

JUD C HICKEY CENTER



PROJECT TITLE:
**JUD C
HICKEY
CENTER**

35% SET - 04/16/21
65% SET - 11/17/21
ISSUE FOR PERMIT - 02/16/22

REVISIONS

REV #	DATE	APPRD BY	REVISION
1	4/16/21	EA	35% SET
2	11/17/21	EA	65% SET
3	2/16/22	EA	ISSUE FOR PERMIT


DA PROJECT NUMBER & NAME:
1893

DRAWING TITLE:
T100

DRAWING NO:
T100

STATE OF GEORGIA
Erin Moseley Atkinson
REGISTERED ARCHITECT
2/16/22

SITE MAP

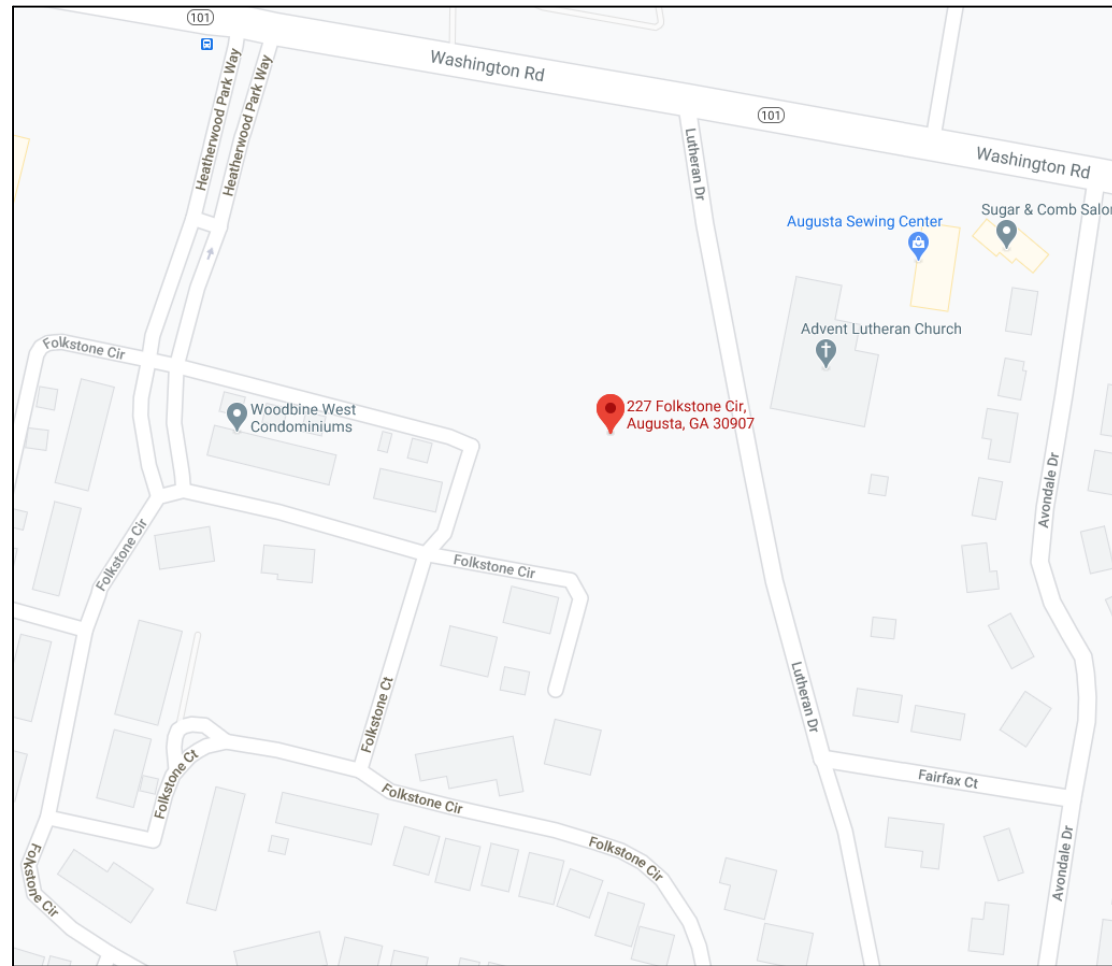

PROJECT DIRECTORY

OWNER:
JUD C. HICKEY CENTER FOR ALZHEIMER'S CARE
1901 CENTRAL AVENUE
AUGUSTA, GA 30904
PH: (706) 738-5039
CONTACT: JENNIFER PENNINGTON
EMAIL: JENNIFER@JUDCHICKEYCENTER.ORG

ELECTRICAL ENGINEER:
ELECTRICAL DESIGN CONSULTANTS, INC.
1201 BROAD STREET, SUITE 1A
AUGUSTA, GA 30901
PH: (706) 724-3551
CONTACT: ASHLEY PAULK, P.E.
EMAIL: APAULK@EDCAUGUSTA.COM

ARCHITECT:
DICKINSON ARCHITECTS
771 BROAD STREET, SUITE 200
AUGUSTA, GEORGIA 30901
PH: (706) 722-7488
CONTACT: ERIN ARMSTRONG, AIA
EMAIL: EARMSTRONG@DICKINSONARCHITECTS.COM

MECH./PLUMBING ENGINEER:
PFA ENGINEERING, INC.
1201 BROAD STREET, SUITE 3A
AUGUSTA, GA 30901
PH: (706) 722-3959
CONTACT: MARTIN FORD, P.E.
EMAIL: JMFORD@PFAENGINEERS.COM

STRUCTURAL ENGINEER:
PRYCO STRUCTURAL
1450 GREENE ST., STE 82
AUGUSTA, GA 30901
PH: (706) 303-4400
CONTACT: JOSE R. HERNANDEZ, P.E., S.E.
EMAIL: JRH@PRYCOSTRUCTURAL.COM

CIVIL: (UNDER SEPARATE CONTRACT)
CIVIL DESIGN SOLUTIONS
371 W MAIN STREET
WARRENTON, GA 30828
PH: (706) 465-0900
CONTACT: SCOTT JOHNSON, P.E.
EMAIL: SLJOHNSON@CIVILDESIGNSOLUTIONS.COM

SYMBOLS LEGEND

	NUMERICAL BUILDING SECTION		NUMERICAL DOOR SYMBOL
	NUMERICAL WALL SECTION		ALPHABETICAL WINDOW SYMBOL
	NUMERICAL DETAIL		ROOM NUMBER
	NUMERICAL INTERIOR ELEVATION		NUMERICAL REVISION
			ALPHABETICAL TOILET ACCESSORY
			NUMERICAL WALL TYPE
			NUMERICAL KITCHEN EQUIPMENT

INDEX OF DRAWINGS

GENERAL PROJECT INFORMATION		35% SET - 04/16/21	65% SET - 11/17/21	ISSUE FOR PERMIT - 02/16/22
T100	TITLE SHEET	X	X	X
T101	CODE DATA	X	X	X
T102	ACCESSIBILITY GUIDELINES	X	X	X
LIFE SAFETY				
LS101	LIFE SAFETY PLAN	X	X	X
LS102	UL DETAILS & FIRESTOPPING DETAILS		X	X
ARCHITECTURAL				
A100	ARCHITECTURAL SITE PLAN	X	X	X
A101	DIMENSION FLOOR PLAN	X	X	X
A102	REFERENCE FLOOR PLAN	X	X	X
A105	ROOF PLAN	X	X	X
A106	REFLECTED CEILING PLAN	X	X	X
A201	BUILDING ELEVATIONS	X	X	X
A301	BUILDING SECTIONS	X	X	X
A302	BUILDING SECTIONS	X	X	X
A303	BUILDING SECTIONS	X	X	X
A310	WALL SECTIONS	X	X	X
A311	WALL SECTIONS	X	X	X
A312	WALL SECTIONS	X	X	X
A321	EXTERIOR DETAILS	X		
A322	EXTERIOR DETAILS	X		
A323	EXTERIOR DETAILS	X		
A331	INTERIOR DETAILS	X		
A401	ENLARGED TOILET PLANS	X	X	X
A402	ENLARGED TOILET PLANS	X	X	X
A403	ENLARGED TOILET PLANS	X	X	X
A410	ENLARGED KITCHEN PLANS	X		
A601	WALL TYPES	X	X	X
A701	DOOR SCHEDULE, TYPES, & DETAILS	X	X	X
A702	DOOR DETAILS	X	X	X
A710	WINDOW SCHEDULE, TYPES, & DETAILS	X	X	X
A801	INTERIOR FINISH SCHEDULE	X		
A810	FIRST FLOOR FINISH PLAN	X	X	X
A821	INTERIOR ELEVATIONS	X	X	X
A822	INTERIOR ELEVATIONS	X	X	X
A823	INTERIOR ELEVATIONS	X	X	X
A824	INTERIOR ELEVATIONS	X	X	X
A850	MILLWORK PLAN	X		
A851	MILLWORK DETAILS	X		
A852	MILLWORK DETAILS	X		
A853	MILLWORK DETAILS	X		
A854	MILLWORK DETAILS	X		
STRUCTURAL				
S100	STRUCTURAL NOTES	X	X	X
S110	SPECIAL INSPECTIONS	X	X	X
S200	FOUNDATION PLAN	X	X	X
S300	FRAMING PLAN	X	X	X
S400	BUILDING SECTION	X	X	X
S500	FOUNDATION DETAILS	X	X	X
S700	FRAMING DETAILS	X	X	X
PLUMBING				
P100	PLUMBING PLAN - WASTE AND VENT			X
P101	PLUMBING PLAN - WATER AND GAS	X	X	X
P200	PLUMBING DETAILS	X	X	X
P201	PLUMBING SCHEDULE AND SPECIFICATIONS			X



FIRE PROTECTION		35% SET - 04/16/21	65% SET - 11/17/21	ISSUE FOR PERMIT - 02/16/22
FP100	FIRE PROTECTION PLAN	X	X	X
FP101	FIRE PROTECTION PLAN - ATTIC	X	X	X
FP200	FIRE PROTECTION SPECIFICATIONS			X
MECHANICAL				
M101	HVAC PLAN	X	X	X
M201	HVAC PIPING PLAN	X	X	X
M301	HVAC DETAILS & SPECIFICATIONS	X	X	X
M401	HVAC SCHEDULES			X
ELECTRICAL				
E100	LEGEND, NOTES, DETAILS, AND FIXTURE SCHEDULE	X	X	X
E101	ELECTRICAL SITE PLAN	X	X	X
E201	LIGHTING PLAN	X	X	X
E301	POWER PLAN	X	X	X
E302	ENLARGED POWER PLAN - KITCHEN			X
E401	MECHANICAL POWER PLAN	X	X	X
E402	MECHANICAL CONNECTION SCHEDULES			X
E501	FIRE ALARM SYSTEM PLAN	X	X	X
E502	SYSTEMS PLAN	X	X	X
E600	POWER RISER DIAGRAM AND PANELBOARD SCHEDULES	X	X	X
E601	PANELBOARD SCHEDULES			X
E700	DETAILS	X	X	X

ARCHITECTURAL GENERAL NOTES

- DO NOT SCALE DRAWINGS- DIMENSIONS GOVERN.
- LARGER SCALE PLANS & DETAILS WILL TAKE PRECEDENCE OVER SMALLER SCALE DRAWINGS.
- THE CONTRACTOR SHALL BE RESPONSIBLE FOR OBTAINING ALL REQUIRED BUILDING PERMITS.
- THE CONTRACTOR SHALL BE RESPONSIBLE FOR PROVIDING ALL WORK AND MATERIALS IN STRICT ACCORDANCE WITH ALL APPLICABLE CODES, REGULATIONS, AND ORDINANCES HAVING JURISDICTION.
- MATERIALS, DIMENSIONS AND ALL OTHER CONDITIONS NOT OTHERWISE INDICATED IN THESE CONSTRUCTION DOCUMENTS SHALL BE INTERPRETED AS HAVING THE SAME MEANING AS THOSE MOST SIMILARLY DETAILED AND MORE FULLY DEFINED ELSEWHERE WITHIN THESE DOCUMENTS.
- THE CONTRACTOR SHALL FIELD VERIFY ALL DIMENSIONS INDICATED WITHIN THESE DOCUMENTS AND SHALL NOTIFY THE ARCHITECT OF ANY VARIATION PRIOR TO THE PURCHASING OF MATERIALS, STARTING FABRICATION OR BEGINNING CONSTRUCTION.
- THE CONTRACTOR, UPON AWARDED CONTRACTS TO SUBCONTRACTORS, SHALL SUBMIT TO THE ARCHITECT AND THE OWNER A LIST OF ALL ITEMS AND THEIR DELIVERY SCHEDULES. THE CONTRACTOR SHALL IDENTIFY ALL LONGLEAD TIME ITEMS ON THE PROJECT (I.E. MATERIALS, FABRICS, HARDWARE, ETC.). THE CONTRACTOR, PRIOR TO ORDERING AN ITEM, SHALL BE RESPONSIBLE FOR NOTIFYING THE ARCHITECT AND THE OWNER OF ANY ITEM WHICH MAY CAUSE THE PROJECT TO BE DELAYED.
- THE CONTRACTOR SHALL BE RESPONSIBLE FOR THE DELAY TO MOVE-IN DATE CAUSED BY SCHEDULING WITHIN HIS SCOPE, I.E., DELIVERY DATES OF MATERIALS, ETC.
- FLOOR TOLERANCE: IN LAYING OUT AND DETAILING THE WORK TO BE COMPLETED, CONSIDERATIONS SHALL BE GIVEN TO VARIATIONS IN THE FLOOR LEVELNESS RESULTING FROM CONSTRUCTION QUALITY AND LIVE AND DEAD LOADS IMPOSED ON THE STRUCTURE. FIELD VERIFICATION SHALL BE MADE OF CONDITIONS TO VERIFY CONSTRUCTION TOLERANCES. ALIGNMENT OF THE DOOR HEADS AND OTHER HORIZONTAL ELEMENTS SHALL BE MAINTAINED AT A CONSTANT LEVEL AND SHALL NOT FOLLOW VARIATIONS IN FLOOR PLANE. LEVEL FLOORS AS REQUIRED USING APPROVED LEVELING COMPOUND.
- CONTRACTOR IS RESPONSIBLE FOR PROVIDING ALL NECESSARY REINFORCING TO ACCOMMODATE INTERIOR FINISHES, FIXTURES AND EQUIPMENT AS DESCRIBED IN THESE DOCUMENTS.
- THE EXTENT OF WORK SHALL BE LIMITED TO THAT INDICATED IN THE ARCHITECTURAL DOCUMENTS. NO ADDITIONAL WORK SHALL BE DONE WITHOUT PRIOR WRITTEN APPROVAL OF THE ARCHITECT OR OWNER. ANY ADDITIONAL WORK PERFORMED WITHOUT WRITTEN APPROVAL SHALL BE AT THE CONTRACTOR'S EXPENSE.
- ALL FASTENERS AND ATTACHMENTS SHALL BE FULLY CONCEALED FROM VIEW, UNLESS NOTED OTHERWISE.
- DIMENSIONS NOTED AS "CLEAR" OR "CRITICAL" SHALL BE MEASURED FROM FINISHED FACE TO FINISHED FACE.
- ALL GYPSUM WALLBOARD AND METAL STUD CONSTRUCTION SHALL BE IN ACCORDANCE WITH RECOMMENDATIONS AND INSTRUCTIONS PUBLISHED BY U.S. GYPSUM COMPANY'S "GYPSUM CONSTRUCTION HANDBOOK", LATEST EDITION.
- ALL FINISH CARPENTRY AND MILLWORK SHALL BE IN ACCORDANCE WITH THE ARCHITECTURAL WOODWORKS INSTITUTE (AWI) STANDARDS FOR SELECTION OF MATERIALS, HARDWARE, FABRICATION, WORKMANSHIP, AND FINISHING.
- EQUIPMENT AND APPLIANCES: THE CONTRACTOR SHALL PROVIDE AND INSTALL EQUIPMENT AND/OR APPLIANCES SPECIFIED UNLESS OTHERWISE NOTED. THE CONTRACTOR SHALL PROVIDE AND COORDINATE INSTALLATION OF OWNER FURNISHED EQUIPMENT AND/OR APPLIANCES WHERE DESIGNATED. CONTRACTOR SHALL VERIFY THE PLUMBING AND ELECTRICAL REQUIREMENTS OF ALL SUCH APPLIANCES.
- PATCH AND SEAL ALL PENETRATIONS IN THE FLOOR AND PARTITIONS TO COMPLY WITH APPLICABLE BUILDING AND/OR LIFE, SAFETY CODES.
- "TYPICAL" MEANS THE REFERENCED DETAIL SHALL APPLY FOR ALL SIMILAR CONDITIONS UNLESS OTHERWISE NOTED.
- ALL FLOOR FINISH CHANGES SHALL OCCUR UNDER CENTER LINE OF DOOR IN CLOSED POSITION.
- WHERE ELECTRICAL, MECHANICAL, AND/OR OTHER WALL MOUNTED DEVICES OCCUR AT THE SAME LOCATION BUT AT DIFFERENT HEIGHTS, THEY SHALL BE CENTERED ABOVE EACH OTHER.
- THE CONTRACTOR IS RESPONSIBLE FOR ALL MECHANICAL AND ELECTRICAL ITEMS INDICATED ON THE ARCHITECTURAL, MECHANICAL, PLUMBING, AND ELECTRICAL DRAWINGS. ALL ITEMS INDICATED ON ANY DRAWING ARE TO BE INCLUDED AS A COMPLETE SYSTEM, AND FINISHING.
- CONTRACTOR SHALL BE RESPONSIBLE FOR COORDINATION OF STRUCTURAL, MECHANICAL, ELECTRICAL, PLUMBING WORK WITH ARCHITECTURAL DRAWINGS. HE SHALL BE RESPONSIBLE TO IDENTIFY ANY DISCREPANCIES ON THE DOCUMENTS AND SHALL INFORM THE ARCHITECT.

1. OCCUPANCY CLASSIFICATION

IBC 2018
SECTIONS 303.3, 303.4, 304, 308.5
ASSEMBLY GROUP A (A-2)
ASSEMBLY GROUP A (A-3)
BUSINESS GROUP B
INSTITUTIONAL GROUP (I-4)

2018 NFPA LIFE SAFETY
CHAPTER 12/13 - NEW & EXISTING ASSEMBLY OCCUPANCIES
CHAPTER 16/17 - NEW & EXISTING DAY-CARE OCCUPANCIES
CHAPTER 38/39 - NEW & EXISTING BUSINESS OCCUPANCIES

SECTION 508 MIXED USE AND OCCUPANCY
I-4, A-2, A-3, & B REGULATED PER
508.3 NONSEPARATED OCCUPANCIES

SECTION 6.1 MULTIPLE OCCUPANCIES
DAY-CARE, ASSEMBLY, & BUSINESS REGULATED PER
6.1.14.3 MIXED OCCUPANCIES

2. CONSTRUCTION TYPE

IBC 2018
SECTION 601
TYPE VB

3. FIRE SPRINKLERS

IBC 2018
SECTION 506.3
AUTOMATIC
FIRE SPRINKLER

2018 NFPA LIFE SAFETY
SECTION 16.3.5
EXTINGUISHING IS REQUIRED.

4. HEIGHT / AREA LIMITATIONS

PER IBC 2018 TABLES 504.3, 504.4, 506.2

PER IBC 2018 506.3 FRONTAGE INCREASE: EQUATION 5-5:

$$l_f = [F/P - 0.25]W/30$$

$$l_f = .62$$

PER IBC 2018 506.2 FRONTAGE INCREASE: EQUATION 5-1:

$$A_a = A_t + (NS \times l_f)$$

ASSEMBLY (A-2 & A-3) ALLOWABLE AREA:

$$A_a = 24,000 \text{ SF} + (6,000 \text{ SF} \times .62)$$

$$A_a = 27,720 \text{ SF}$$

BUILDING AREA BREAKDOWN:

INTERIOR	24,312 SF
COVERED EXTERIOR	2,991 SF
TOTAL:	27,303 SF

AREA:	MAX ALLOWABLE AREA (TABLE 506.2)	FRONTAGE AREA INCREASE ALLOWABLE	ACTUAL BUILDING AREA
BUILDING AREA	24,000 SF	27,720 SF	27,303 SF

HEIGHT:	MAX ALLOWABLE HEIGHT (TABLES 504.3, 504.4)	ACTUAL BUILDING HEIGHT
HEIGHT IN FEET	60'	30'
HEIGHT IN STORIES	2	1

5. OCCUPANCY LOAD

NOTES:

- CALCULATIONS ARE PER NFPA TBL. 7.3.1.2
- TOTAL OCCUPANCY INCLUDES OCCUPANTS IN THE INTERNAL COURTYARD, BUT THAT AREA IS NOT INCLUDED IN THE BUILDING AREA., PER IBC. EGRESS THROUGH AND OUT OF THE BUILDING FOR THESE OCCUPANTS IS INCLUDED IN THE BUILDING DESIGN.

	AREA / FACTOR = OCCUPANTS	TOTAL OCCUPANCY
TOTAL	24,312 SF VARIES, SEE LIFE SAFETY PLAN	928

6. EGRESS REQUIREMENTS

PER NFPA 101 TABLE 7.3.3.1

	LEVEL COMPONENT .2" PER OCCUPANT		STAIR COMPONENT .3" PER OCCUPANT	
	MIN.	ACTUAL	MIN.	ACTUAL
1st FLOOR	36"	72"	36"	N/A

	NUMBER OF EXITS	
	MIN. PER NFPA 101	ACTUAL
1st FLOOR	3	3

7. TRAVEL DISTANCE

NOTES:

- PER NFPA 101 TABLE A7.6.

TRAVEL DISTANCE LIMIT		DEAD-END LIMIT		COMMON PATH LIMIT	
NFPA 101 TABLE A7.6	ACTUAL	NFPA 101 TABLE A7.6	ACTUAL	NFPA 101 TABLE A7.6	ACTUAL
200 FT.	< 128 FT	20 FT.	< 13 FT	20/75 FT.	< 28 FT

8. APPLICABLE CODES - STATE OF GEORGIA

LIFE SAFETY CODE	NFPA 101, 2018 EDITION
INTERNATIONAL BUILDING CODE	2018 EDITION, WITH GEORGIA AMENDMENTS
AMERICANS WITH DISABILITIES ACT	2010 WITH REVISED STANDARDS
INTERNATIONAL MECHANICAL CODE	2018 EDITION, WITH GEORGIA AMENDMENTS
INTERNATIONAL PLUMBING CODE	2018 EDITION, WITH GEORGIA AMENDMENTS
NATIONAL ELECTRIC CODE	2020 EDITION, WITH GEORGIA AMENDMENTS
INTERNATIONAL FIRE CODE	2018 EDITION, WITH GEORGIA AMENDMENTS
INTERNATIONAL FUEL GAS CODE	2018 EDITION, WITH GEORGIA AMENDMENTS
INTERNATIONAL ENERGY CONSERVATION CODE	2015 EDITION, WITH GEORGIA AMENDMENTS
NFPA 13	2013 EDITION

TABLE 102.10: CODES REFERENCE GUIDE	PRIMARY	SUPPLEMENT
OCCUPANCY CLASSIFICATION	LSC	IBC
BUILDING CONSTRUCTION TYPES INCLUDING ALLOWABLE HEIGHT, ALLOWABLE BUILDING AREAS, AND THE REQUIREMENTS FOR THE SPRINKLER PROTECTION RELATED TO MINIMUM BUILDING CONSTRUCTION TYPES	IBC	LSC
MEANS OF EGRESS	LSC	NONE
STANDPIPES	IBC	IFC
INTERIOR FINISH	LSC	NONE
HVAC SYSTEMS	IMC	NONE
VERTICAL OPENINGS	LSC	NONE
SPRINKLER SYSTEMS MINIMUM CONSTRUCTION STANDARDS	LSC	NONE
FIRE ALARM SYSTEMS	LSC	NONE
SMOKE ALARM AND SMOKE DETECTION SYSTEMS	STATE STATUTE & LSC	NONE
PORTABLE FIRE EXTINGUISHERS	IFC	NONE
COOKING EQUIPMENT	LSC & NFPA	NONE
FUEL FIRED APPLIANCES	IFGC	NFPA 54
LIQUID PETROLEUM GAS	NFPA 58	NFPA 54 & IFGC
COMPRESSED NATURAL GAS	NFPA 52	NONE




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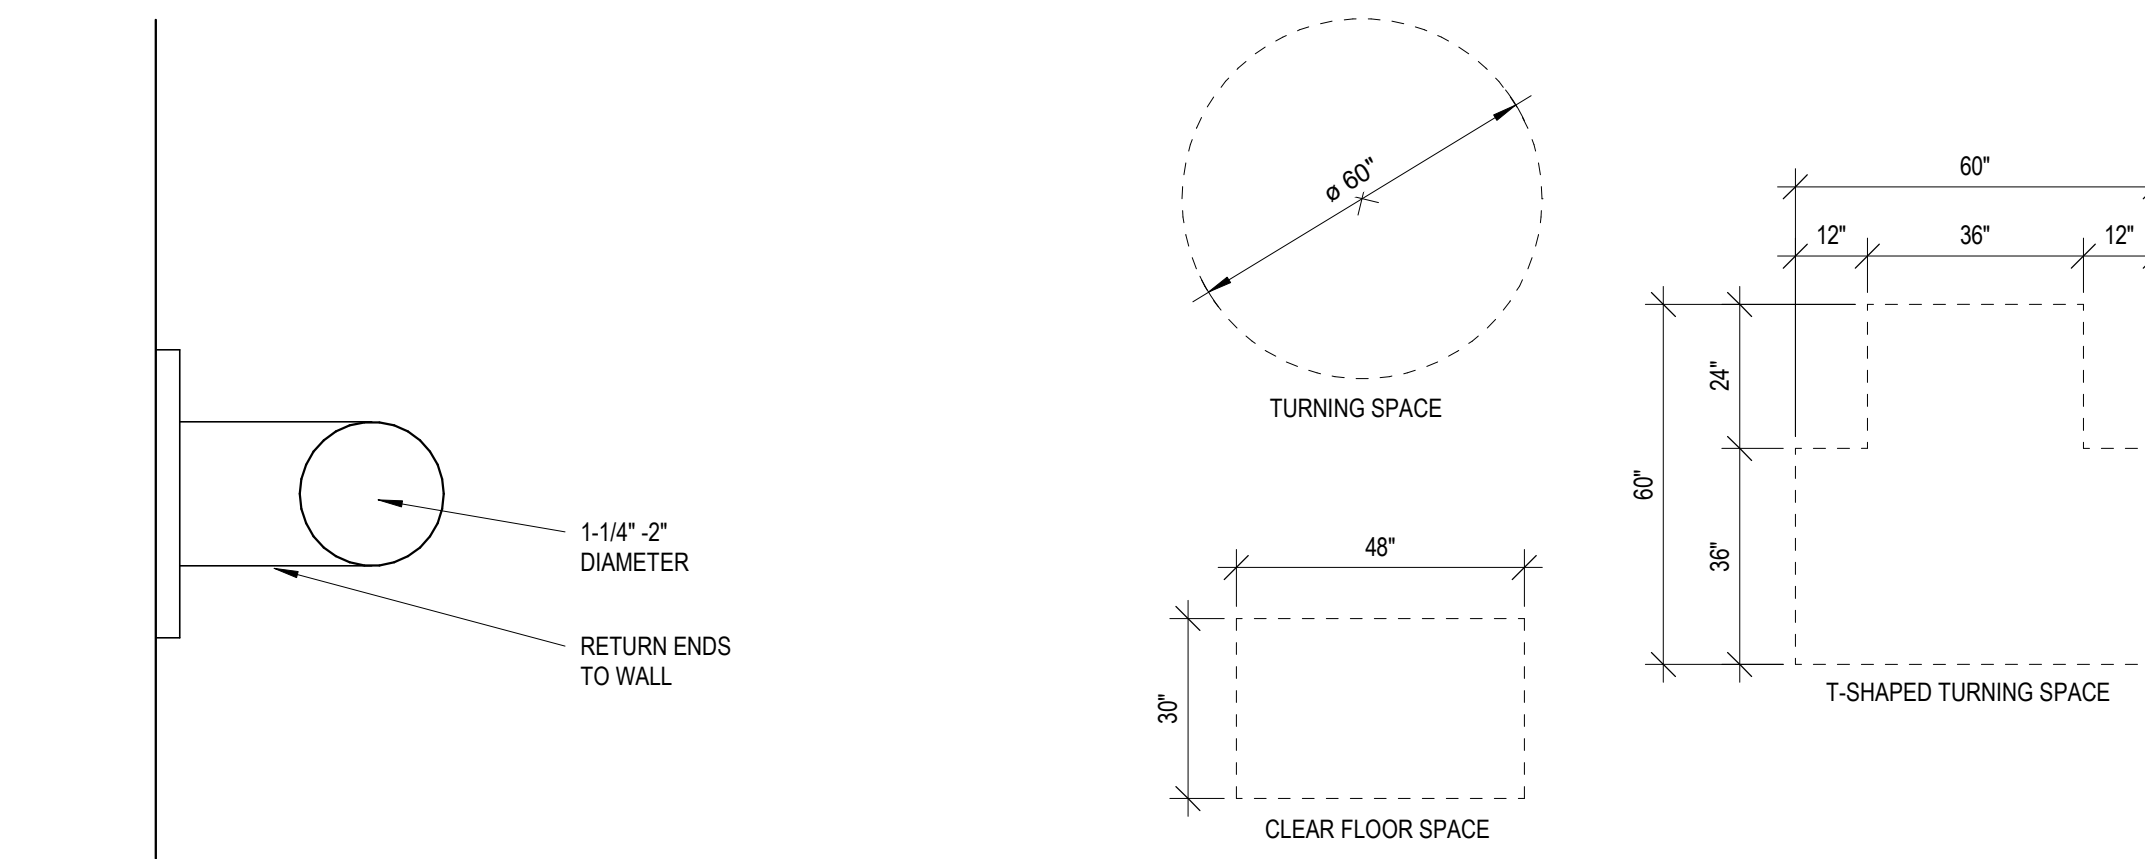
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1893
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CODE DATA

DRAWING NO:
T101




1 DOOR CLR AT PUBLIC/COMMON AREAS
SCALE: 3/8" = 1'-0"


NOTE: ACCESSIBLE DOOR SURFACE TO MAINTAIN A SMOOTH SURFACE ON THE PUSH SIDE EXTENDING THE FULL WIDTH OF THE DOOR AS PER ANSI A117.1 404.2.9

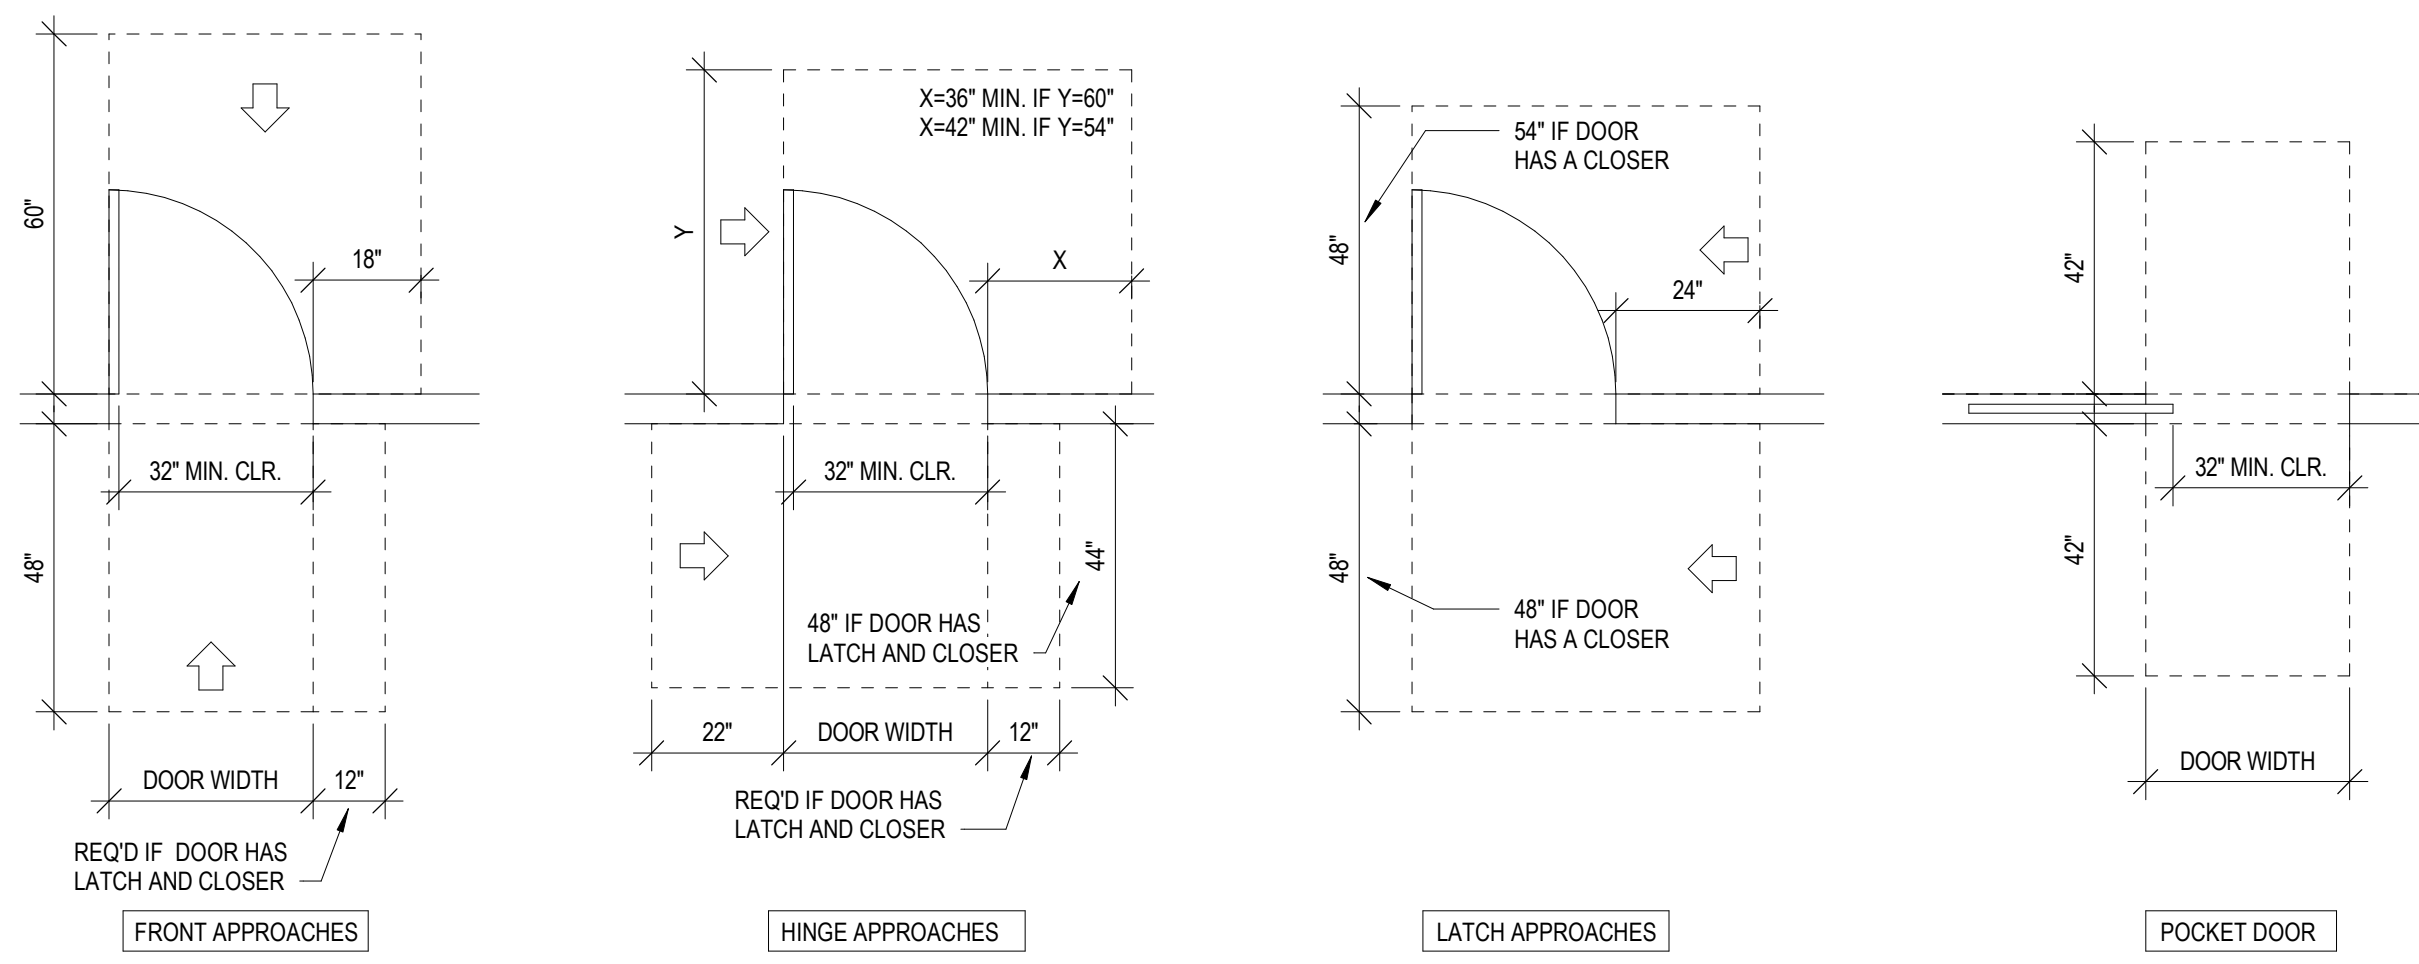


2 TYP. GRAB-BAR SECTION
SCALE: 6" = 1'-0"

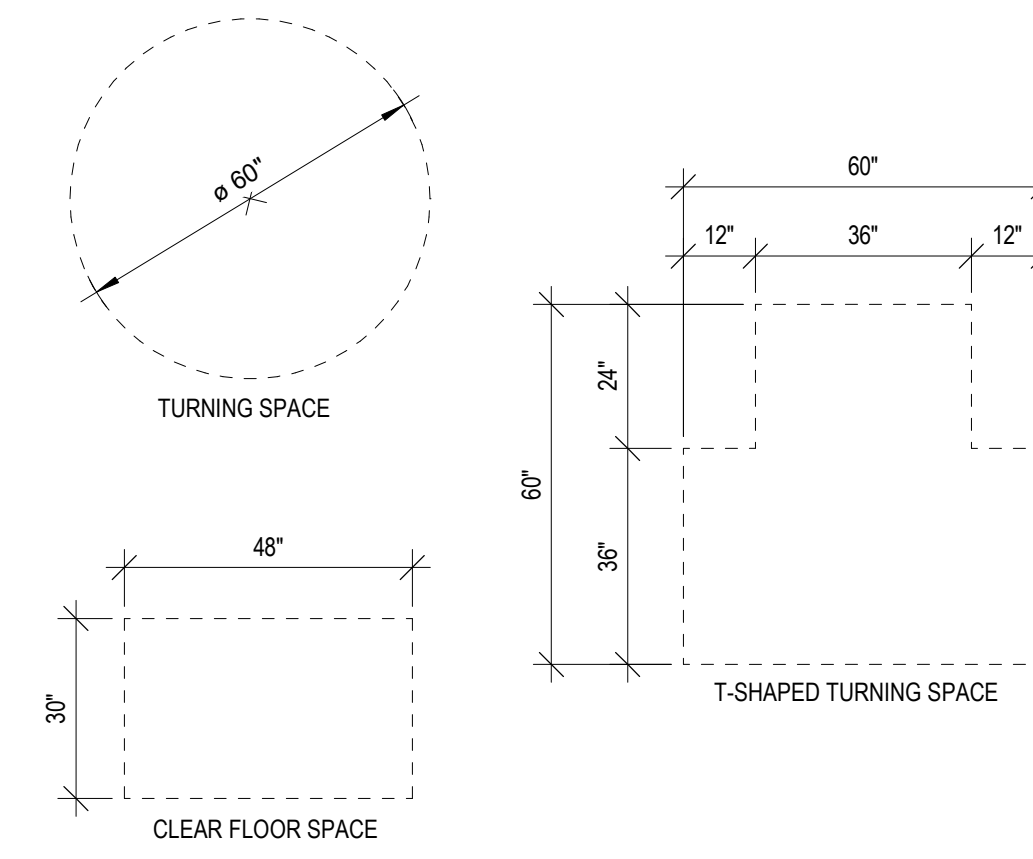


3 CLEAR FLOOR SPACES
SCALE: 3/8" = 1'-0"

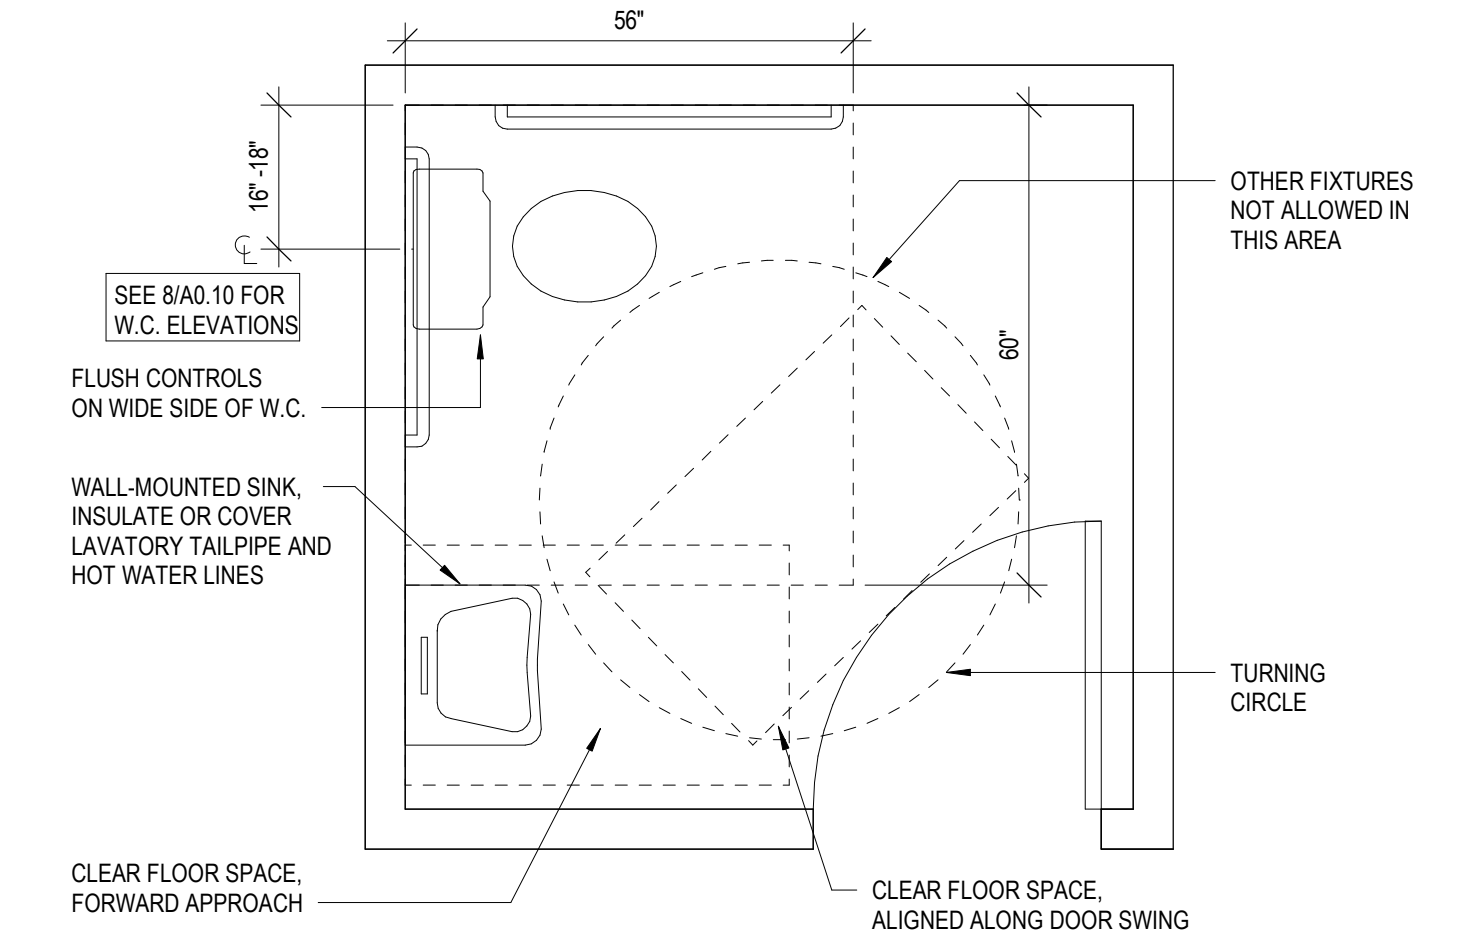


4 COMMON USE SINGLE BATHROOM
SCALE: 1/2" = 1'-0"

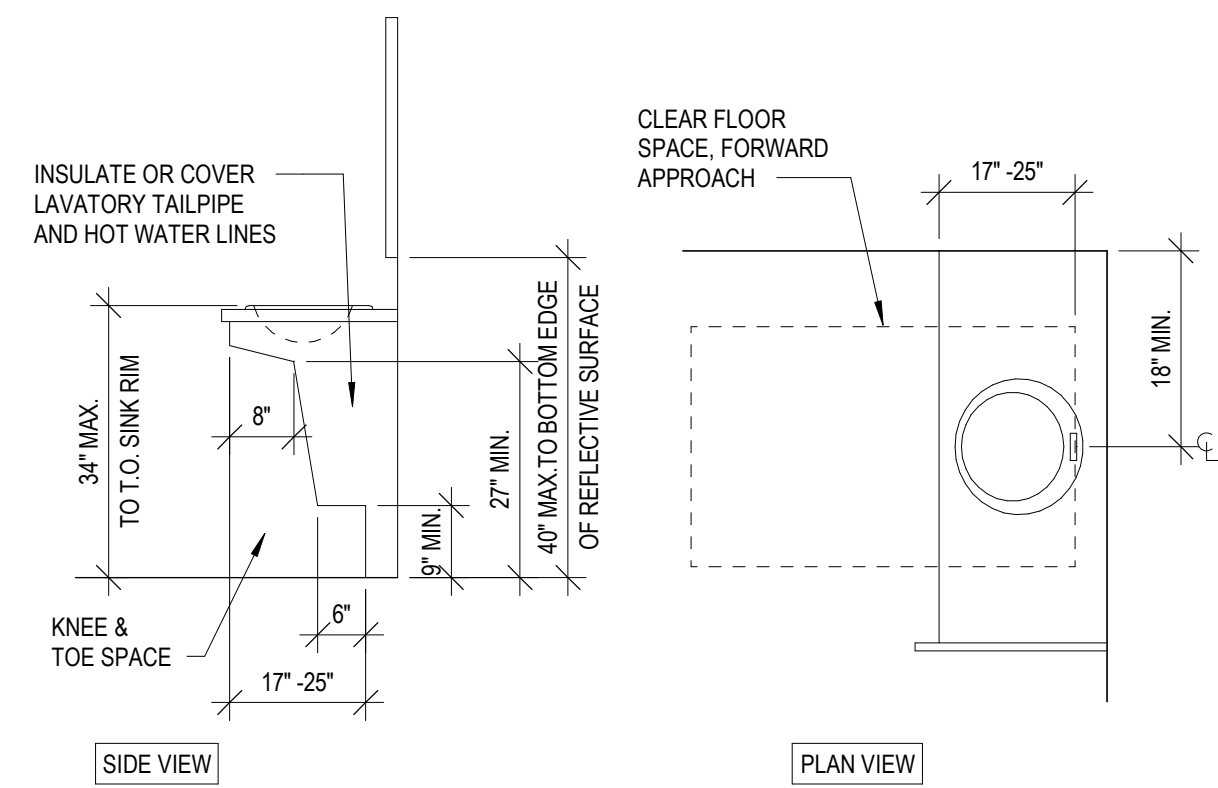


5 COMMON USE LAVATORY
SCALE: 1/2" = 1'-0"

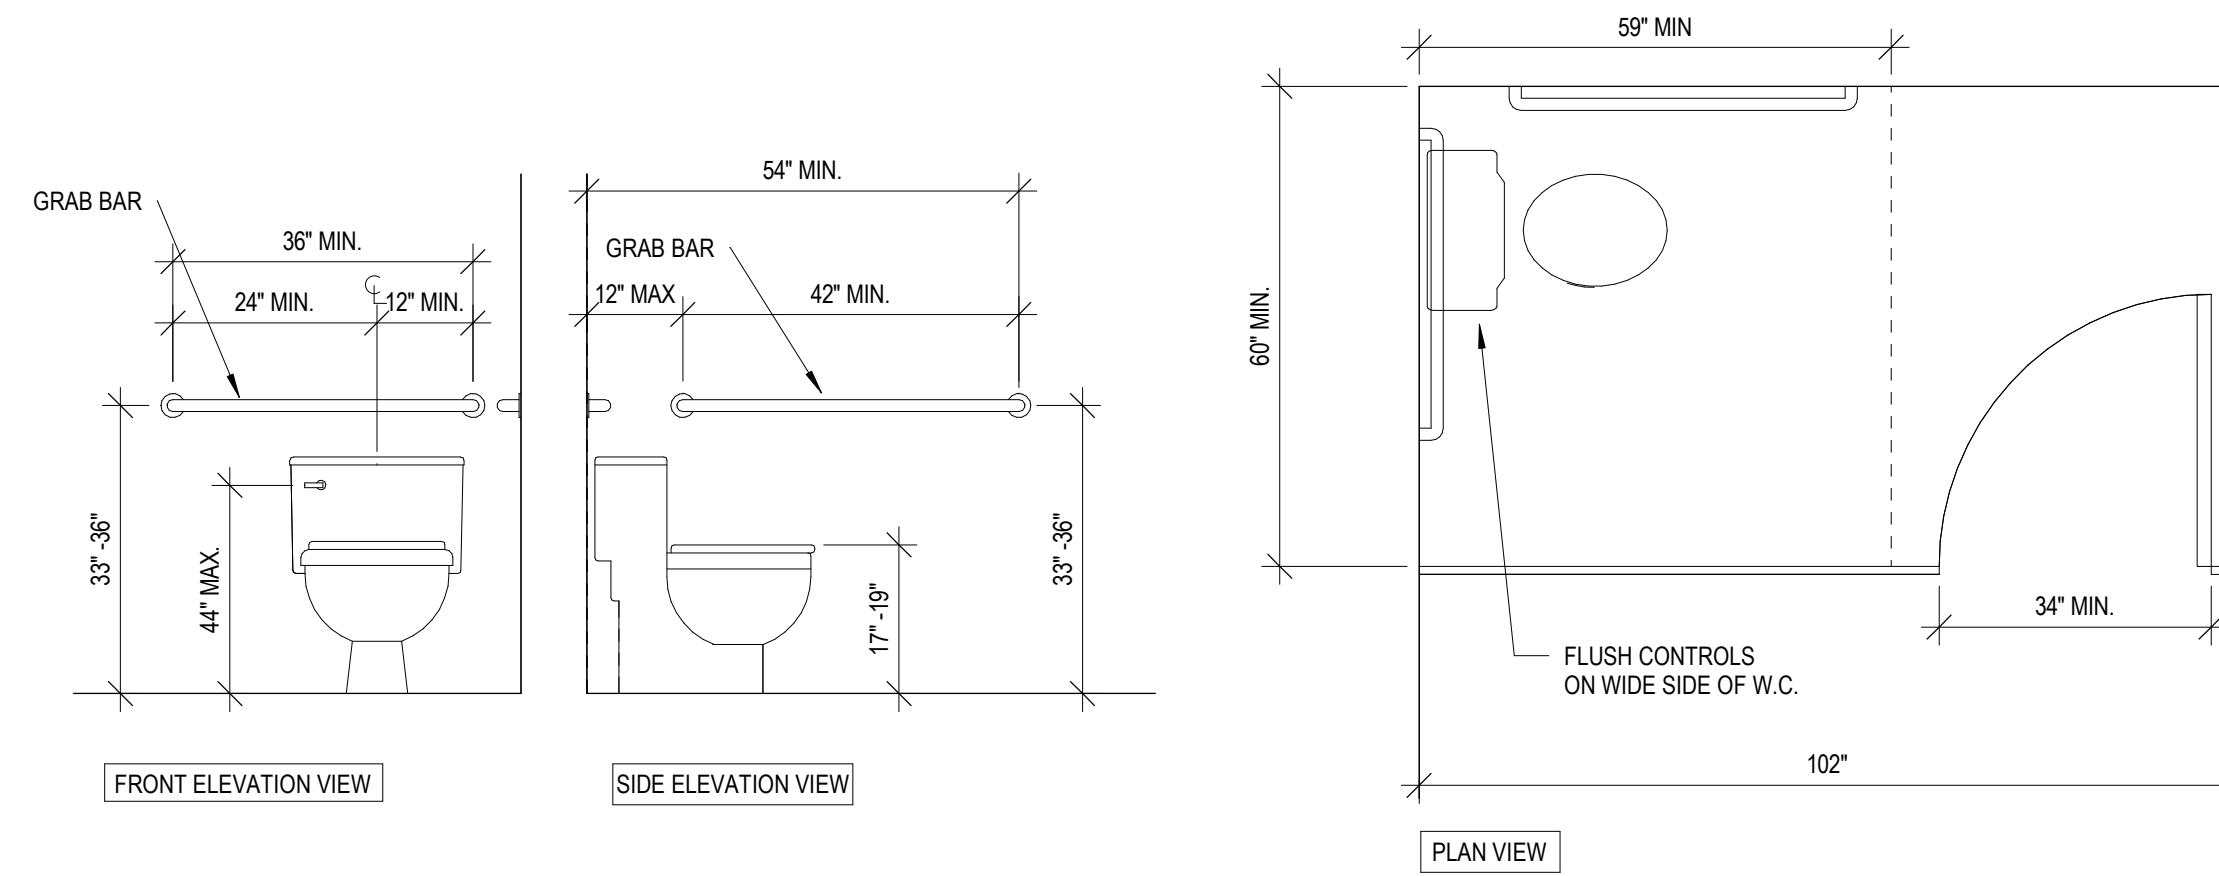


6 COMMON USE ACCESSIBLE WC COMPARTMENT
SCALE: 1/2" = 1'-0"

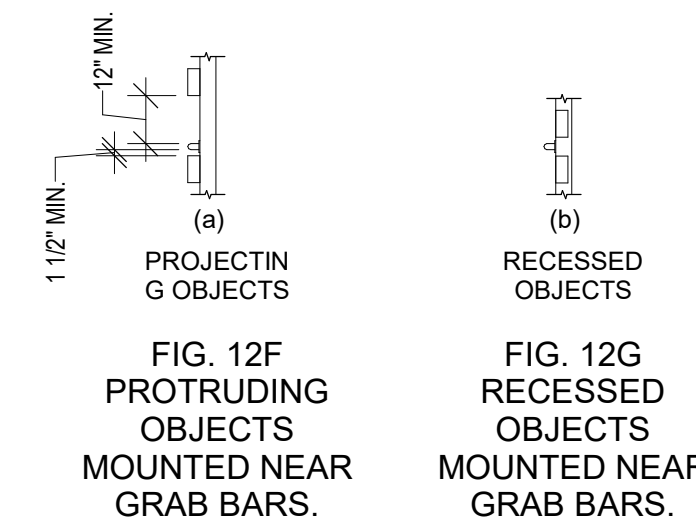


7 PROTRUDING OBJECTS
SCALE: 1/4" = 1'-0"

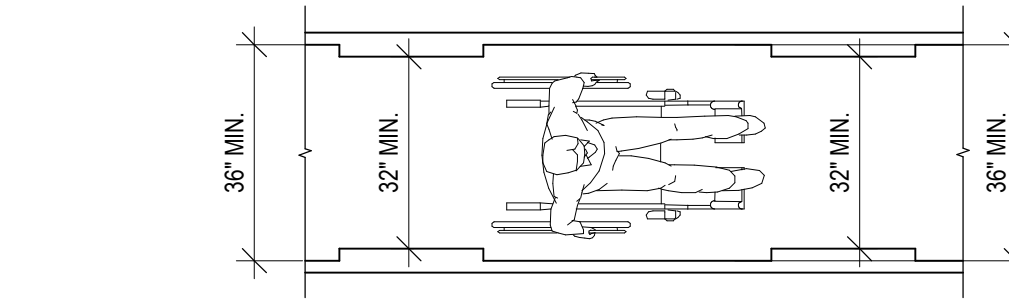



403.5.2 Clear Width at Turn. Where the accessible route makes a 180 degree turn around an element which is less than 48 inches wide, clear width shall be 42 inches minimum approaching the turn, 48 inches minimum at the turn and 42 inches minimum leaving the turn.
EXCEPTION: Where the clear width at the turn is 60 inches minimum compliance with 403.5.2 shall not be required.

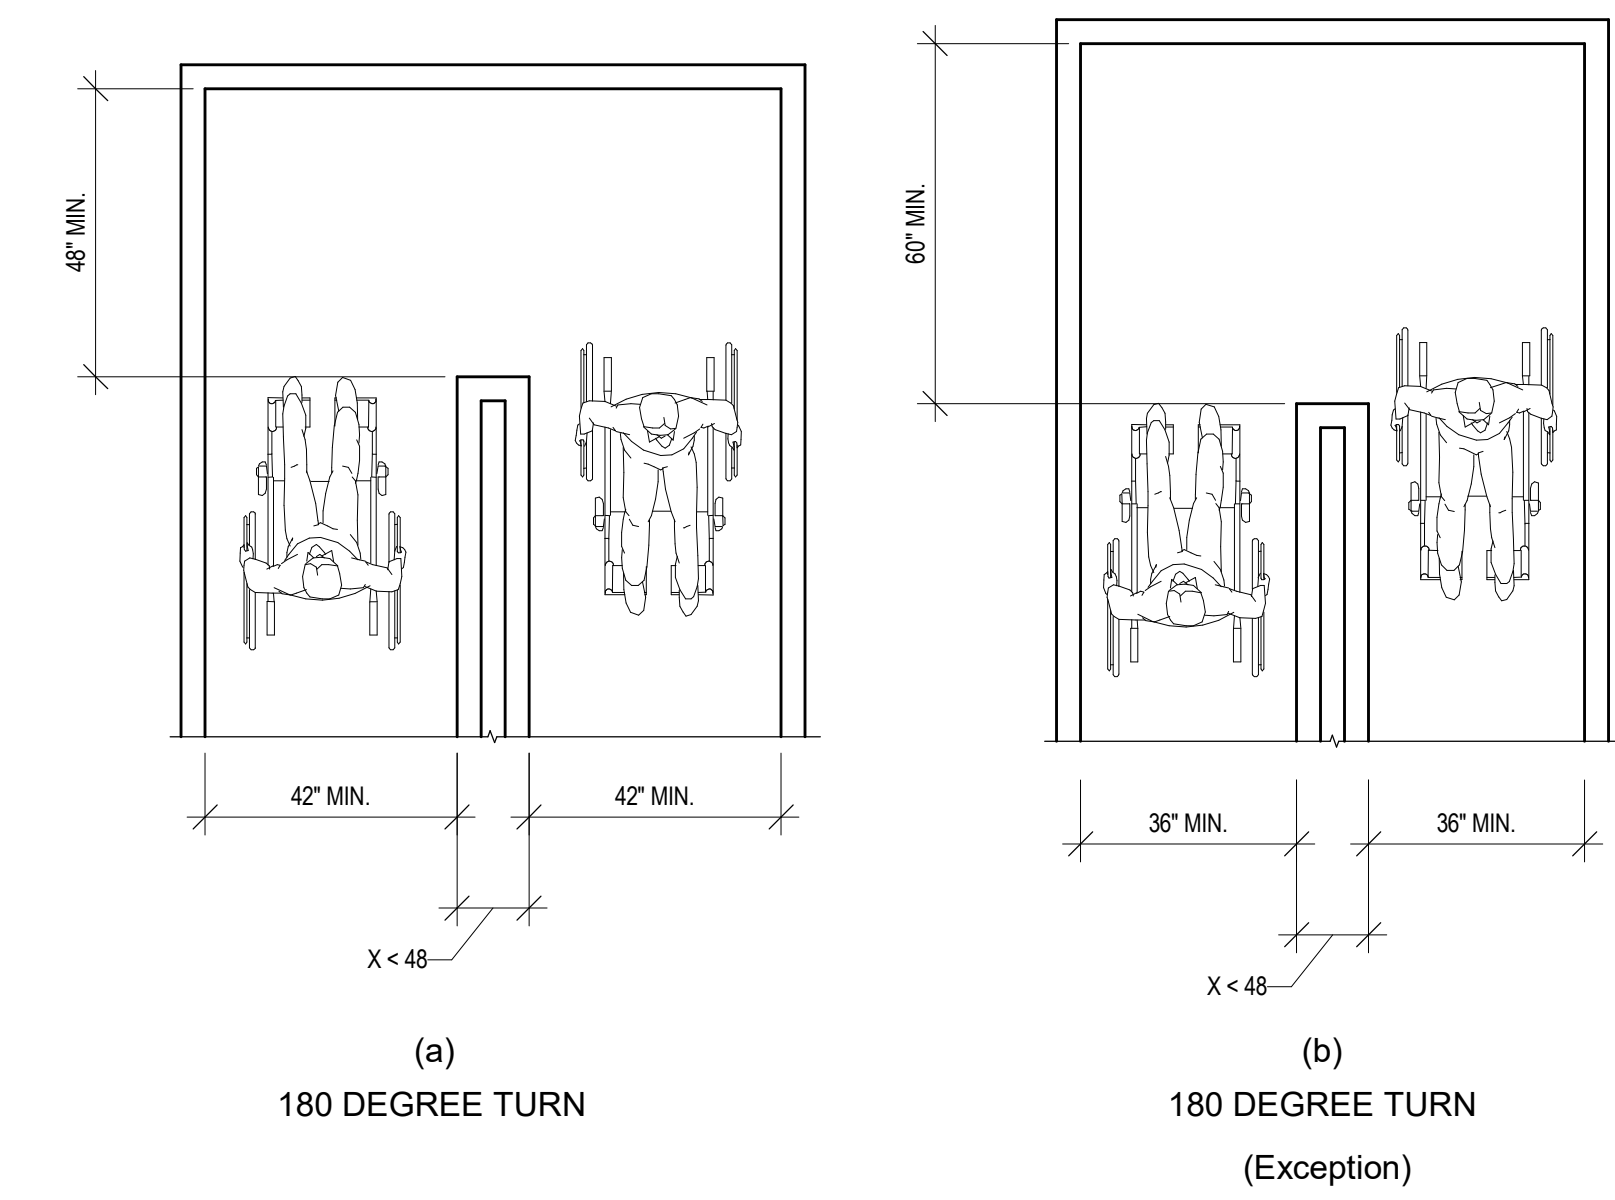

8 CLEAR WIDTH AT TURN
SCALE: 3/8" = 1'-0"

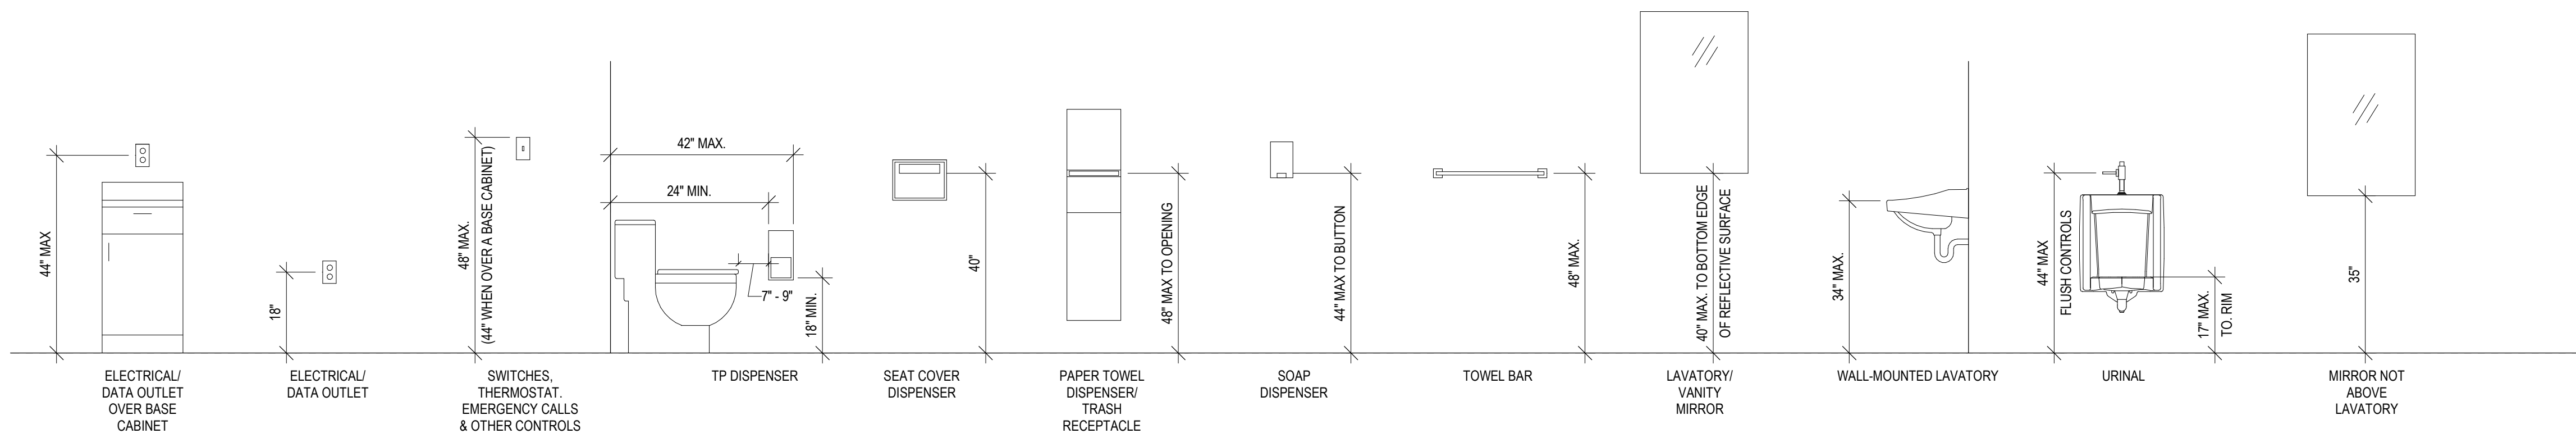

9 TYP. MOUNTING HEIGHTS
SCALE: 1/2" = 1'-0"

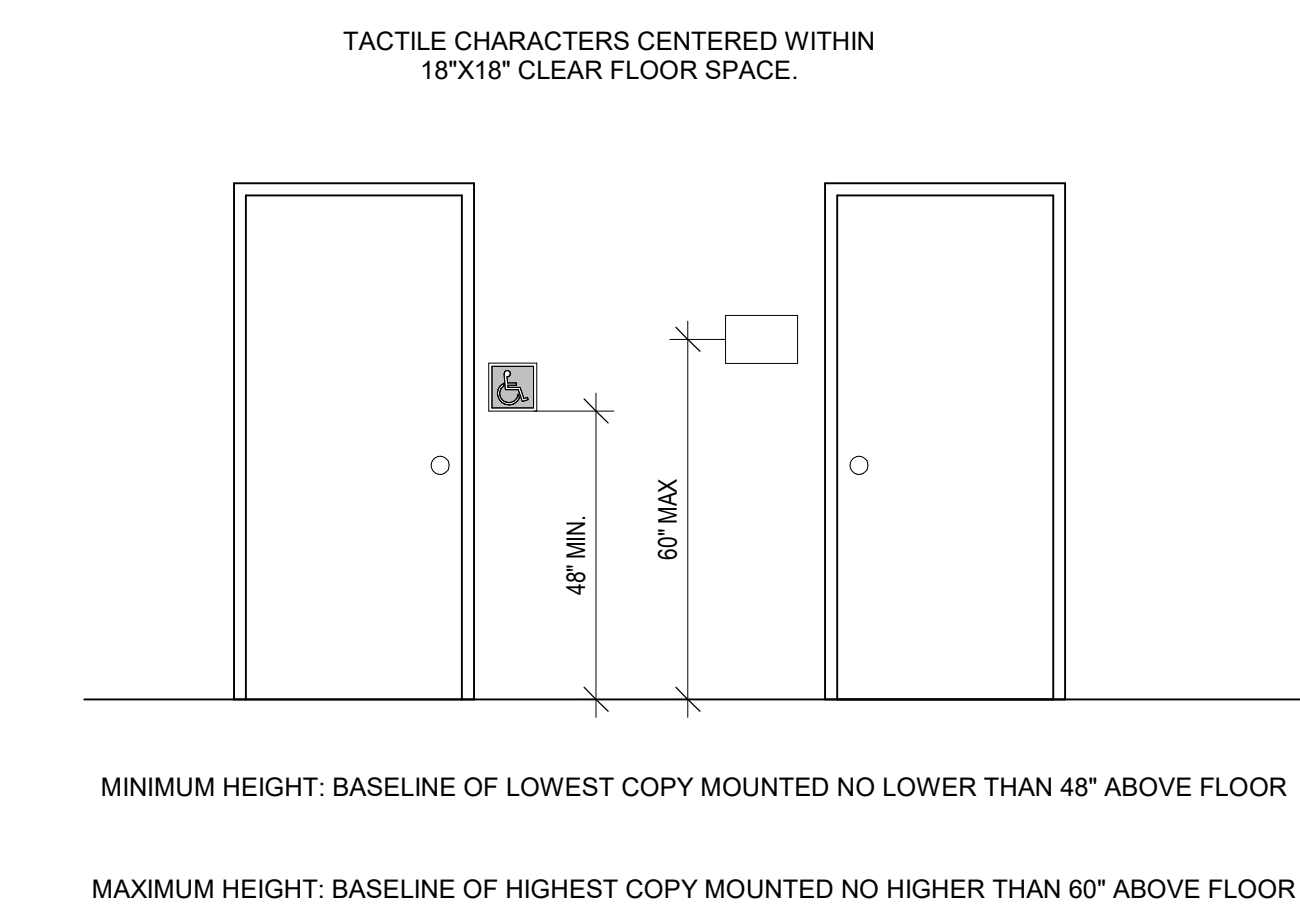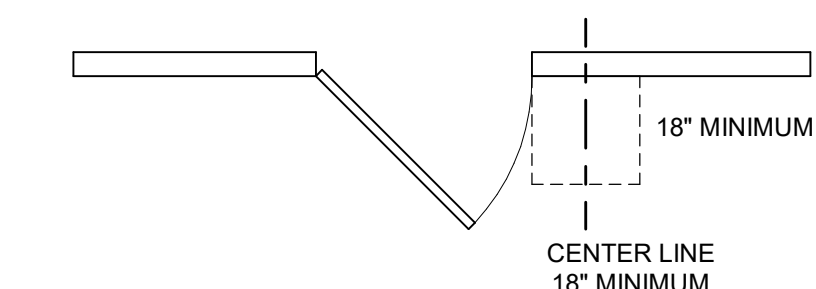


10 TACTILE
SCALE: 3/8" = 1'-0"

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1 2 3 4 5 6

E
D
C
B
A



LIFE SAFETY CODE KEY

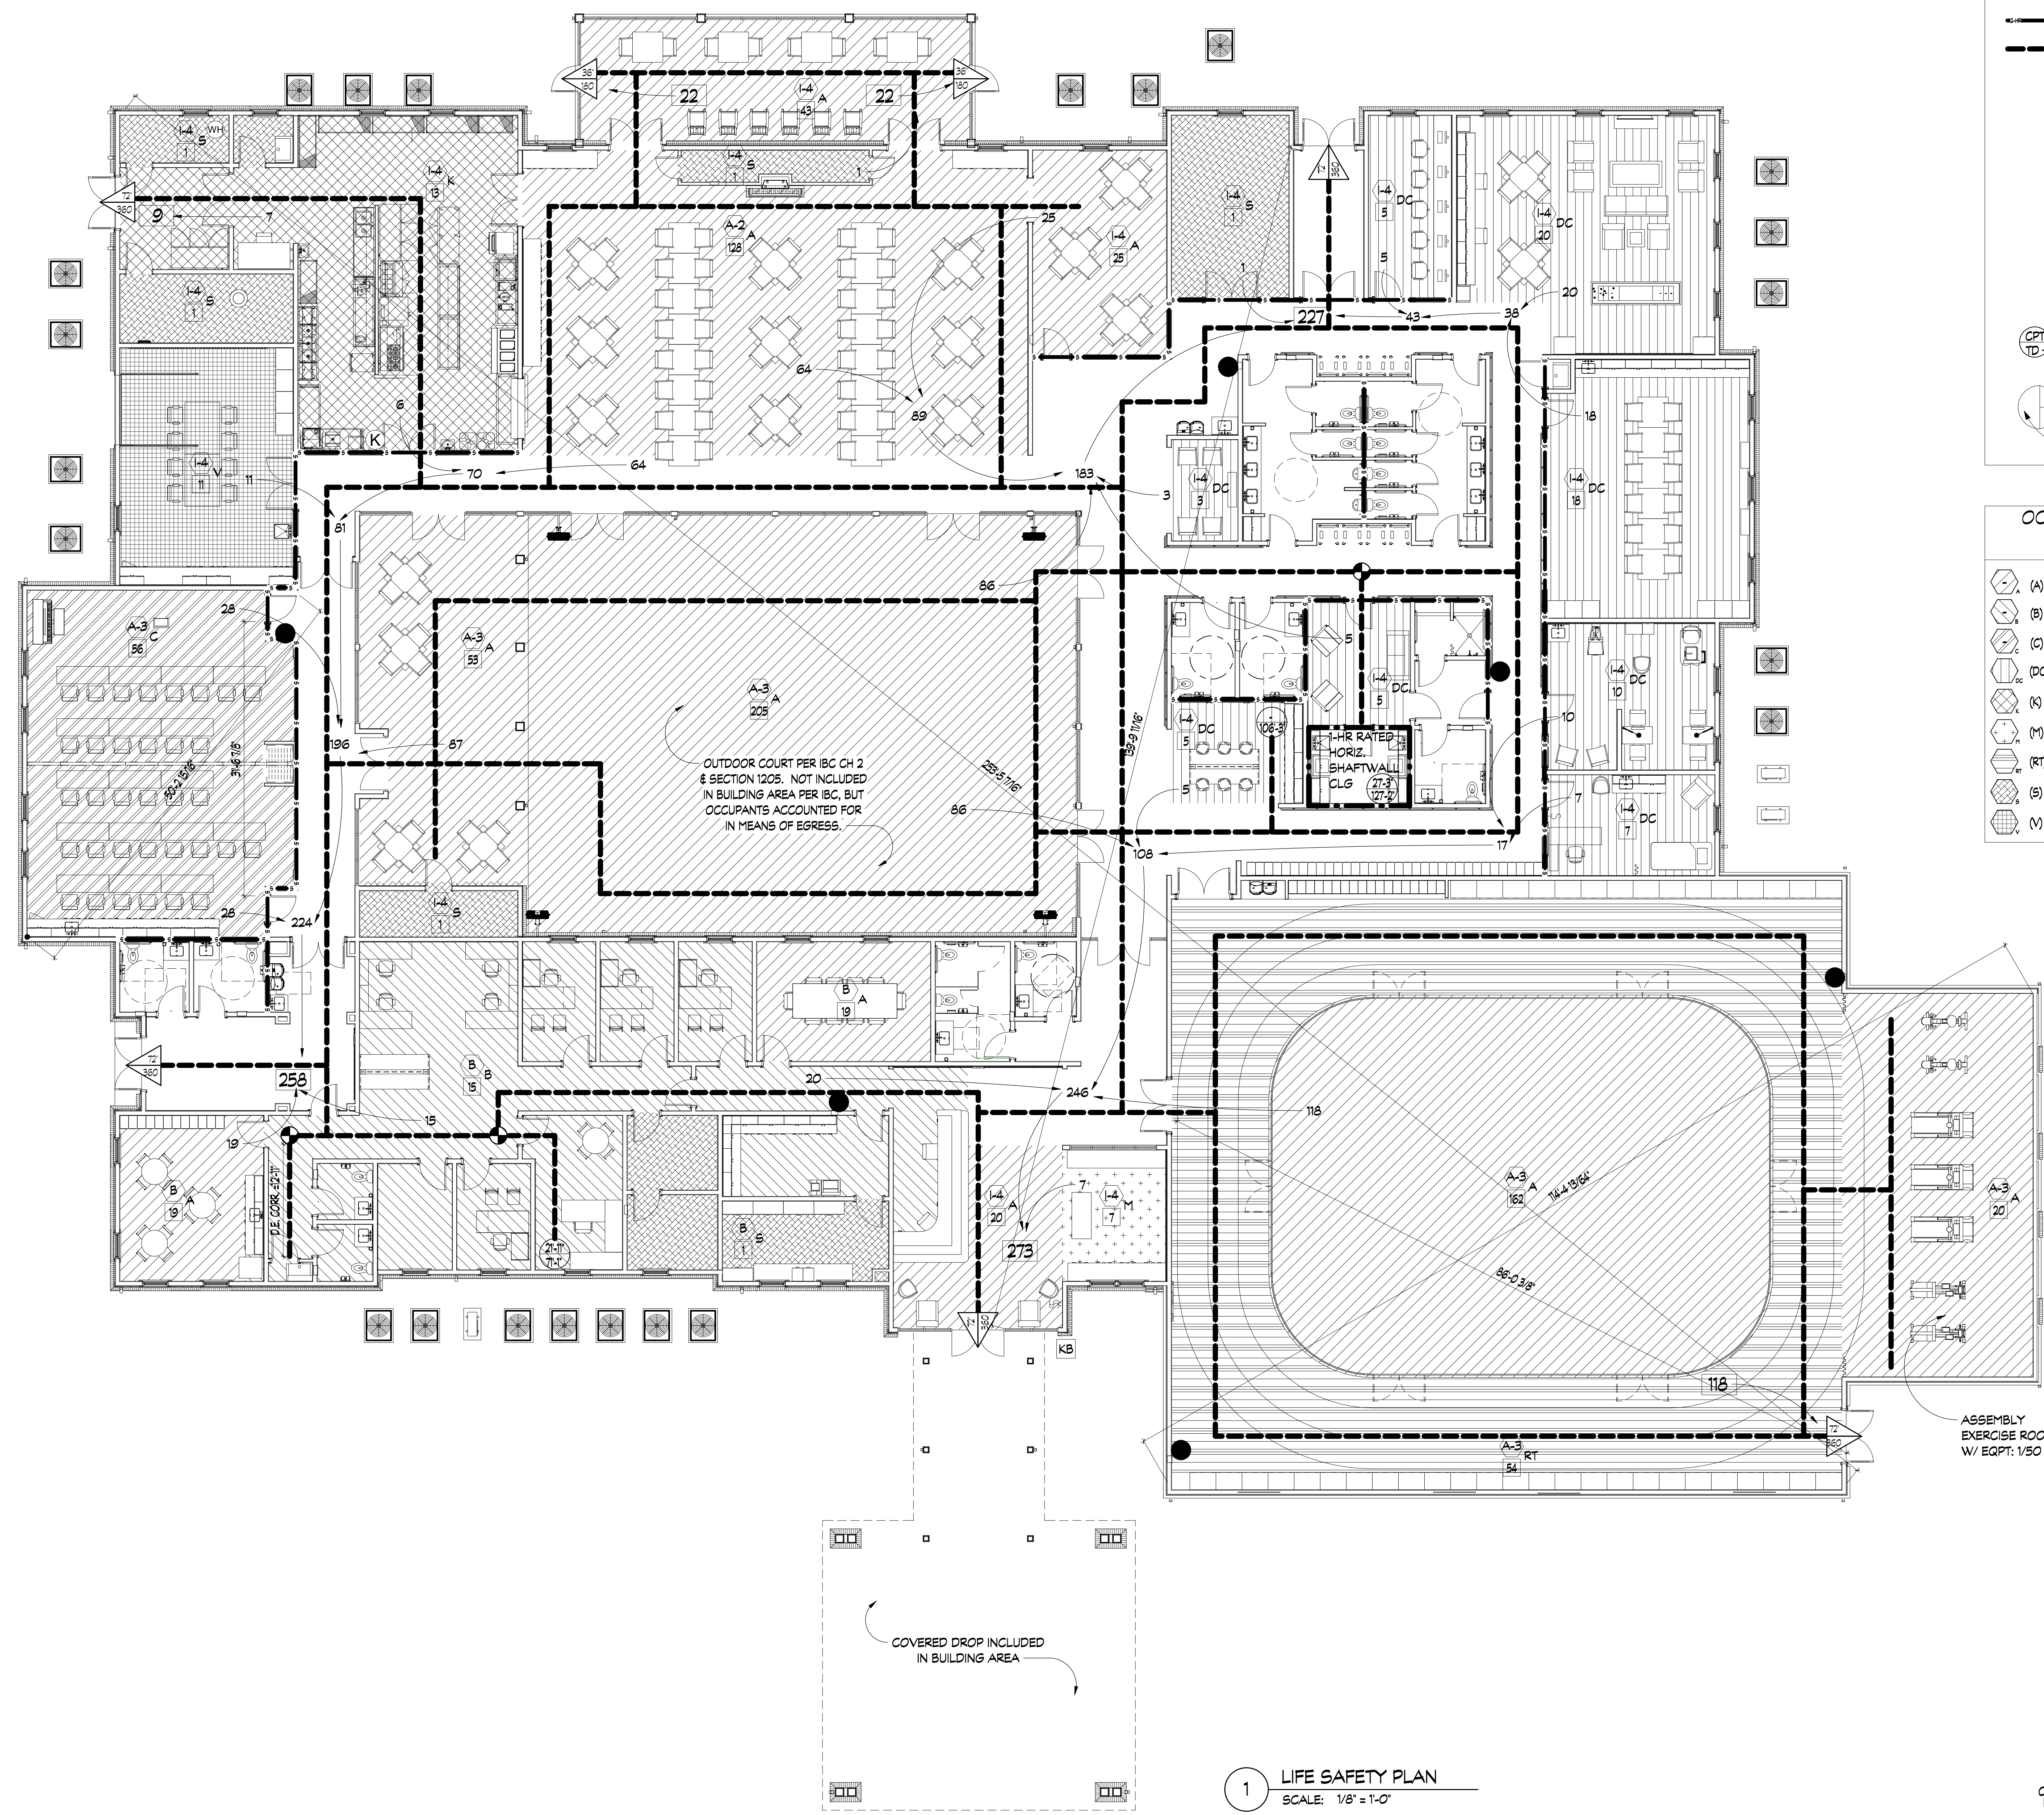- SMOKE PARTITION
- 30 MIN RATED FIRE PARTITION
- 1 HOUR RATED FIRE PARTITION
- 2 HOUR RATED FIRE PARTITION
- 2 HOUR RATED FIRE WALL
- PATH OF EGRESS TRAVEL
- END OF COMMON PATH OF TRAVEL
- OCCUPANCY DESIGNATION (BO)
- PRIMARY USE FOR OCCUPANT LOAD (NFPA)
- ROOM OCCUPANT LOAD
- ABC TYPE FIRE EXTINGUISHER
- K TYPE FIRE EXTINGUISHER
- INCIDENTAL USE AREA/ACCESSORY OCCUPANCY
- KNEX BOX
- COMMON PATH OF TRAVEL
- TRAVEL DISTANCE TO EXIT
- EGRESS WIDTH
- EGRESS CAPACITY
- # OF OCCUPANTS AT EXIT

OCCUPANT LOAD FACTORS (PER NFPA 7.3.1.2)


- (A) ASSEMBLY LESS CONCENTRATED - 15 NET SF
- (B) BUSINESS - 150 SF
- (C) CLASSROOM - 20 NET SF
- (DC) DAY CARE - 35 NET SF
- (K) KITCHEN - 100 SF
- (M) MERCANTILE - 30 SF
- (RT) RUNNING TRACK - 50 SF
- (S) STORAGE - 500 SF
- (V) WORKSHOP/VOCATIONAL - 50 NET SF

OUTDOOR COURT PER IBC CH 2 & SECTION 1205. NOT INCLUDED IN BUILDING AREA PER IBC, BUT OCCUPANTS ACCOUNTED FOR IN MEANS OF EGRESS.

ASSEMBLY EXERCISE ROOM W/ EQPT: 150 SF

COVERED DROP INCLUDED IN BUILDING AREA

1 LIFE SAFETY PLAN
SCALE: 1/8" = 1'-0"

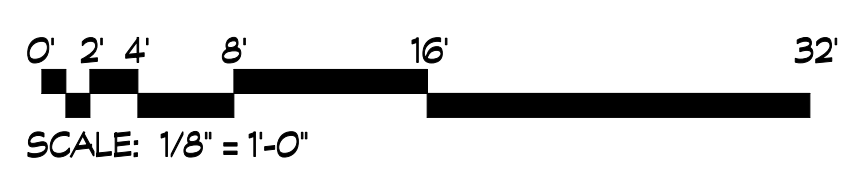

dickinson
ARCHITECTS
Architecture/Interior Design/Planning
771 Broad Street Suite 200
Augusta, Georgia 30901
(706) 722-7488
mail@dickinsonarchitects.com
www.dickinsonarchitects.com

Member of the
American Institute of
Architects

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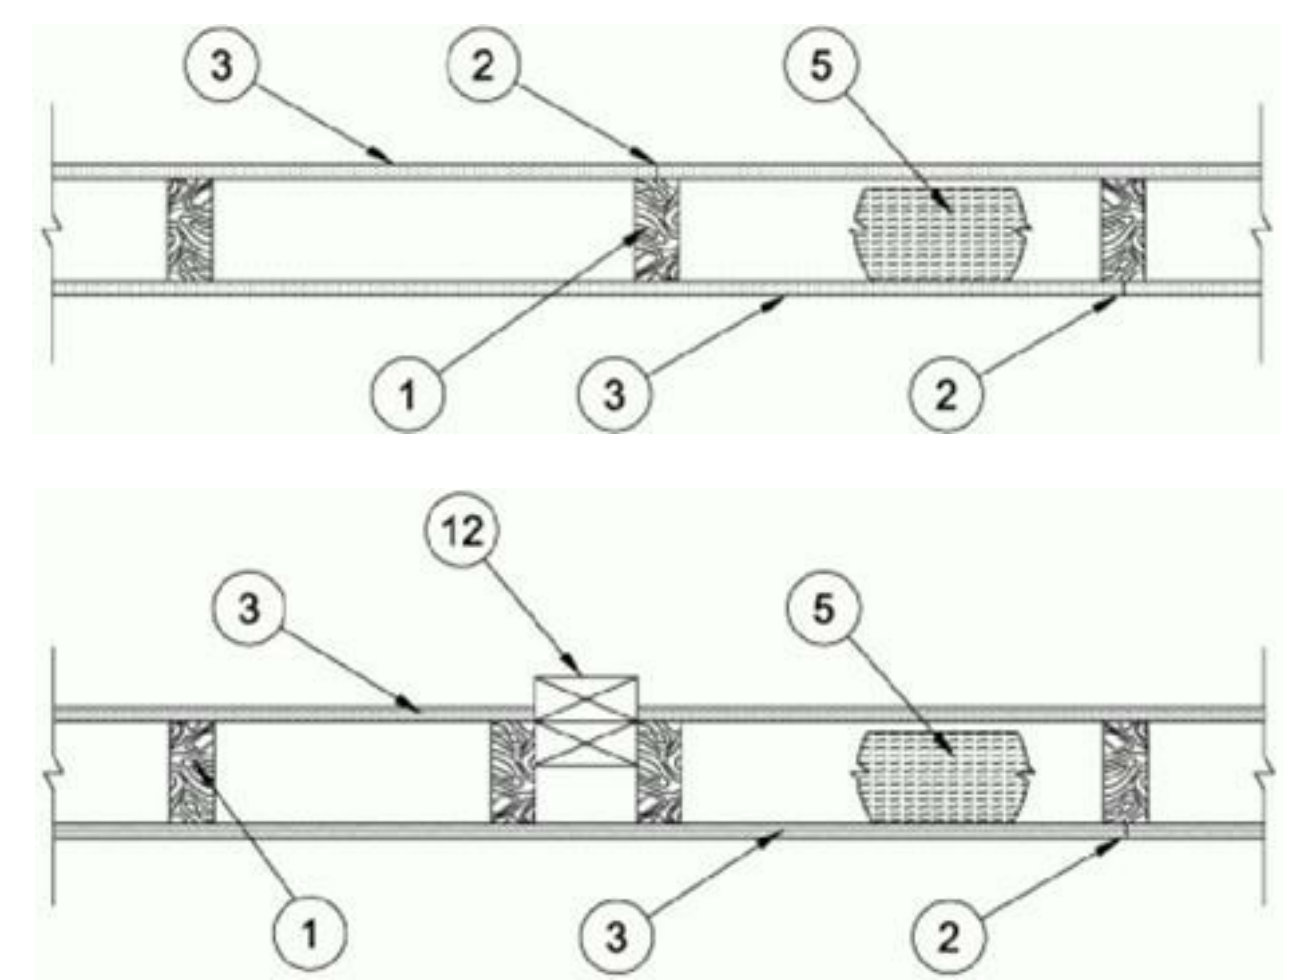
DA PROJECT NUMBER & NAME:
1893
DRAWING TITLE:
**LIFE SAFETY
PLAN**

DRAWING NO:
LS101

1 2 3 4 5 6

Design No. U305
July 29, 2021
Bearing Wall Rating — 1 Hr
Finish Rating — See Items 3, 3A, 3D, 3E, 3F, 3G, 3H, 3J and 3L.
STC Rating - 56 (See Item 9)

* Indicates such products shall bear the UL or cUL Certification Mark for jurisdictions employing the UL or cUL Certification (such as Canada), respectively.




2
1-HR HORIZ. SHAFT WALL ASSEMBLY
SCALE: 1 1/2" = 1'-0"

Design No. U415
June 05, 2019

Nonbearing Wall Ratings — 1, 2, 3 or 4 Hr

* Indicates such products shall bear the UL or cUL Certification Mark for jurisdictions employing the UL or cUL Certification (such as Canada), respectively.

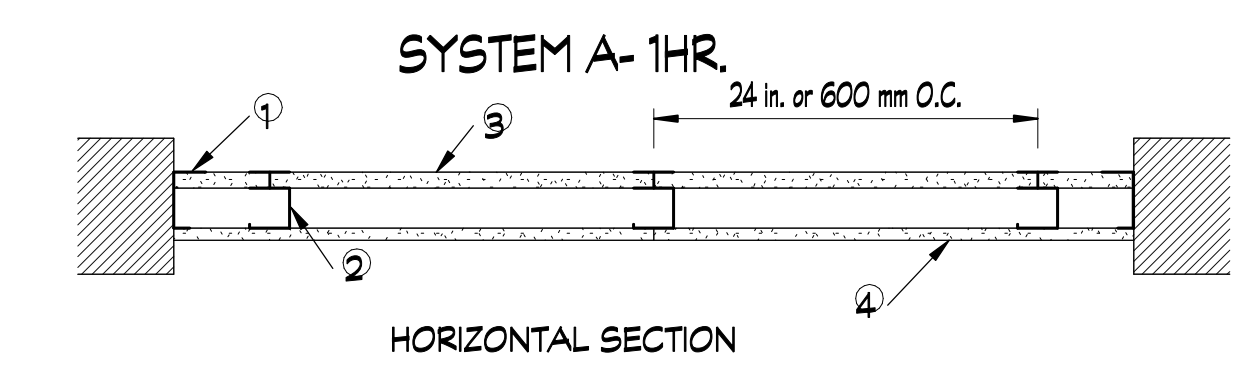

1. Floor, Side and Ceiling Runners — "J" - shaped runner, min 2-1/2 in. deep (min 4 in. deep when System C is used), with unequal legs of 1 in. and 2 in., fabricated from min 24 MSG (min 20 MSG when Item 4A, 4B, 4C, 4D or 7 are used) galv steel. Runners positioned with short leg toward finished side of wall. Runners attached to structural supports with steel fasteners located not greater than 2 in. from ends and not greater than 24 in. OC. "E" - shaped studs (Item 2A) may be used as side runners in place of "J" - shaped runners.

2. Steel Studs — "C-H" - shaped studs, min 2-1/2 in. deep (min 4 in. deep when System C is used), fabricated from min 25 MSG (min 20 MSG when Items 2D, 4A, 4B, 4C, 4D or 7 is used) galv steel. Cut to lengths 3/8 to 1/2 in. less than floor-to-ceiling height and spaced 24 in. or 600 mm OC (max 16 in. OC when Items 4A, 4B, 4C, or 4D are used).

3. Gypsum Board* — Gypsum liner panels, nom 1 in. thick, 24 in. or 600 mm (for metric spacing) wide. Panels cut 1 in. less in length than floor to ceiling height. Vertical edges inserted in "H" portion of "C-H" studs or the gap between the two 3/4 in. legs of the "E" studs. Free edge of end panels attached to long leg of vertical "J" - runners with 1-5/8 in. long Type S steel screws spaced not greater than 12 in. OC. When wall height exceeds liner panel length, liner panel may be butted to extend to the full height of the wall. Horizontal joints need not be backed by steel framing. In System 1, butt joints in liner panels are staggered min 36 in. Butt joints backed with 6 in. by 22 in. strips of 3/4 in. thick gypsum wallboard (Item 4). Wallboard strips centered over butt joints and secured to liner panels with six 1-1/2 in. long Type G steel screws, three screws along the 22 in. dimension at the top and bottom of the strips.

CGC INC — Type SLX

UNITED STATES GYPSUM CO — Type SLX
USG BORAL DRYWALL SFZ LLC — Type SLX
USG MEXICO S A DE C V — Type SLX

4. Gypsum Board* — System A — 1 Hr
Gypsum panels, with beveled, square or tapered edges, nom 5/8 in. thick, 48 in. or 1200 mm wide, applied vertically or horizontally, attached to studs with 1 in. long Type S steel screws spaced 12 in. when installed vertically or 8 in OC when installed horizontally. Horizontal joints need not be backed by steel framing.

CGC INC — Types AR, C, IP-AR, IP-X1, IP-X2, IPC-AR, SCX, SHX, ULX, USGX, WRC, WRX
UNITED STATES GYPSUM CO — Types AR, C, FRX-G, IP-AR, IP-X1, IP-X2, IPC-AR, SCX, SGX, SHX, ULX, ULX, WRC, WRX, USGX. When ULIX is used insulation, Item 6, **Batts and Blankets*** is required and minimum stud depth is 4 in.


5. Joint Tape and Compound — (Not Shown)
Systems A, B, C, E, F, G, H, I
Joints on outer layers of gypsum board (Item 4 and 4A) covered with paper tape and joint compound. Paper tape and joint compound may be omitted when gypsum boards are supplied with square edges. Exposed screw heads covered with joint compound.

6. Batts and Blankets* — Systems A, B, E, F, G, H, I
(Optional) — Mineral wool or glass fiber batts partially or completely filling stud cavity. Any mineral wool or glass fiber batt mineral bearing the UL Classification Marking as to Fire Resistance.

System A With Type ULIX Gypsum Boards
Placed in stud cavities, any min. 3-1/2 in. thick glass fiber insulation bearing the UL Classification Marking as to Surface Burning Characteristics and/or Fire Resistance. See **Batts and Blankets (BKNV or BZJZ) Categories** for names of Classified companies.

* Indicates such products shall bear the UL or cUL Certification Mark for jurisdictions employing the UL or cUL Certification (such as Canada), respectively.

*NOTE: SEE CURRENT UL DESIGN FOR FULL PRODUCT INFORMATION AND ALTERNATE ACCEPTABLE MATERIALS

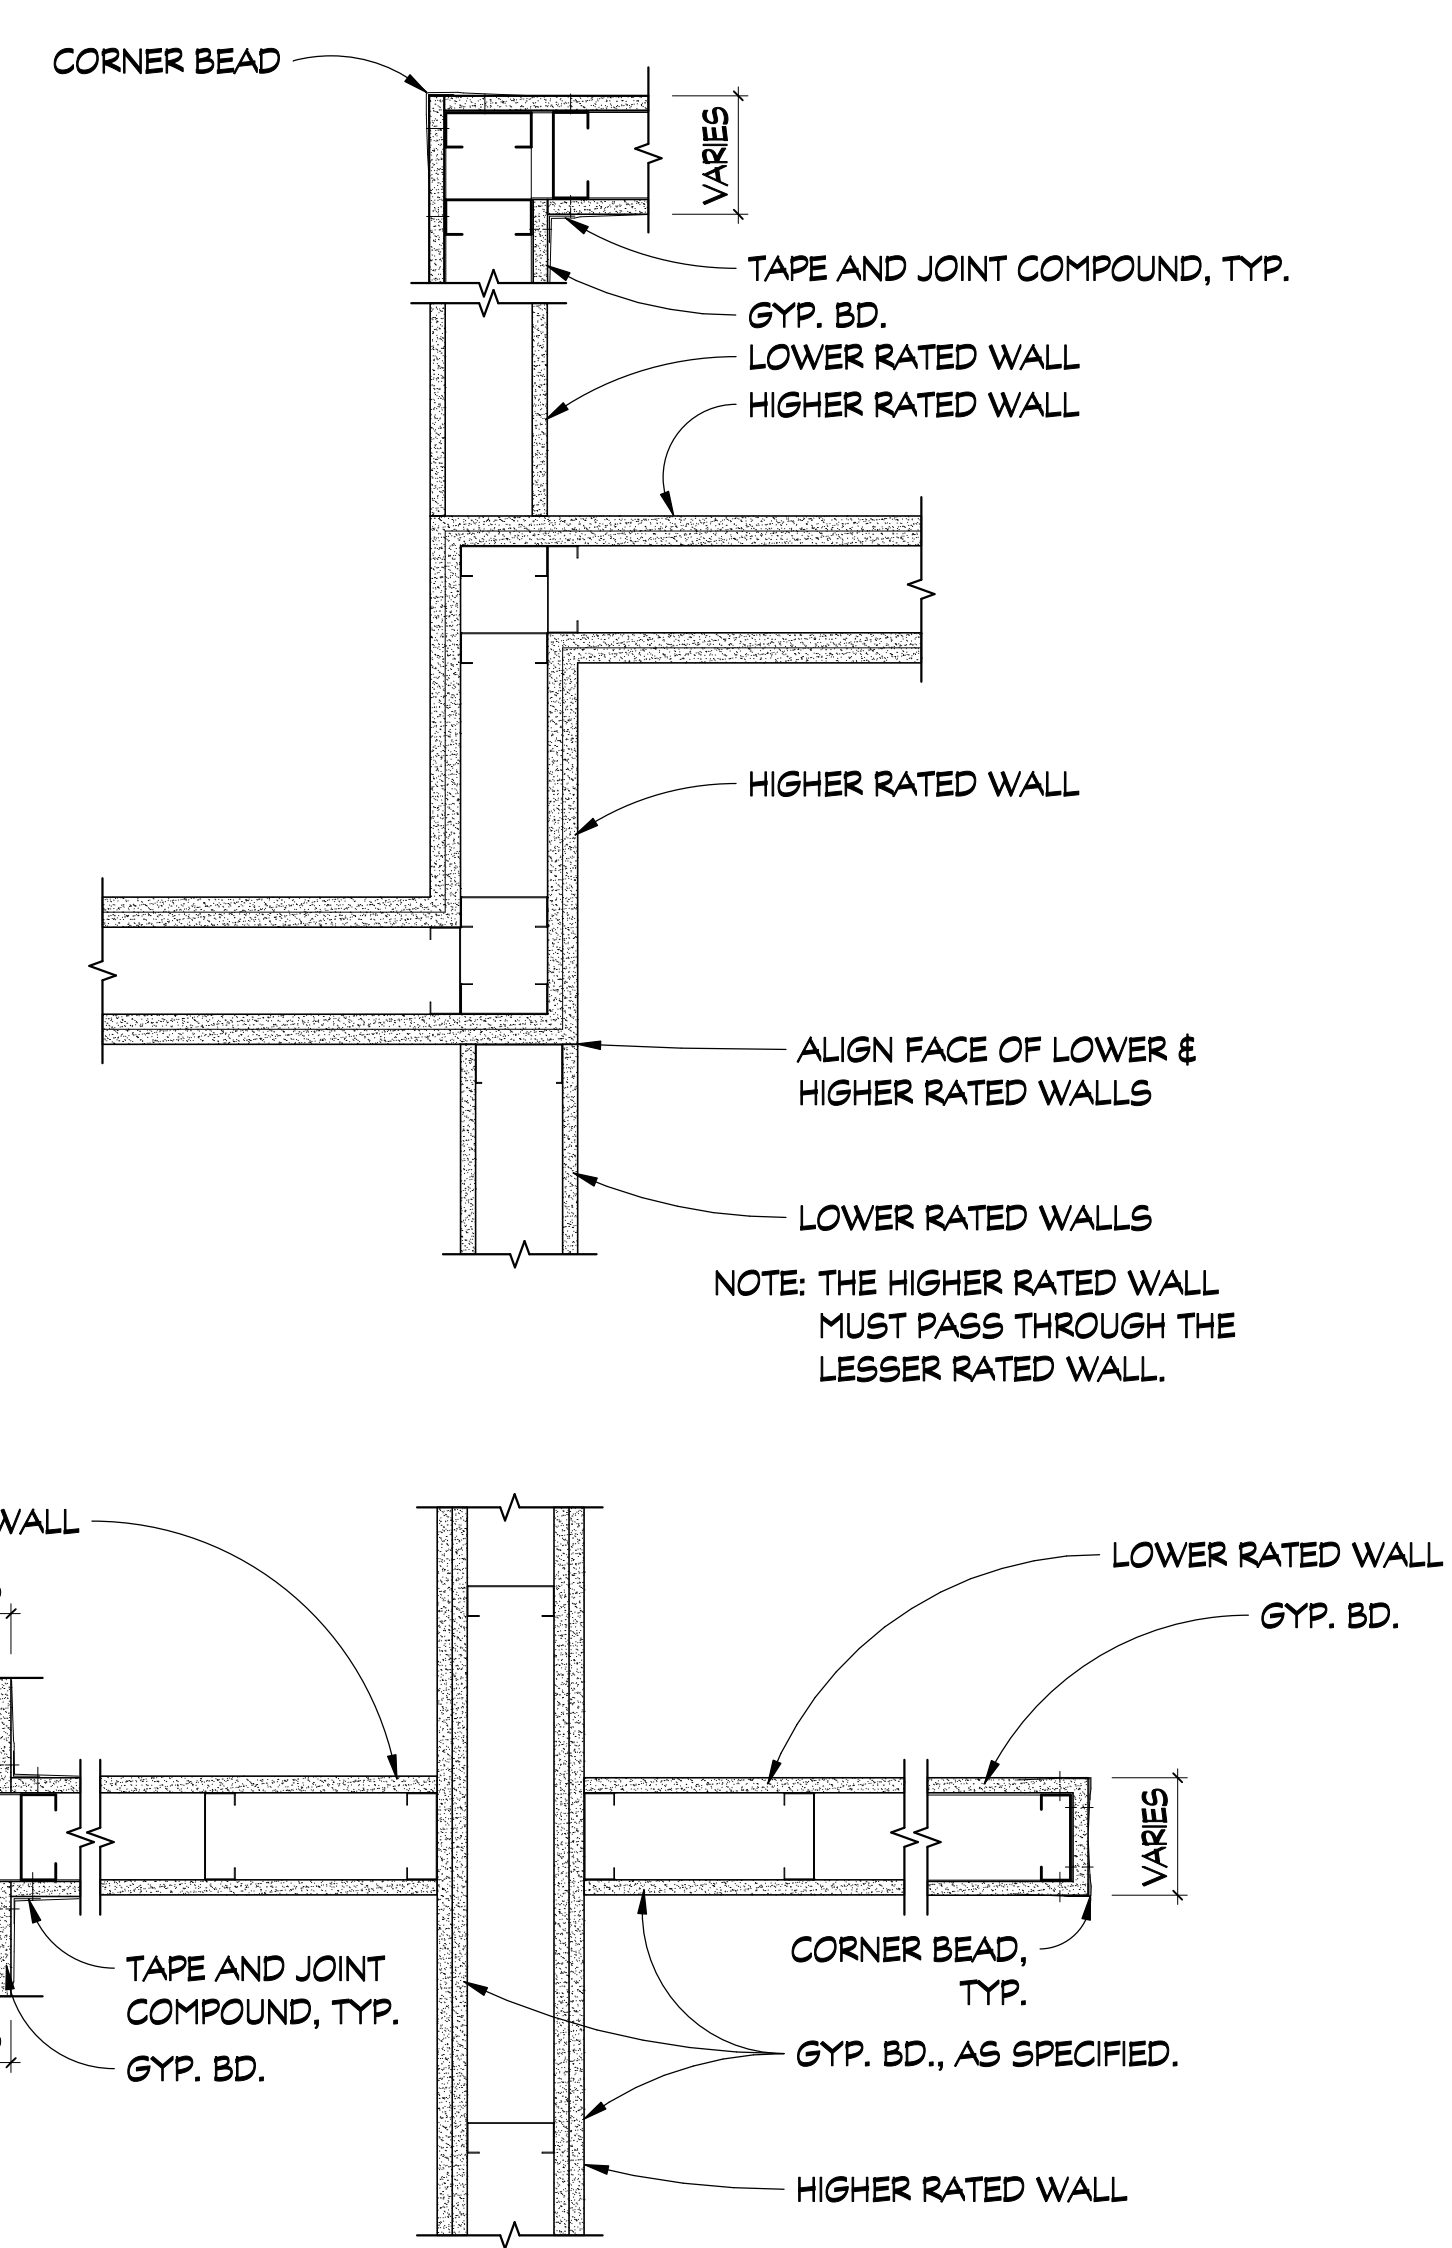

3
INTERSECTION OF RATED WALLS
SCALE: 1 1/2" = 1'-0"

1. Wood Studs — Nom 2 by 4 in. spaced 16 in. OC max. effectively freestopped.
2. Joints and Nail-Heads — Joints covered with joint compound and paper tape. Joint compound and paper tape may be omitted when square edge boards are used. As an alternate, nom 3/32 in. thick gypsum veneer plaster may be applied to the entire surface of Classified veneer baseboard with the joints reinforced with paper tape. Nailheads exposed or covered with joint compound.
3. Gypsum Board* — 5/8 in. thick paper or vinyl surfaced, with beveled, square, or tapered edges, applied either horizontally or vertically. Gypsum panels nailed 7 in. OC with 6d cement coated nails 1-7/8 in. long, 0.0915 in. shank diam and 15/64 in. diam heads. When used in widths other than 48 in., gypsum panels are to be installed horizontally.

AMERICAN GYPSUM CO — Types AGX-1 (finish rating 23 min.), M-Glass (finish rating 23 min.), Type AGX-11 (finish rating 26 min), Type AGX-12 (finish rating 22 min), Type LightRoc (finish rating 23 min.) or Type AG-C

CERTAINTEED GYPSUM INC — Type C, Type X or Type X-1 (finish rating 26 min); Type EGRG or GlasRoc (finish rating 23 min), GlasRoc-2, Type Habito (finish rating 26 min).

CERTAINTEED GYPSUM INC — Type LGFC6A (finish rating 34 min), Type LGFC2A, Type LGFC-C/A, Type LGFC-WD, Type LGLLX (finish rating 21 min), Type CLLX (finish rating 24 min)

GEORGIA-PACIFIC GYPSUM L L C — Type 5 (finish rating 26 min), Type 6 (finish rating 23 min), Type 9 (finish rating 26 min), Type C (finish rating 26 min), Type DGG (finish rating 20 min), Type GPF51 (finish rating 20 min), Type GPF52 (finish rating 20 min), Type GPF56 (finish rating 26 min), Type DS, Type DAP, Type DD (finish rating 20 min), Type DA, Type DAPC, Type LS (finish rating 23 min), Type X, Veneer Plaster Base - Type X, Water Rated - Type X, Sheathing - Type X, Soffit - Type X, Type LWX (finish rating 22 min), Veneer Plaster Base-Type LWX (finish rating 22 min), Water Rated-Type LWX (finish rating 22 min), Sheathing Type-LWX (finish rating 22 min), Soffit-Type LWX (finish rating 22 min), Type DGLW (finish rating 22 min), Water Rated-Type DGLW (finish rating 22 min), Sheathing Type- DGLW (finish rating 22 min), Soffit-Type DGLW (finish rating 22 min), Type LWX (finish rating 22 min), Type LW2X (finish rating 22 min), Veneer Plaster Base - Type LW2X (finish rating 22 min), Water Rated - Type LW2X (finish rating 22 min), Sheathing - Type LW2X (finish rating 22 min), Type DGL2W (finish rating 22 min), Type DGL2W (finish rating 22 min), Water Rated - Type DGL2W (finish rating 22 min), Sheathing - Type DGL2W (finish rating 22 min)

NATIONAL GYPSUM CO — Type FSK (finish rating 20 min), Type FSK-G (finish rating 20 min), Type FSW (finish rating 20 min), Type FSW-2 (finish rating 24 min), Type FSW-3 (finish rating 20 min), Type FSW-5 (finish rating 22 min), Type FSW-G (finish rating 20 min), Type FSK-C (finish rating 20 min), Type FSW-C (finish rating 20 min), Type FSKM-C, Type FSW-6 (finish rating 20 min), Type FSL (finish rating 24 min), Type FSW-8, Type FSLX (finish rating 21 min), Type RSX (finish rating 26 min).

PABCO BUILDING PRODUCTS L L C, DBA PABCO GYPSUM — Types C, PG-2 (finish rating 20 min), PG-3 (finish rating 20 min), Types PG-3W, PG-5W (finish rating 20 min), Type PG-4 (finish rating 20 min), Type PG-6 (finish rating 23 min), Types PG-3WS, PG-5WS, PGS-WRS (finish rating 20 min), Types PG-5, PG-9 (finish rating 26 min), PG-11 PG-13 (Nails increased to 2 in.), Type PG-C or PGI (finish rating 26 min)

UNITED STATES GYPSUM CO — Type AR (finish rating 24 min), Type C (finish rating 24 min), Type FRX-G (finish rating 29 min), Type IP-AR (finish rating 24 min), Type IPC-AR (finish rating 24 min), Type IP-X1 (finish rating 24 min), Type IP-X2 (finish rating 24 min), Type SHX (finish rating 24 min), Type SCX (finish rating 24 min), Type SGX (finish rating 24 min), Type ULX (finish rating 22 min), Type WRX (finish rating 24 min), Type WRC (finish rating 24 min), Type ULIX (finish rating 20 min)

5. Batts and Blankets* — (Optional — Required when Item 6A is used (RC-1)) — Glass fiber or mineral wool insulation. Placed to completely or partially fill the stud cavities. When Item 6A is used, glass fiber or mineral wool insulation shall be friction-fitted to completely fill the stud cavities.

CERTAINTEED CORP
JOHNS MANVILLE
KNAUF INSULATION LLC
MANSON INSULATION INC
ROCKWOOL — Types Acoustical Fire Batts and Type AFB, min. density 1.69 pcf / 27.0 kg/m³
ROCK WOOL MANUFACTURING CO — Delta Board

THERMAFIBER INC — Type SAFB, SAFB FF

5C. Batts and Blankets* — Required for use with resilient channels, Item 7, 3 in. thick mineral wool batts, friction-fitted to fill interior of wall.

THERMAFIBER INC — Type SAFB, SAFB FF

5D. Glass Fiber Insulation — (As an alternate to Item 5C) — 3 in. thick glass fiber batts bearing the UL Classification Marking as to Surface Burning and/or Fire Resistance, friction-fitted to fill the interior of the wall. See Batts and Blankets (BKNV or BZJZ) Categories for names of Classified companies.

5E. Batts and Blankets* — (Required for use with Wall and Partition Facings and Accessories, Item 3D) — Glass fiber insulation, nom 3-1/2 in. thick, min. density of 0.80 pcf, with a flame spread of 25 or less and a smoke developed of 50 or less, friction-fitted to completely fill the stud cavities. See Batts and Blankets Category (BKNV) for names of manufacturers.

5F. Fiber, Sprayed* — (Optional, Not Shown — Not for use with Items 6, 6A, 6B, 6C, or 6D) — As an alternate to Batts and Blankets (Item 5) and Item 5A - Spray applied granulated mineral fiber material. The fiber is applied with adhesive, at a minimum density of 4.0 pcf, to completely fill the enclosed cavity in accordance with the application instructions supplied with the product. See Fiber, Sprayed (CCAZ).

AMERICAN ROCKWOOL MANUFACTURING, LLC — Type Rockwool Premium Plus

8. Caulking and Sealants — (Not Shown, Optional) — A bead of acoustical sealant applied around the partition perimeter for sound control.


* Indicates such products shall bear the UL or cUL Certification Mark for jurisdictions employing the UL or cUL Certification (such as Canada), respectively.

*NOTE: SEE CURRENT UL DESIGN FOR FULL PRODUCT INFORMATION AND ALTERNATE ACCEPTABLE MATERIALS



1 2 3 4 5 6

E
D
C
B
A

1 2 3 4 5 6

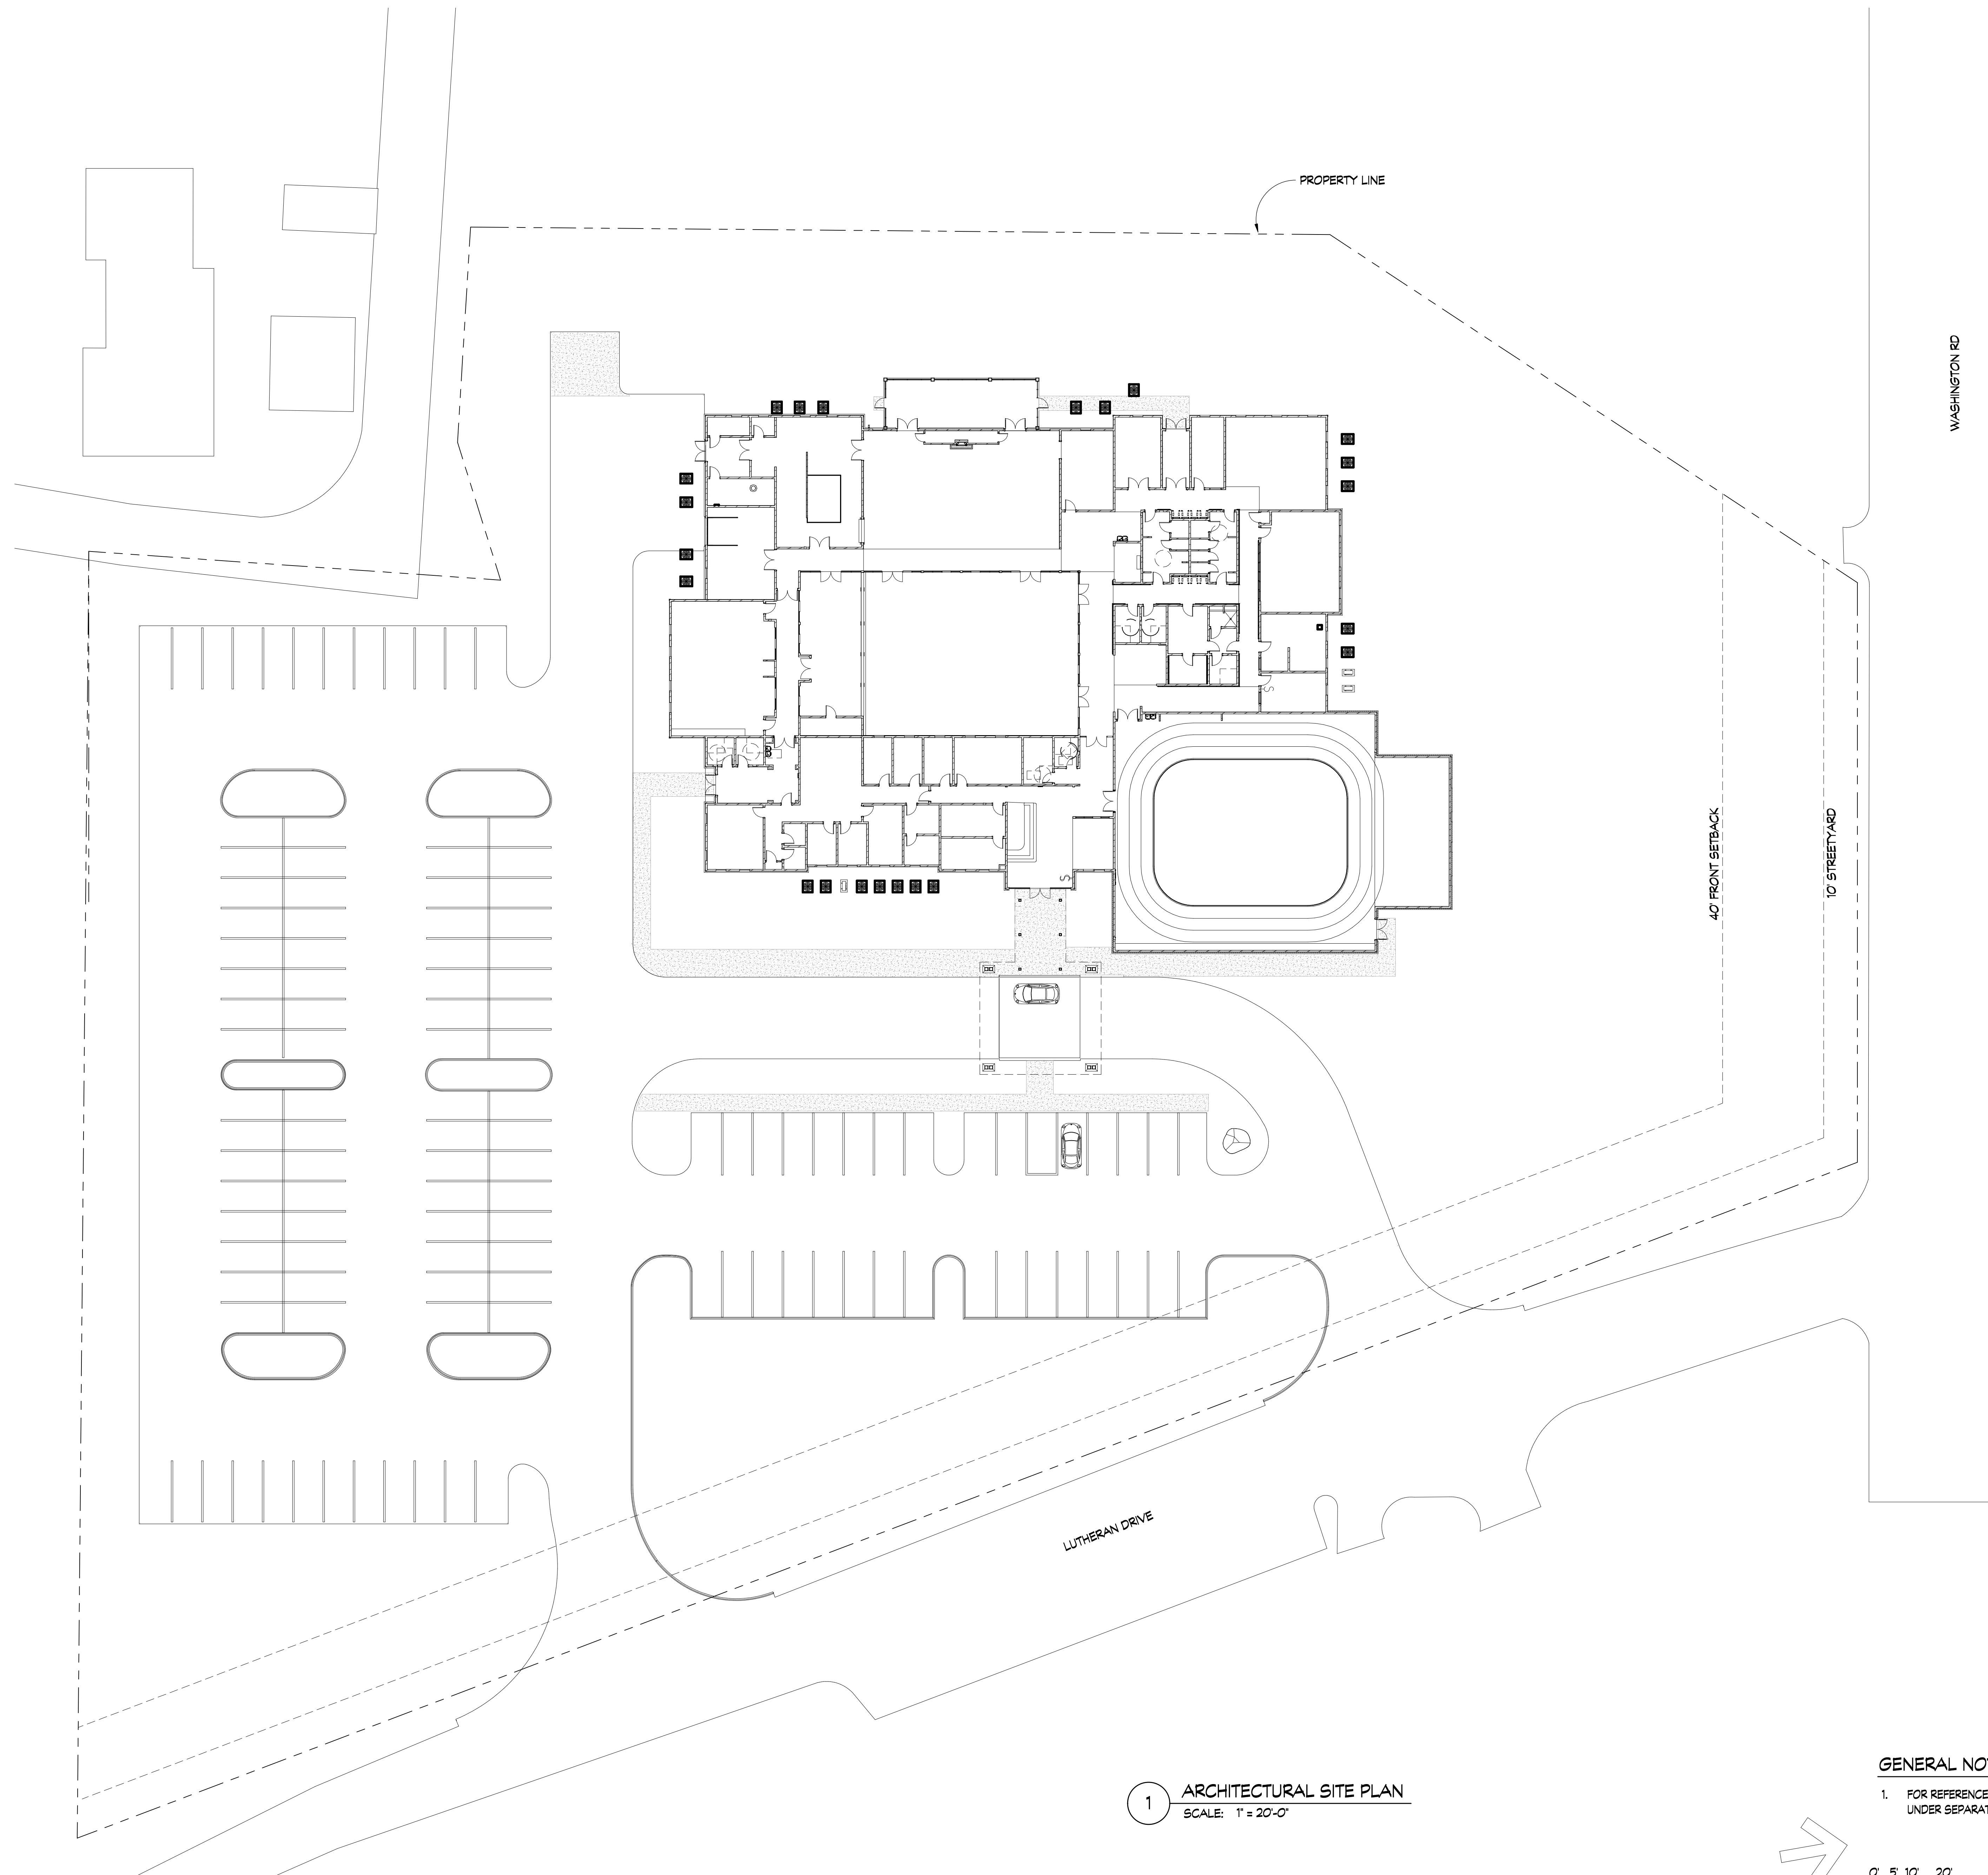

1 ARCHITECTURAL SITE PLAN
SCALE: 1" = 20'-0"

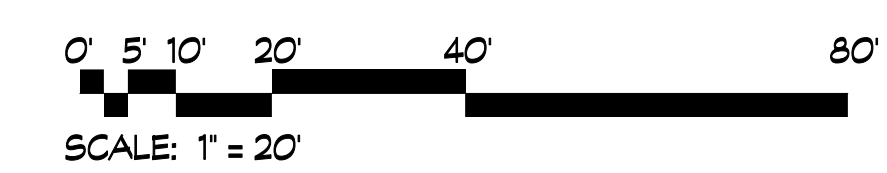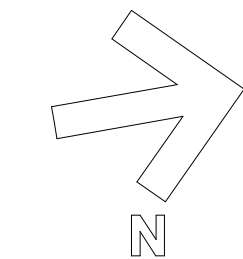

GENERAL NOTES:
1. FOR REFERENCE ONLY, SEE CIVIL DRAWINGS UNDER SEPARATE CONTRACT.


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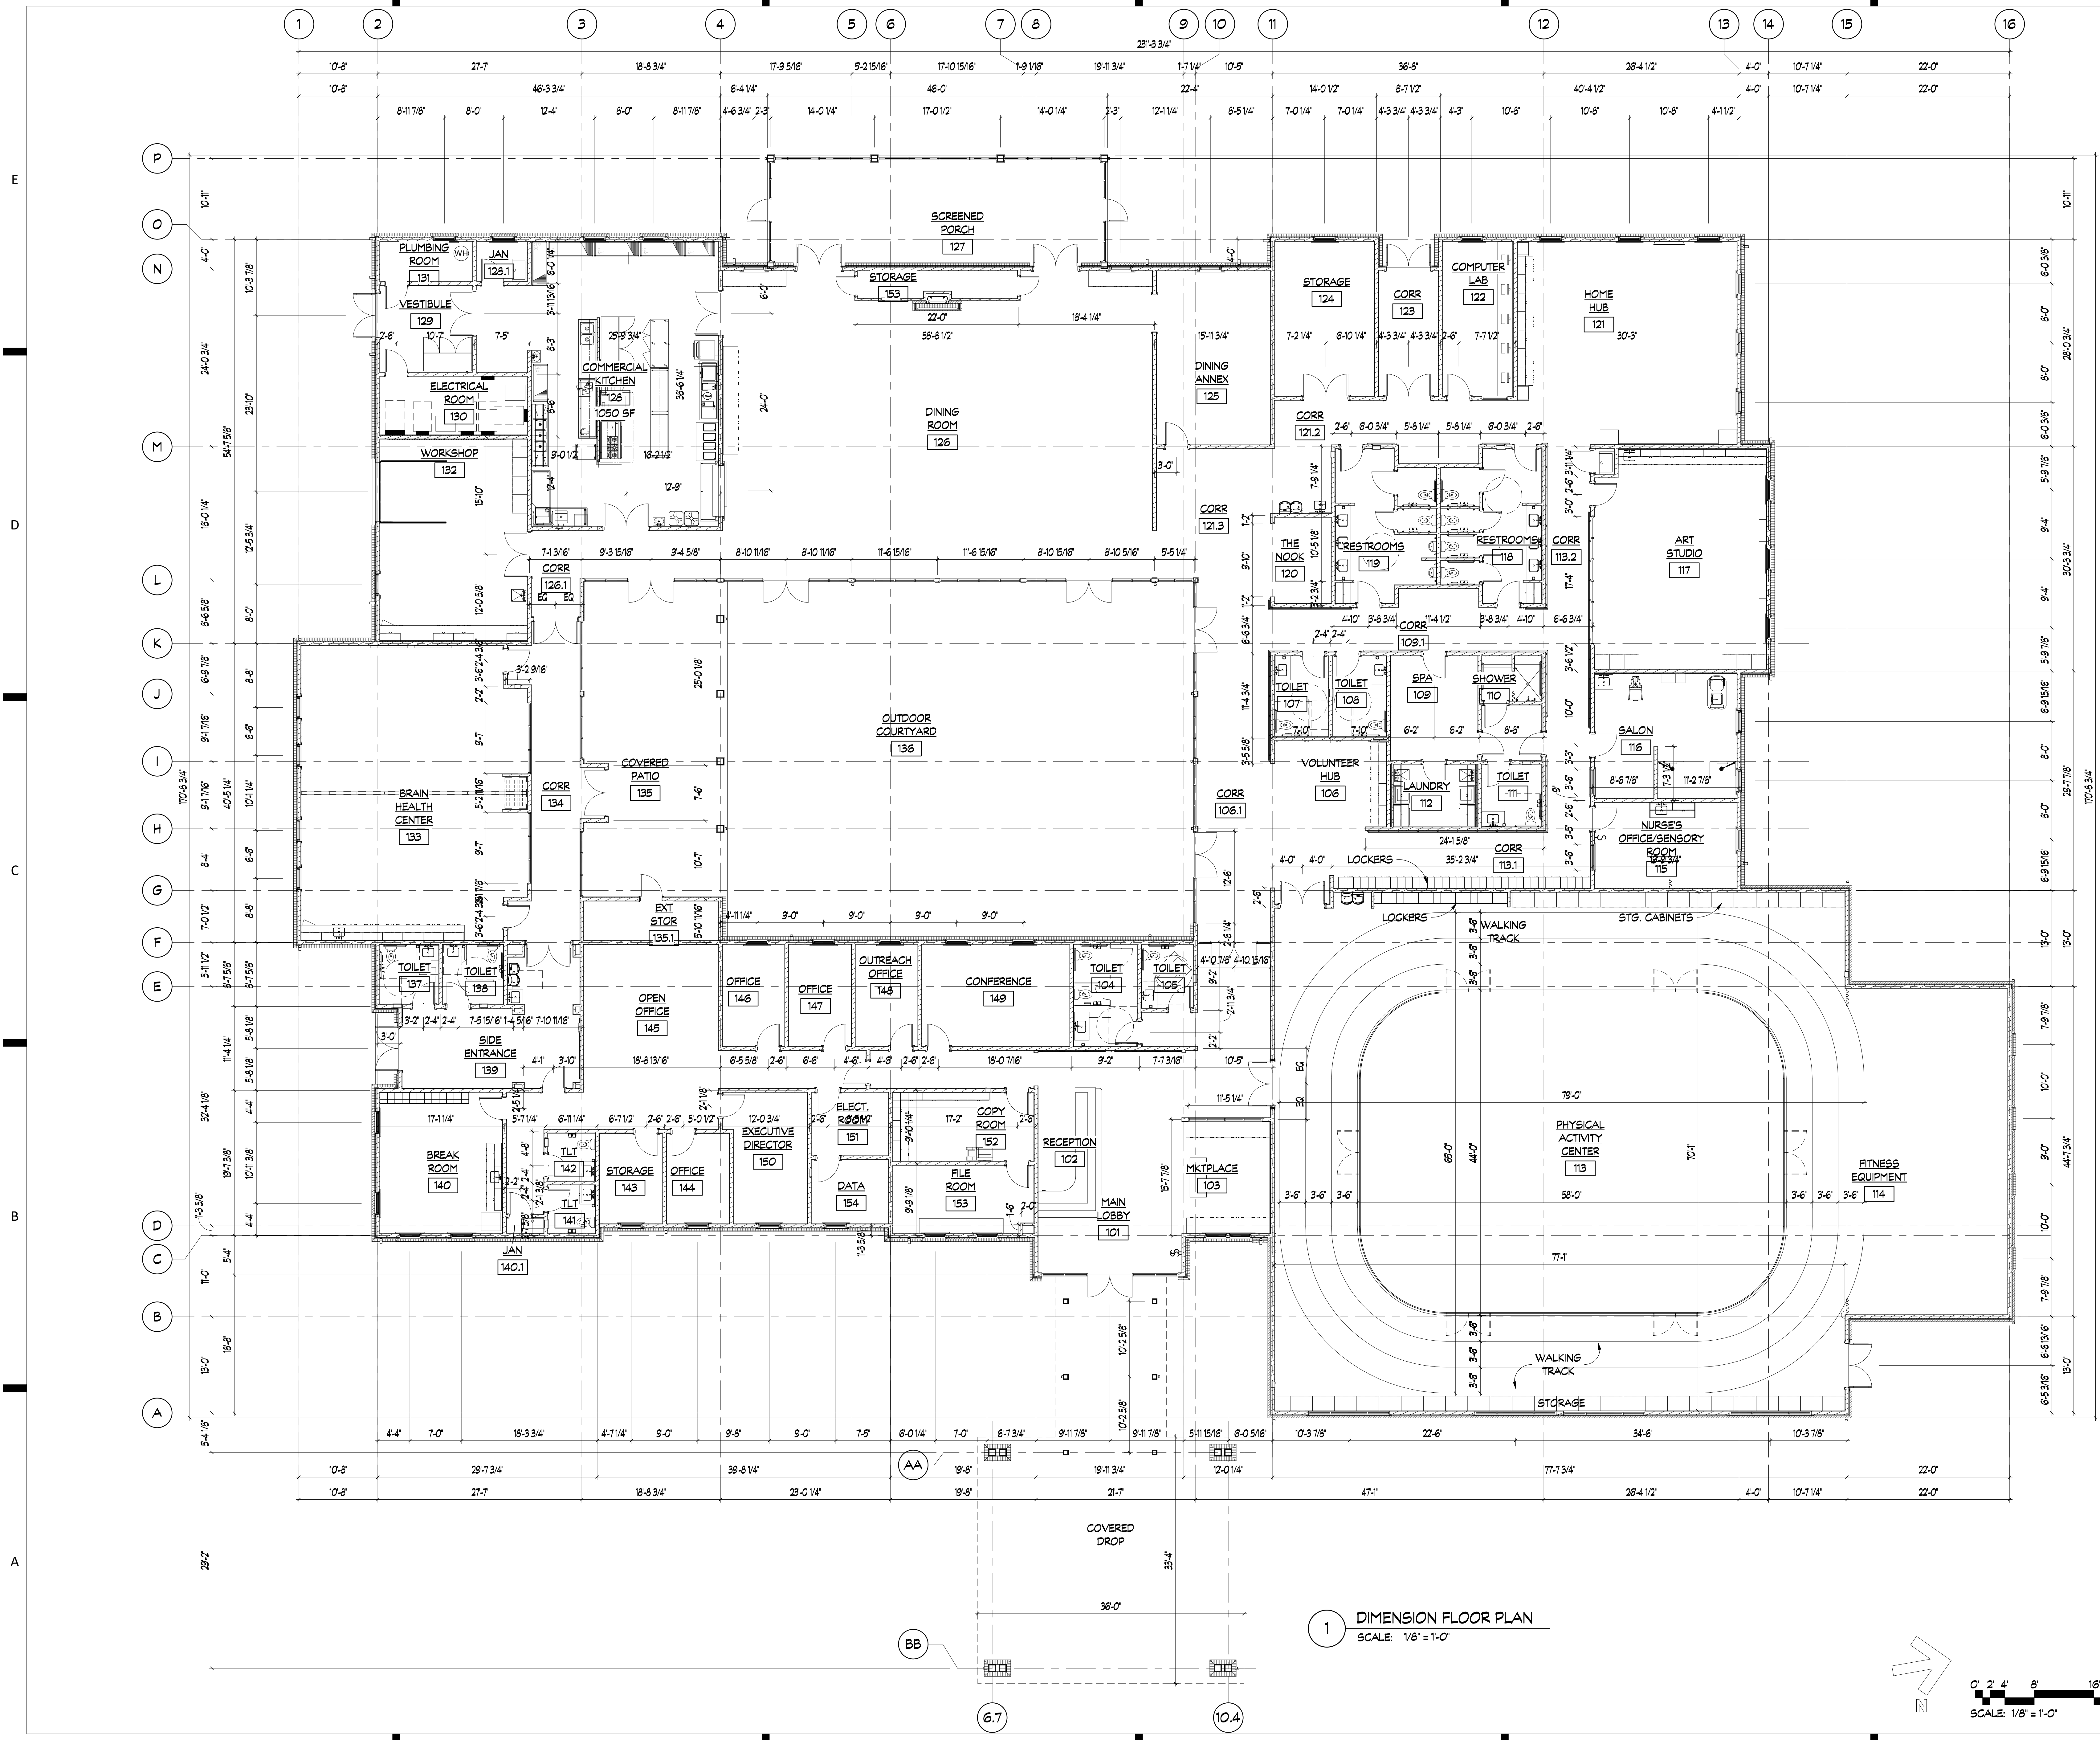
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HICKEY
CENTER**


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	DATE	APRVD BY	REVISION
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2	11/17/21	EA	65% SET
3	2/16/22	EA	ISSUE FOR PERMIT




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1893
DRAWING TITLE:
**ARCHITECTURAL
SITE PLAN**
DRAWING NO:
A100

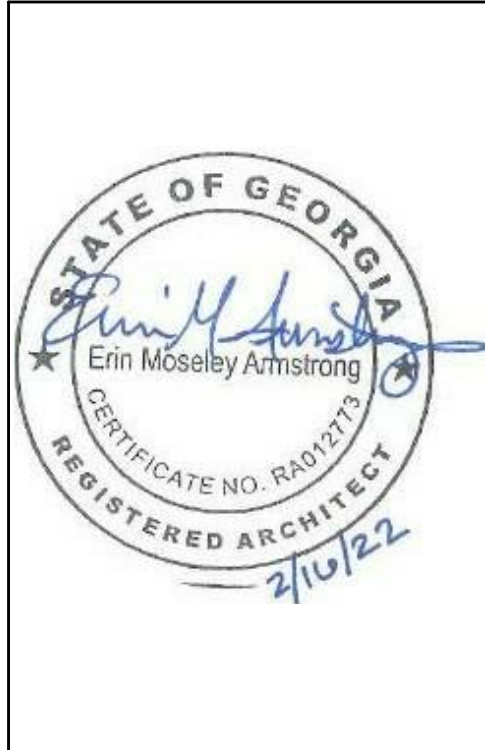


1 DIMENSION FLOOR PLAN
SCALE: 1/8" = 1'-0"

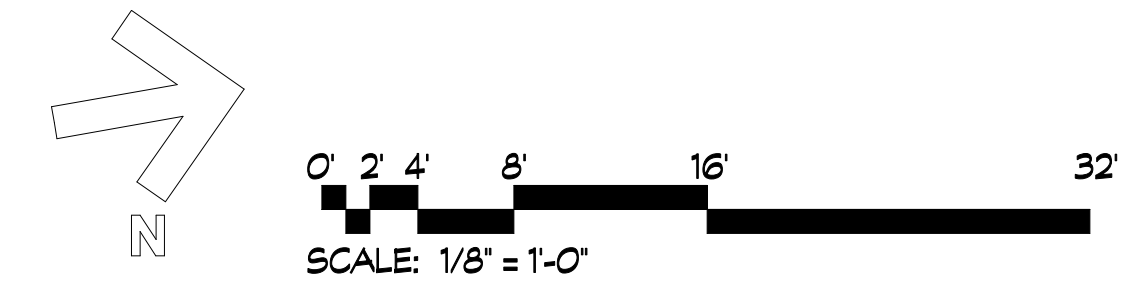

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3	2/16/22	EA		ISSUE FOR PERMIT

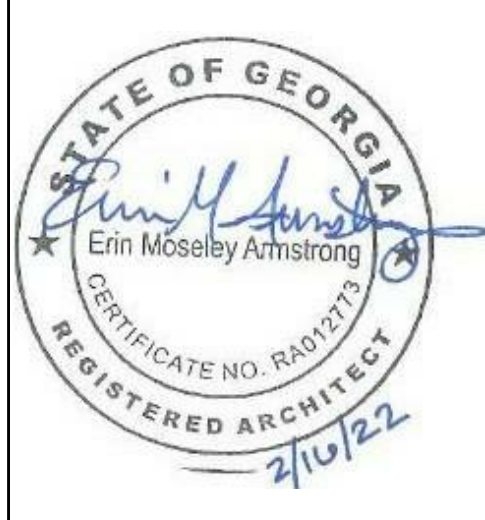

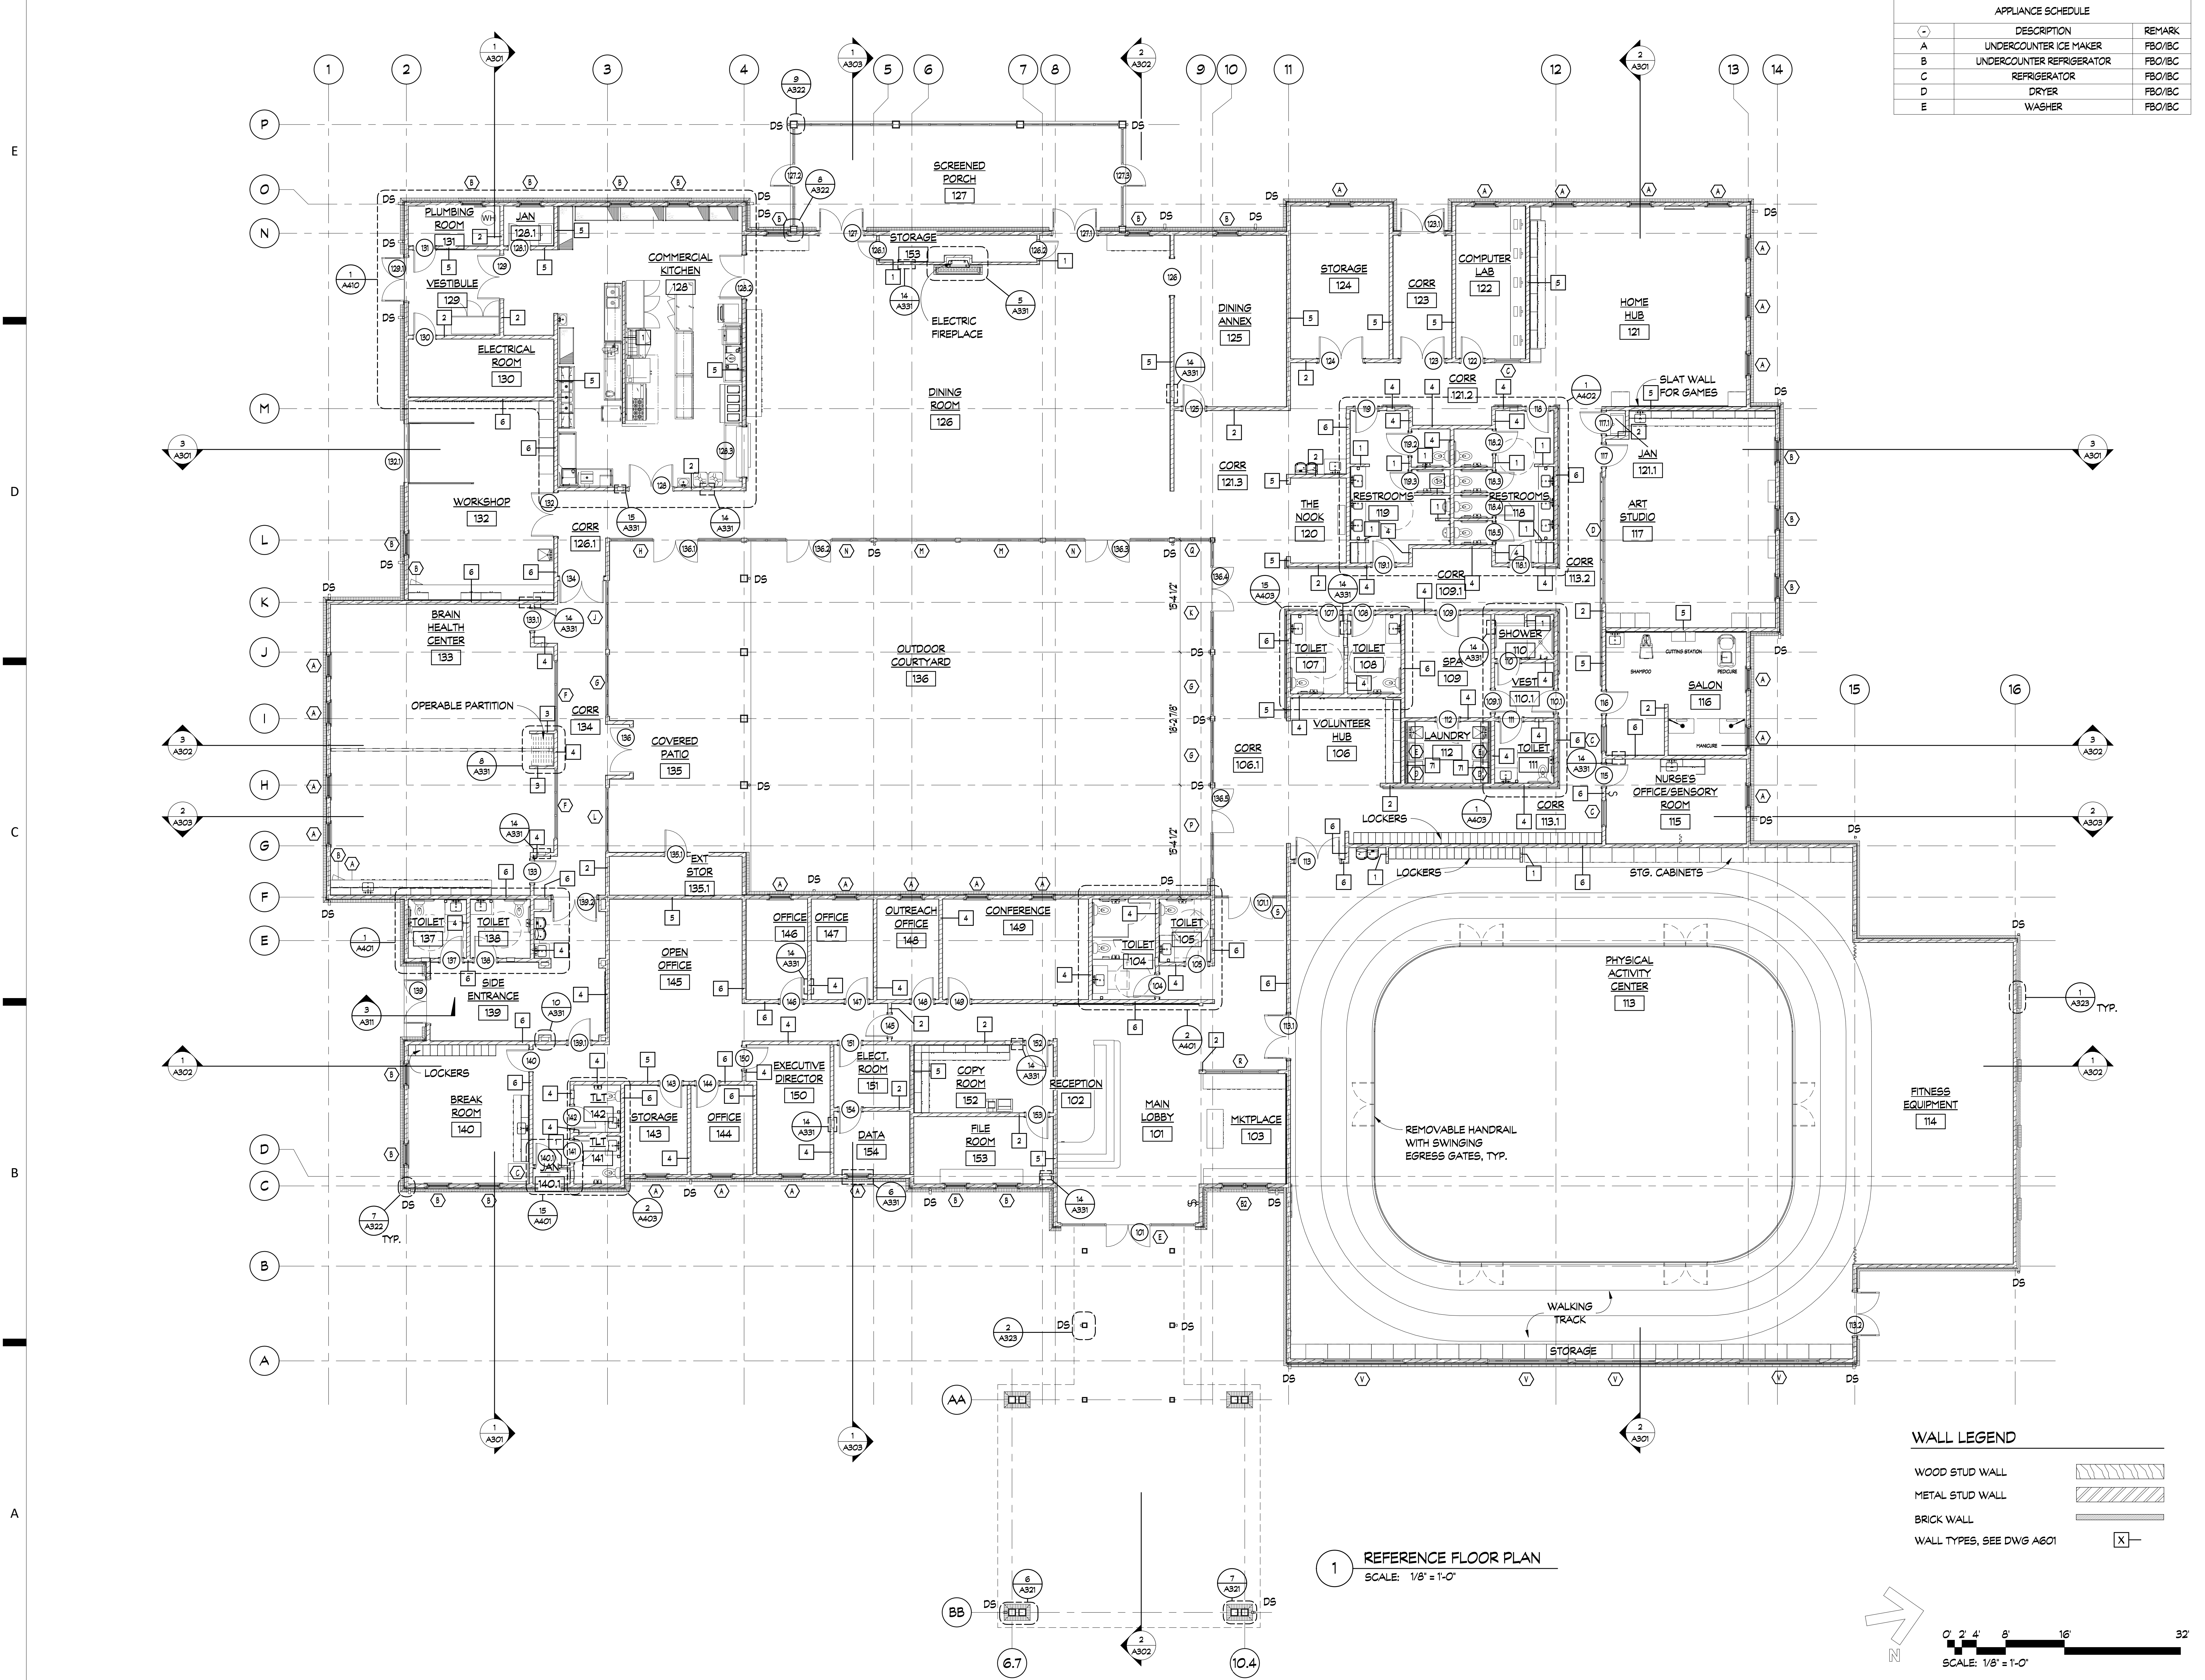


APPLIANCE SCHEDULE		
DESCRIPTION	REMARK	
A UNDERCOUNTER ICE MAKER	FBO/IBC	
B UNDERCOUNTER REFRIGERATOR	FBO/IBC	
C REFRIGERATOR	FBO/IBC	
D DRYER	FBO/IBC	
E WASHER	FBO/IBC	

dickinson ARCHITECTS
 Architecture/Interior Design/Planning
 771 Broad Street Suite 200
 Augusta, Georgia 30901
 (706) 722-7488
 mail@dickinsonarchitects.com
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REVISIONS				
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11/17/21	EA			65% SET
2/16/22	EA			ISSUE FOR PERMIT




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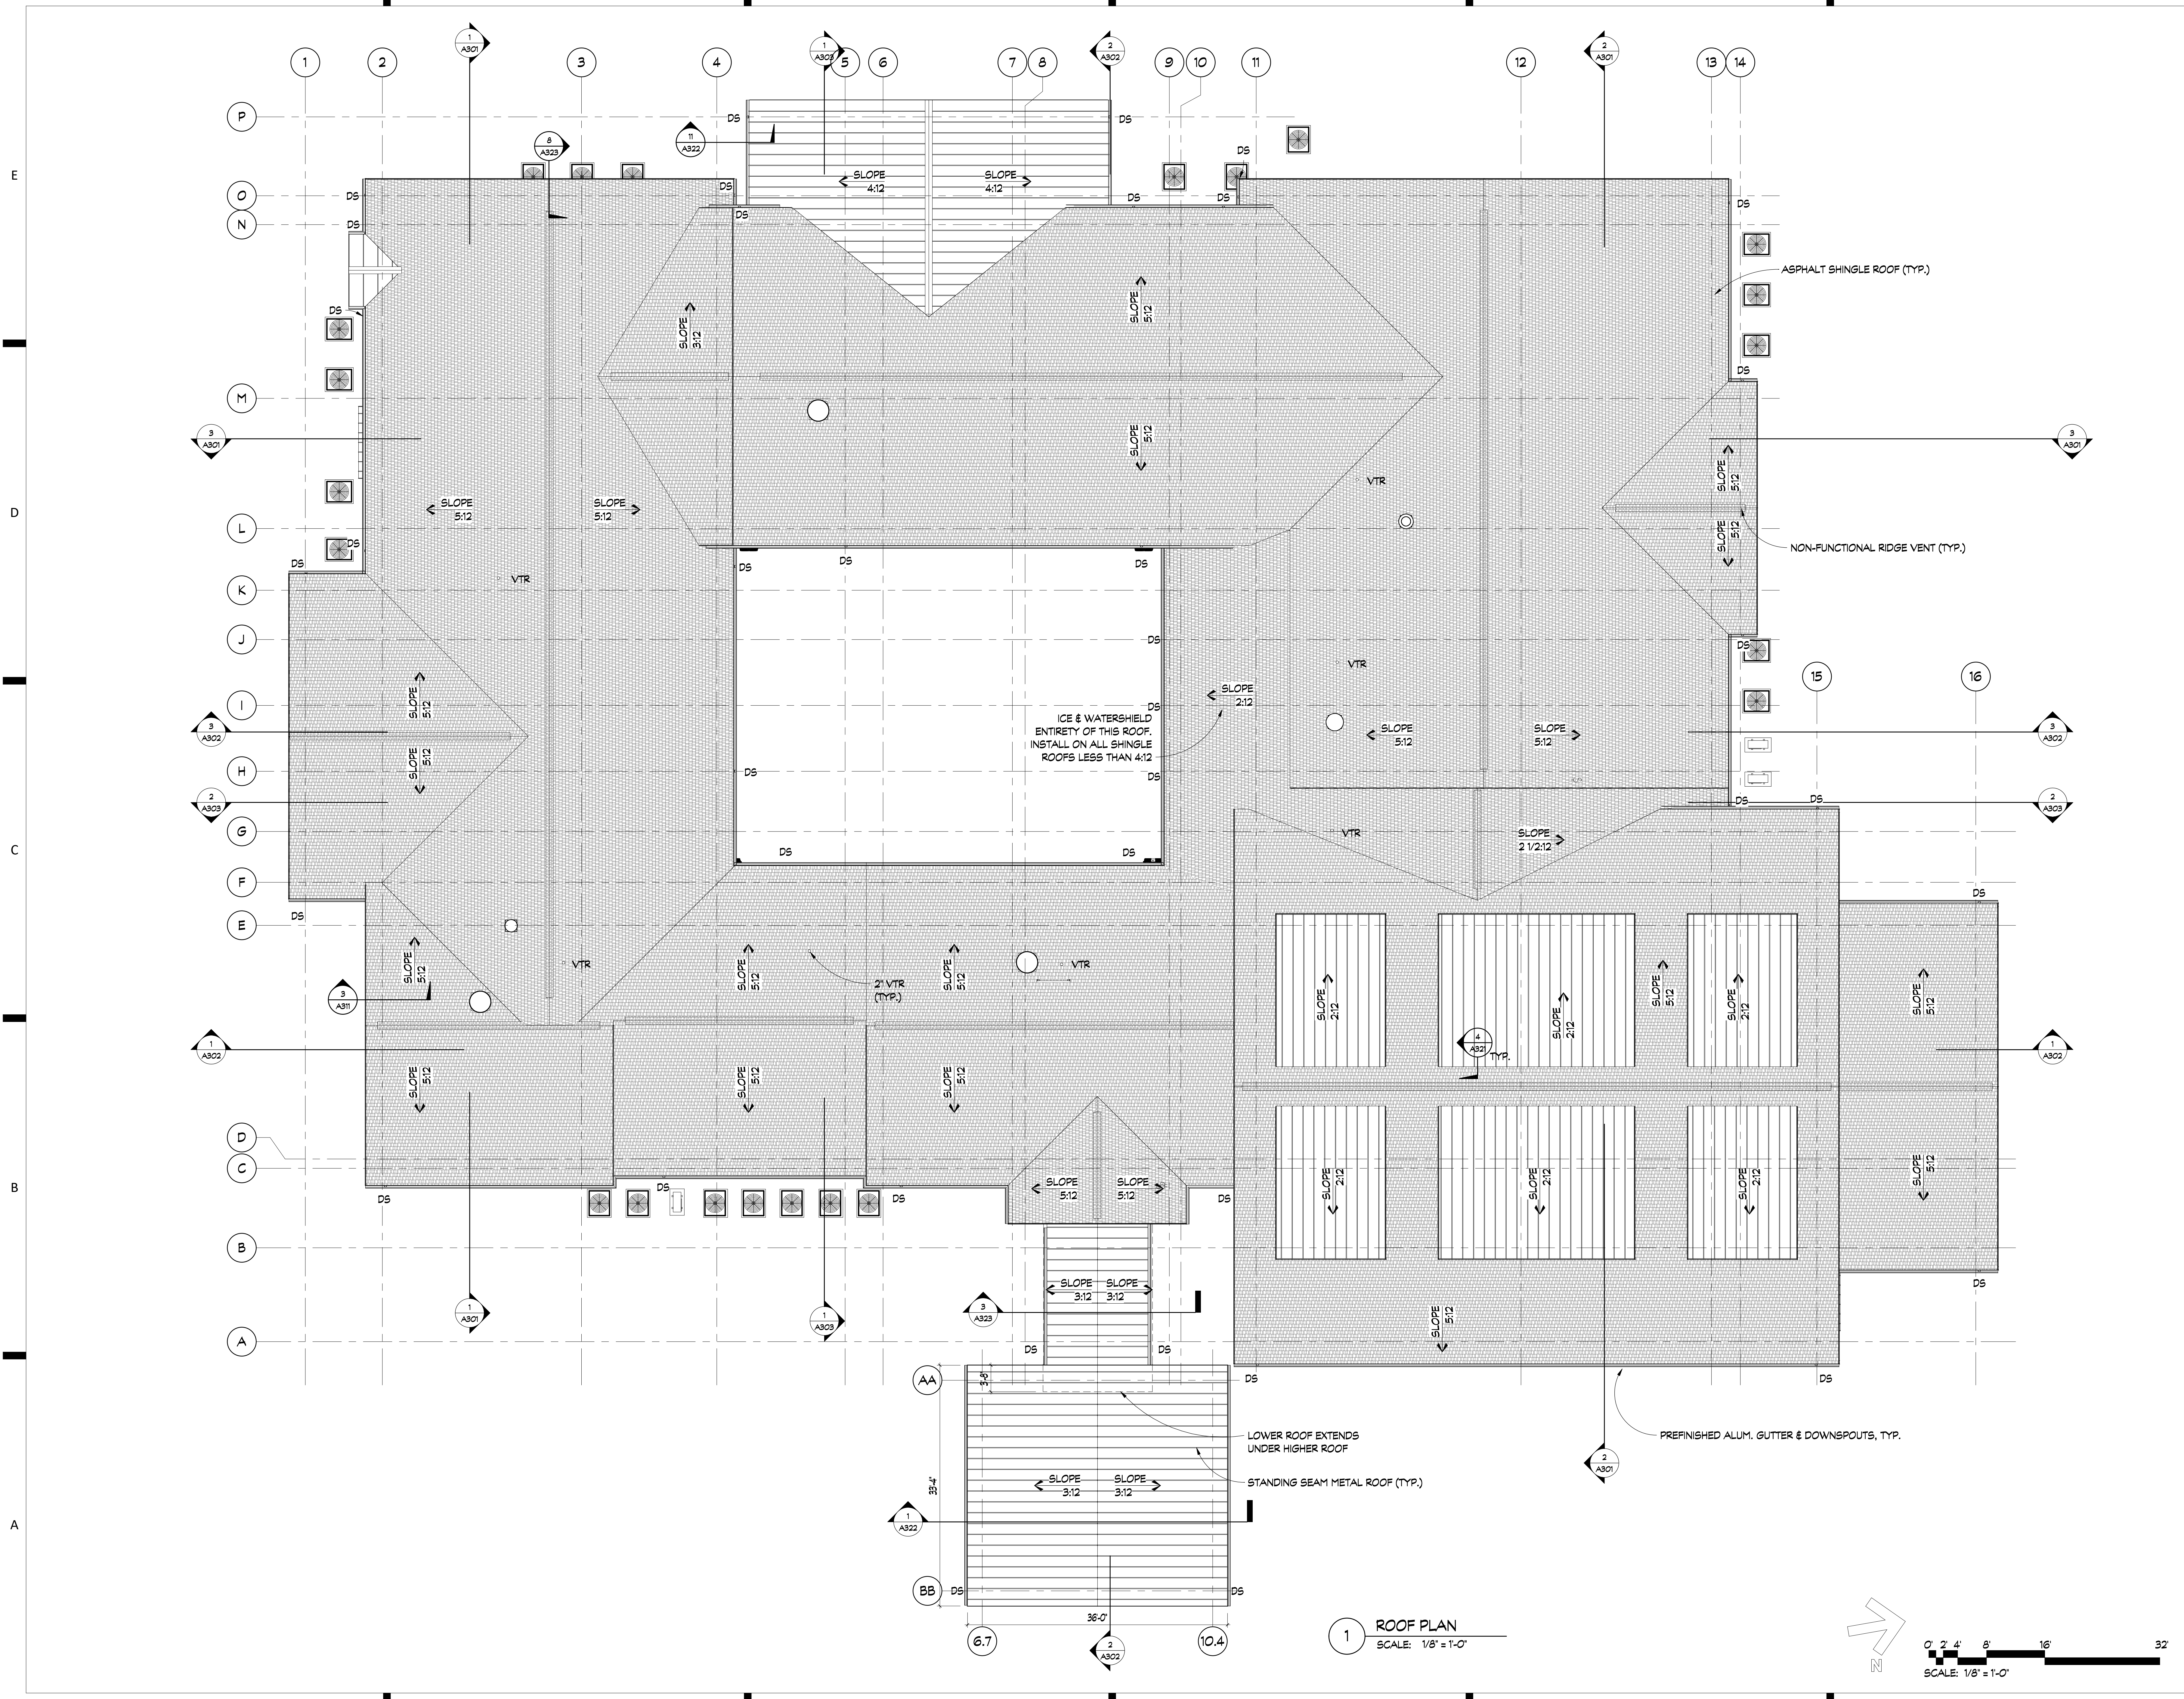
DRAWING NO:
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1 REFERENCE FLOOR PLAN
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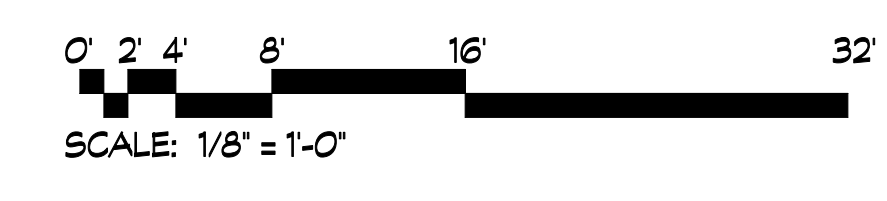
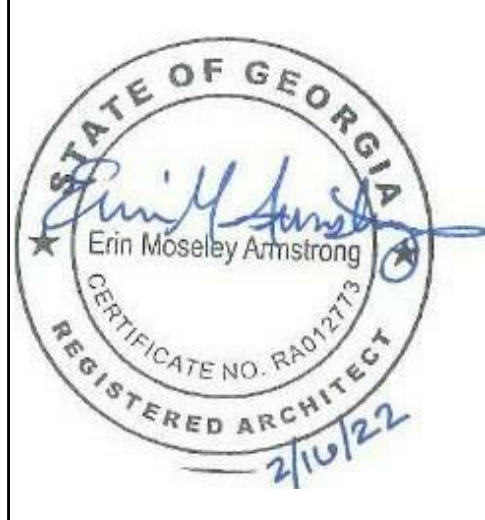
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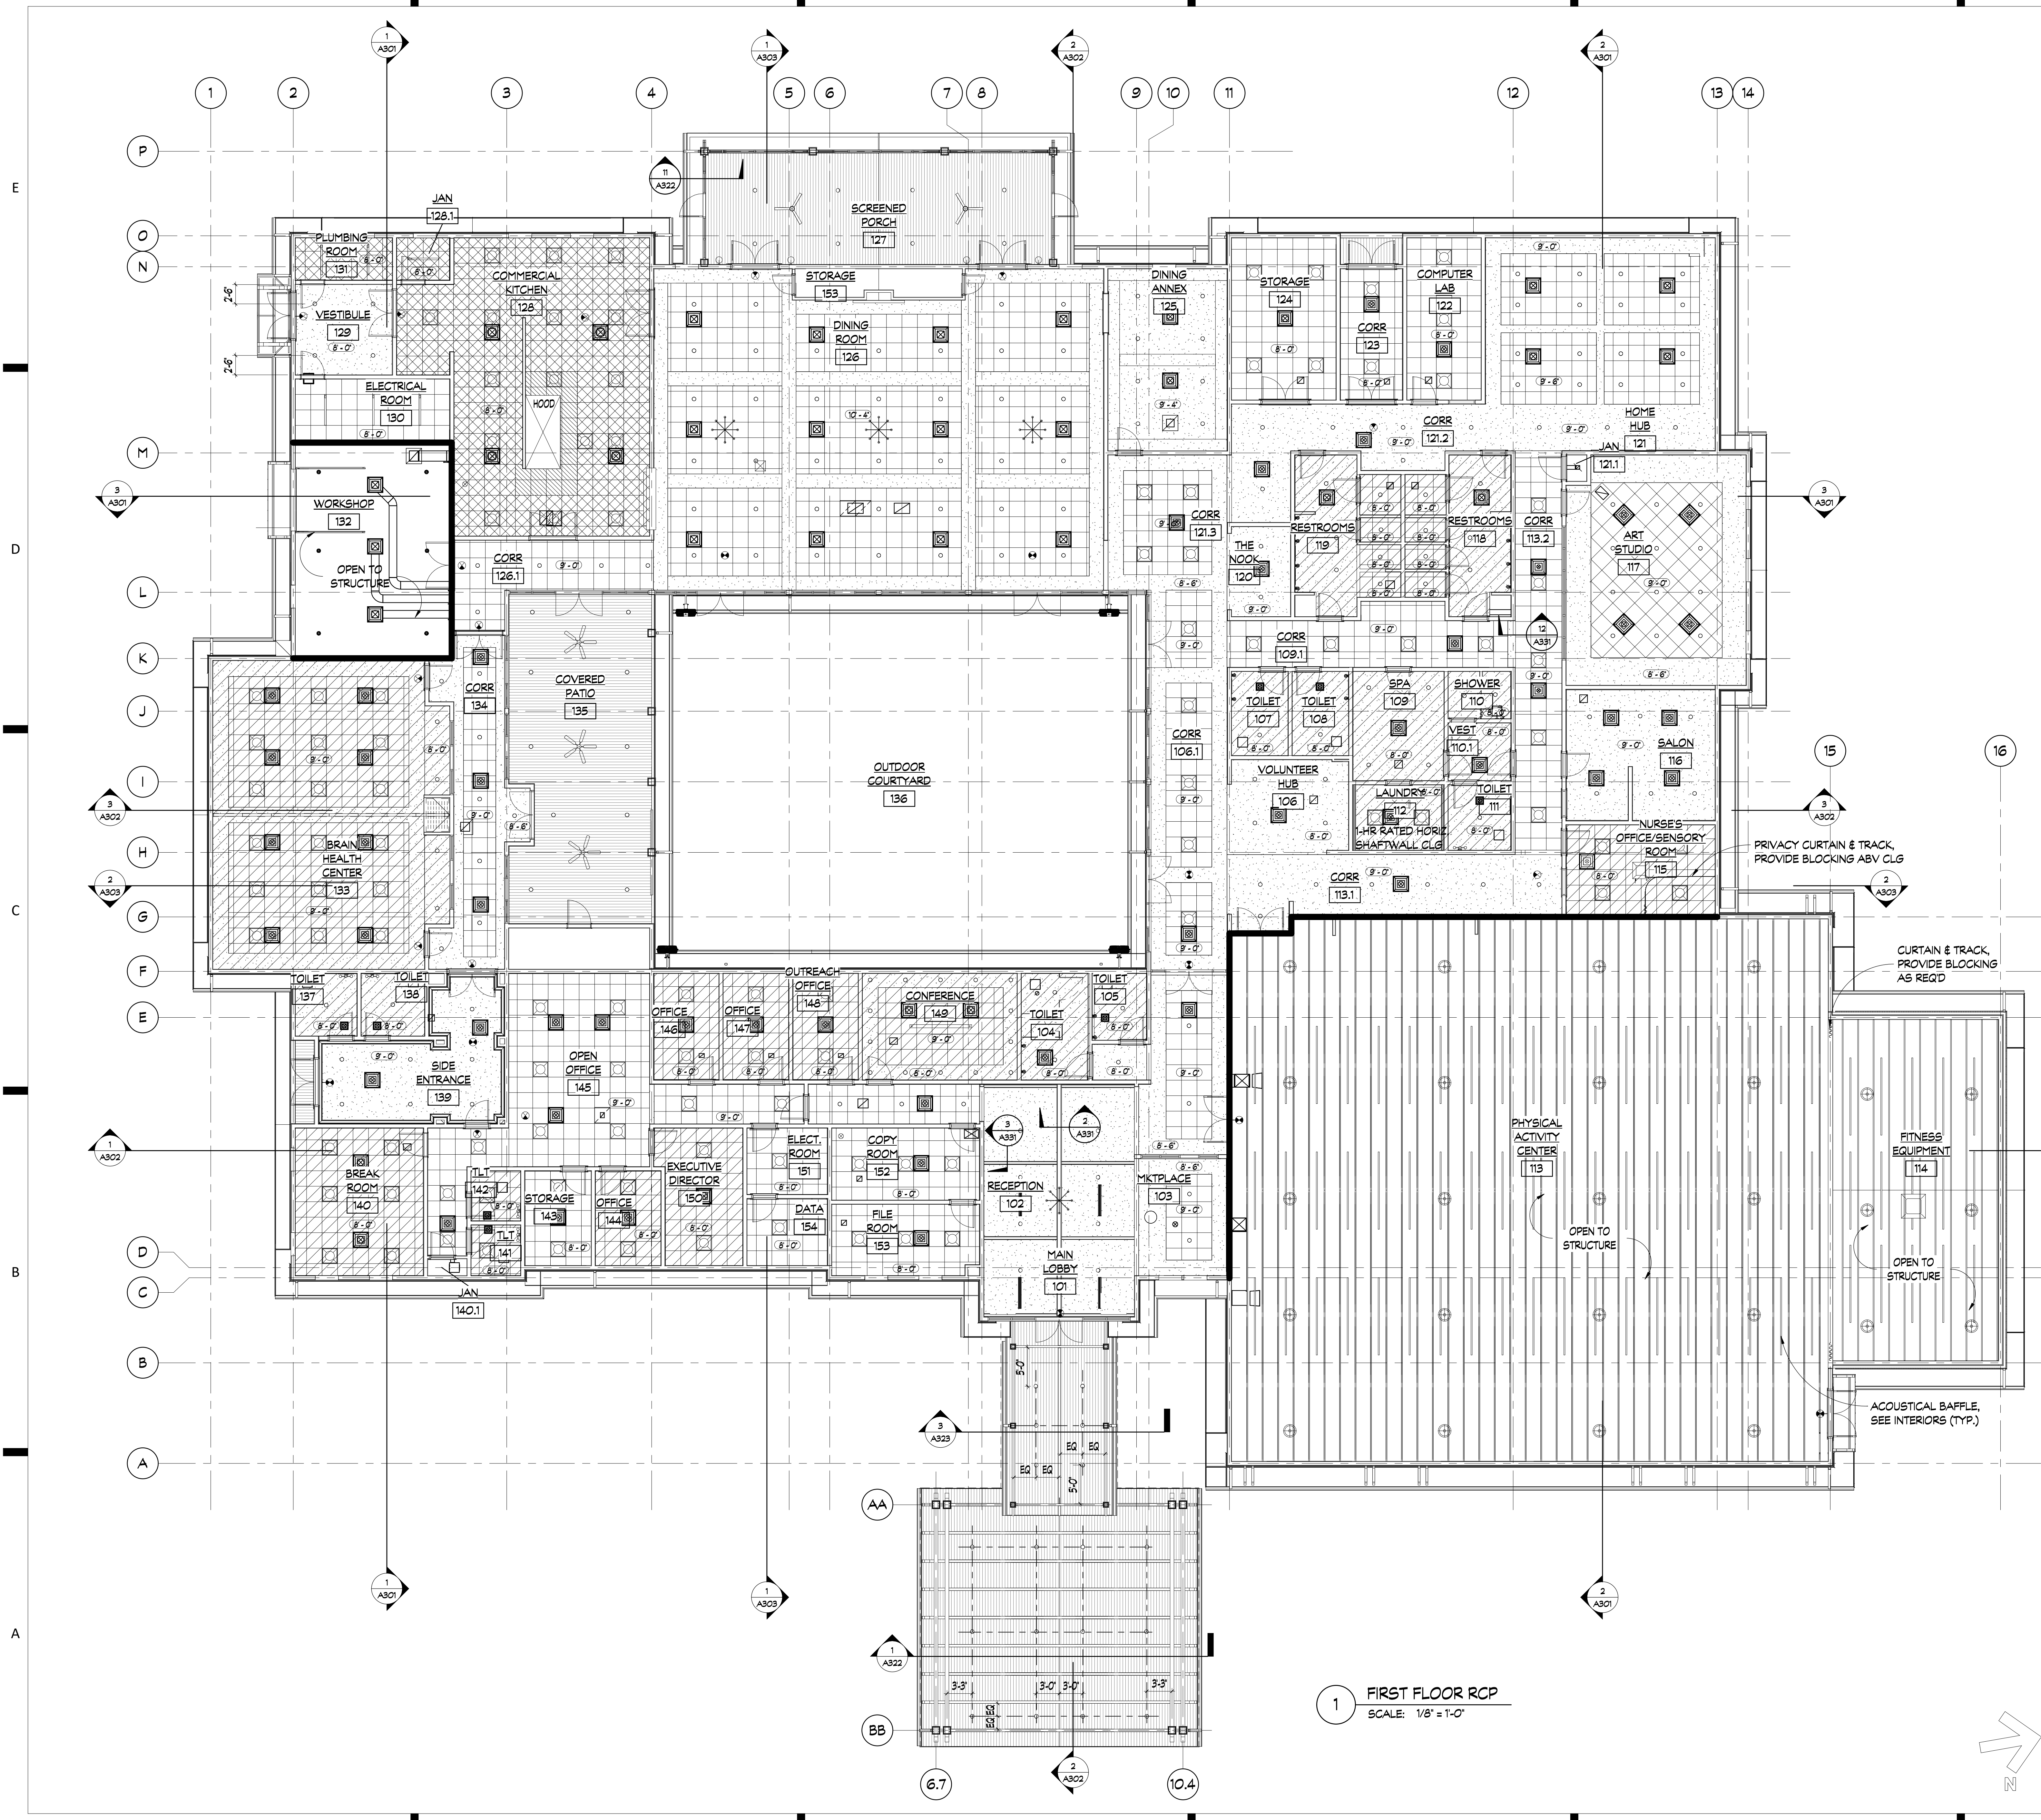
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METAL STUD WALL	
BRICK WALL	
WALL TYPES, SEE DWG A601	

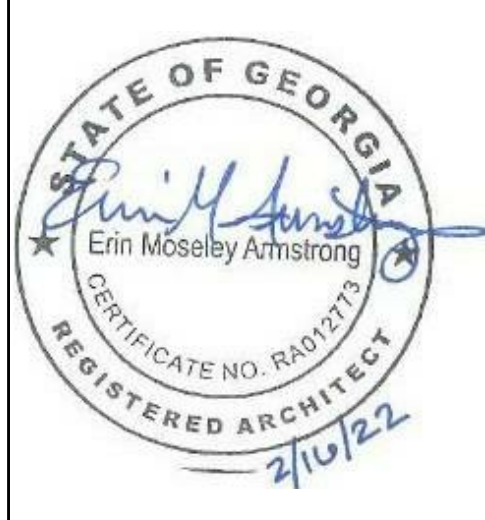




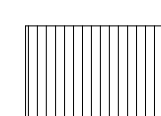
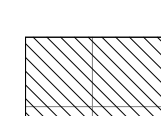

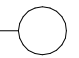
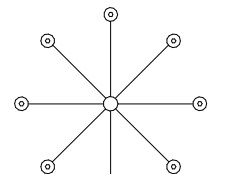







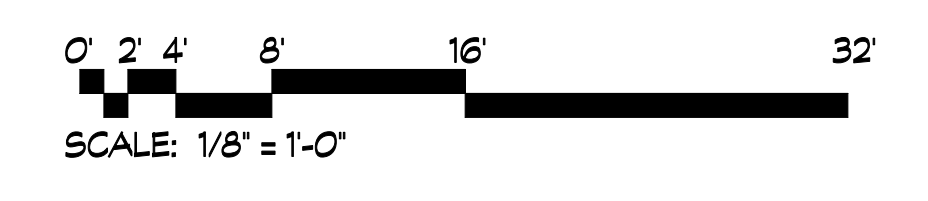



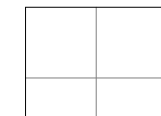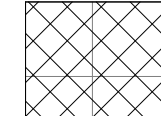

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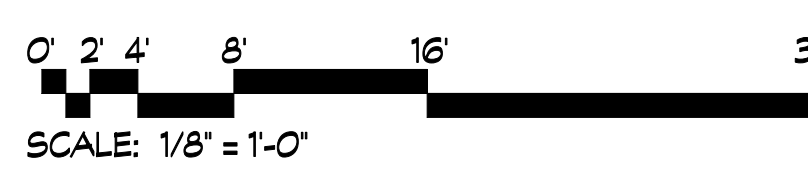


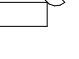

CEILING LEGEND


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-  SPECIALTY ACOUSTICAL CEILING PANEL
-  GYPSUM BOARD CEILING
-  T & G WOOD CEILING
-  STAINLESS STEEL CEILING PANEL
-  RECESSED FIXTURE
-  WALL SCONCE
-  DECORATIVE CHANDELIER
-  LINEAR FIXTURE
-  TRACK LIGHTING
-  GYM LIGHTING
-  EMERGENCY FIXTURE
-  EXIT LIGHT
-  MECHANICAL SUPPLY AIR DEVICE
-  MECHANICAL RETURN AIR DEVICE
-  EXHAUST
-  CEILING ACCESS PANEL
-  WALL TO DECK/STRUCTURE ABOVE
-  SOUND INSULATION ABOVE CEILING

1 FIRST FLOOR RCP
SCALE: 1/8" = 1'-0"




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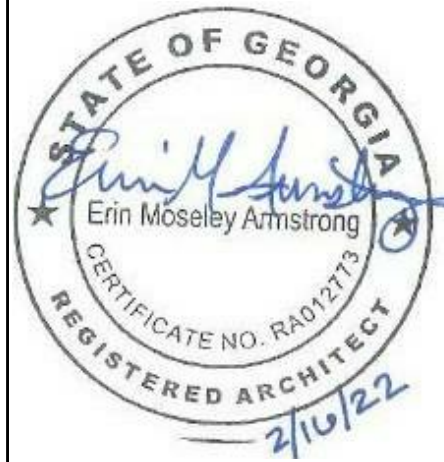
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Augusta, Georgia 30901
(706) 722-7488
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2	11/17/21	EA		65% SET
3	2/16/22	EA		ISSUE FOR PERMIT



DA PROJECT NUMBER & NAME:
1893

DRAWING TITLE:
**REFLECTED
CEILING
PLAN**

DRAWING NO:
A106

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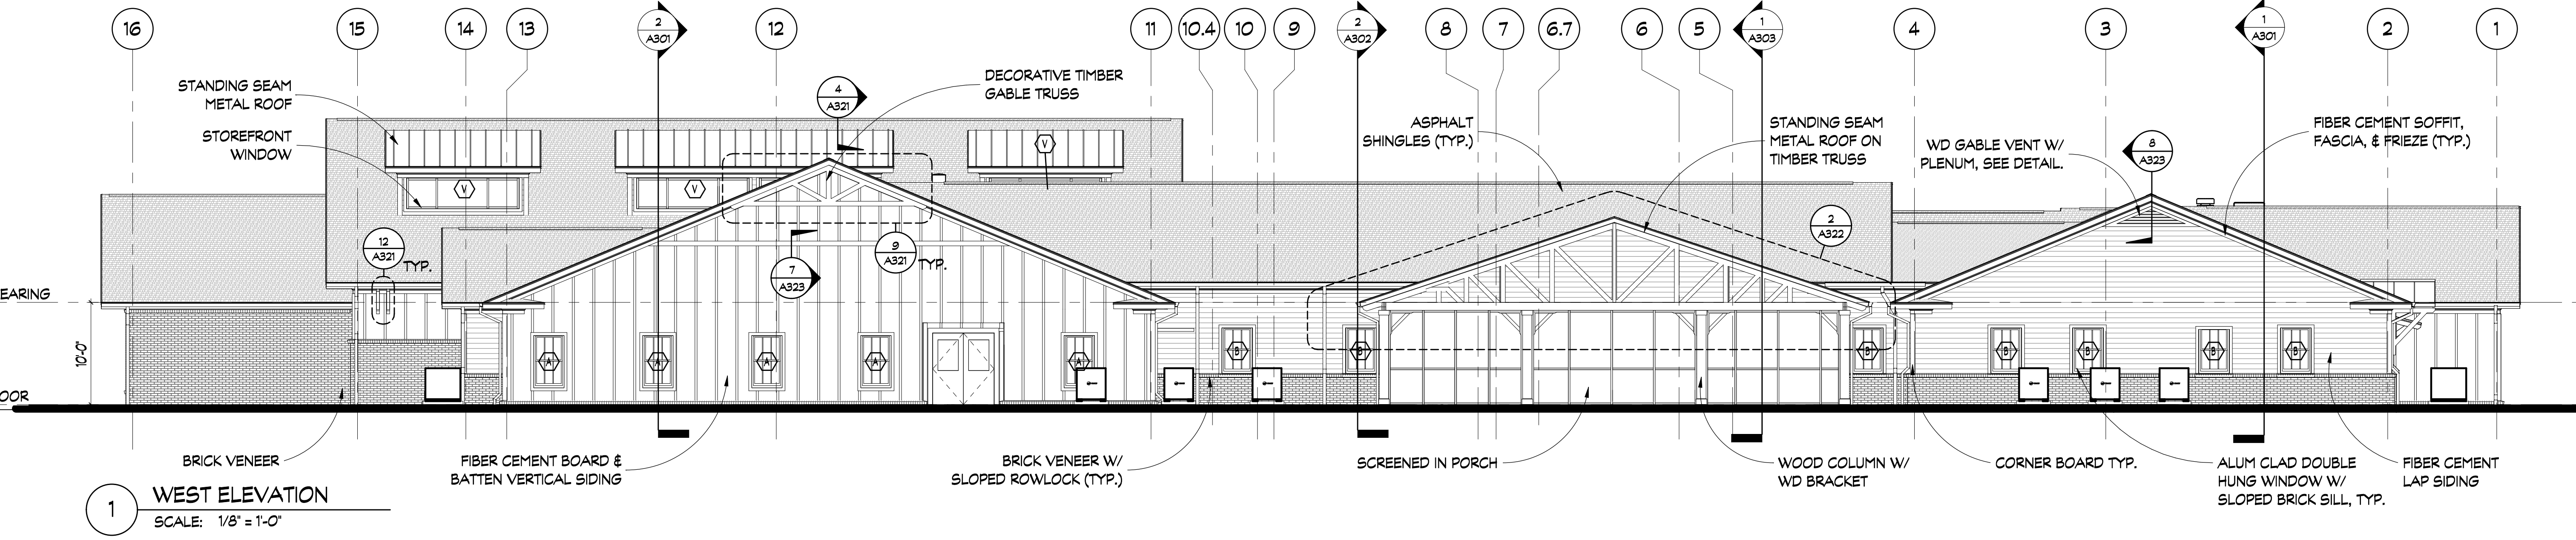


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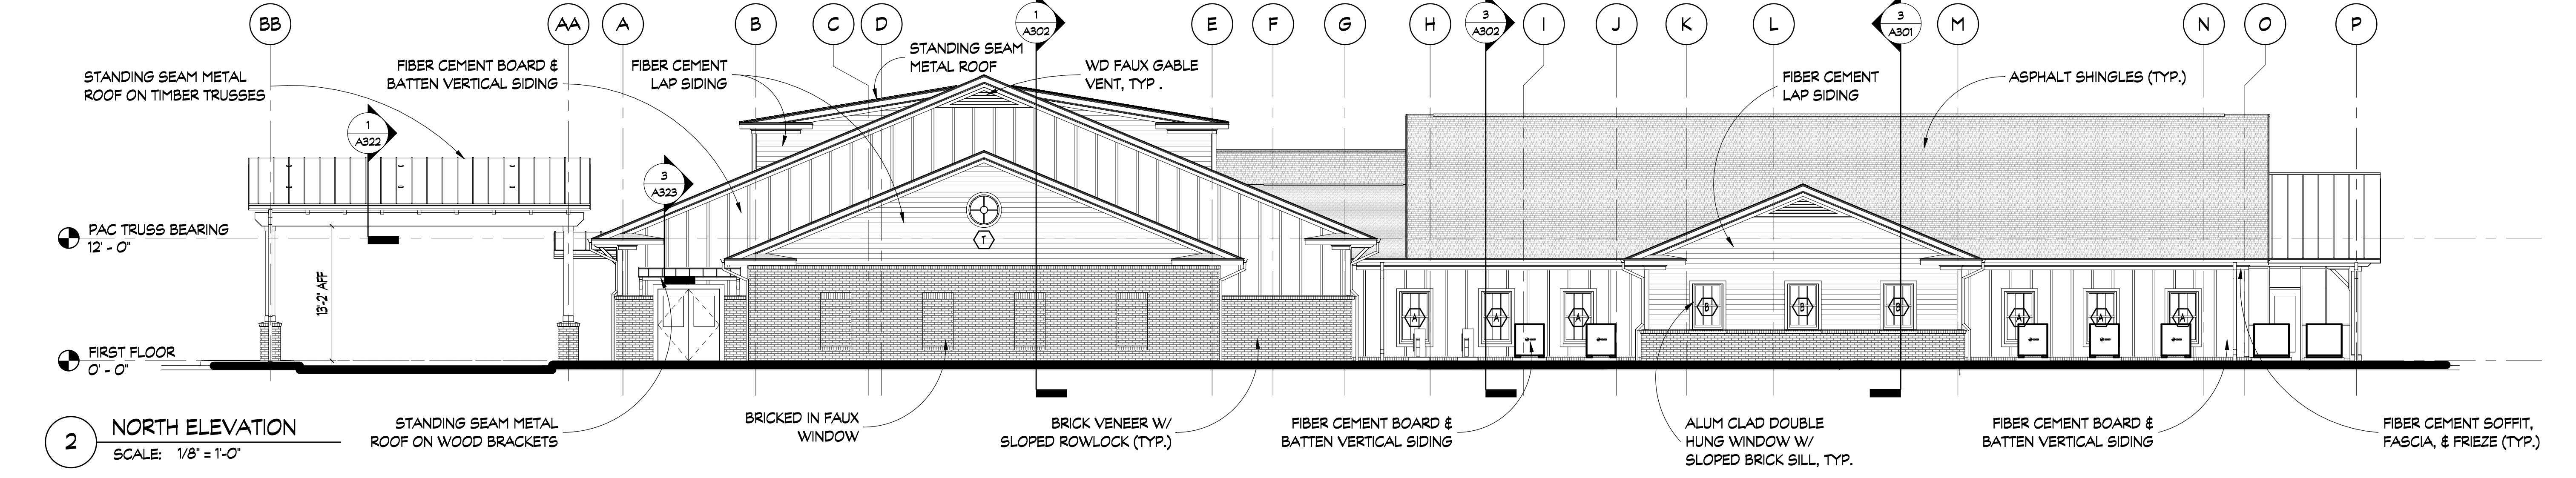
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**BUILDING
ELEVATIONS**

DRAWING NO:
A201


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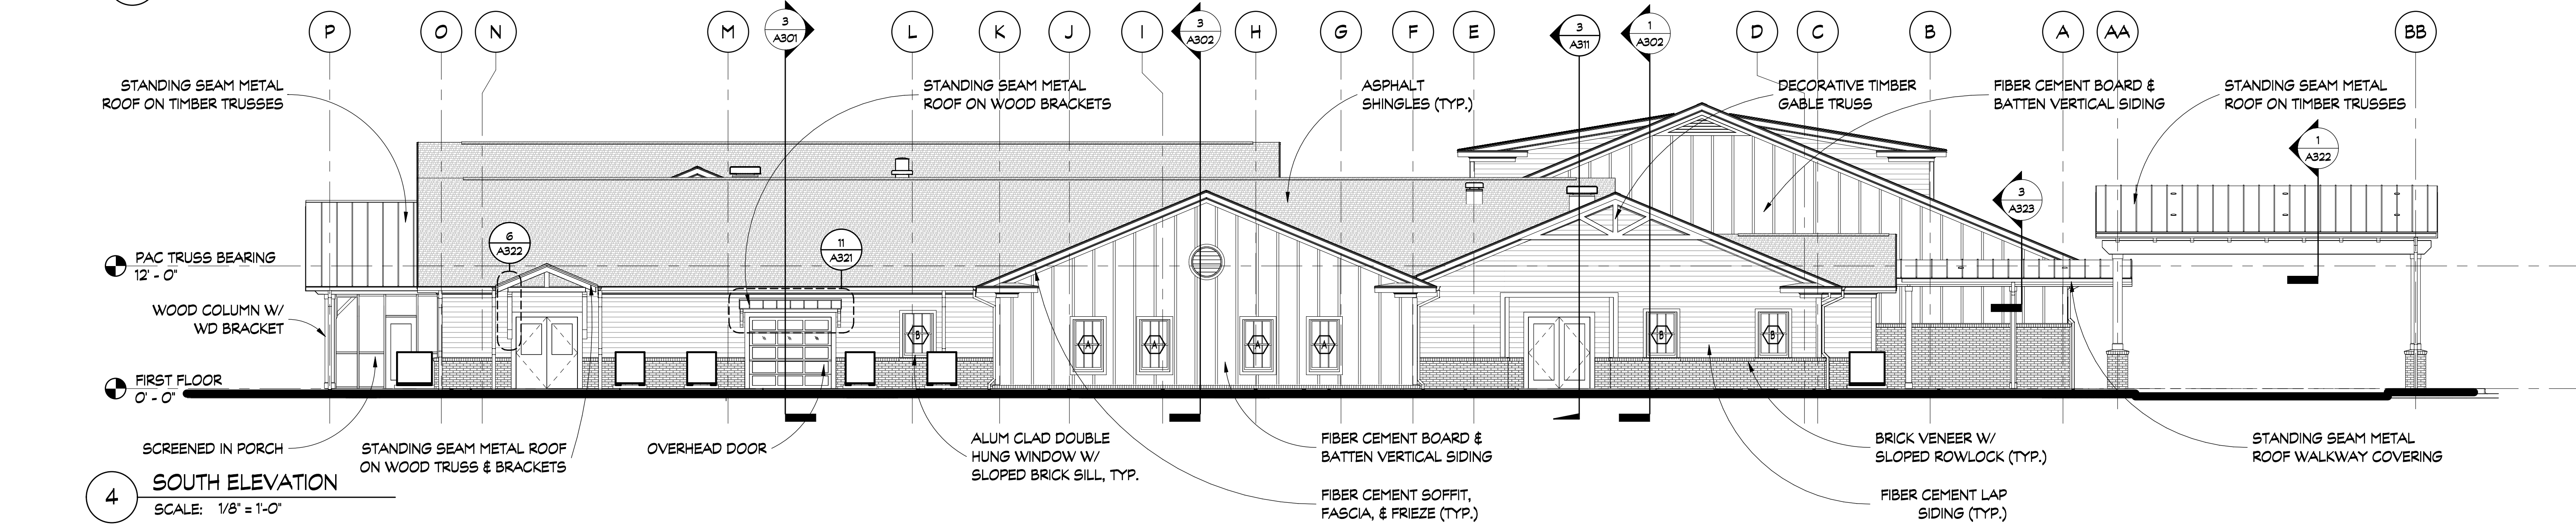
1 WEST ELEVATION
SCALE: 1/8" = 1'-0"




2 NORTH ELEVATION
SCALE: 1/8" = 1'-0"



3 EAST ELEVATION
SCALE: 1/8" = 1'-0"

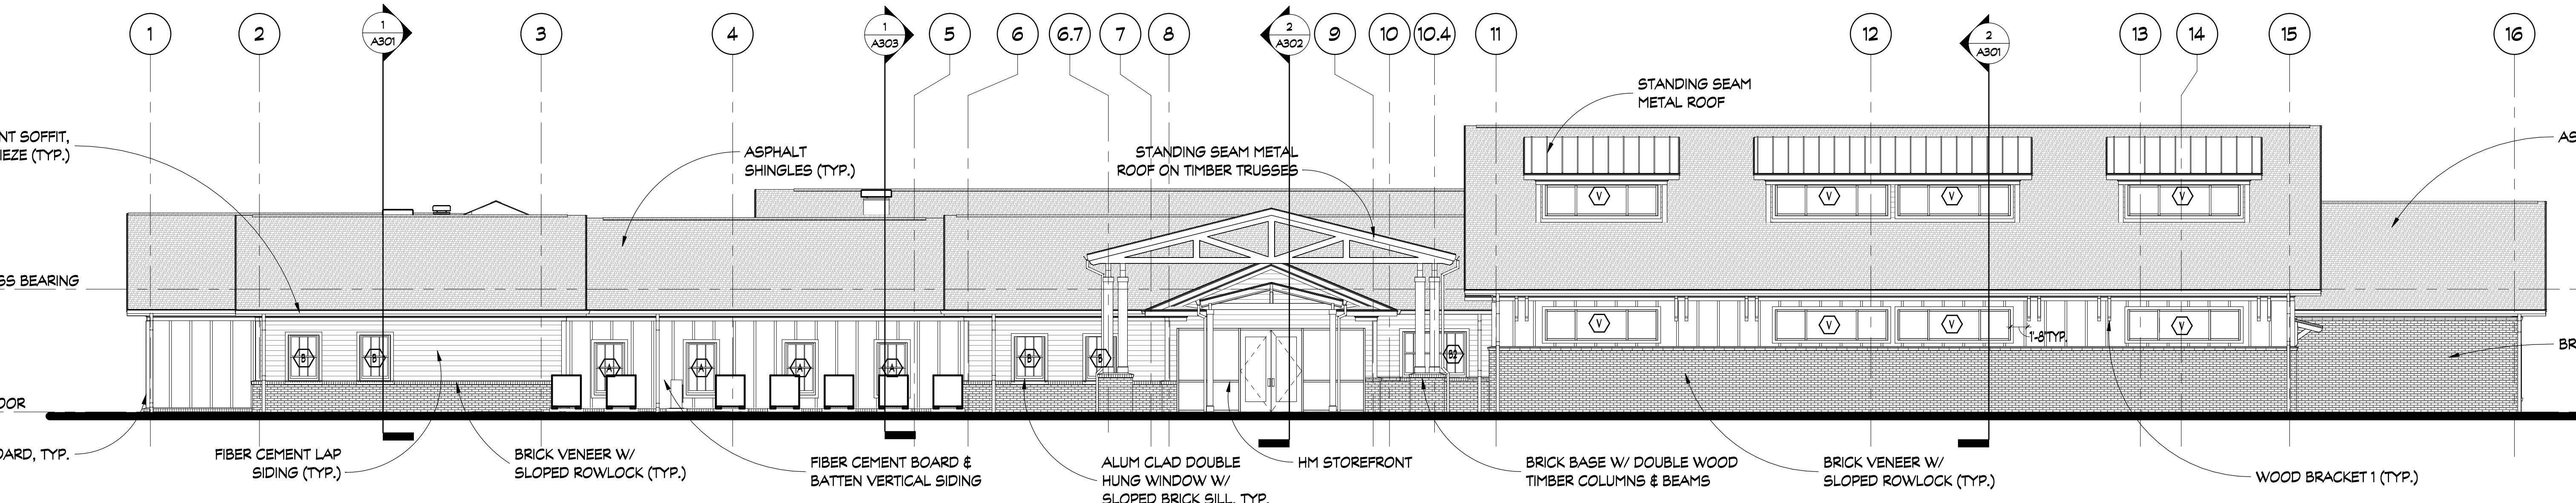


4 SOUTH ELEVATION
SCALE: 1/8" = 1'-0"

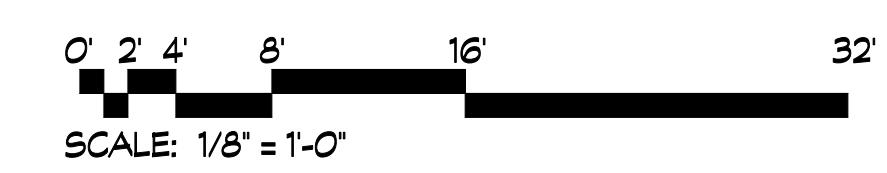

1 2 3 4 5 6


REVISIONS			
REV #	DATE	APPROV BY	REVISION
1	11/17/21	EA	65% SET
2	2/16/22	EA	ISSUE FOR PERMIT

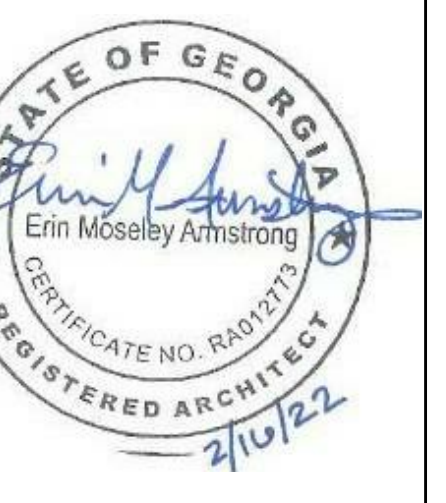


DA PROJECT NUMBER & NAME:
1893

DRAWING TITLE:
**BUILDING
SECTIONS**


DRAWING NO:
A301

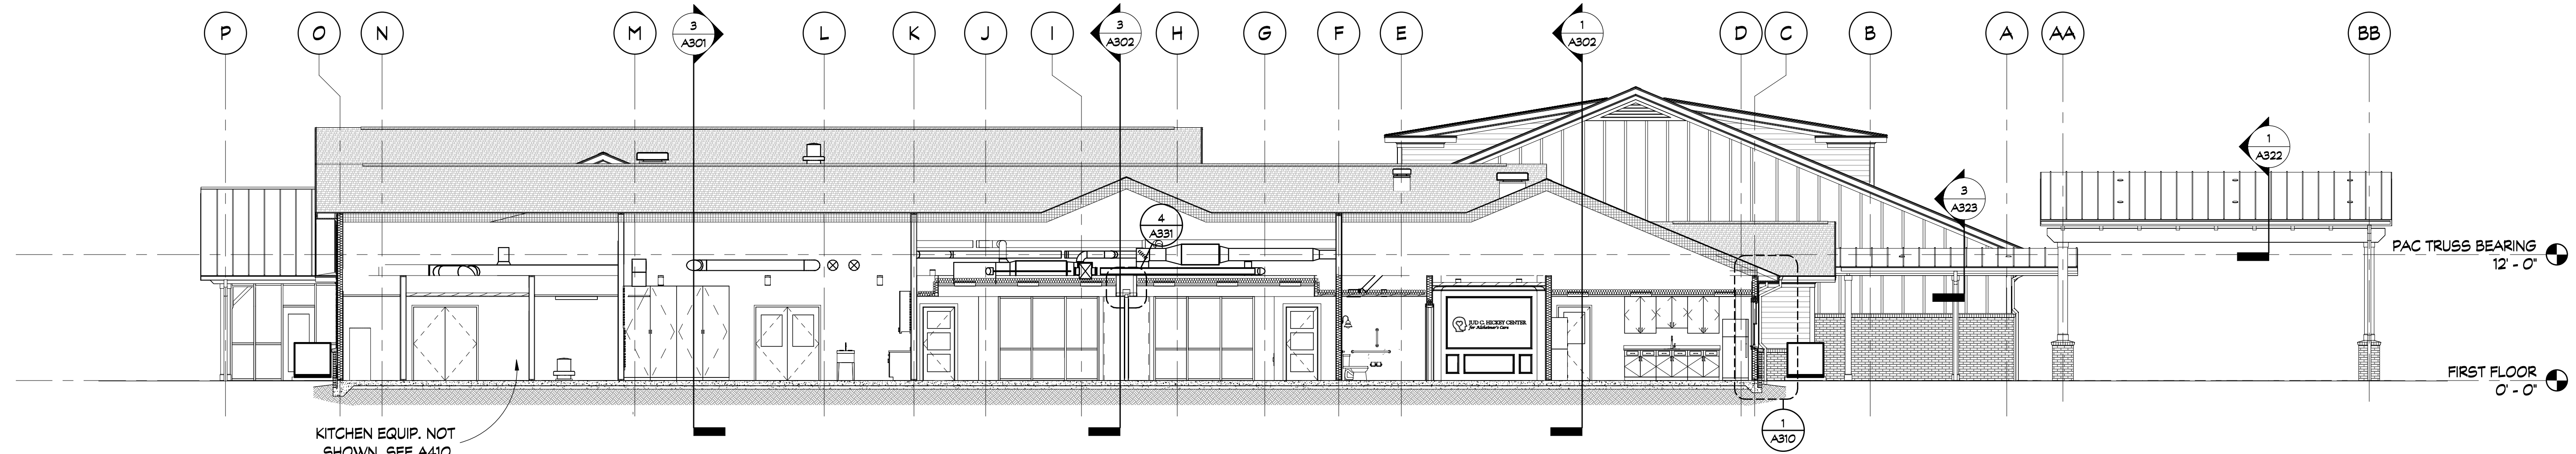

1 BUILDING SECTION
SCALE: 1/8" = 1'-0"

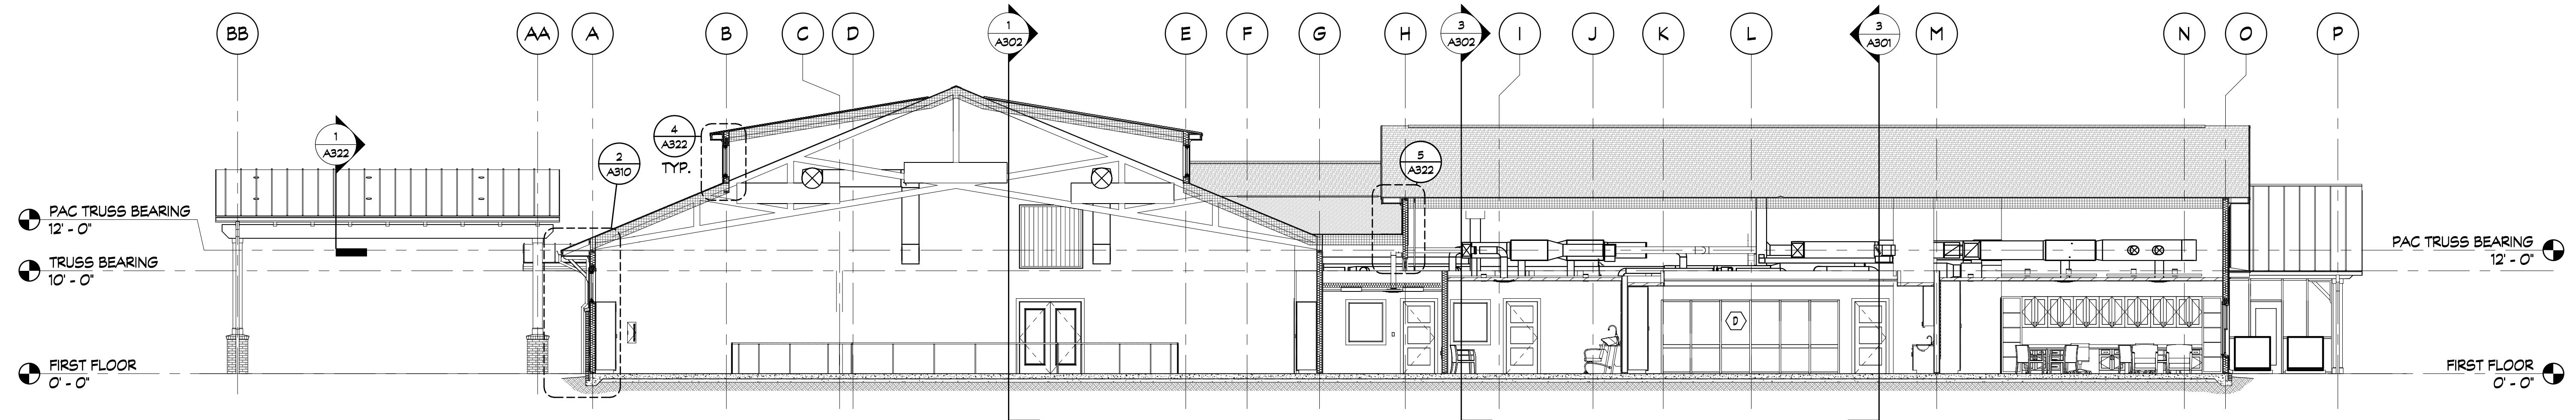


2 BUILDING SECTION
SCALE: 1/8" = 1'-0"

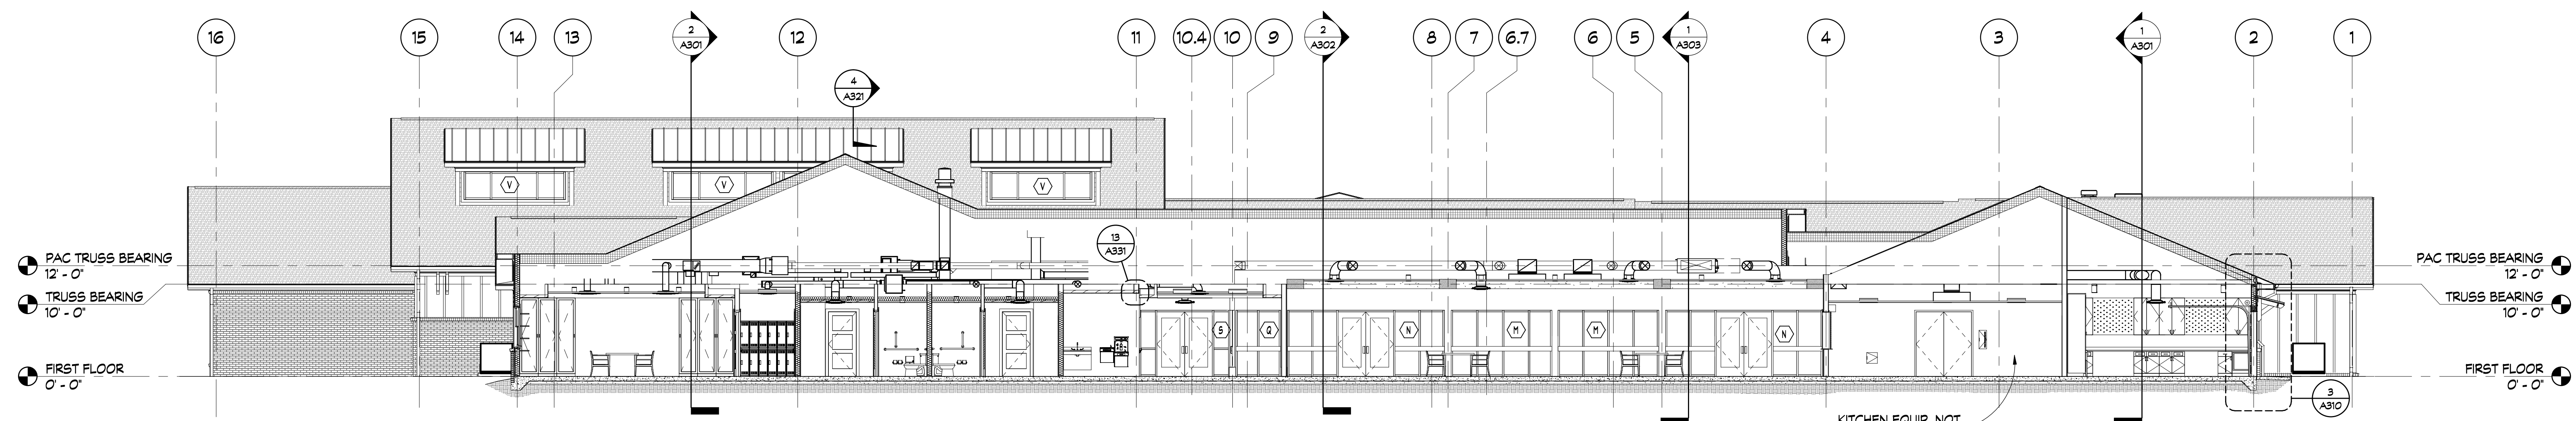

3 BUILDING SECTION
SCALE: 1/8" = 1'-0"

GENERAL NOTES:

- SEE STRUCTURAL FOR PRE-ENGINEERED ROOF TRUSSES. MAJORITY OF ROOF FRAMING NOT SHOWN ON ARCHITECTURAL, BUT IS REQUIRED.
- GC TO COORD. ALL ABOVE-CEILING M/E/P/FP EQUIPMENT W/ ROOF TRUSS DESIGN.

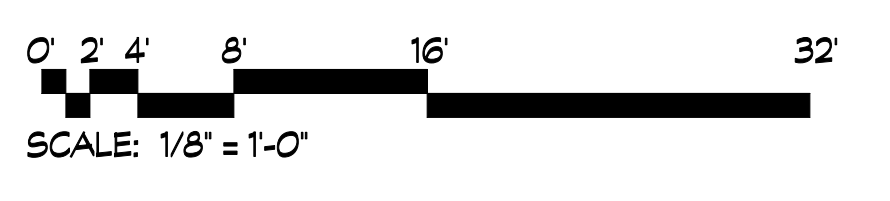


REVISIONS			
REV #	DATE	APPROV	REVISION
1	11/17/21	EA	65% SET
2	2/16/22	EA	ISSUE FOR PERMIT




DA PROJECT NUMBER & NAME:
1893

DRAWING TITLE:
**BUILDING
SECTIONS**


DRAWING NO:
A302

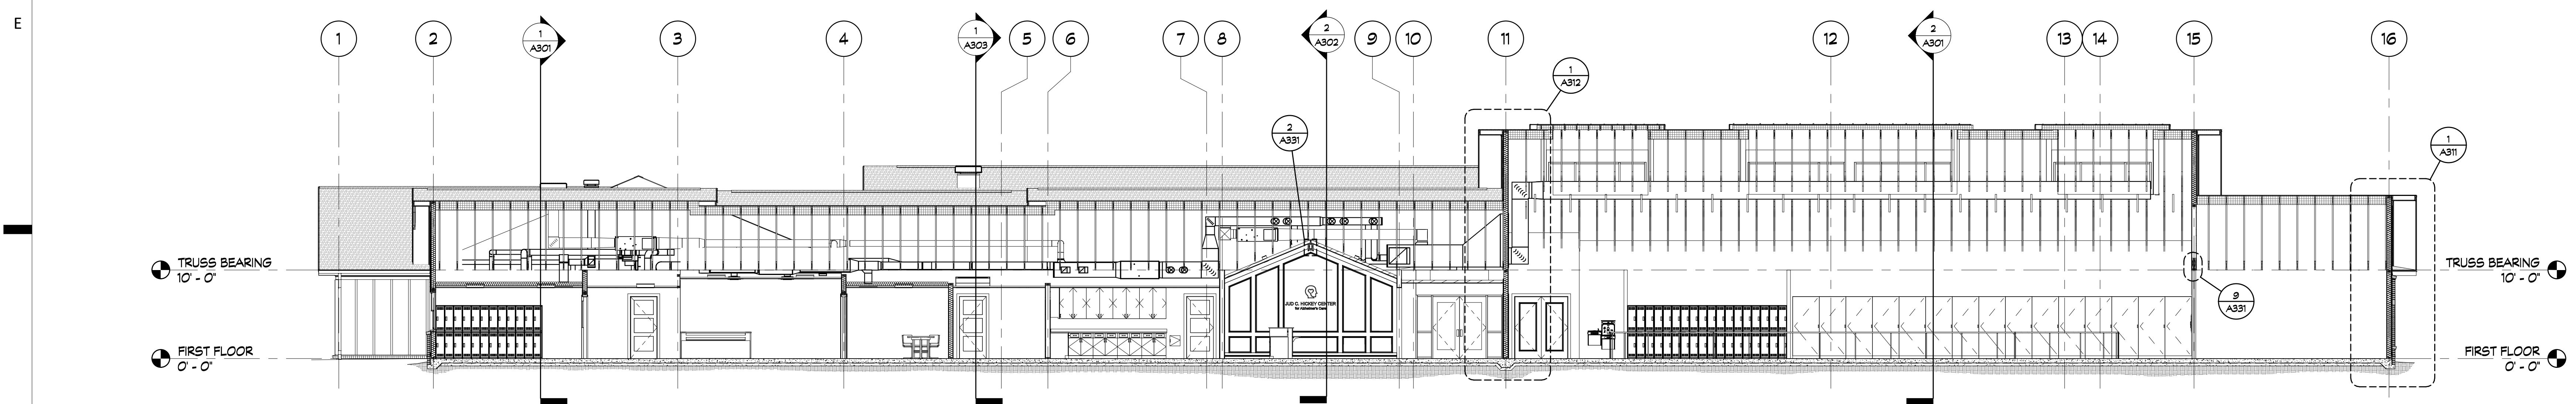

1 BUILDING SECTION
SCALE: 1/8" = 1'-0"

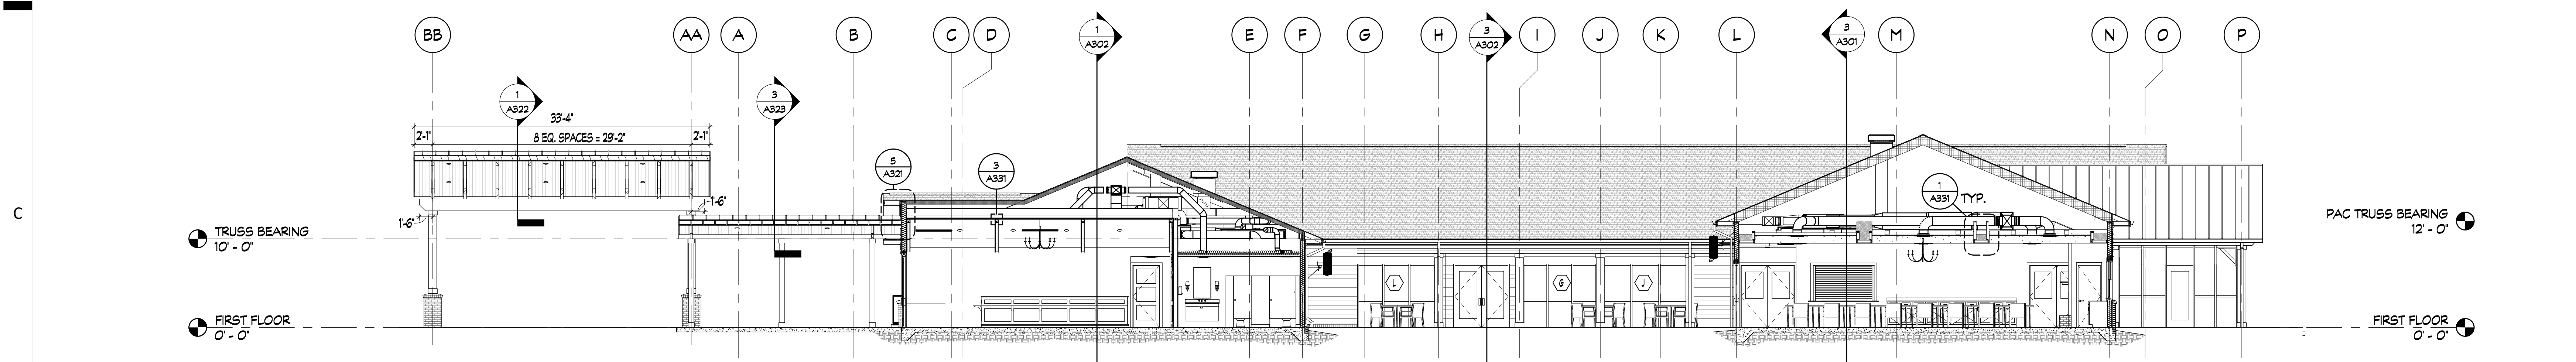


2 BUILDING SECTION
SCALE: 1/8" = 1'-0"

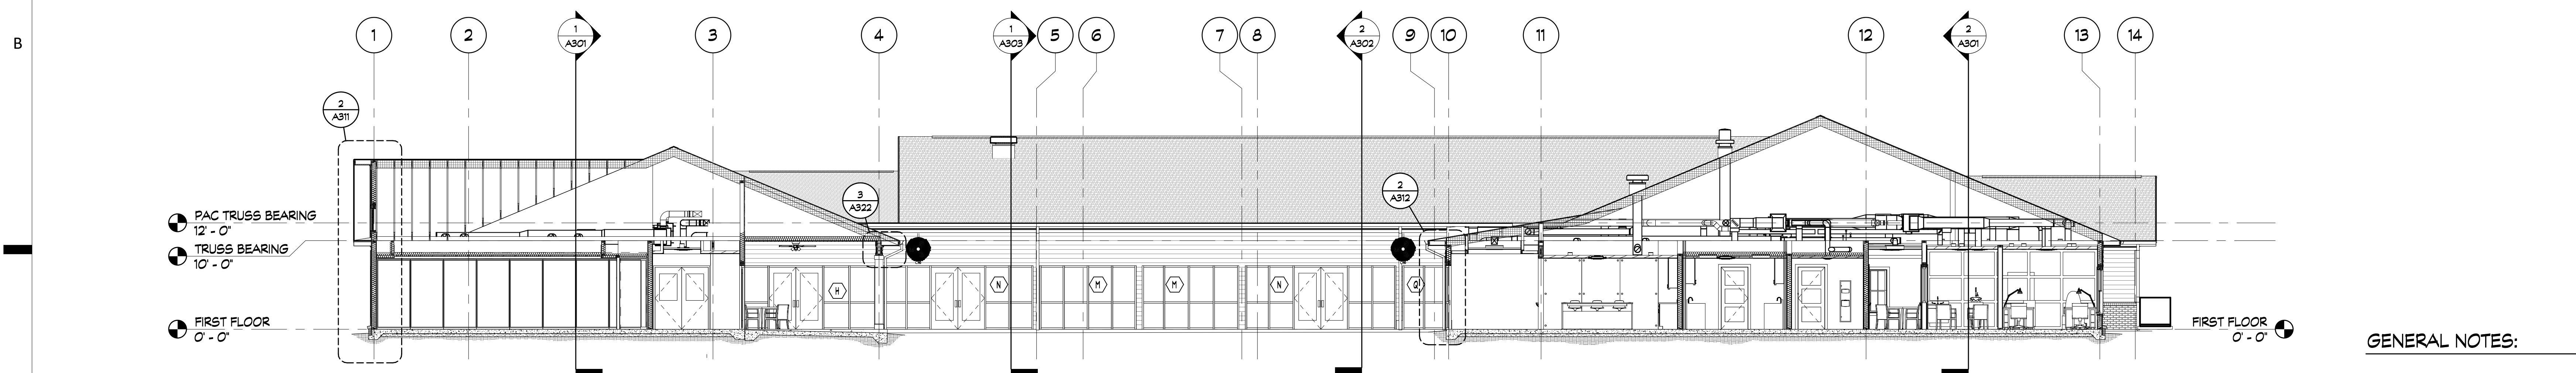


3 BUILDING SECTION
SCALE: 1/8" = 1'-0"

GENERAL NOTES:


- SEE STRUCTURAL FOR PRE-ENGINEERED ROOF TRUSSES. MAJORITY OF ROOF FRAMING NOT SHOWN ON ARCHITECTURAL, BUT IS REQUIRED.
- GC TO COORD. ALL ABOVE-CEILING M/E/P/FP EQUIPMENT W/ ROOF TRUSS DESIGN.

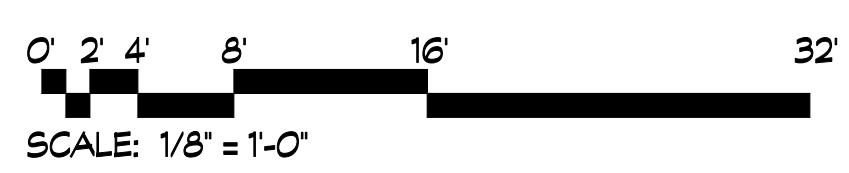

REVISIONS			
REV #	DATE	APRVD BY	REVISION
	11/17/21	EA	65% SET
	2/16/22	EA	ISSUE FOR PERMIT

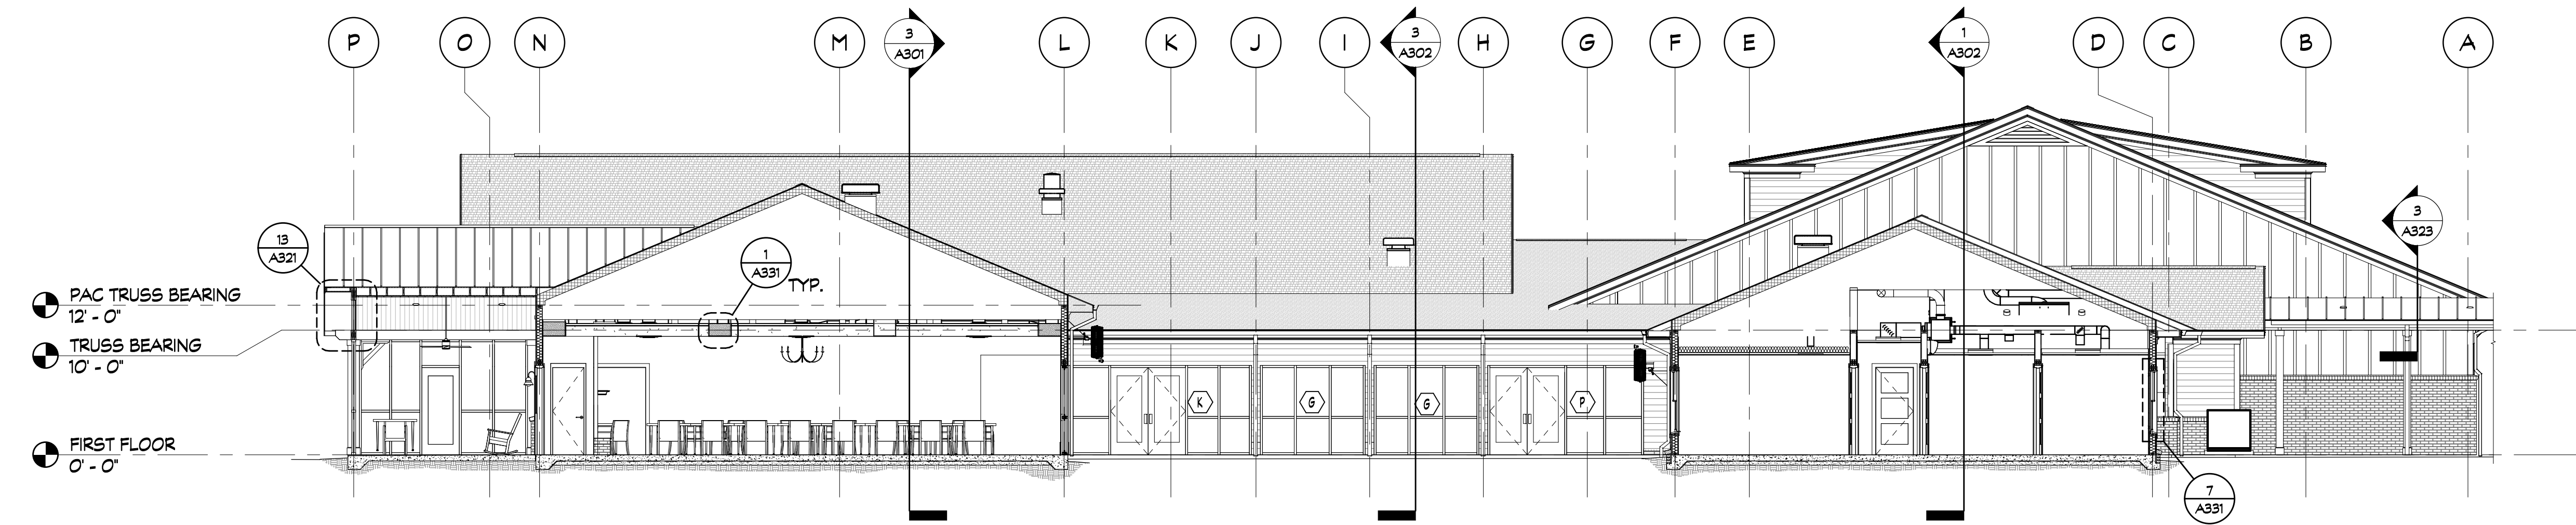


1
A102 BUILDING SECTION
SCALE: 1/8" = 1'-0"

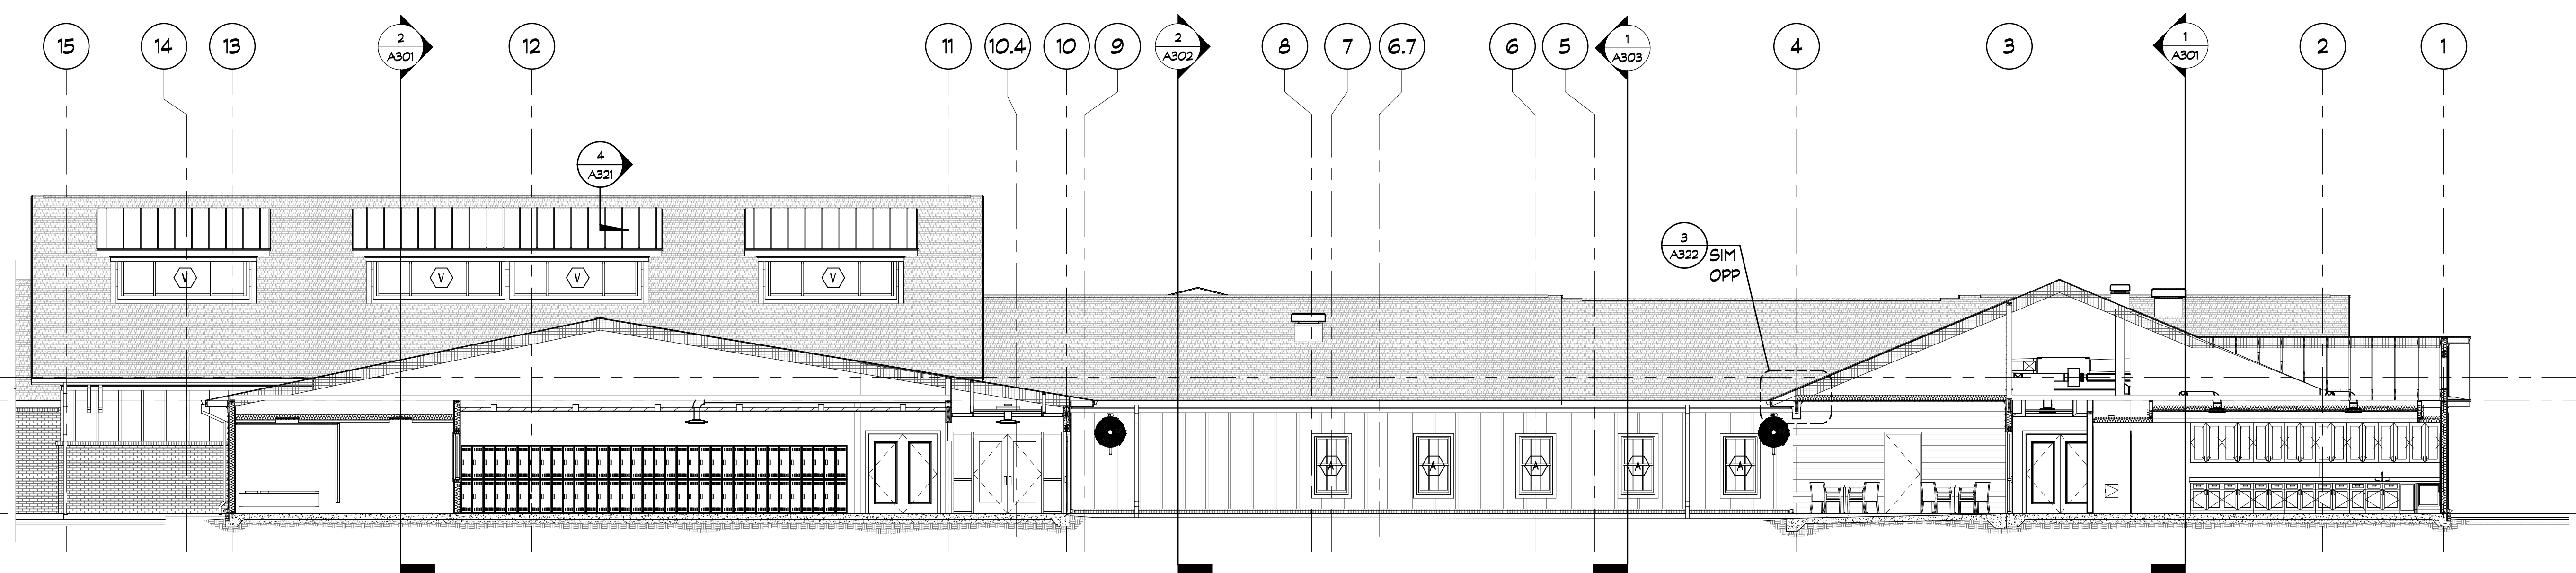

2
A102 BUILDING SECTION
SCALE: 1/8" = 1'-0"

GENERAL NOTES:

- SEE STRUCTURAL FOR PRE-ENGINEERED ROOF TRUSSES. MAJORITY OF ROOF FRAMING NOT SHOWN ON ARCHITECTURAL, BUT IS REQUIRED.
- GC TO COORD. ALL ABOVE-CEILING M/E/P/FP EQUIPMENT W/ ROOF TRUSS DESIGN.

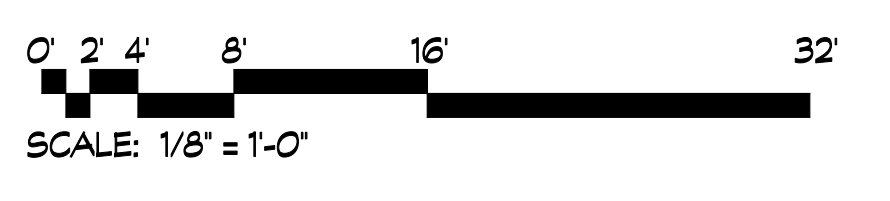

GENERAL NOTES:


- SEE STRUCTURAL FOR PRE-ENGINEERED ROOF TRUSSES. MAJORITY OF ROOF FRAMING NOT SHOWN ON ARCHITECTURAL, BUT IS REQUIRED.
- GC TO COORD. ALL ABOVE-CEILING M/E/P/FP EQUIPMENT W/ ROOF TRUSS DESIGN.

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mail@dickinsonarchitects.com
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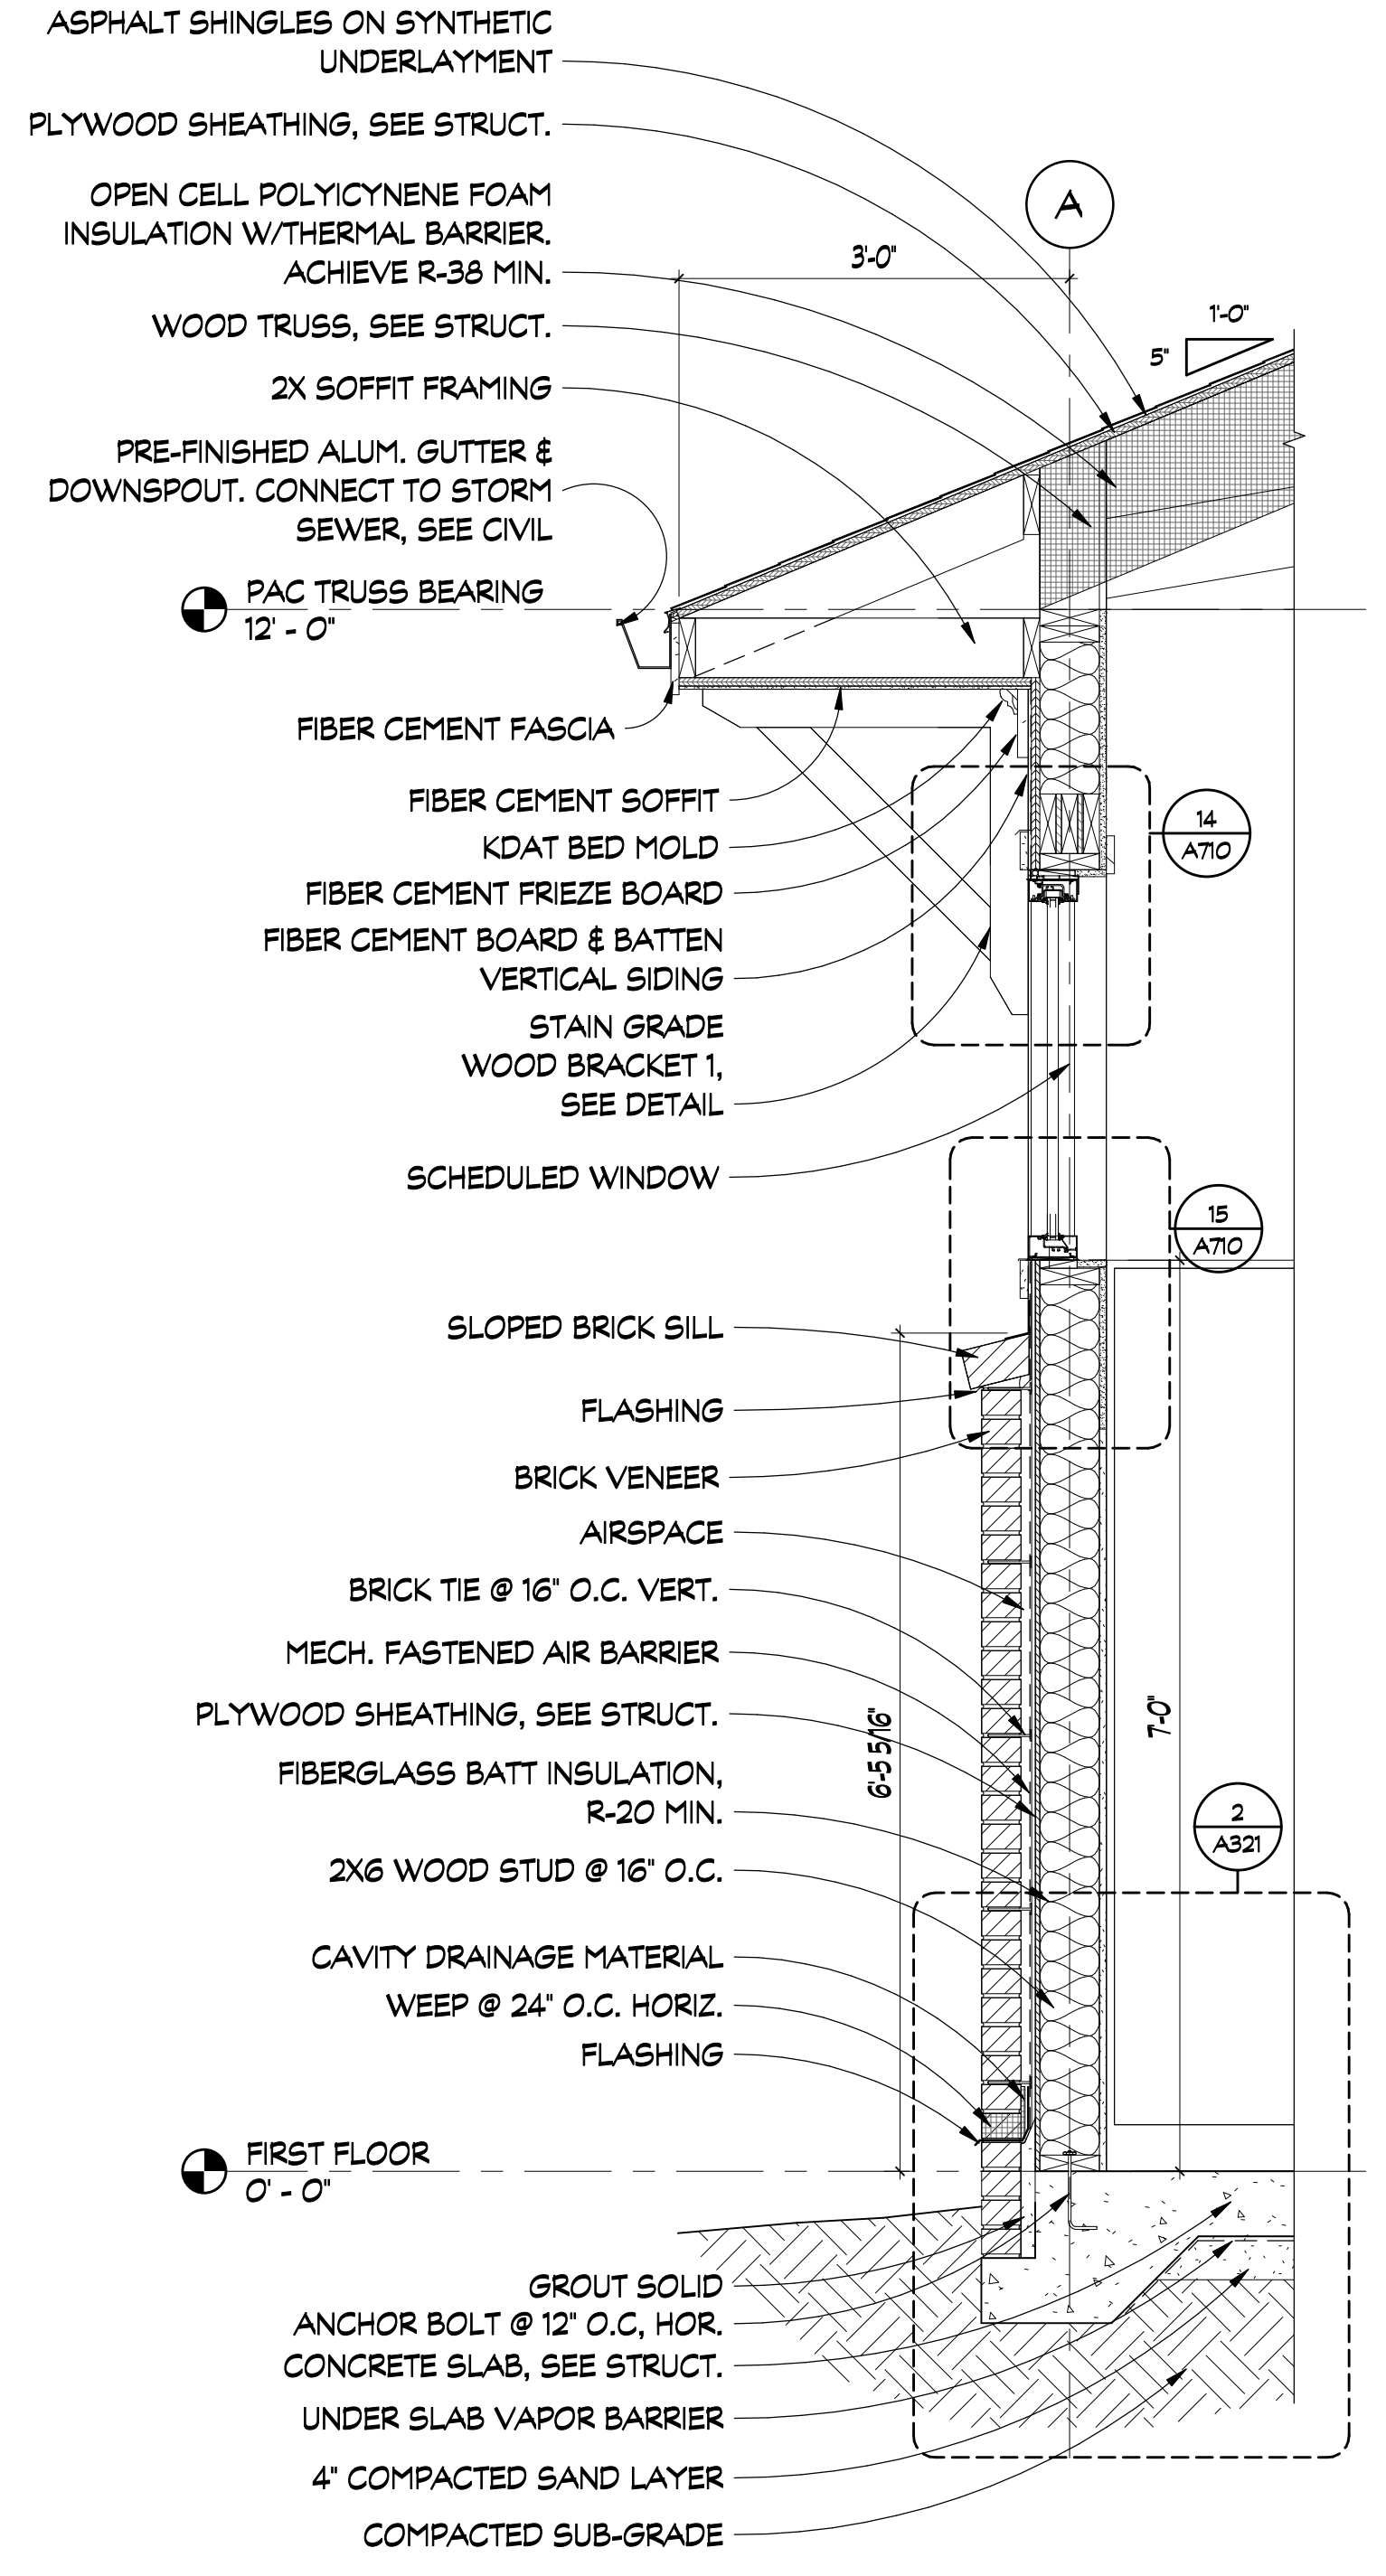
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Architects

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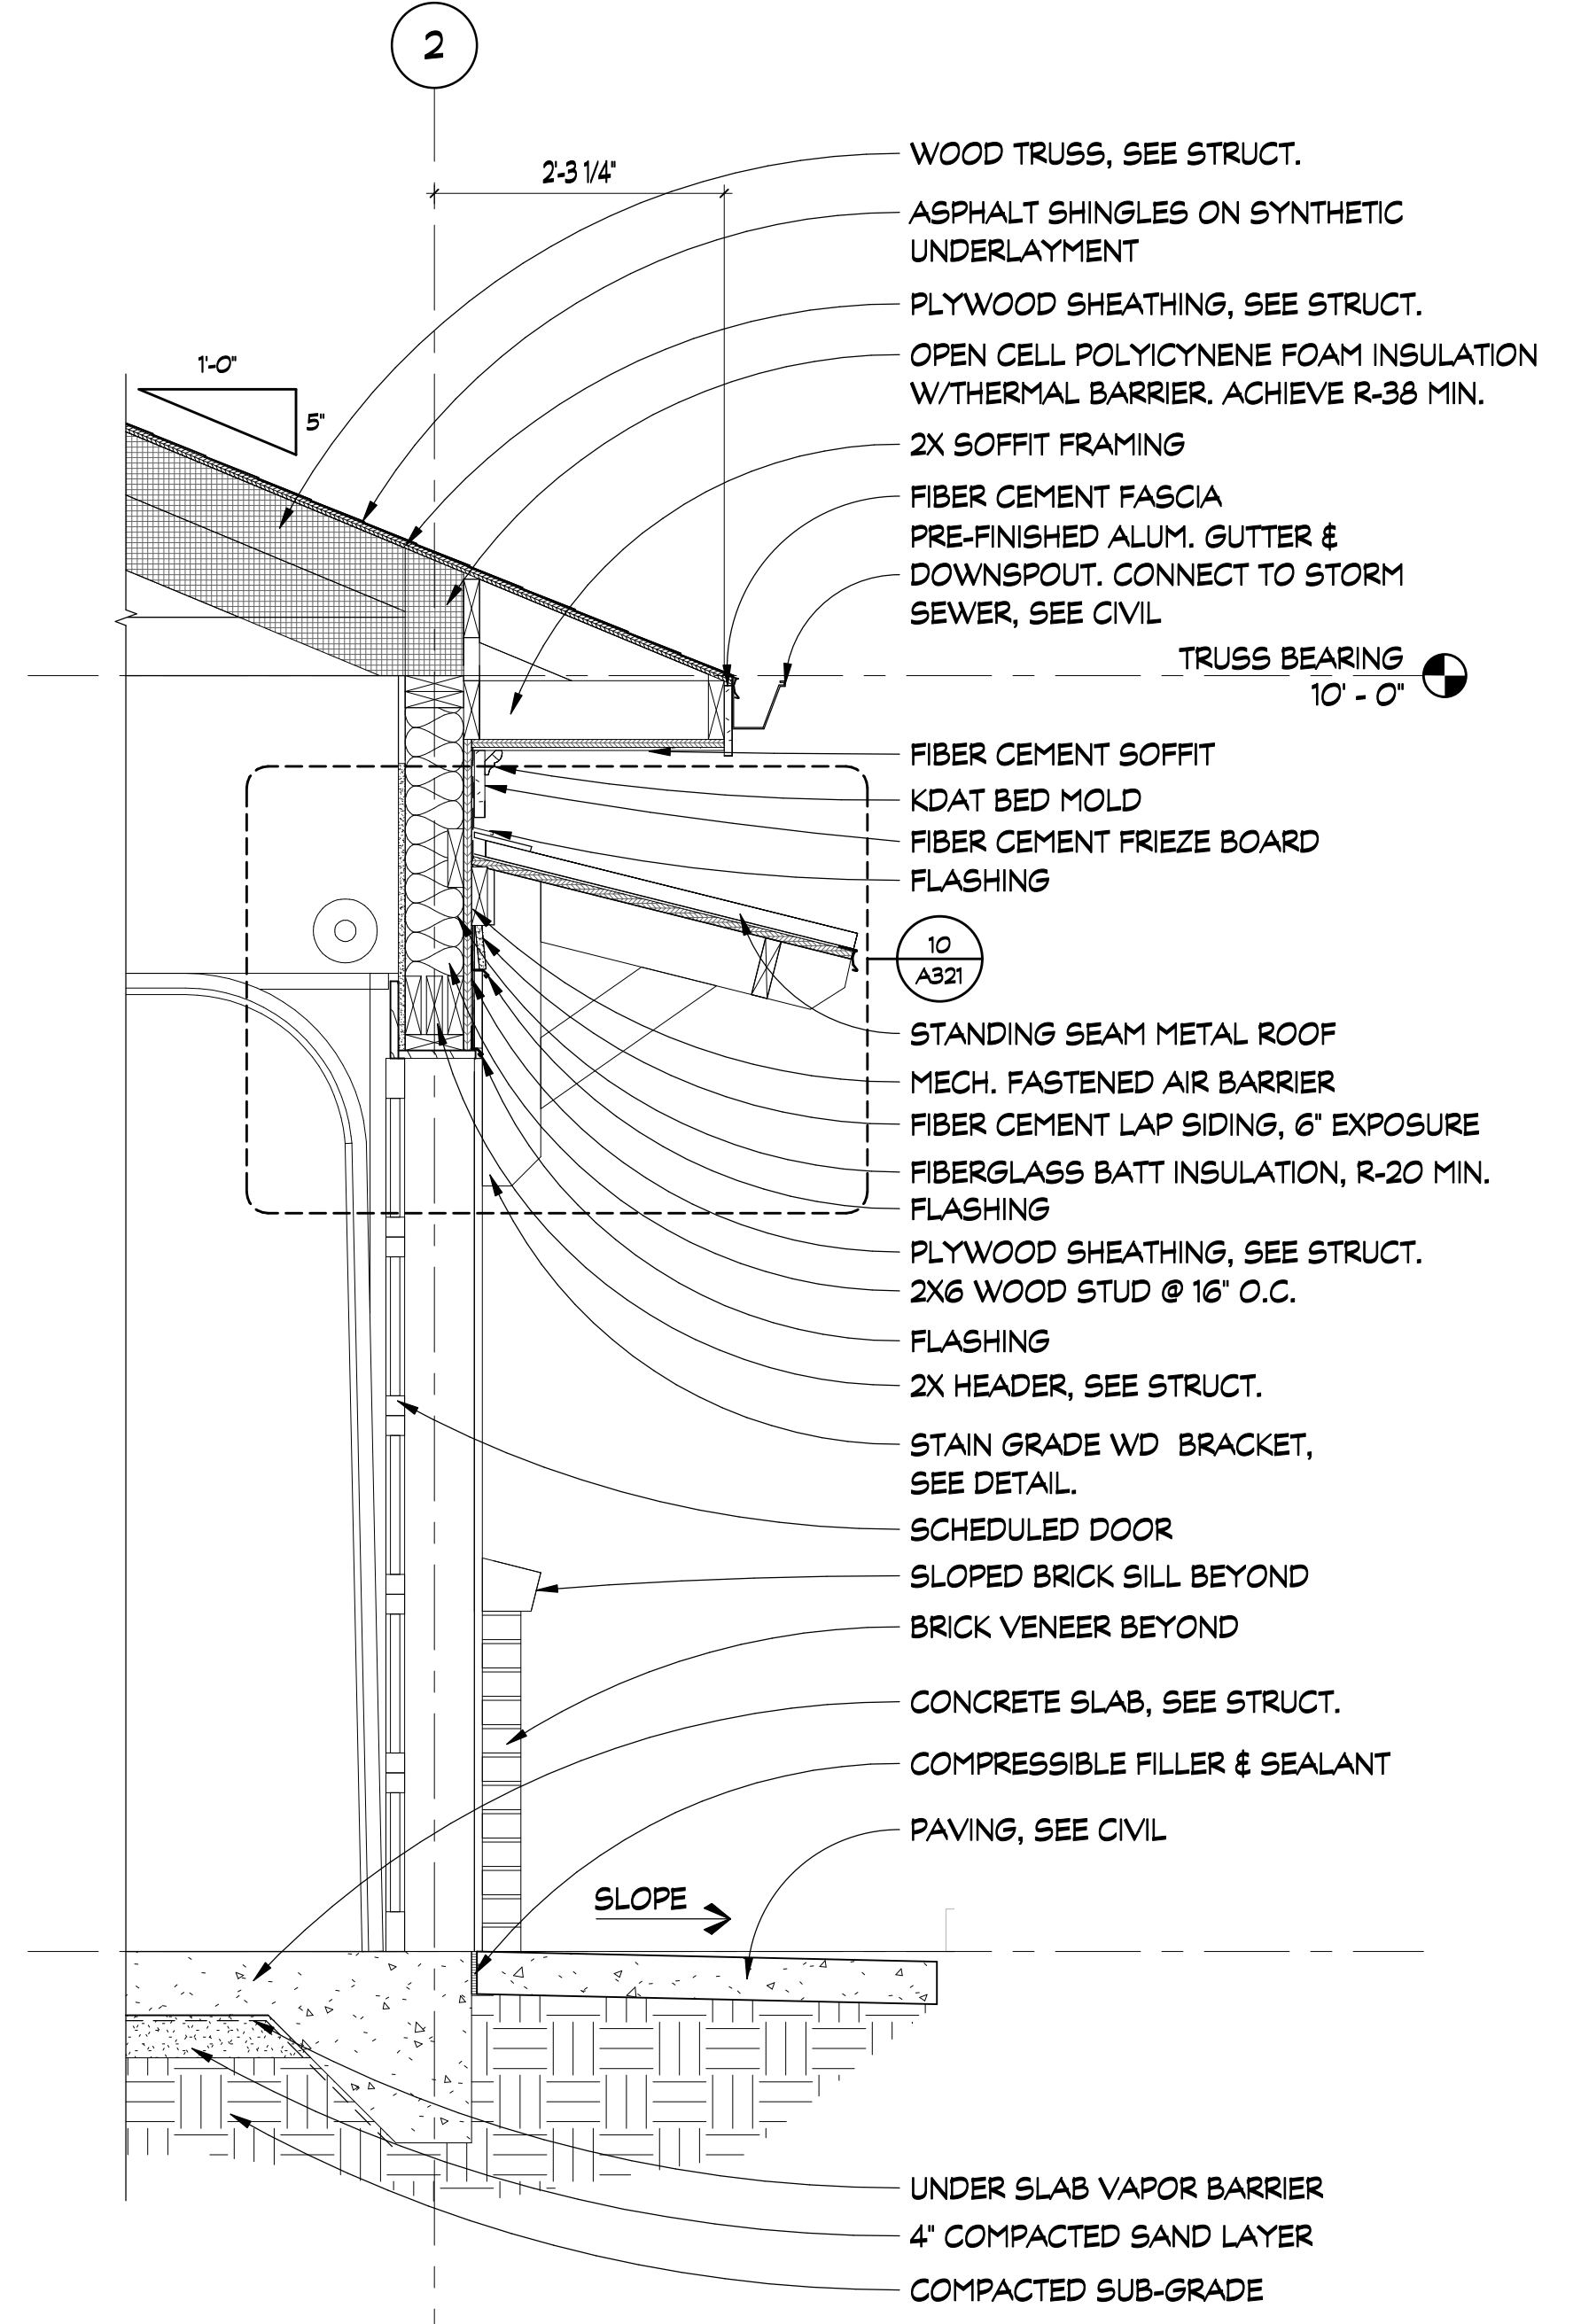
REVISIONS			
REV #	DATE	APPROVED BY	REVISION
1	11/17/21	EA	65% SET
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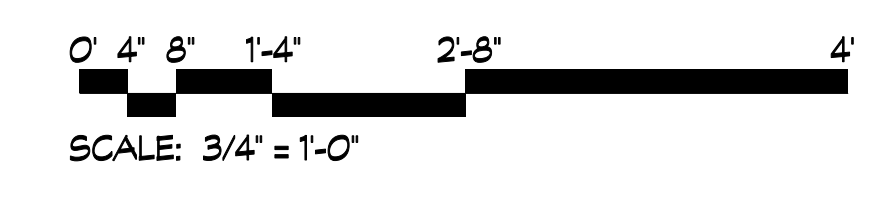
1 WALL SECTION
SCALE: 3/4" = 1'-0"



2 WALL SECTION
SCALE: 3/4" = 1'-0"

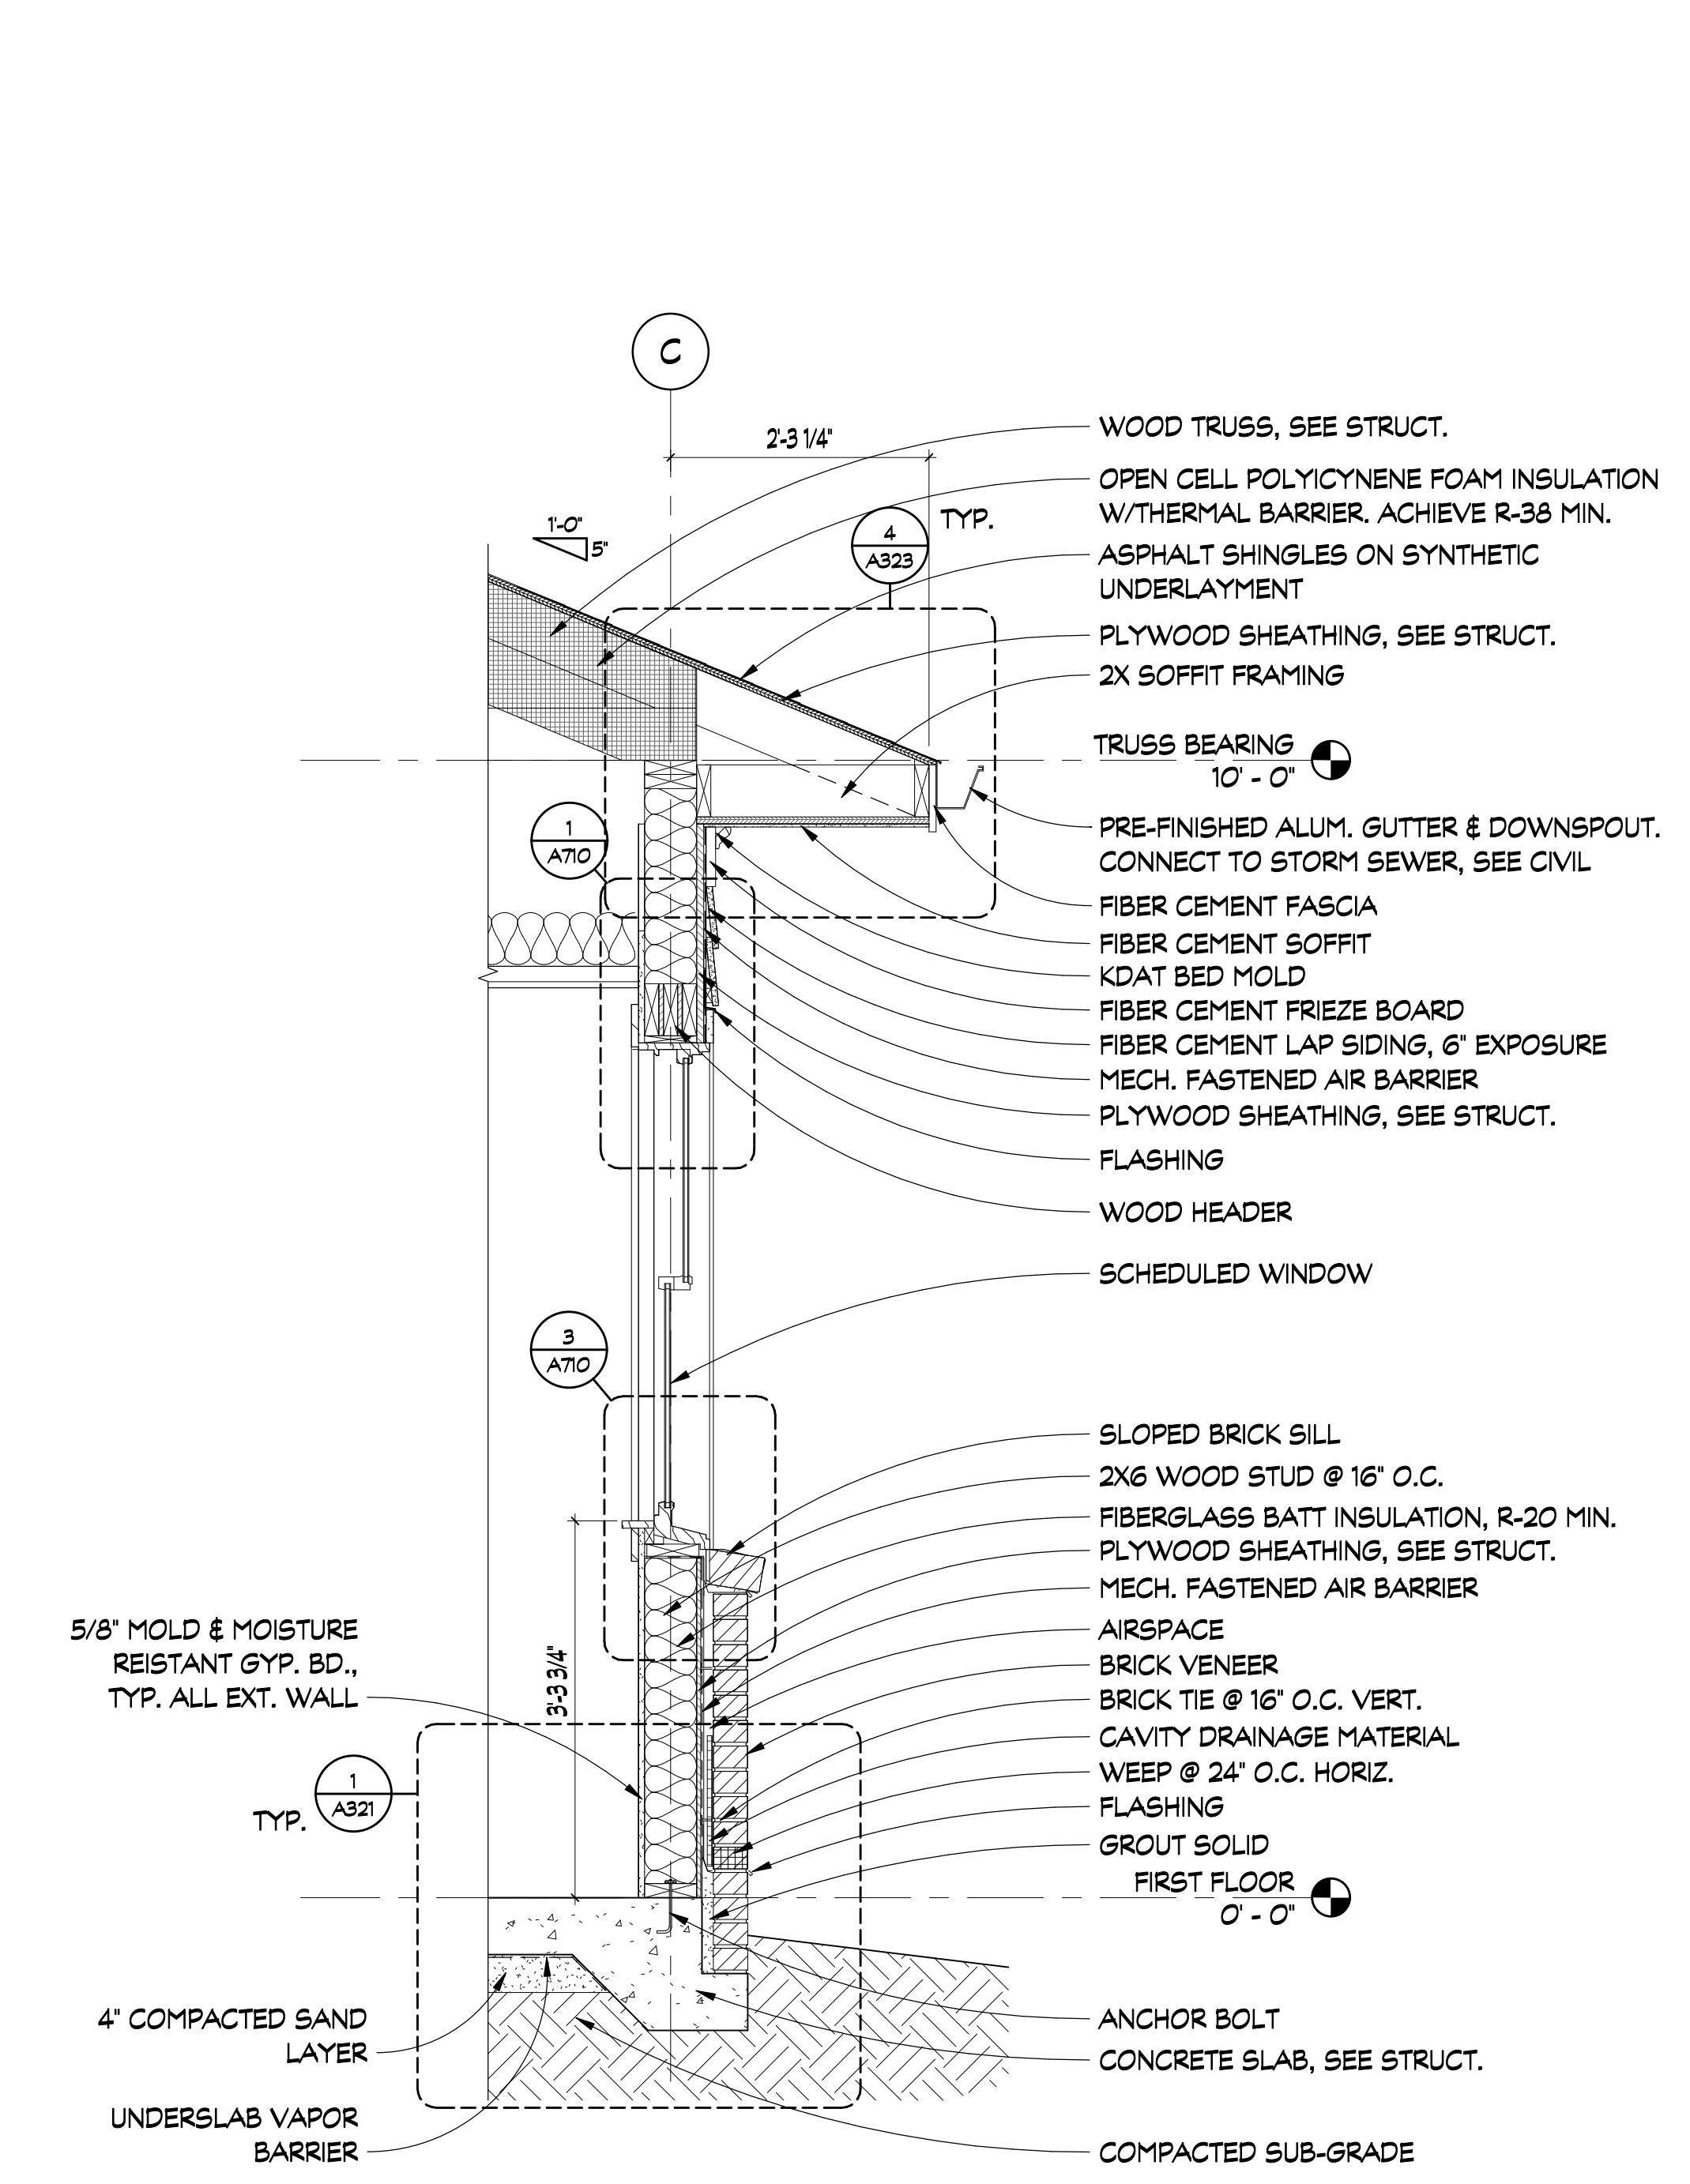

3 WALL SECTION
SCALE: 3/4" = 1'-0"



STATE OF GEORGIA
Erin McSoley Athstrong
REGISTERED ARCHITECT
2/16/22

DA PROJECT NUMBER & NAME:
1893
DRAWING TITLE:
**WALL
SECTIONS**


DRAWING NO:
A310

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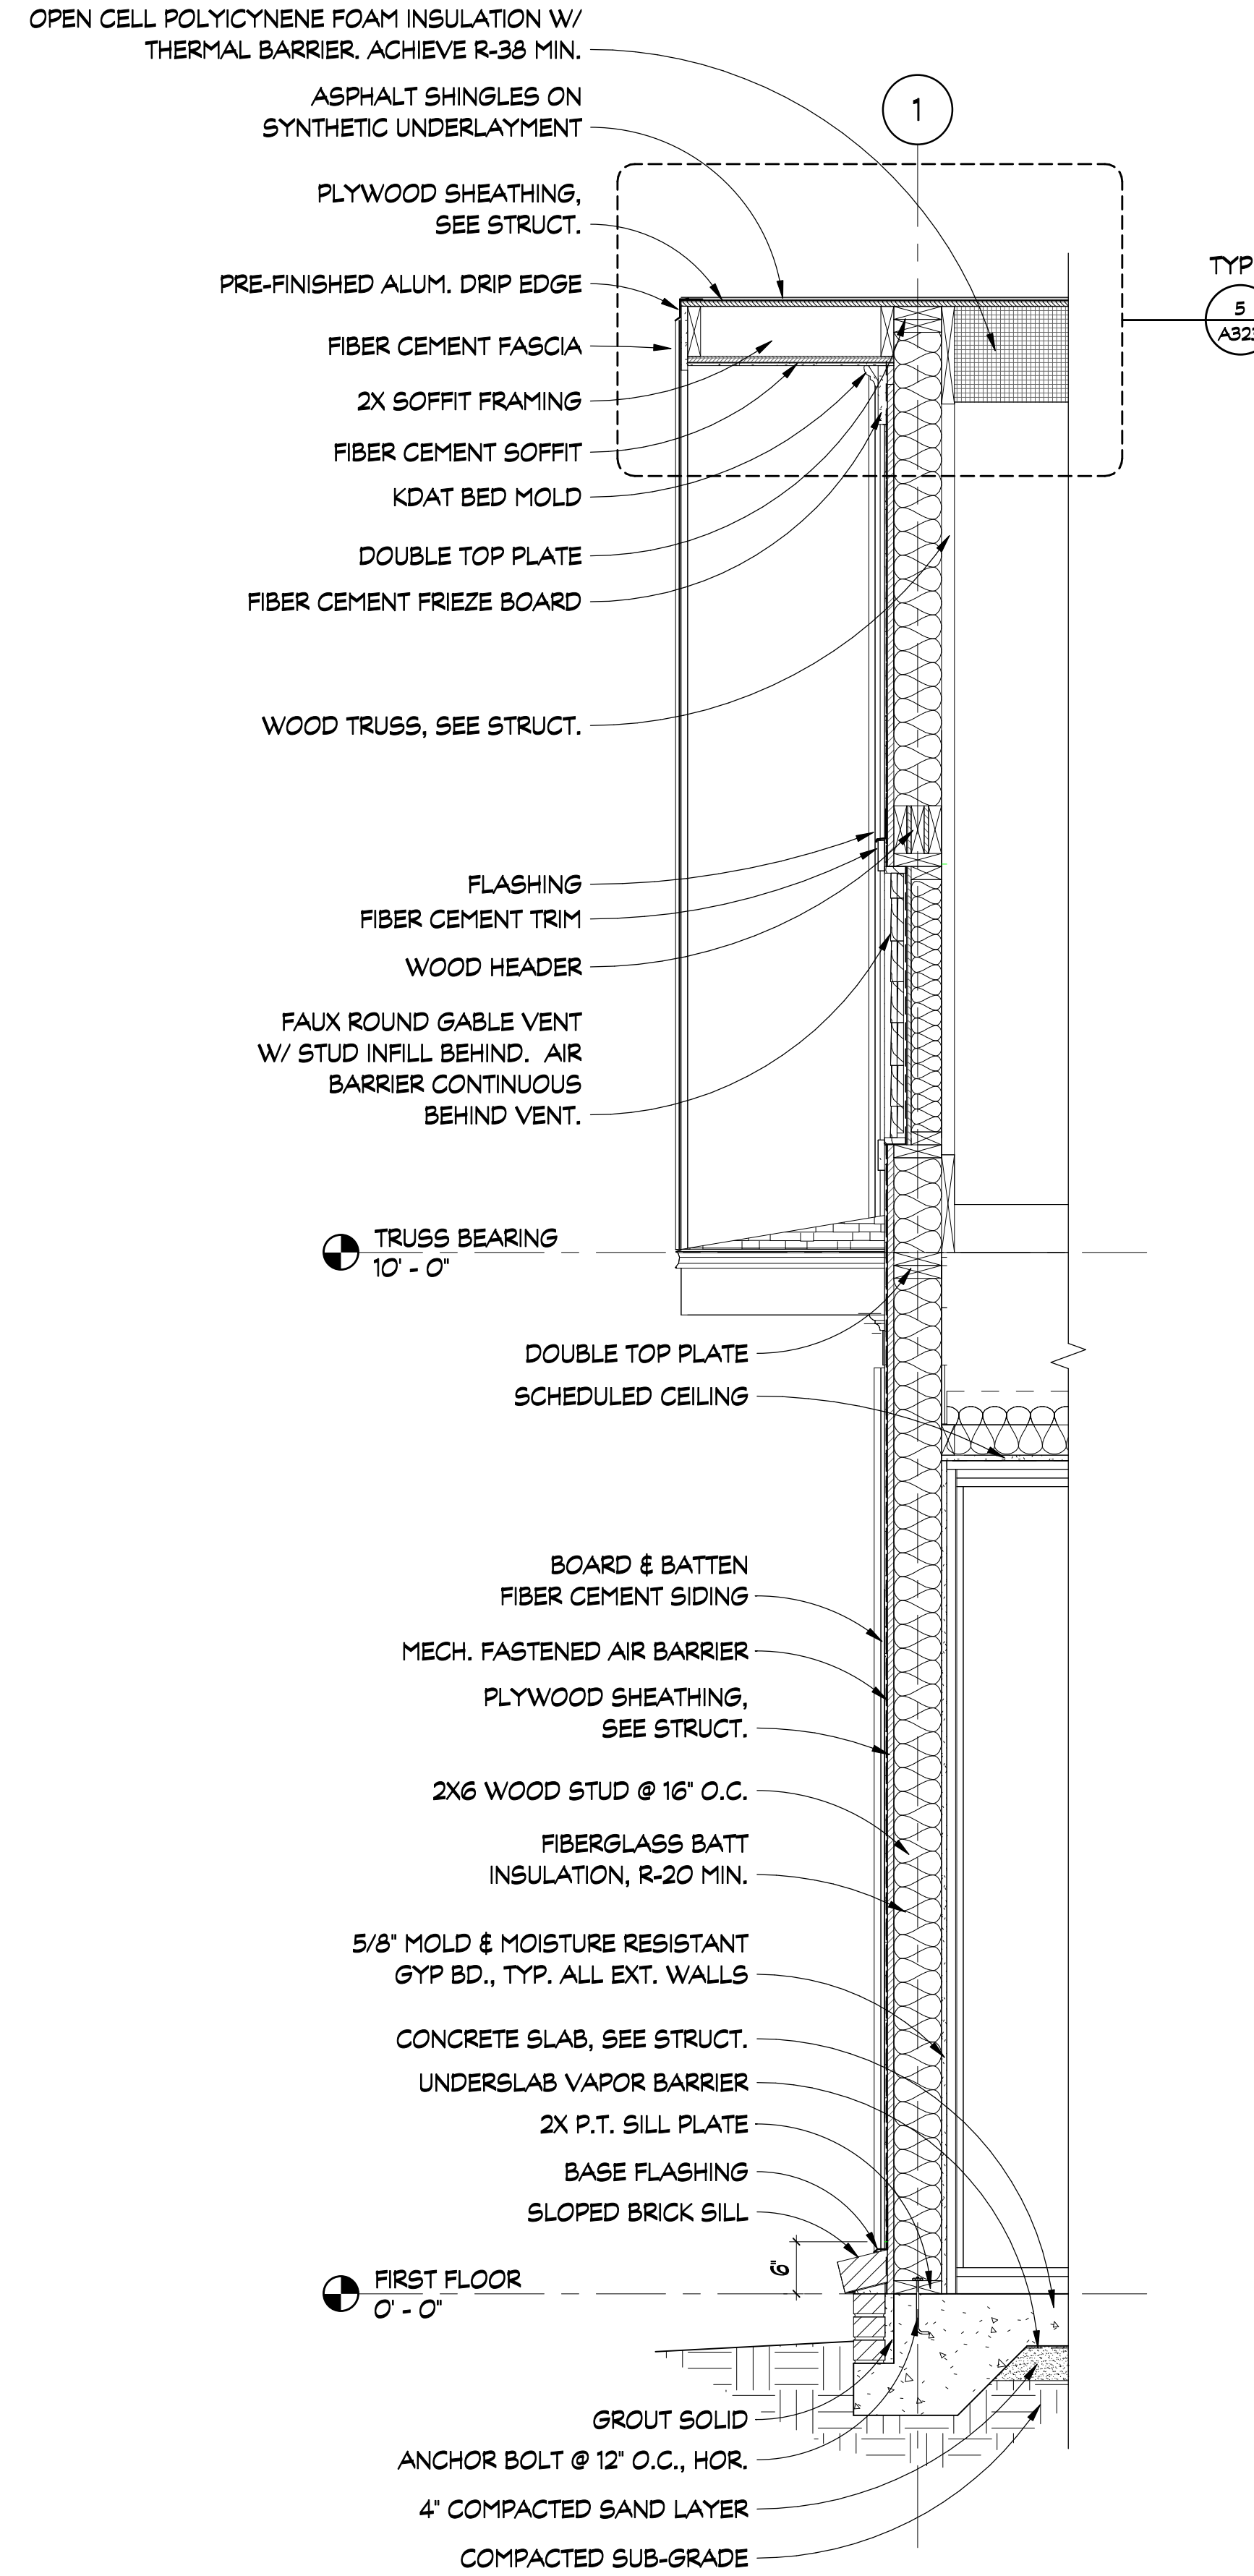


GENERAL NOTES:


- SEE STRUCTURAL FOR PRE-ENGINEERED ROOF TRUSSES. MAJORITY OF ROOF FRAMING NOT SHOWN ON ARCHITECTURAL, BUT IS REQUIRED.
- GC TO COORD. ALL ABOVE-CEILING M/E/P/PP EQUIPMENT W/ ROOF TRUSS DESIGN.

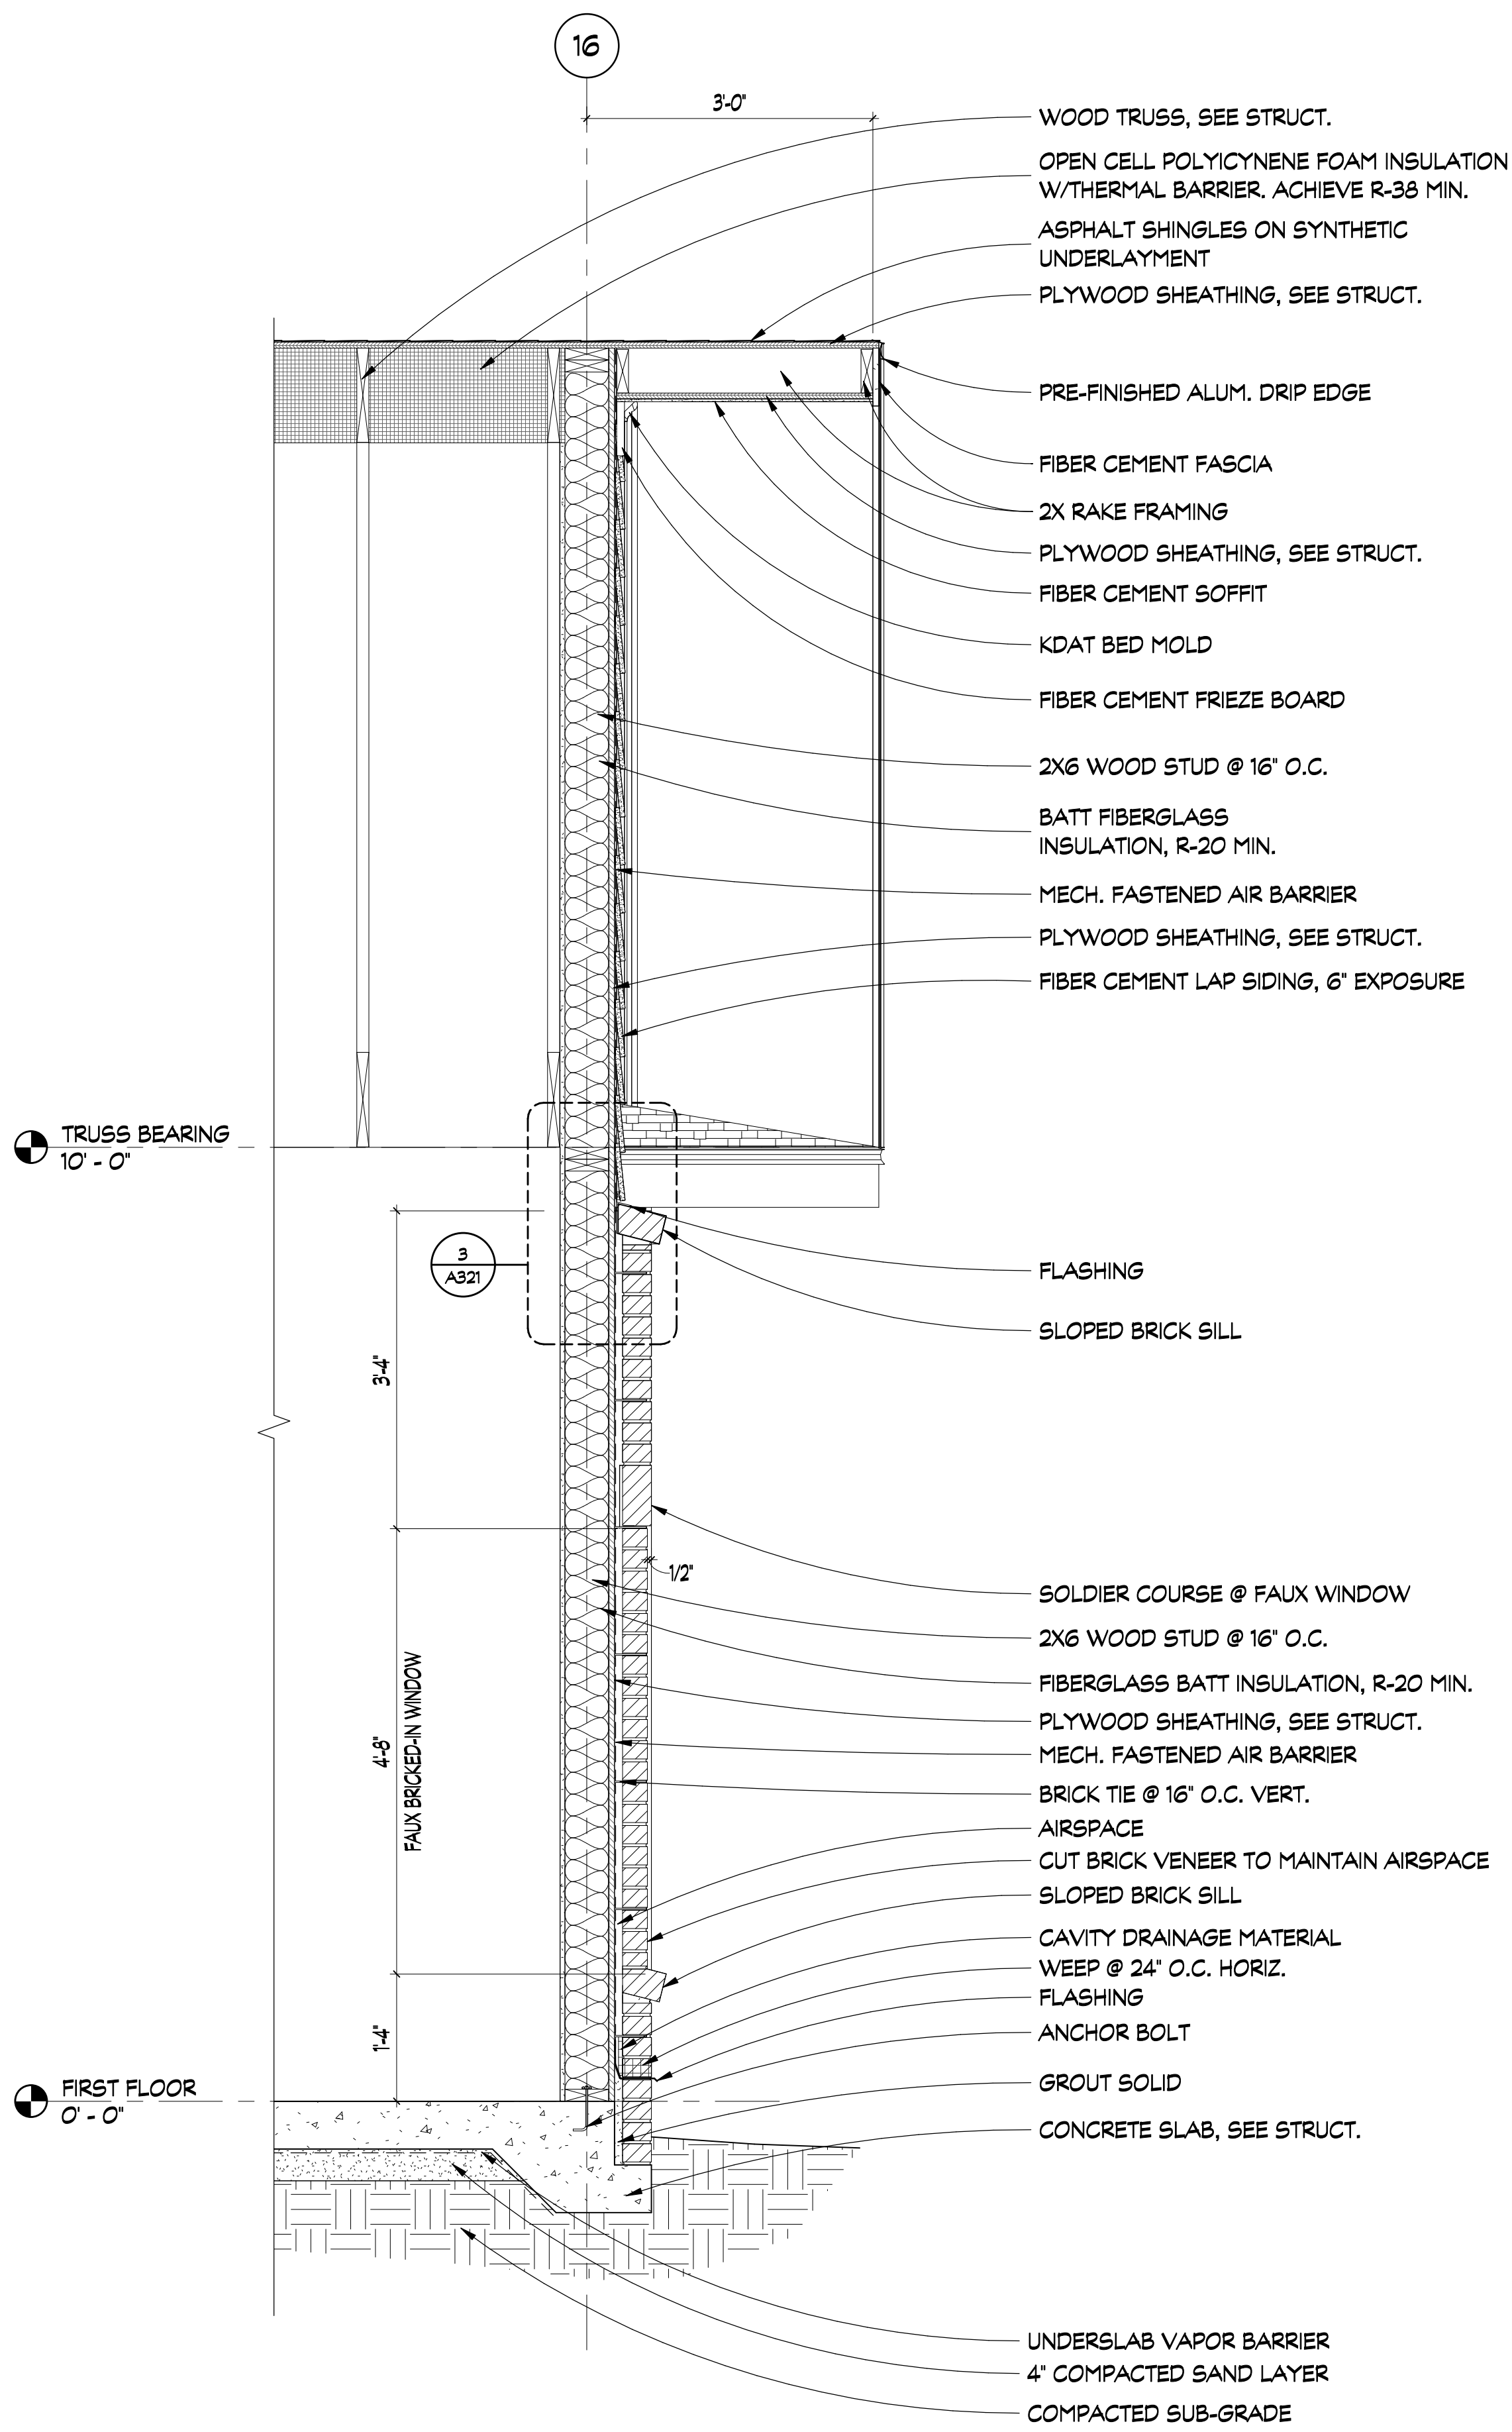


1
WALL SECTION
SCALE: 3/4" = 1'-0"



2
WALL SECTION
SCALE: 3/4" = 1'-0"

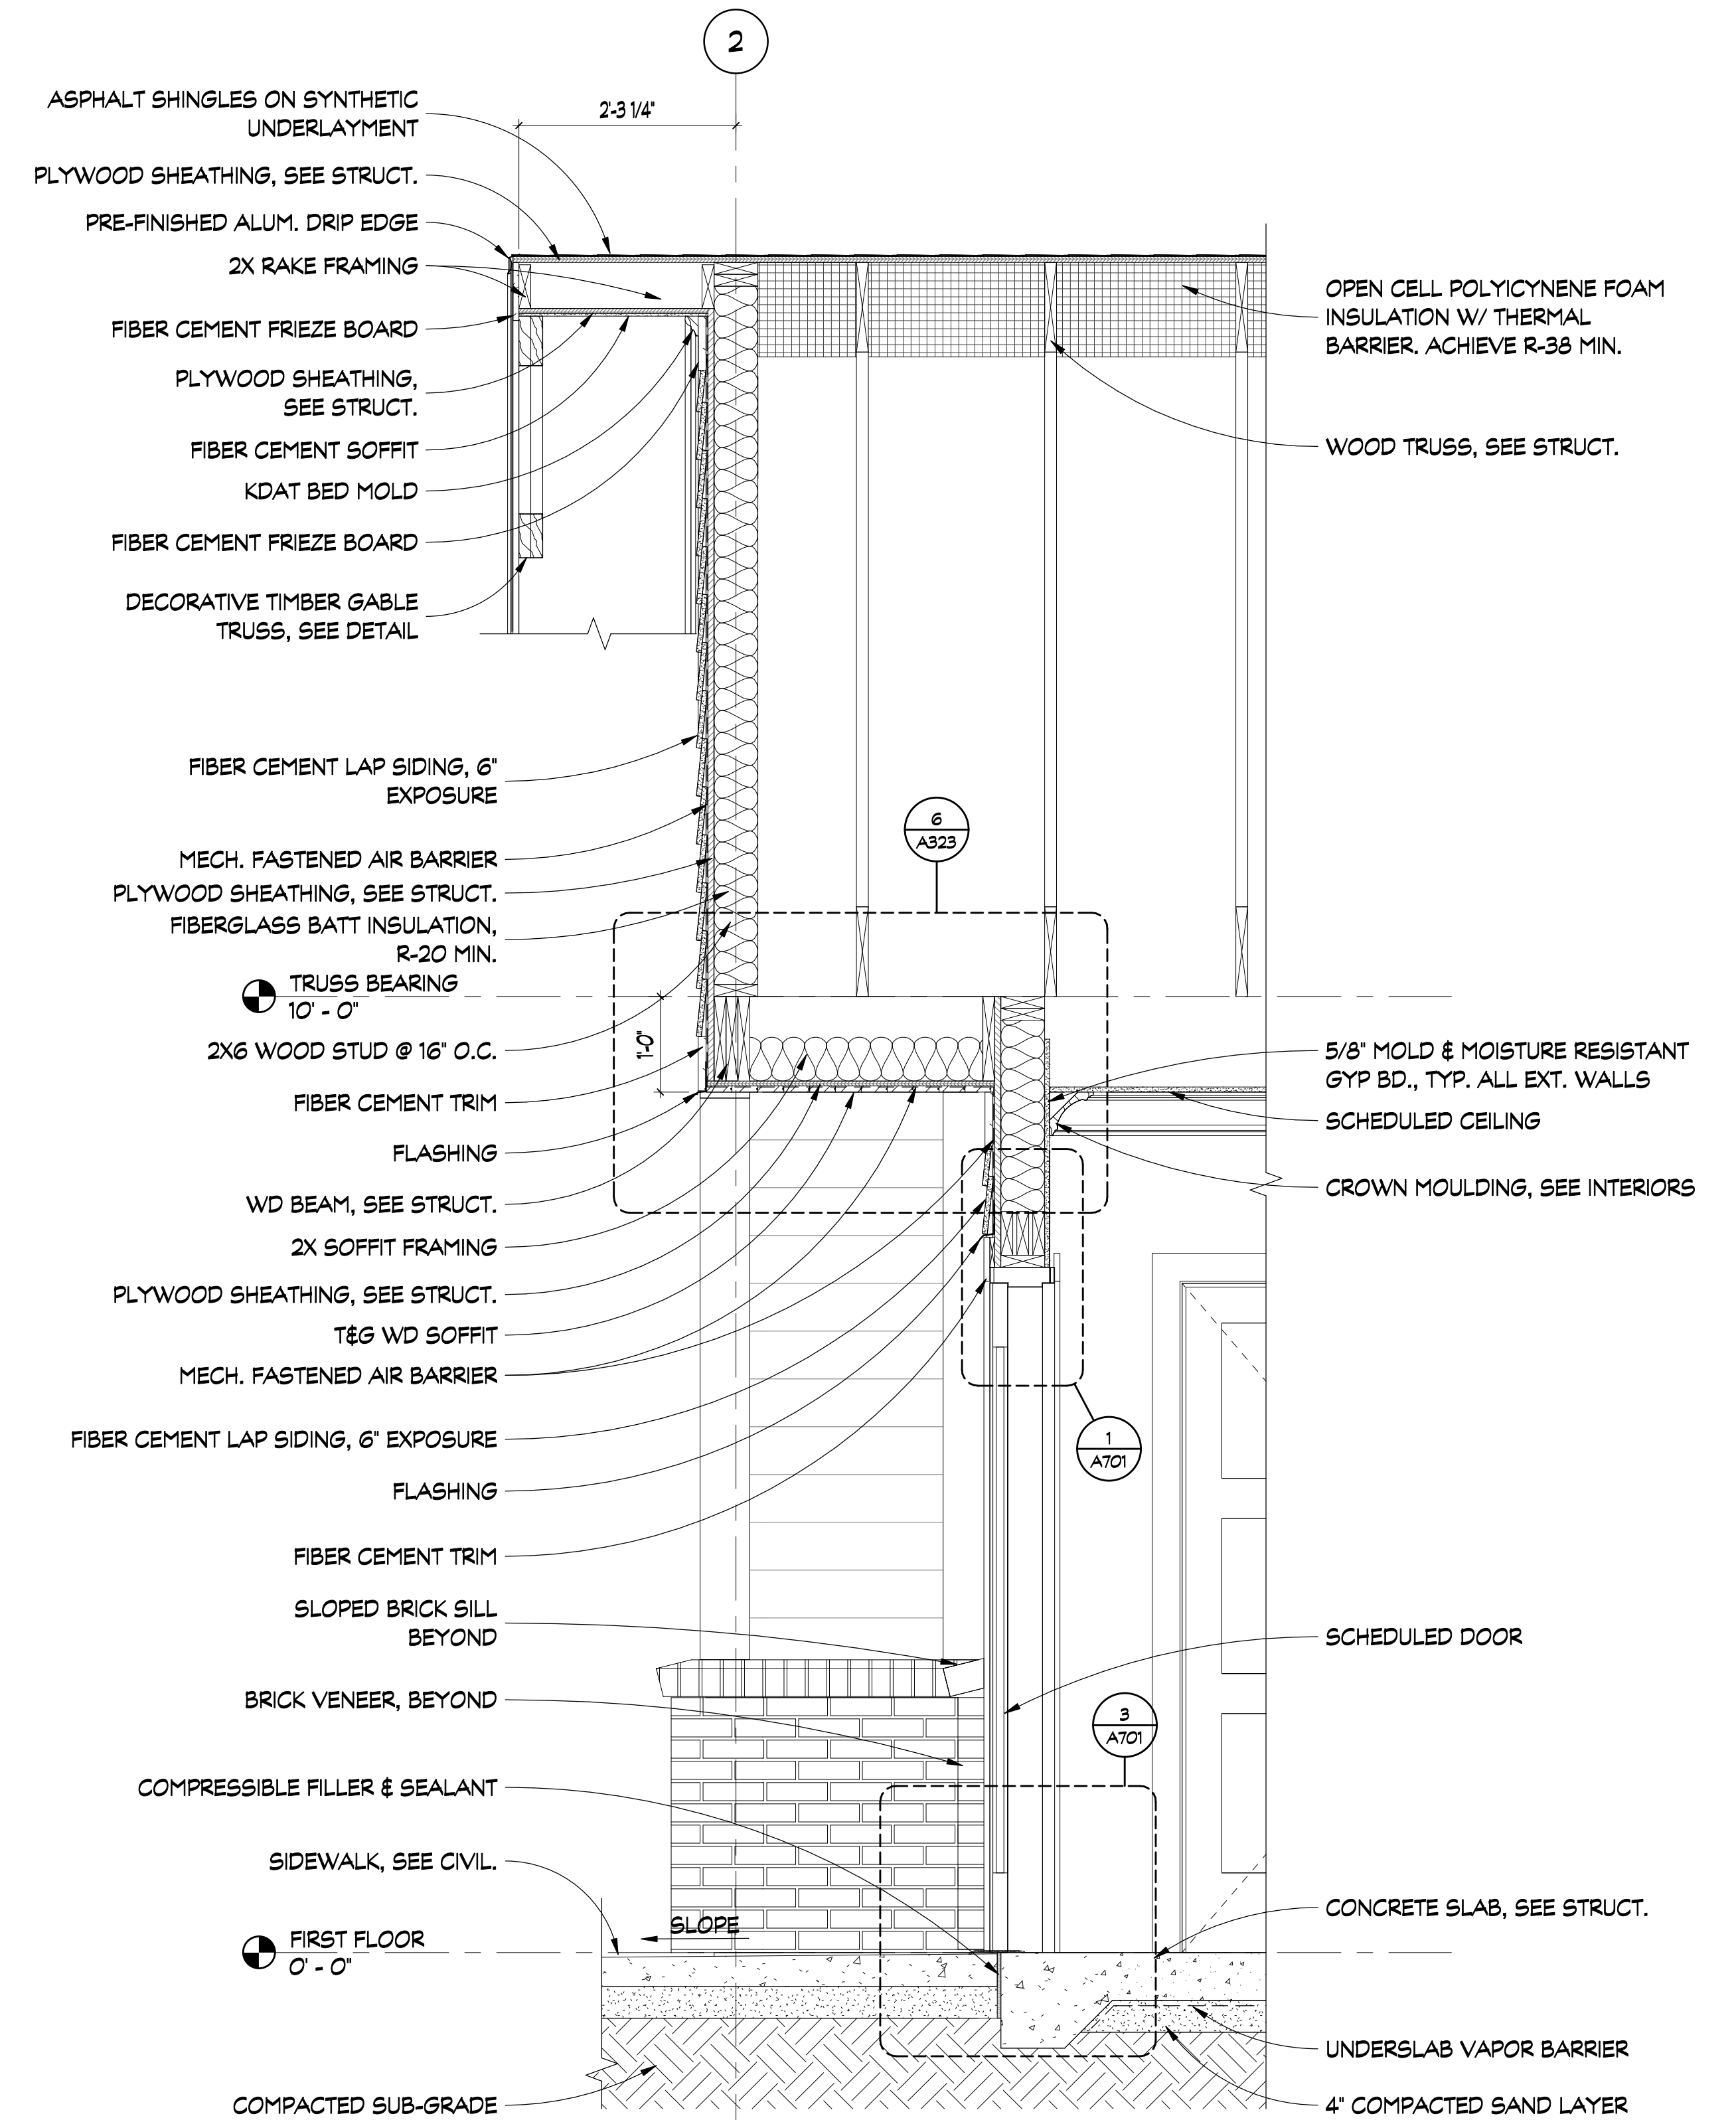

3
WALL SECTION
SCALE: 3/4" = 1'-0"

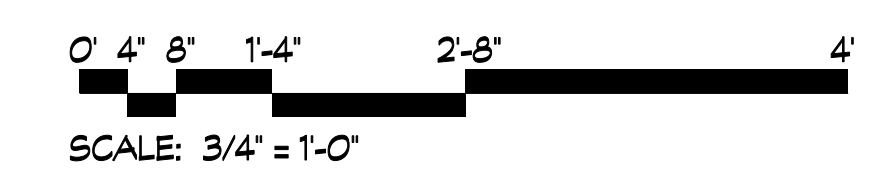

REVISIONS				
REV #	DATE	BY	APRVD	REVISION
1	11/17/21	EA		65% SET
2	2/16/22	EA		ISSUE FOR PERMIT




DA PROJECT NUMBER & NAME:
1893


DRAWING TITLE:
**WALL
SECTIONS**

DRAWING NO:
A311

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1 WALL SECTION
A302 SCALE: 3/4" = 1'-0"

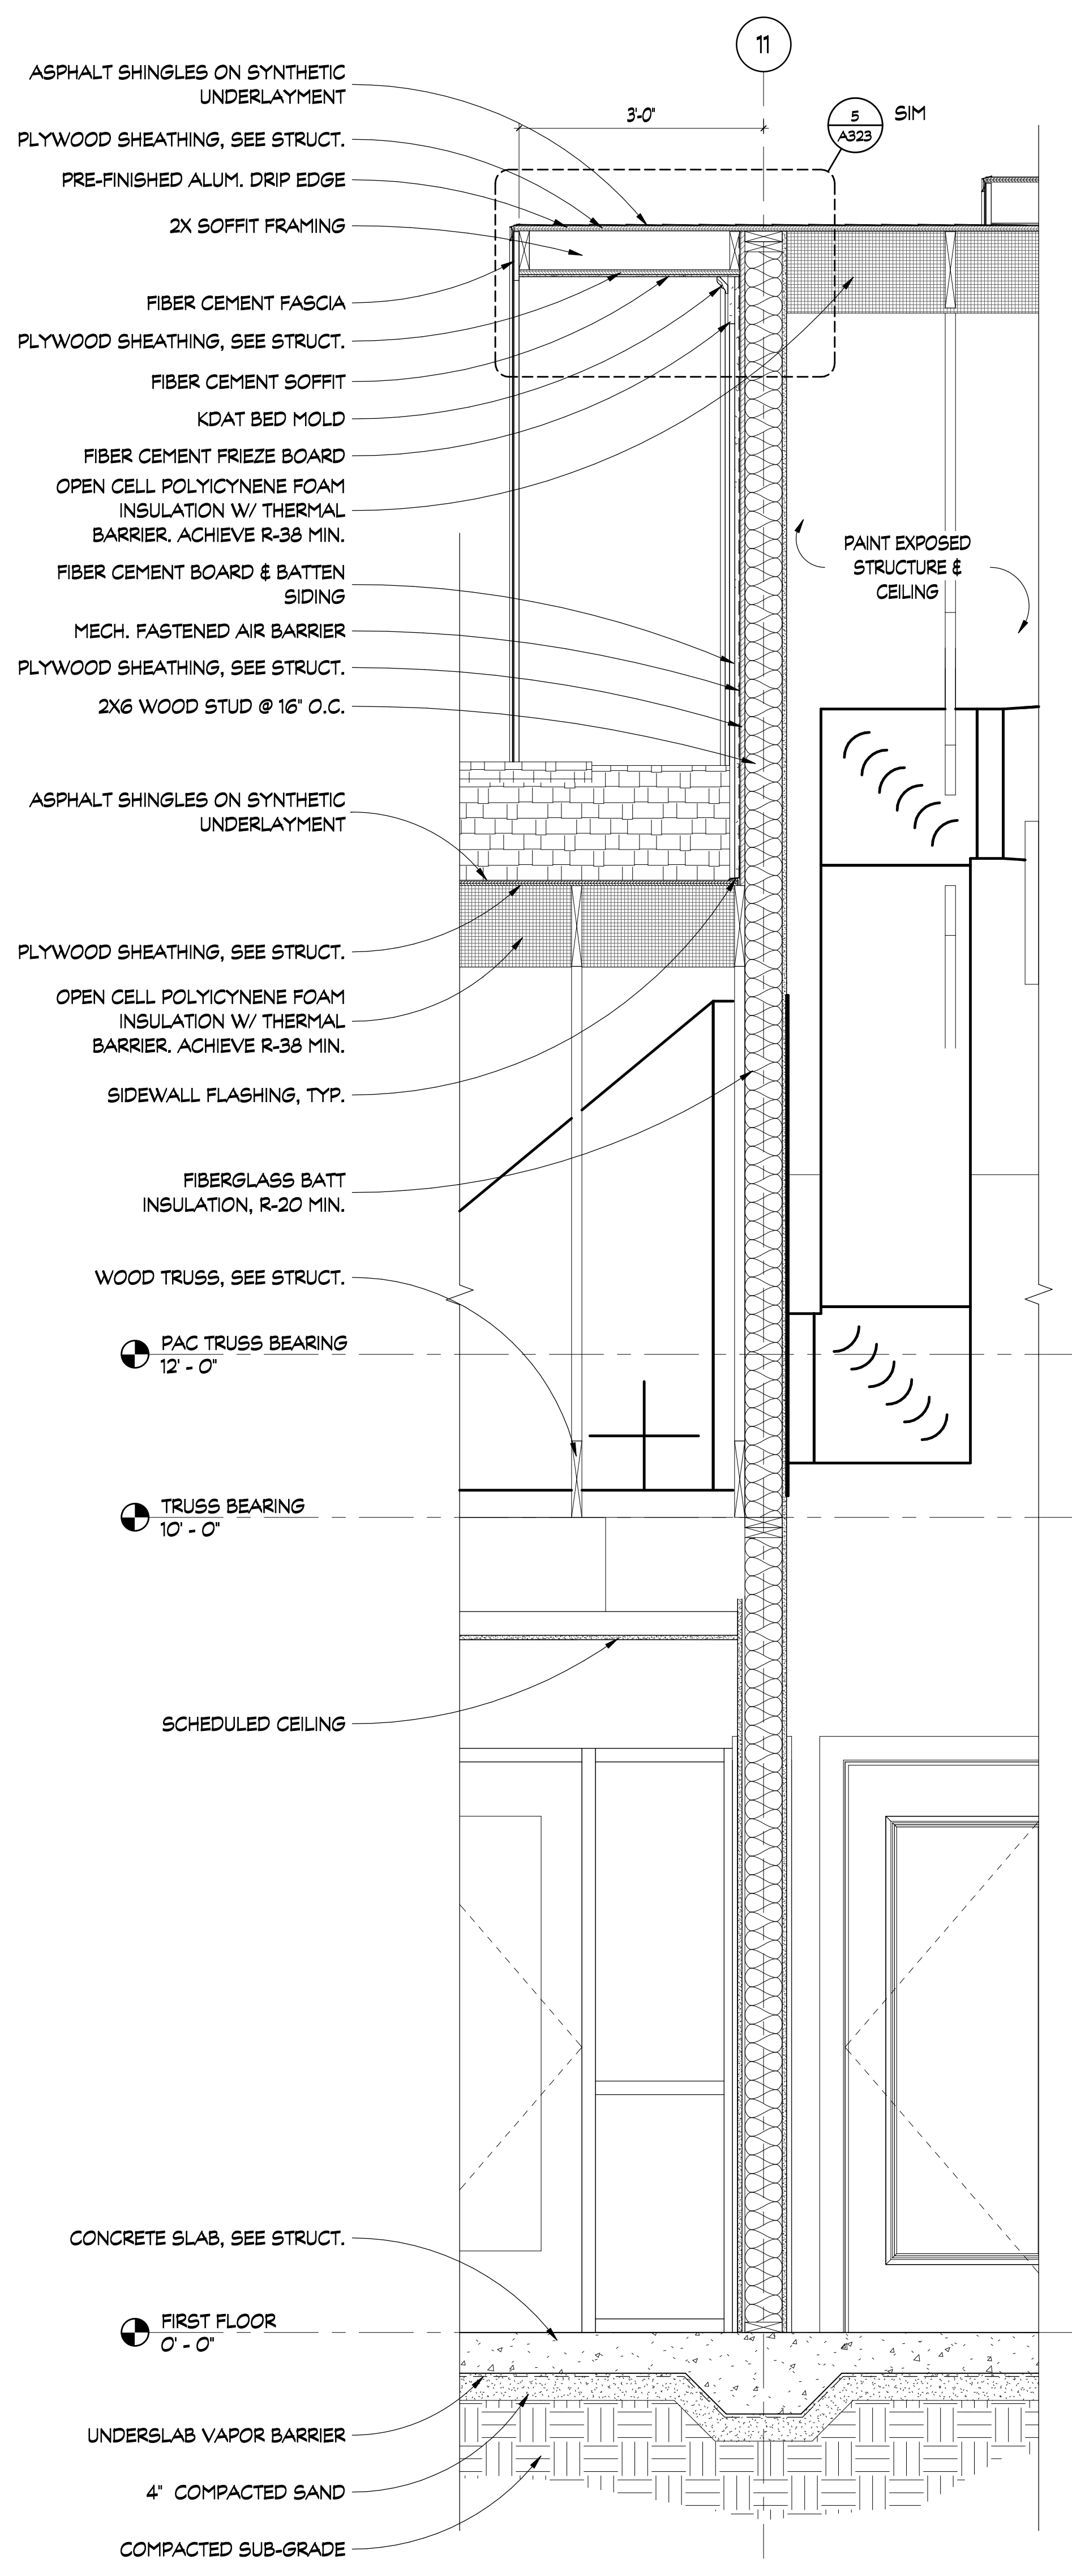

2 WALL SECTION
A302 SCALE: 3/4" = 1'-0"

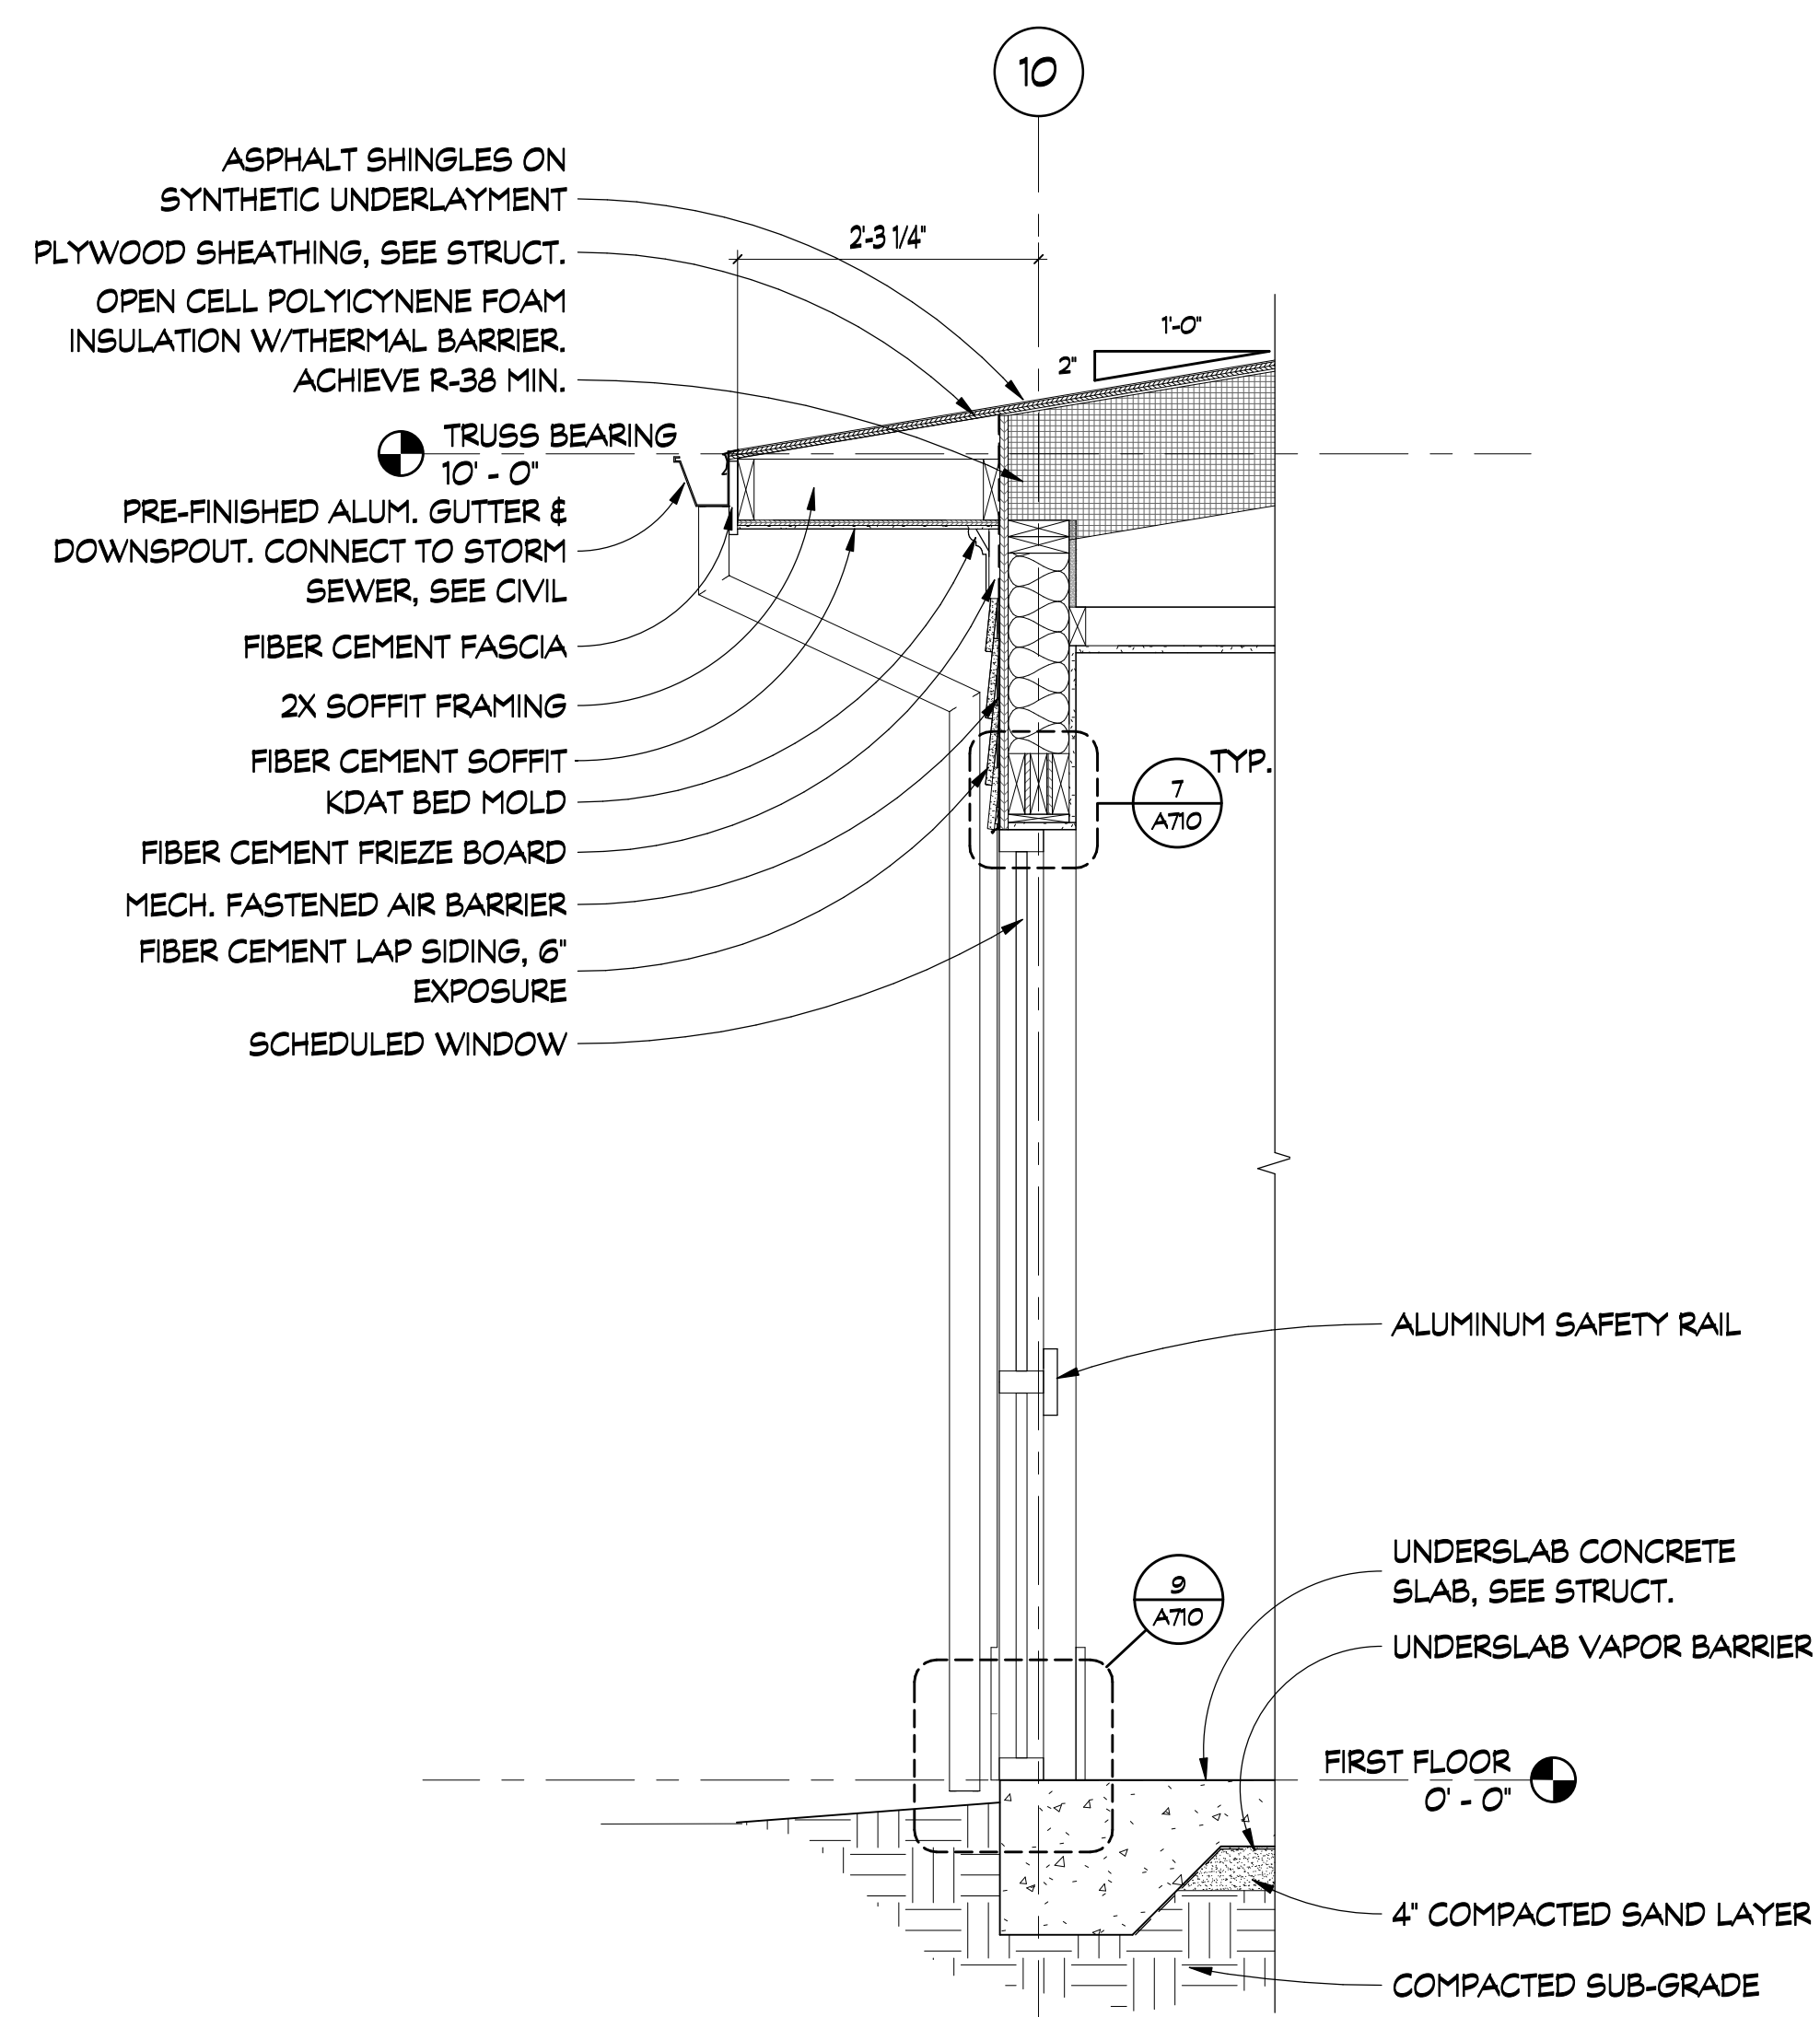GENERAL NOTES:


- SEE STRUCTURAL FOR PRE-ENGINEERED ROOF TRUSSES. MAJORITY OF ROOF FRAMING NOT SHOWN ON ARCHITECTURAL, BUT IS REQUIRED.
- GC TO COORD. ALL ABOVE-CEILING M/E/P/FP EQUIPMENT W/ ROOF TRUSS DESIGN.

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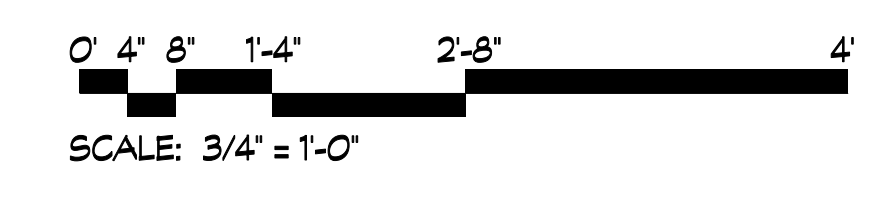
PROJECT TITLE:
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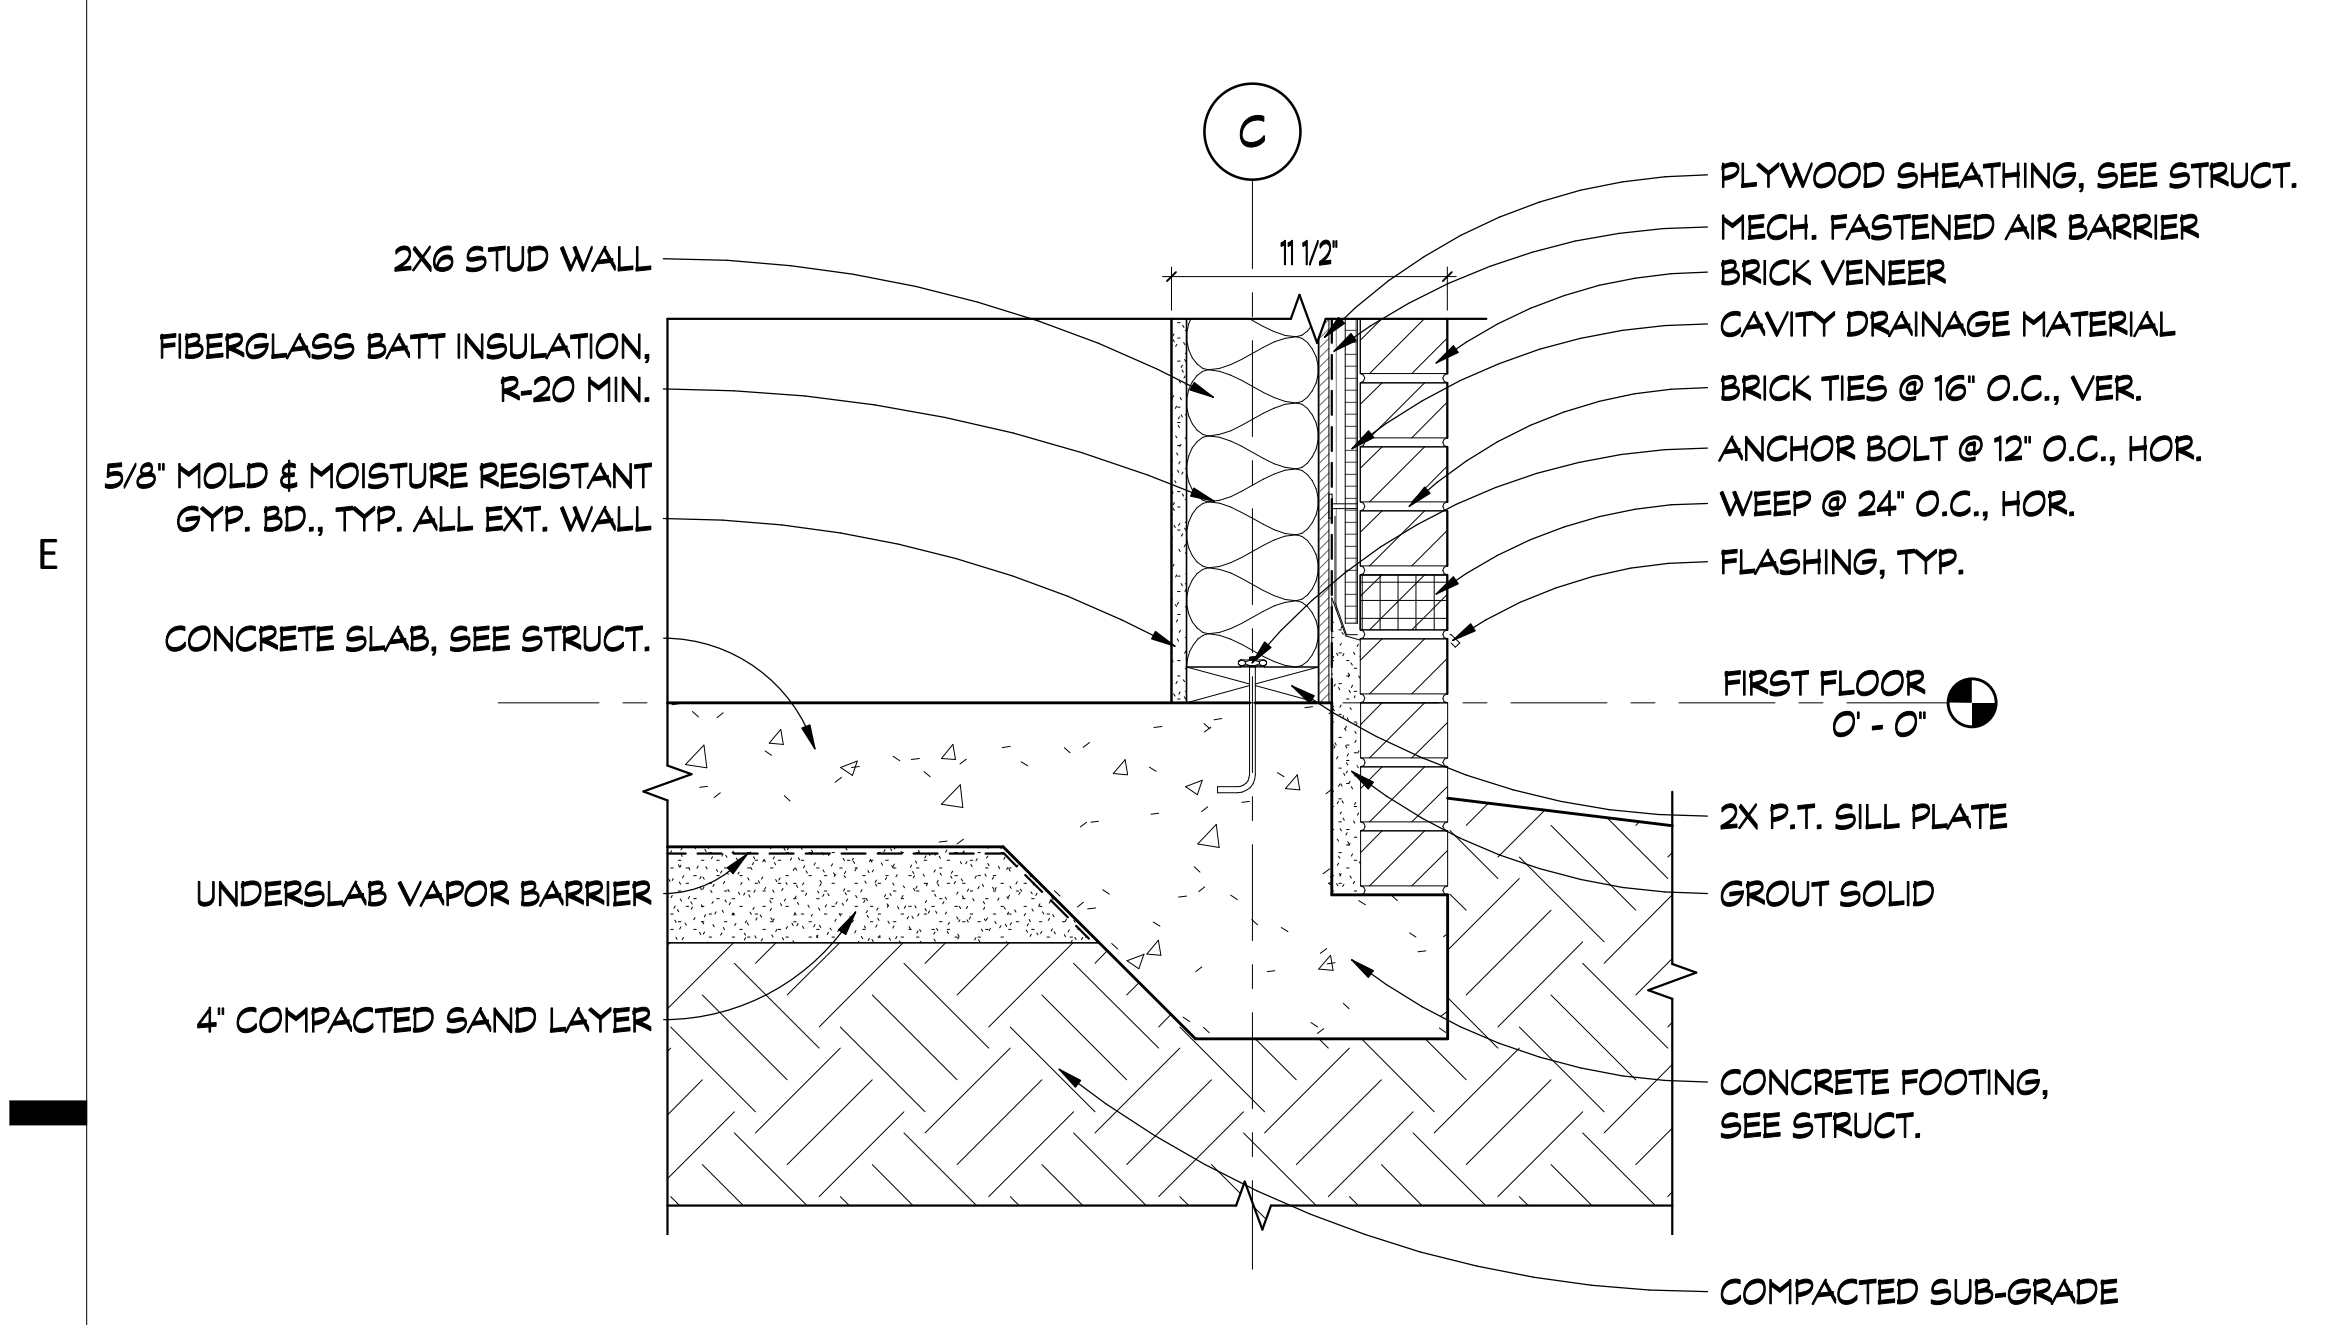
REVISIONS			
REV #	DATE	APRVD BY	REVISION
1	11/17/21	EA	65% SET
2	2/16/22	EA	ISSUE FOR PERMIT




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1893
DRAWING TITLE:
**WALL
SECTIONS**

DRAWING NO:
A312

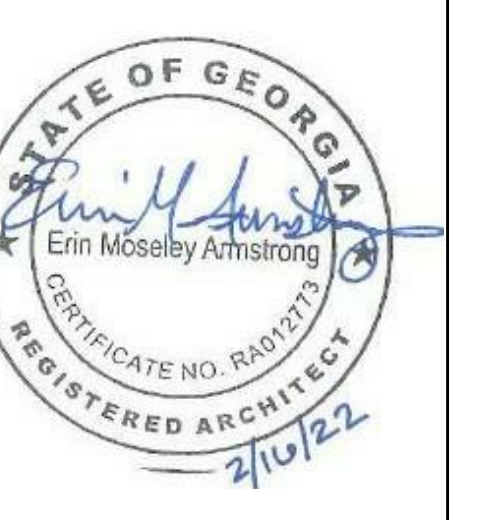





1 FOUNDATION DETAIL
A310 SCALE: 1 1/2" = 1'-0"

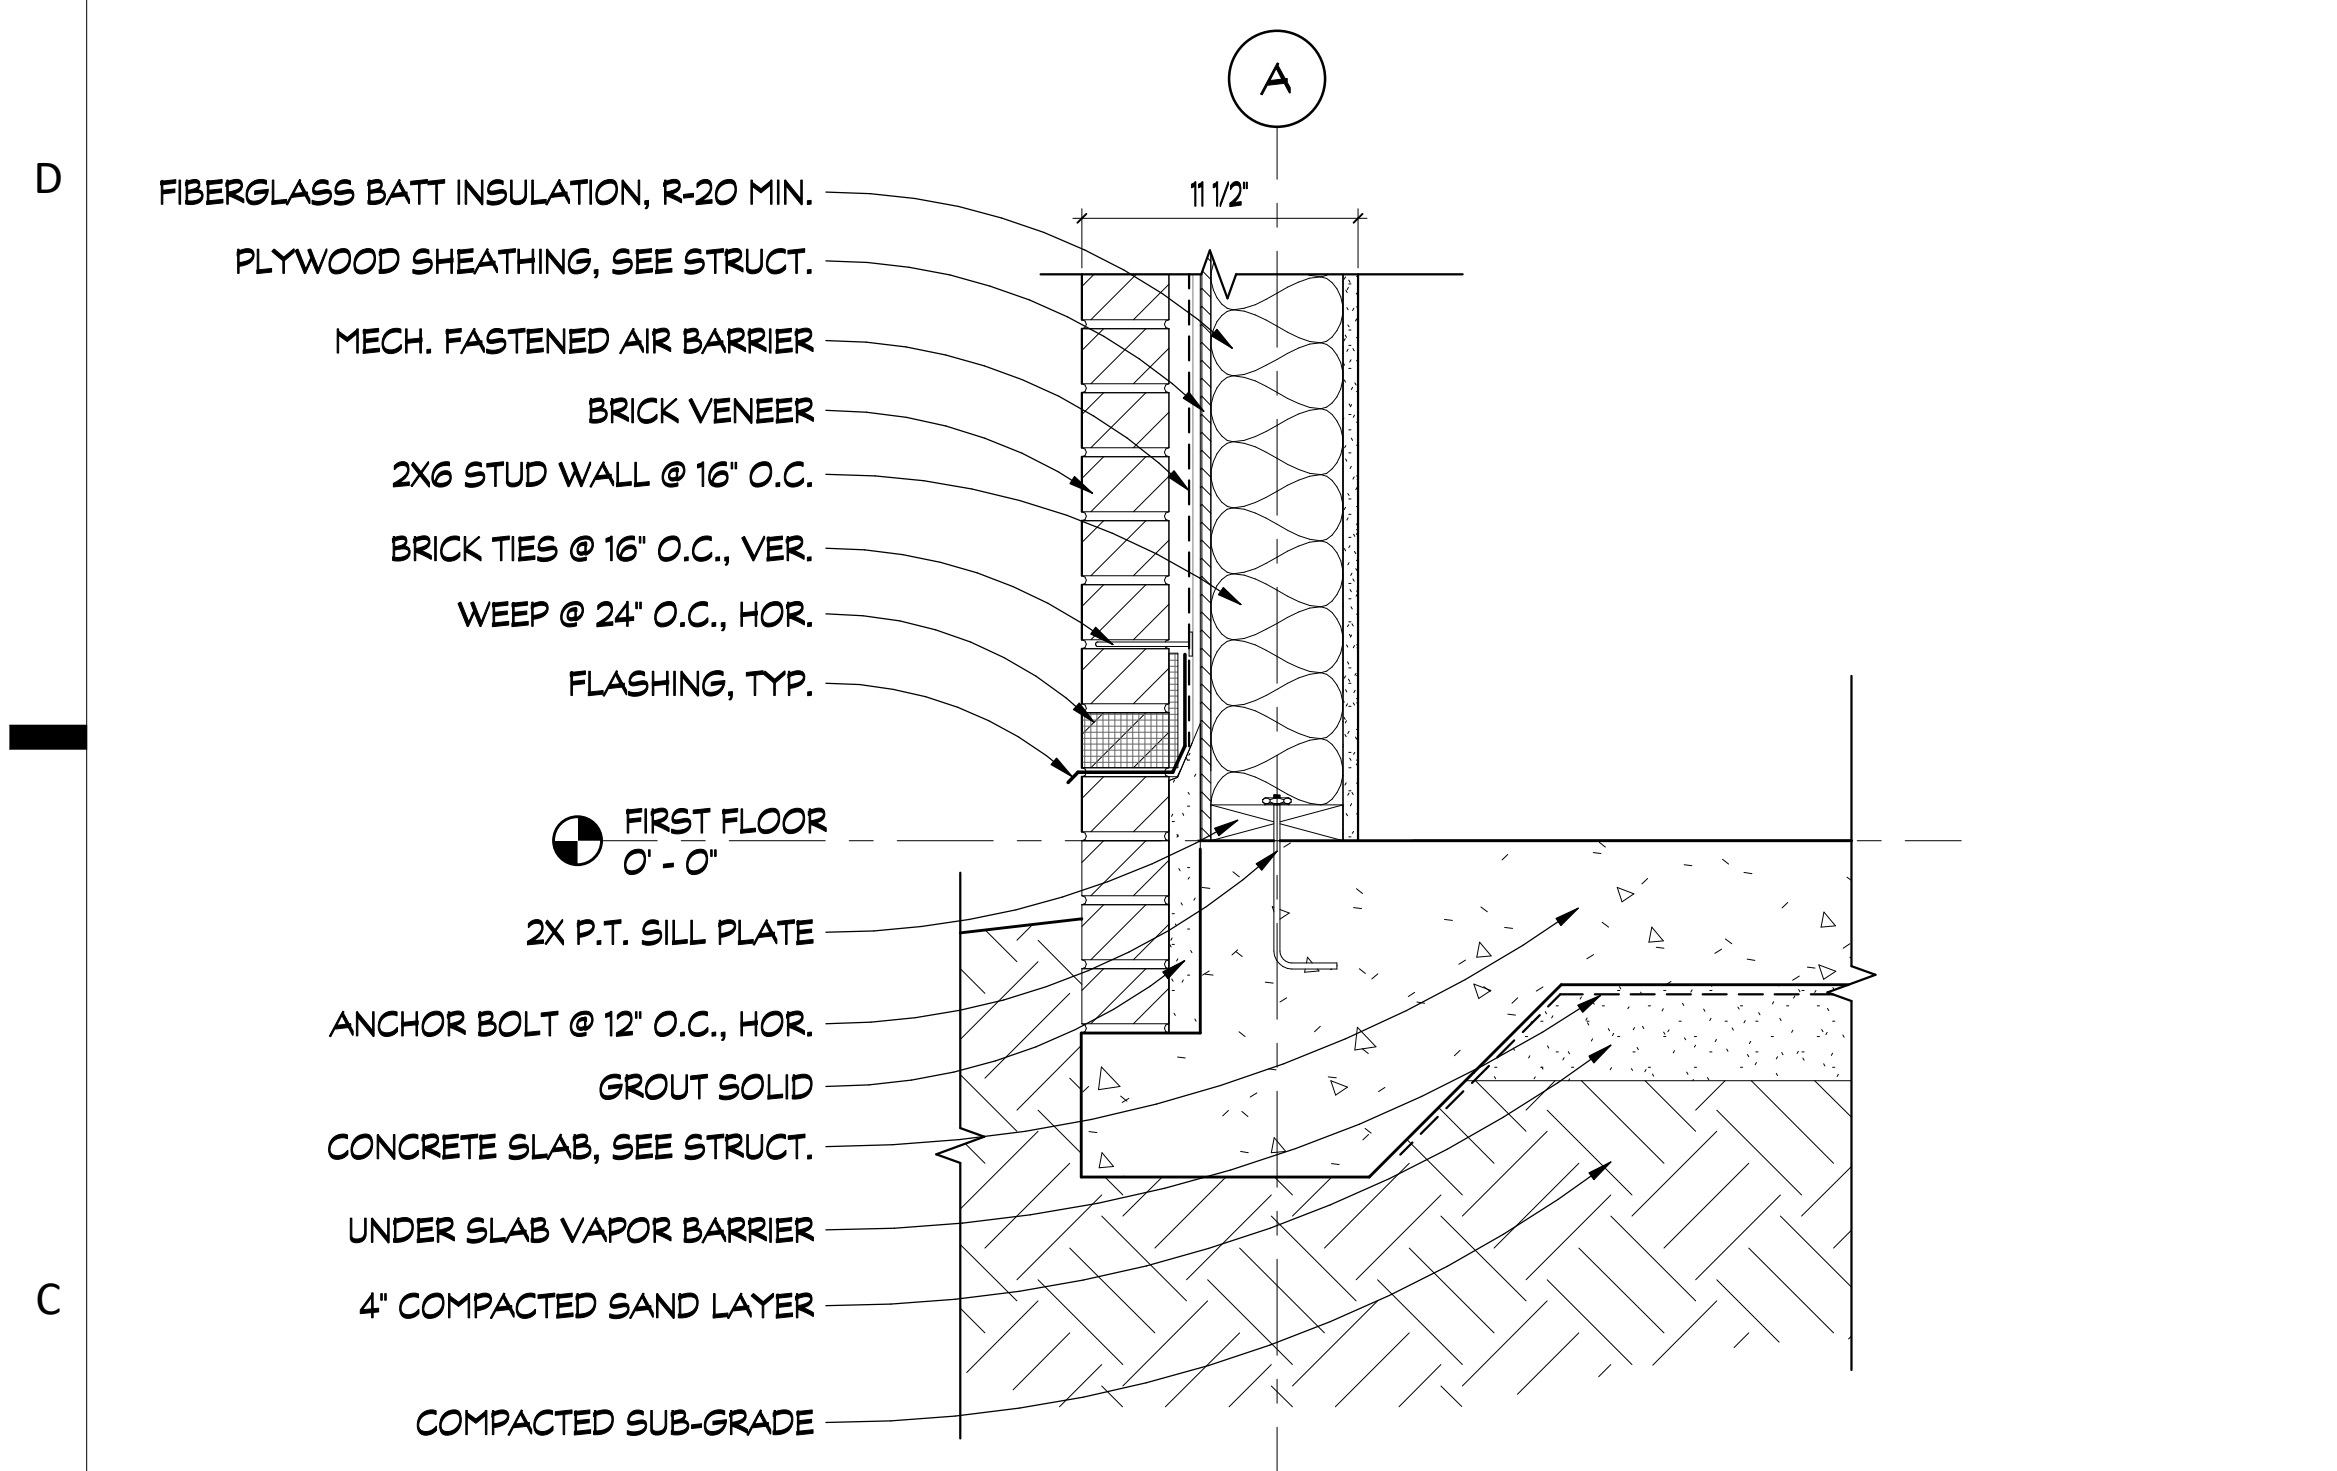


2 FOUNDATION DETAIL
A310 SCALE: 1 1/2" = 1'-0"

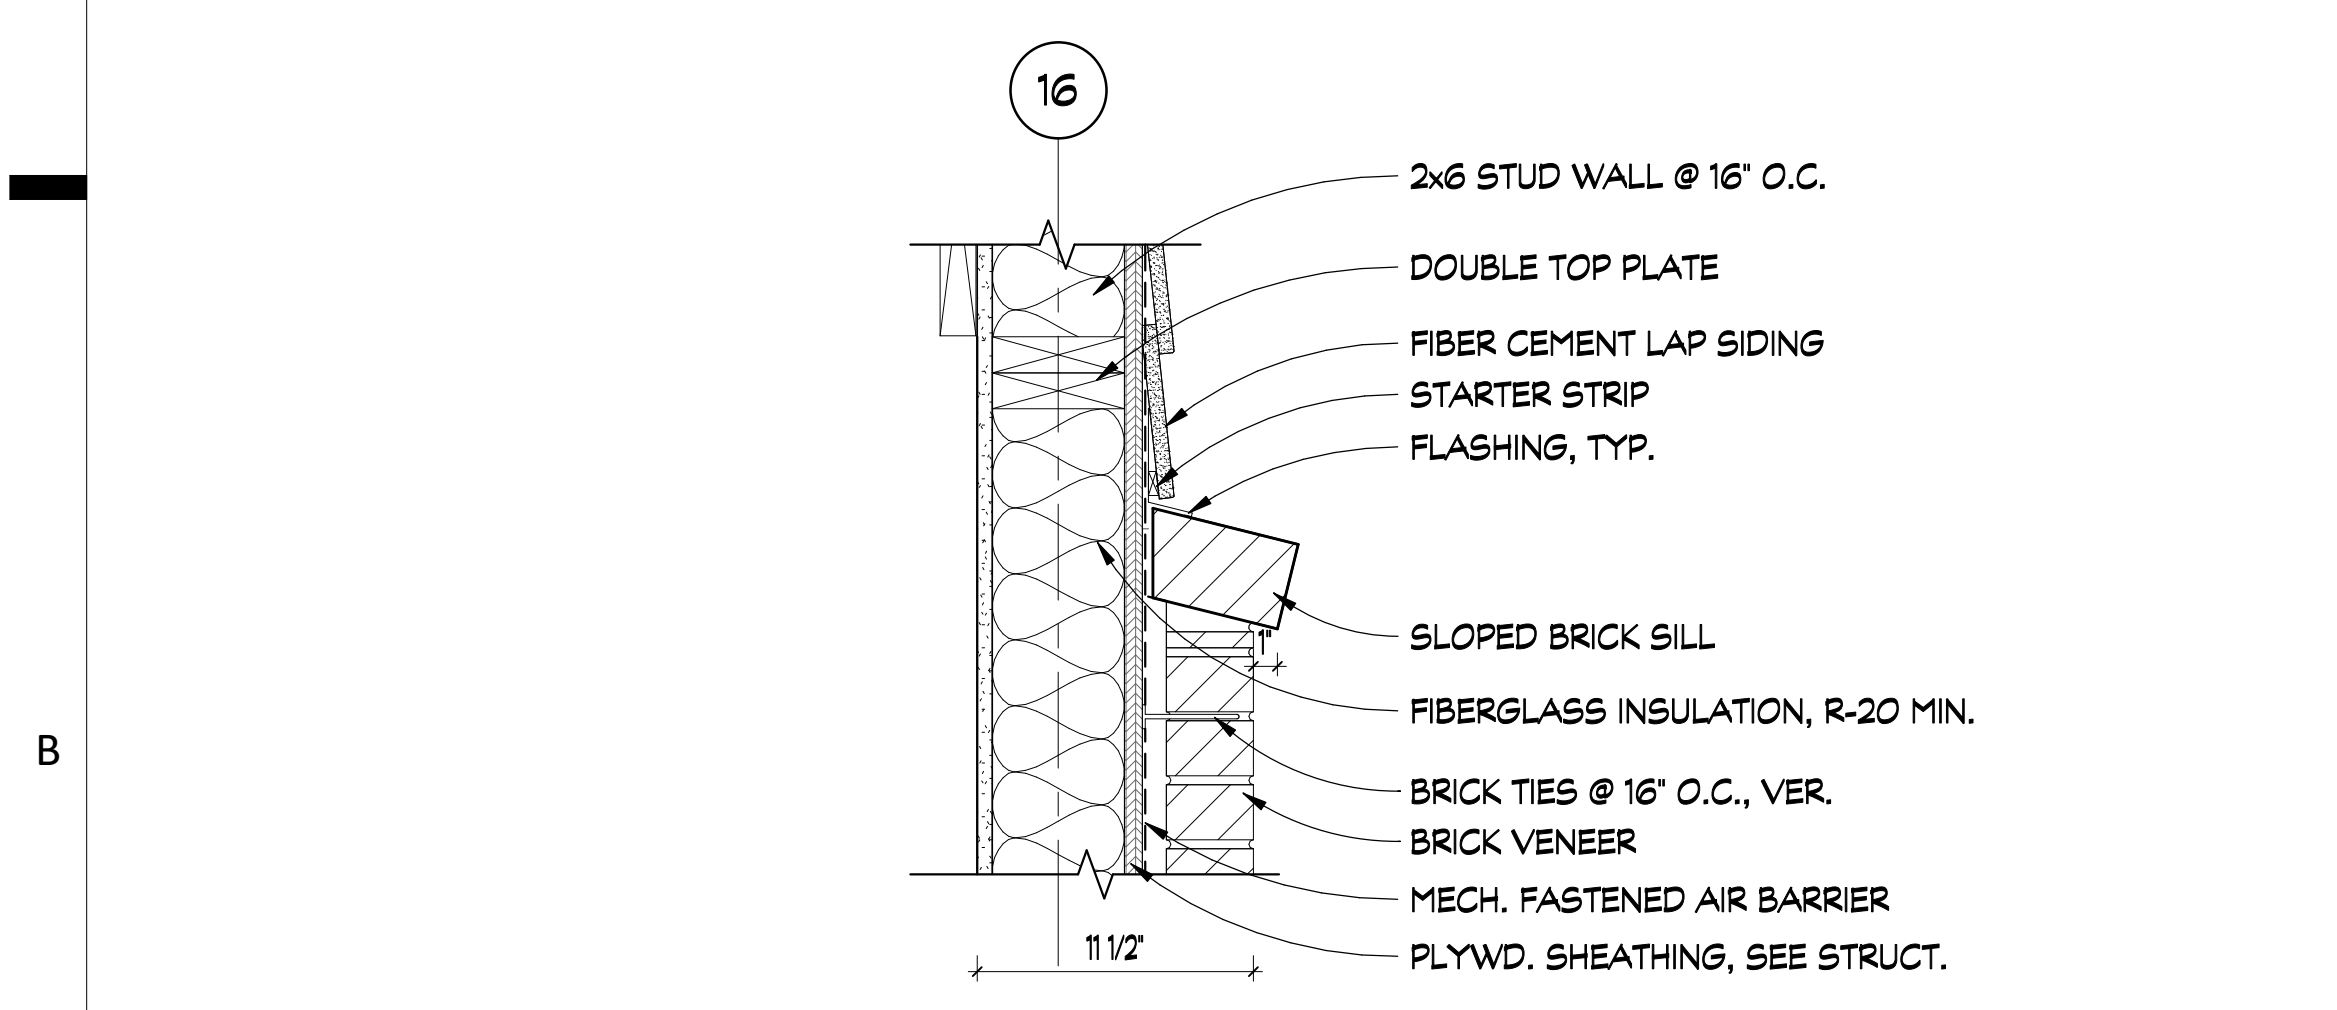


3 FLASHING DETAIL
A311 SCALE: 1 1/2" = 1'-0"

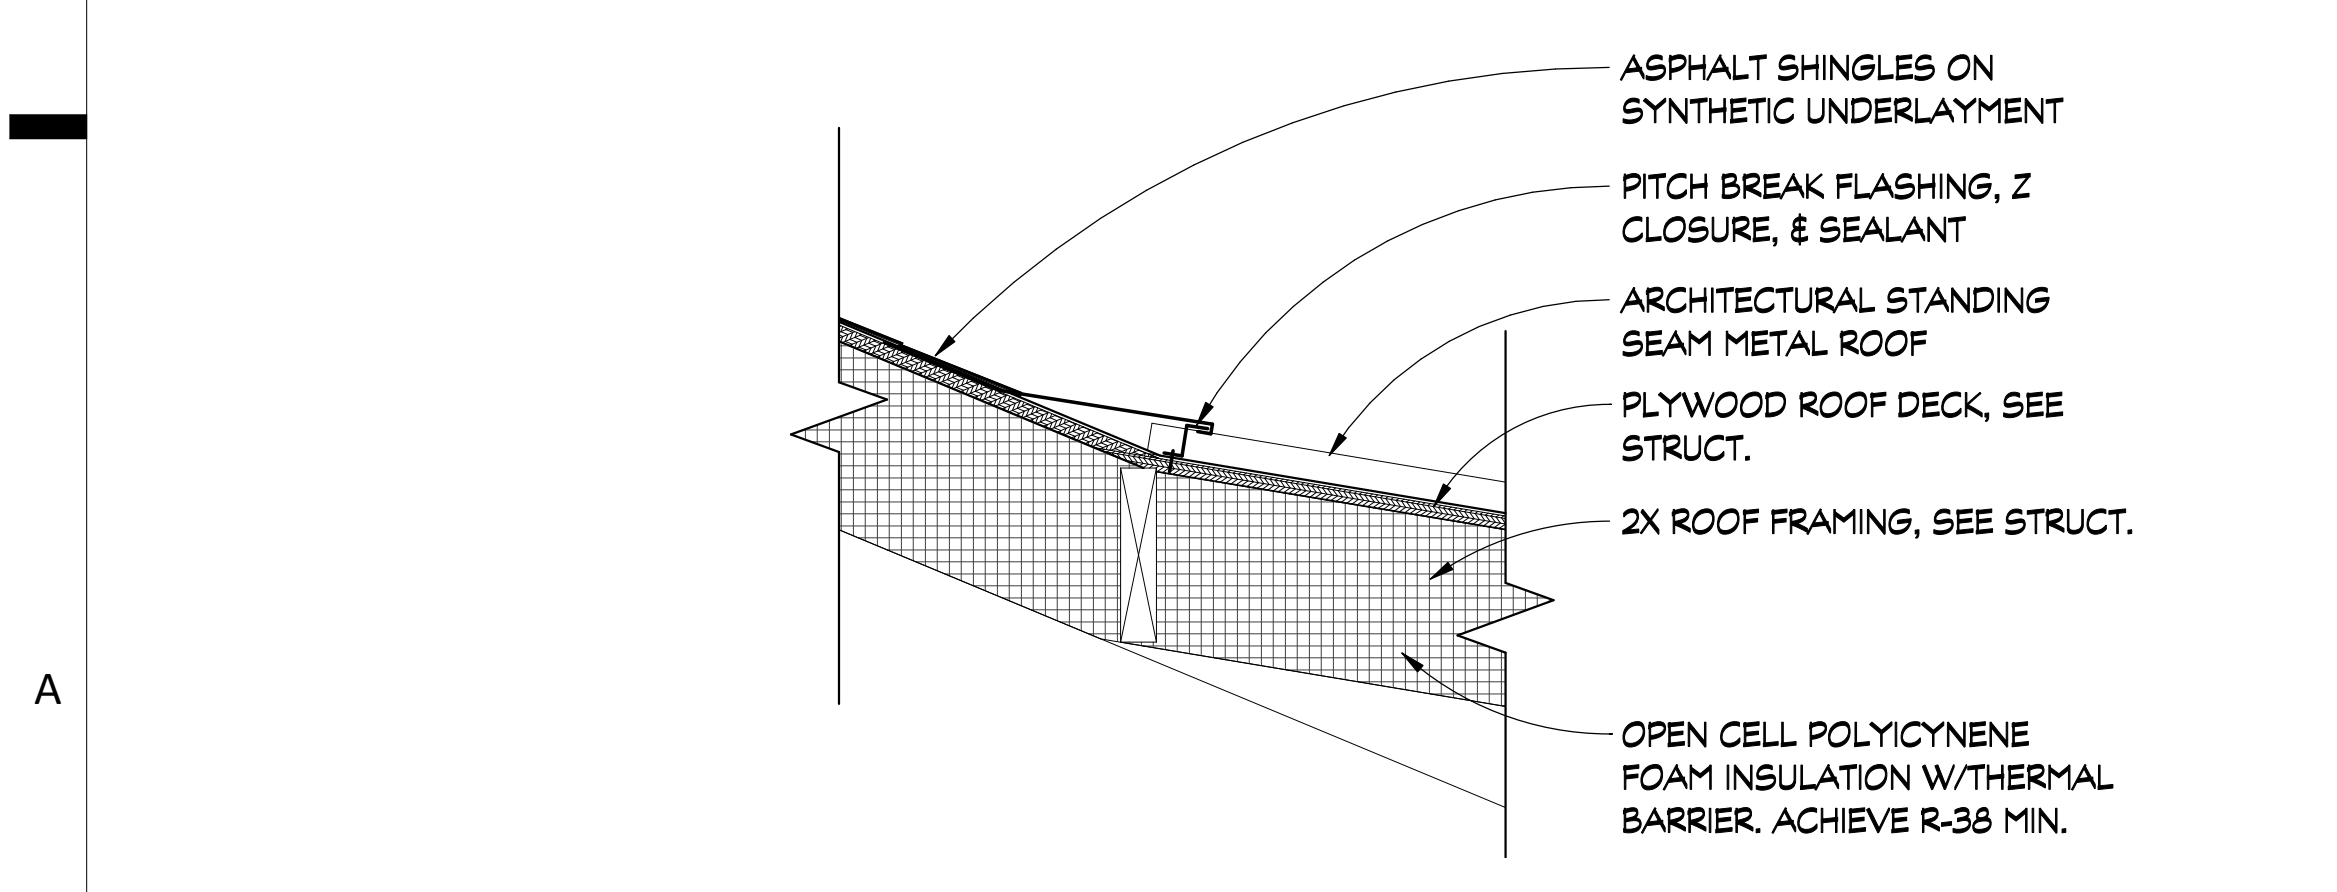


4 ROOF TRANSITION DETAIL
A105 SCALE: 1 1/2" = 1'-0"

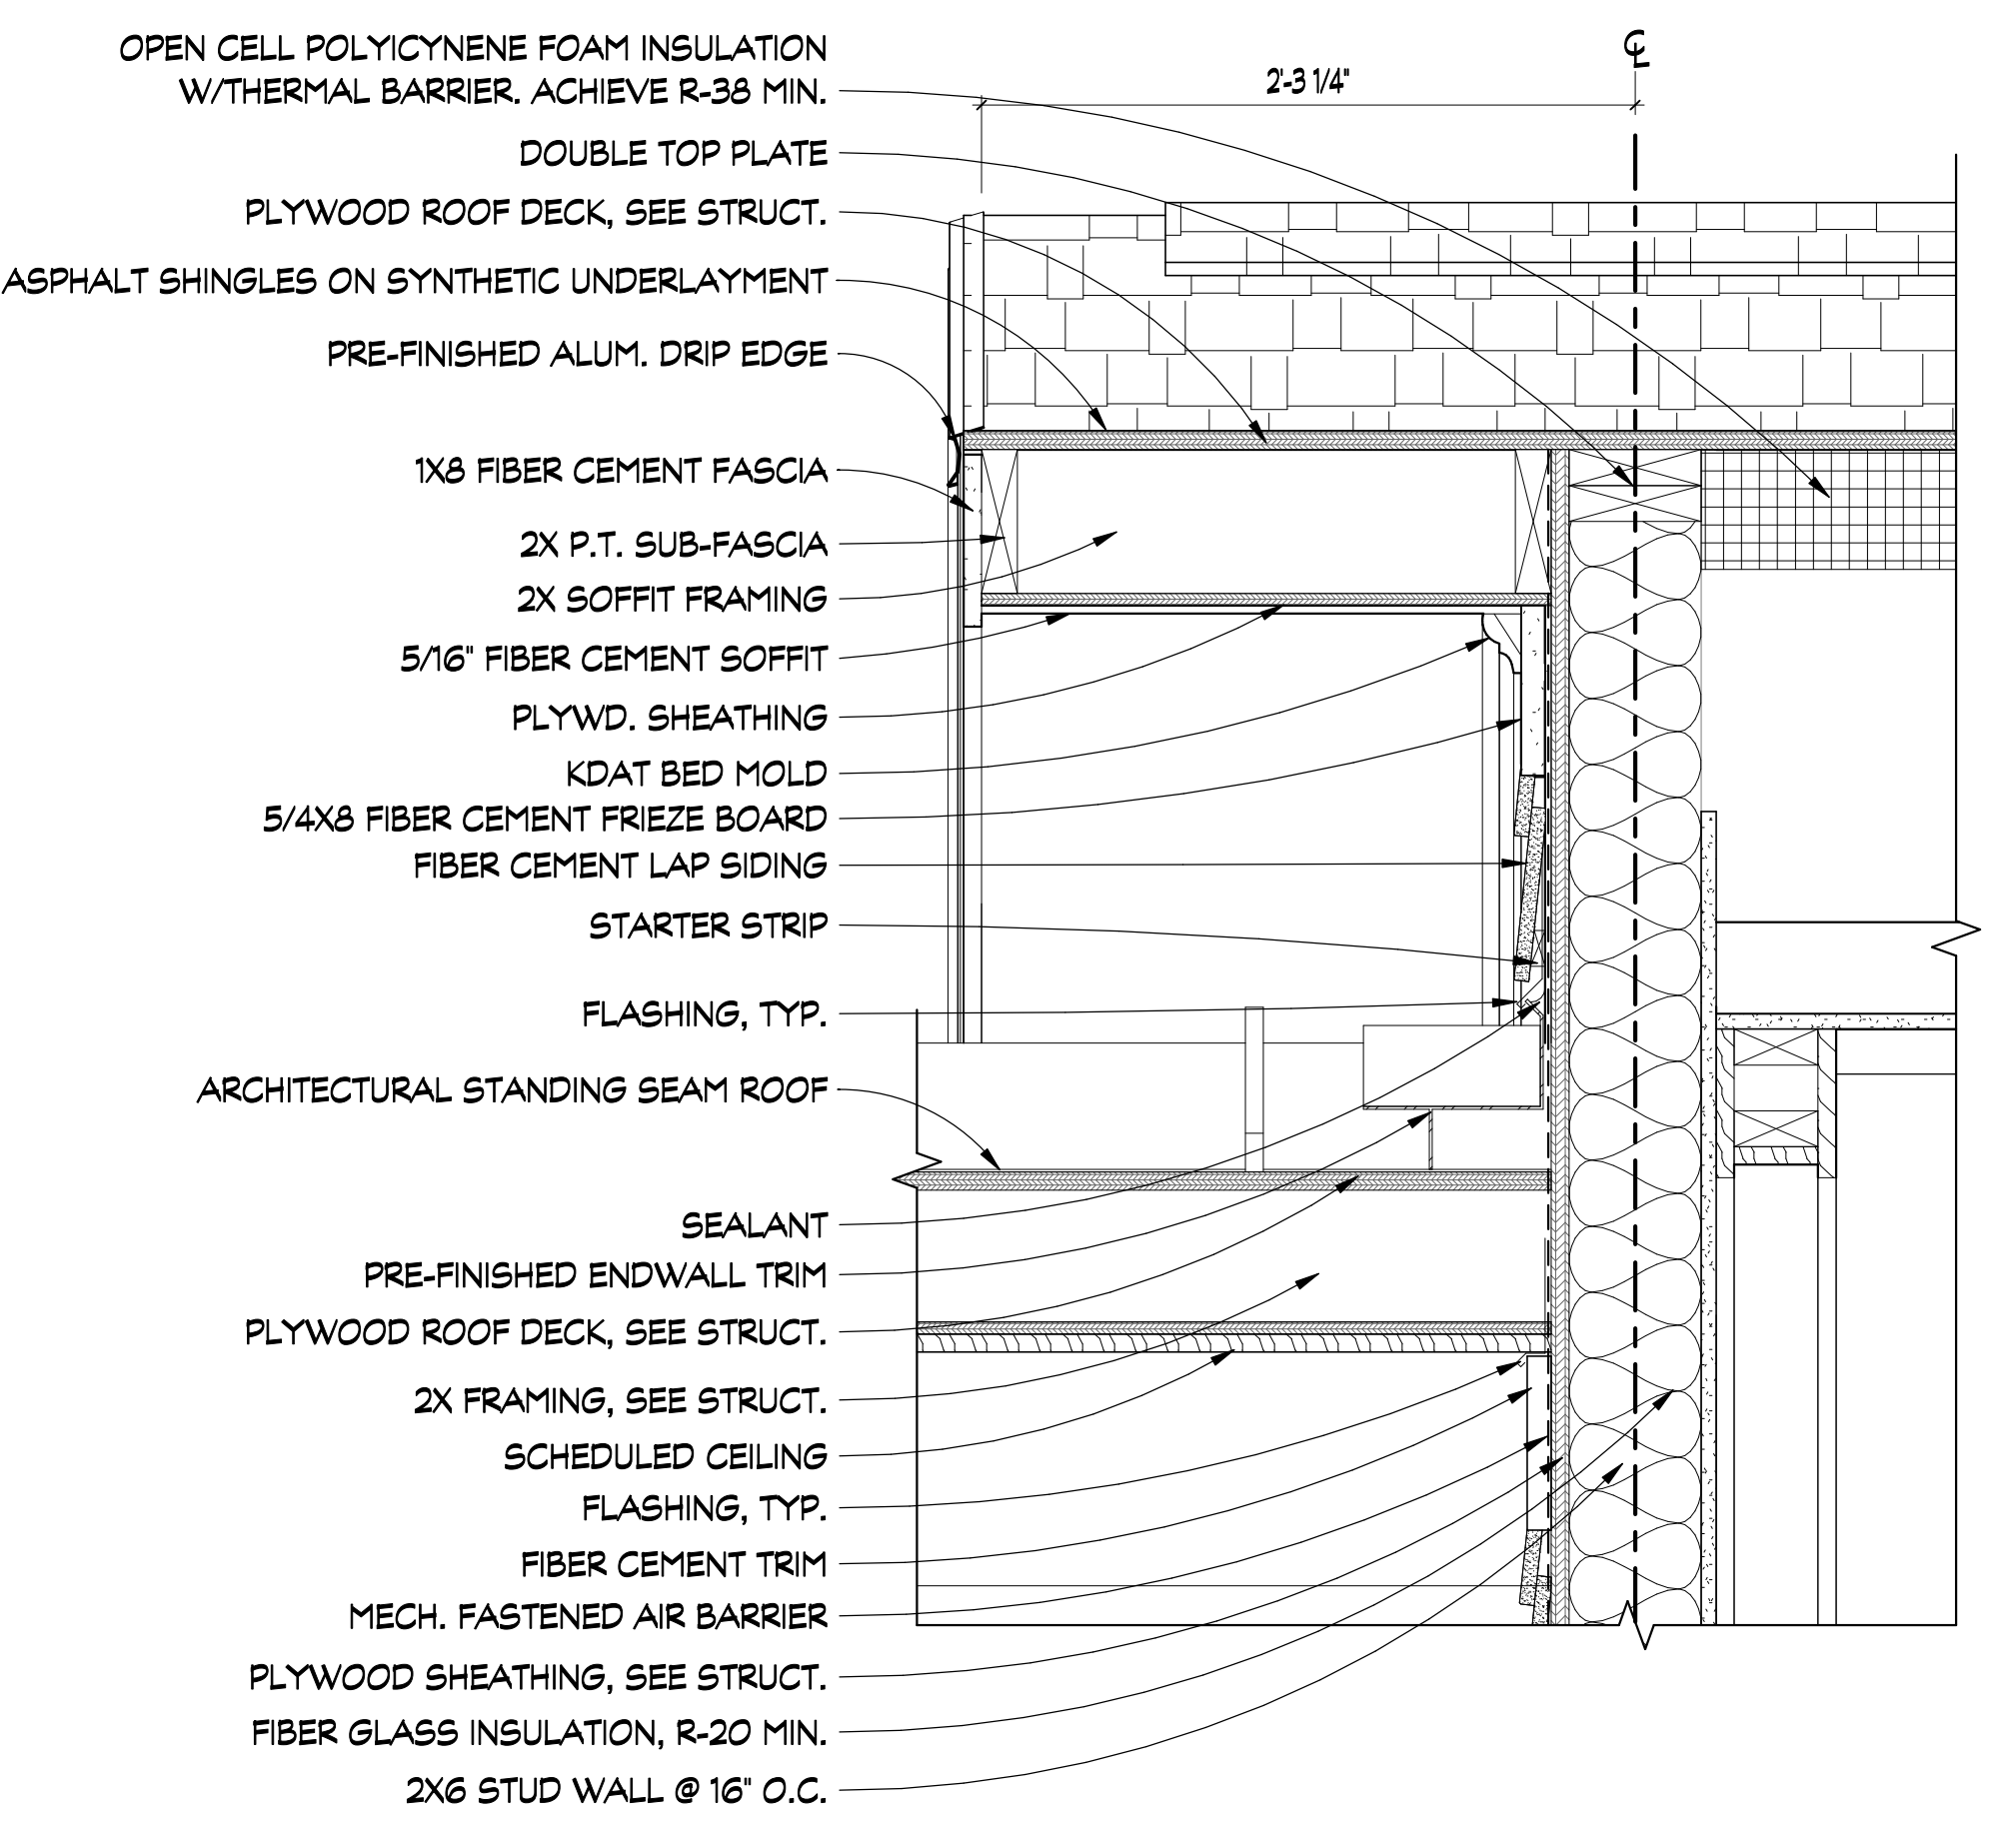


5 ROOF/FLASHING DETAIL
A302 SCALE: 1 1/2" = 1'-0"

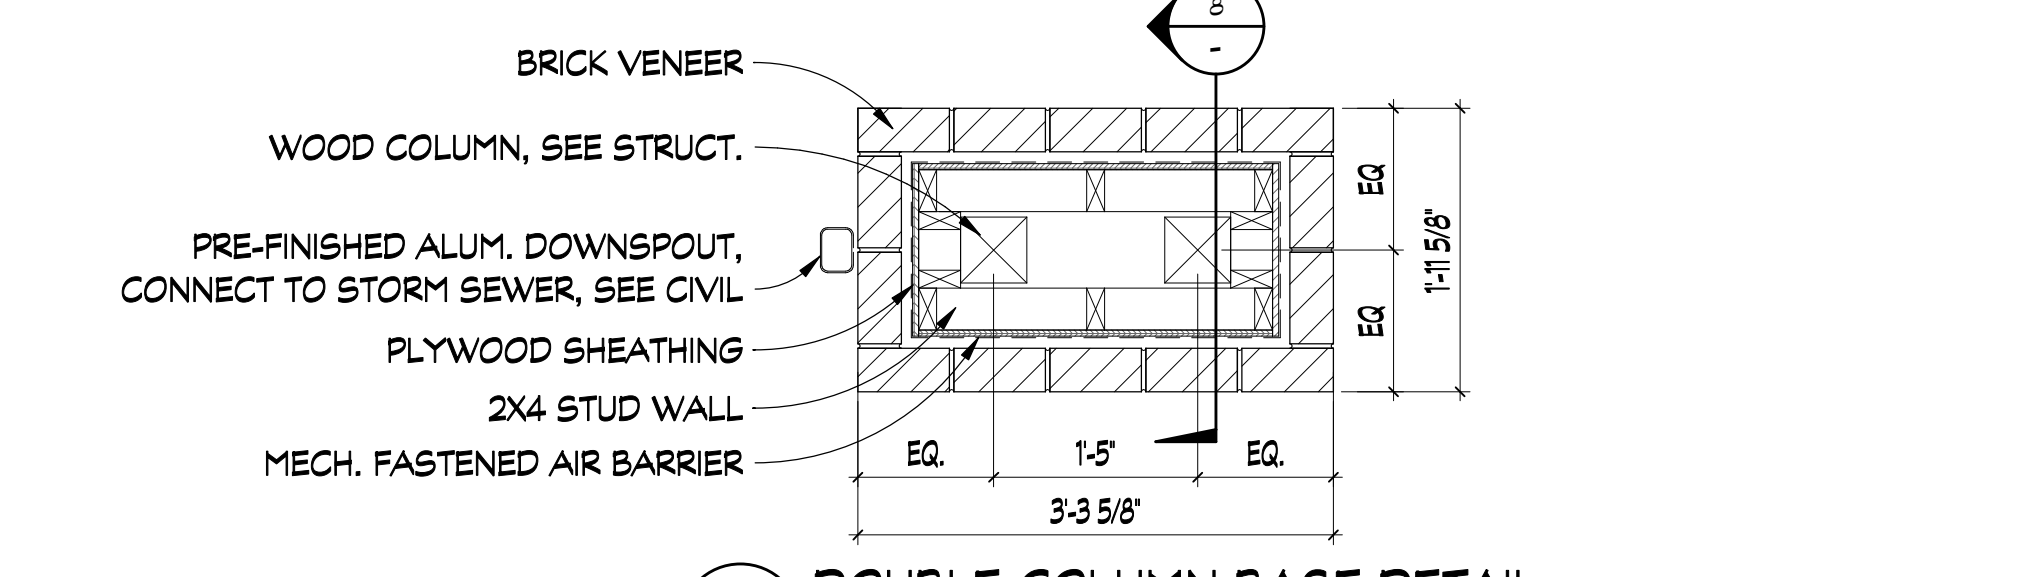


6 DOUBLE COLUMN BASE DETAIL
A102 SCALE: 3/4" = 1'-0"

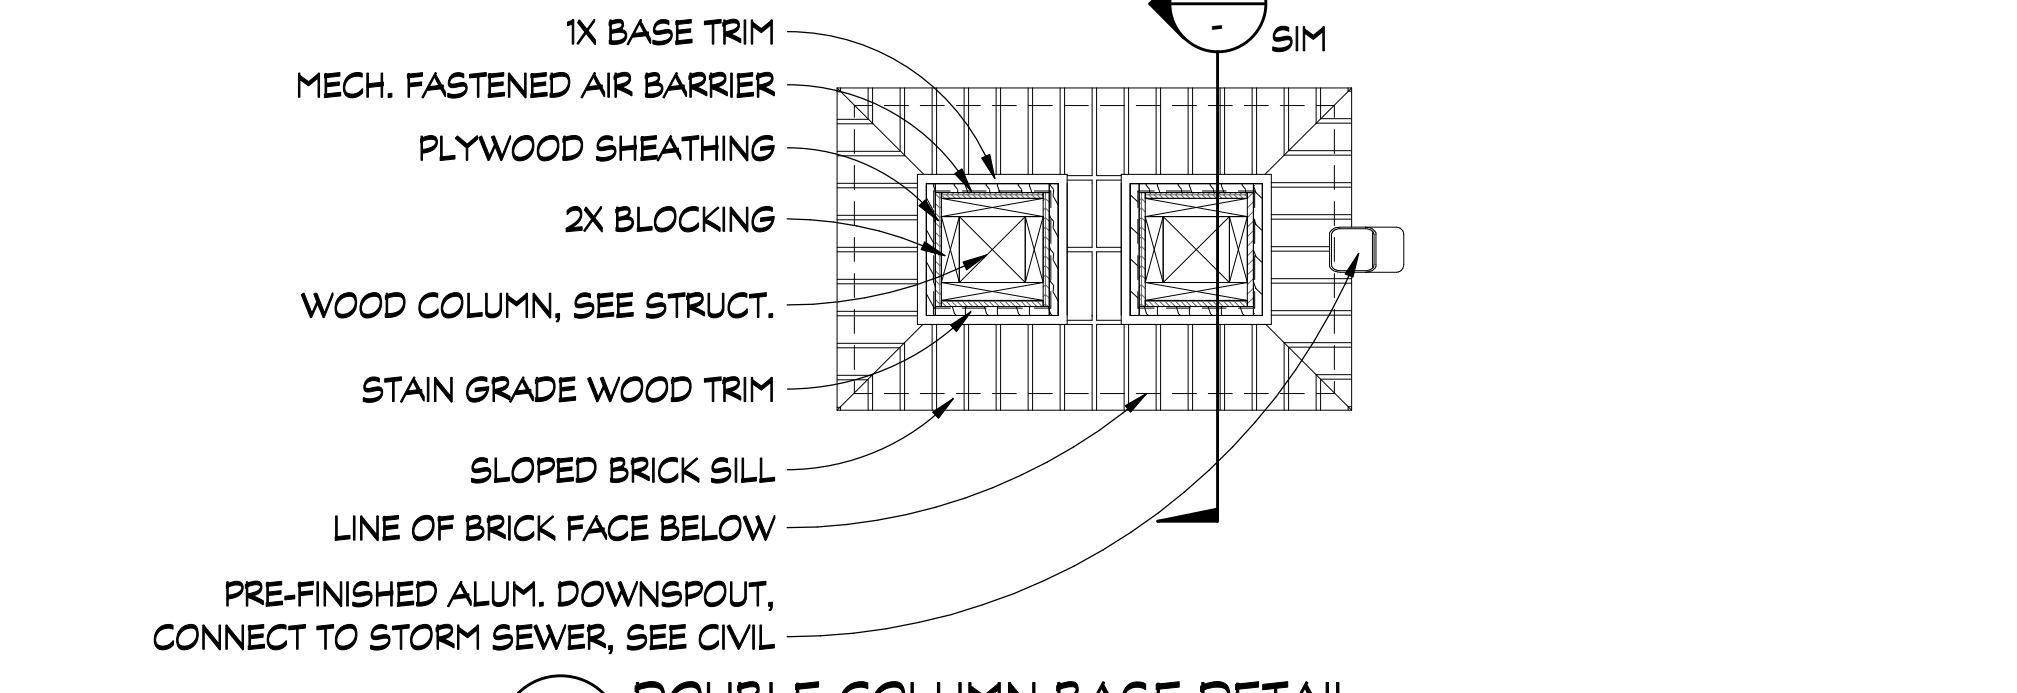


7 DOUBLE COLUMN BASE DETAIL
A102 SCALE: 3/4" = 1'-0"

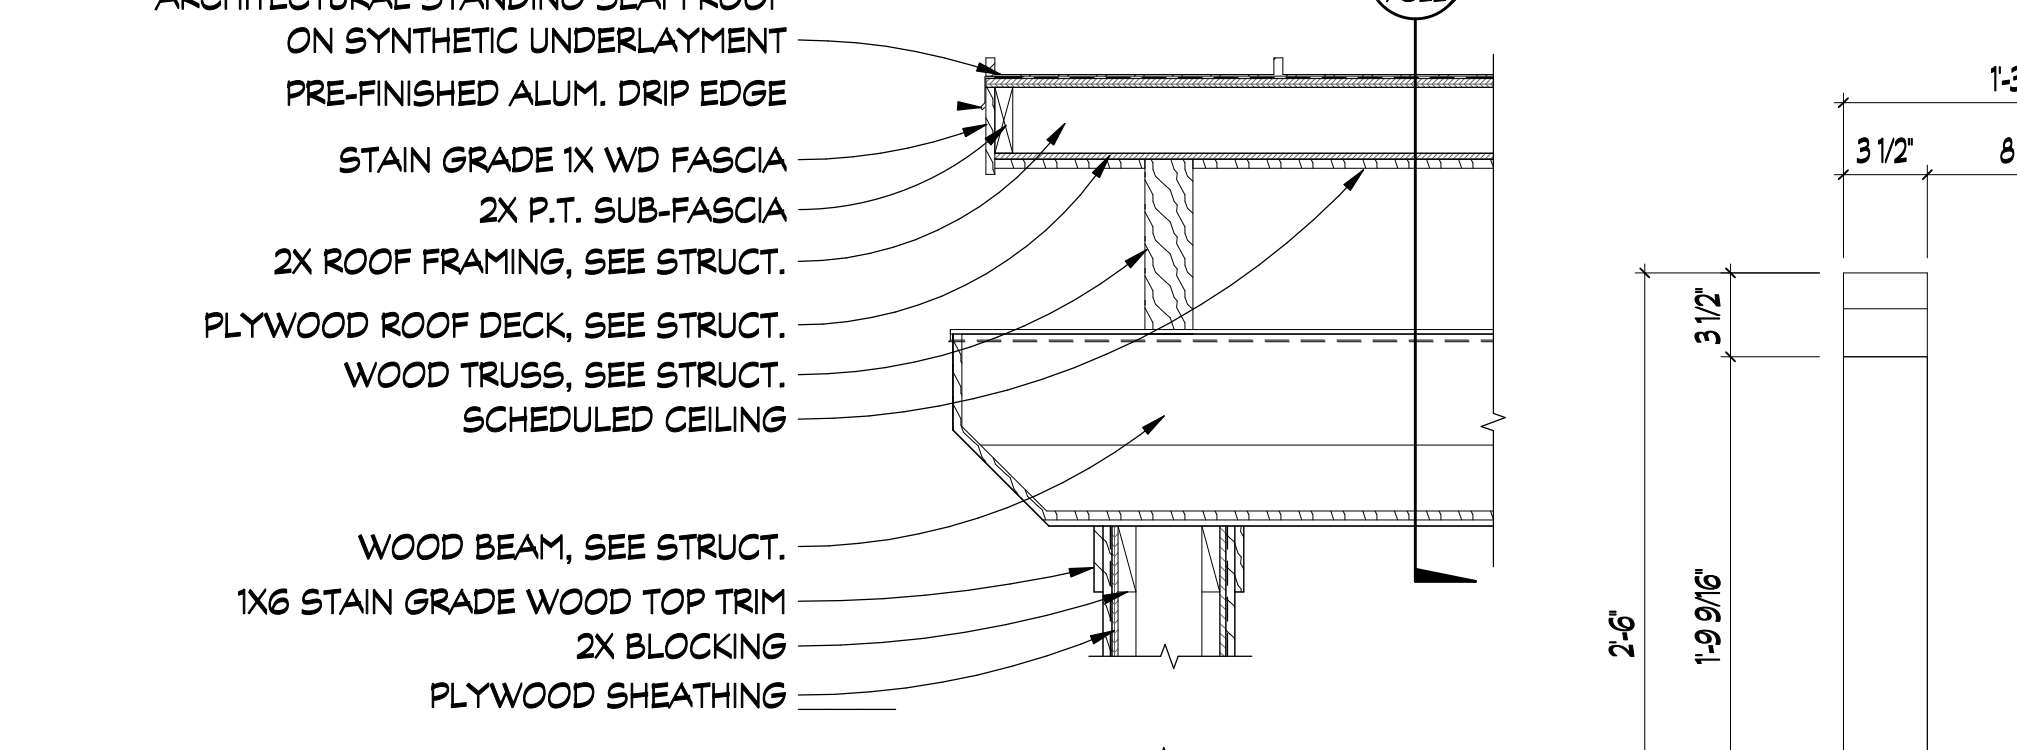


8 PORTE-COCHERE COLUMN SECTION
SCALE: 3/4" = 1'-0"

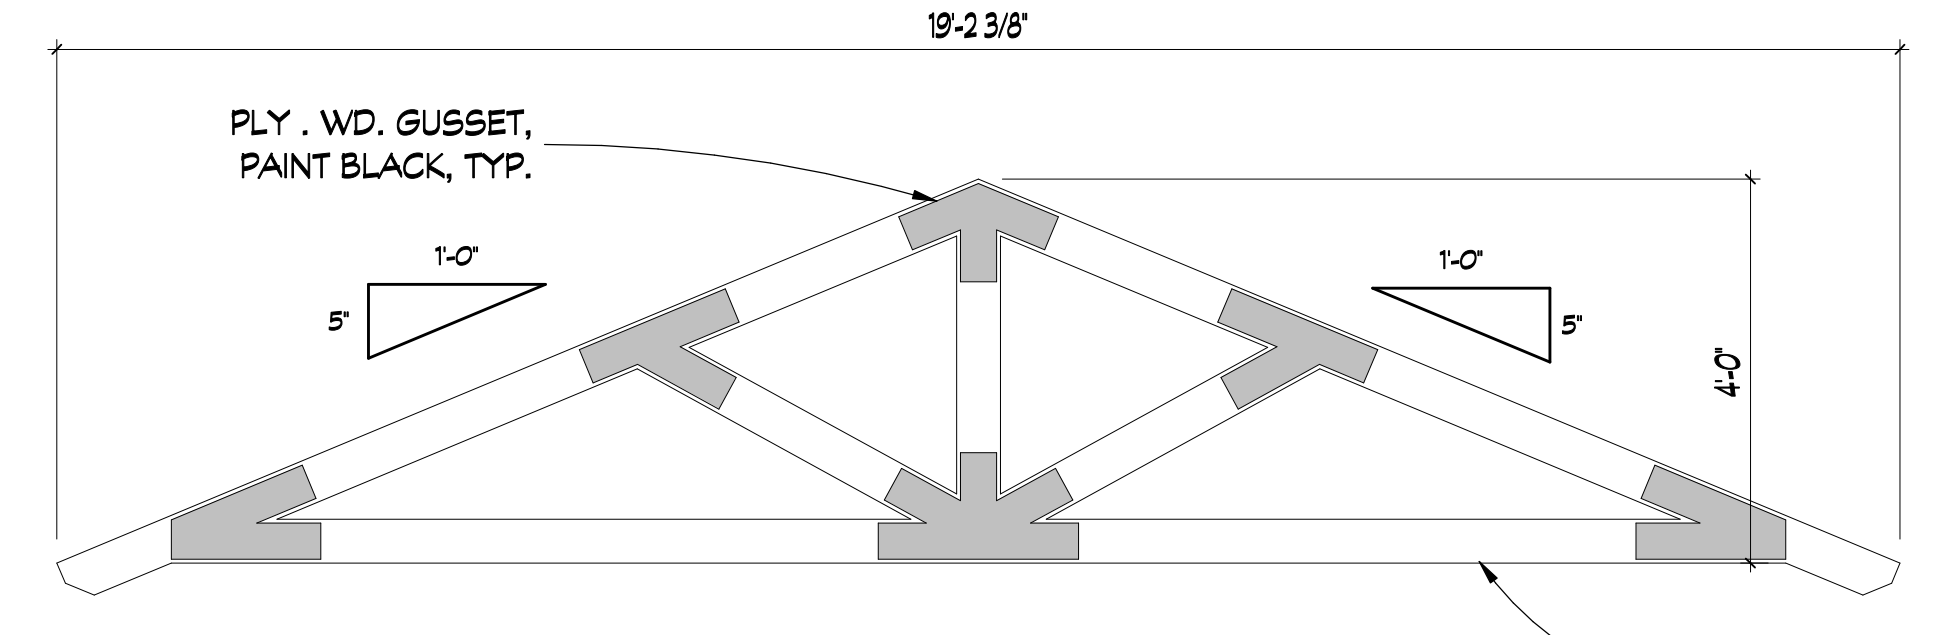


9 DECORATIVE GABLE TRUSS
A201 SCALE: 1/2" = 1'-0"

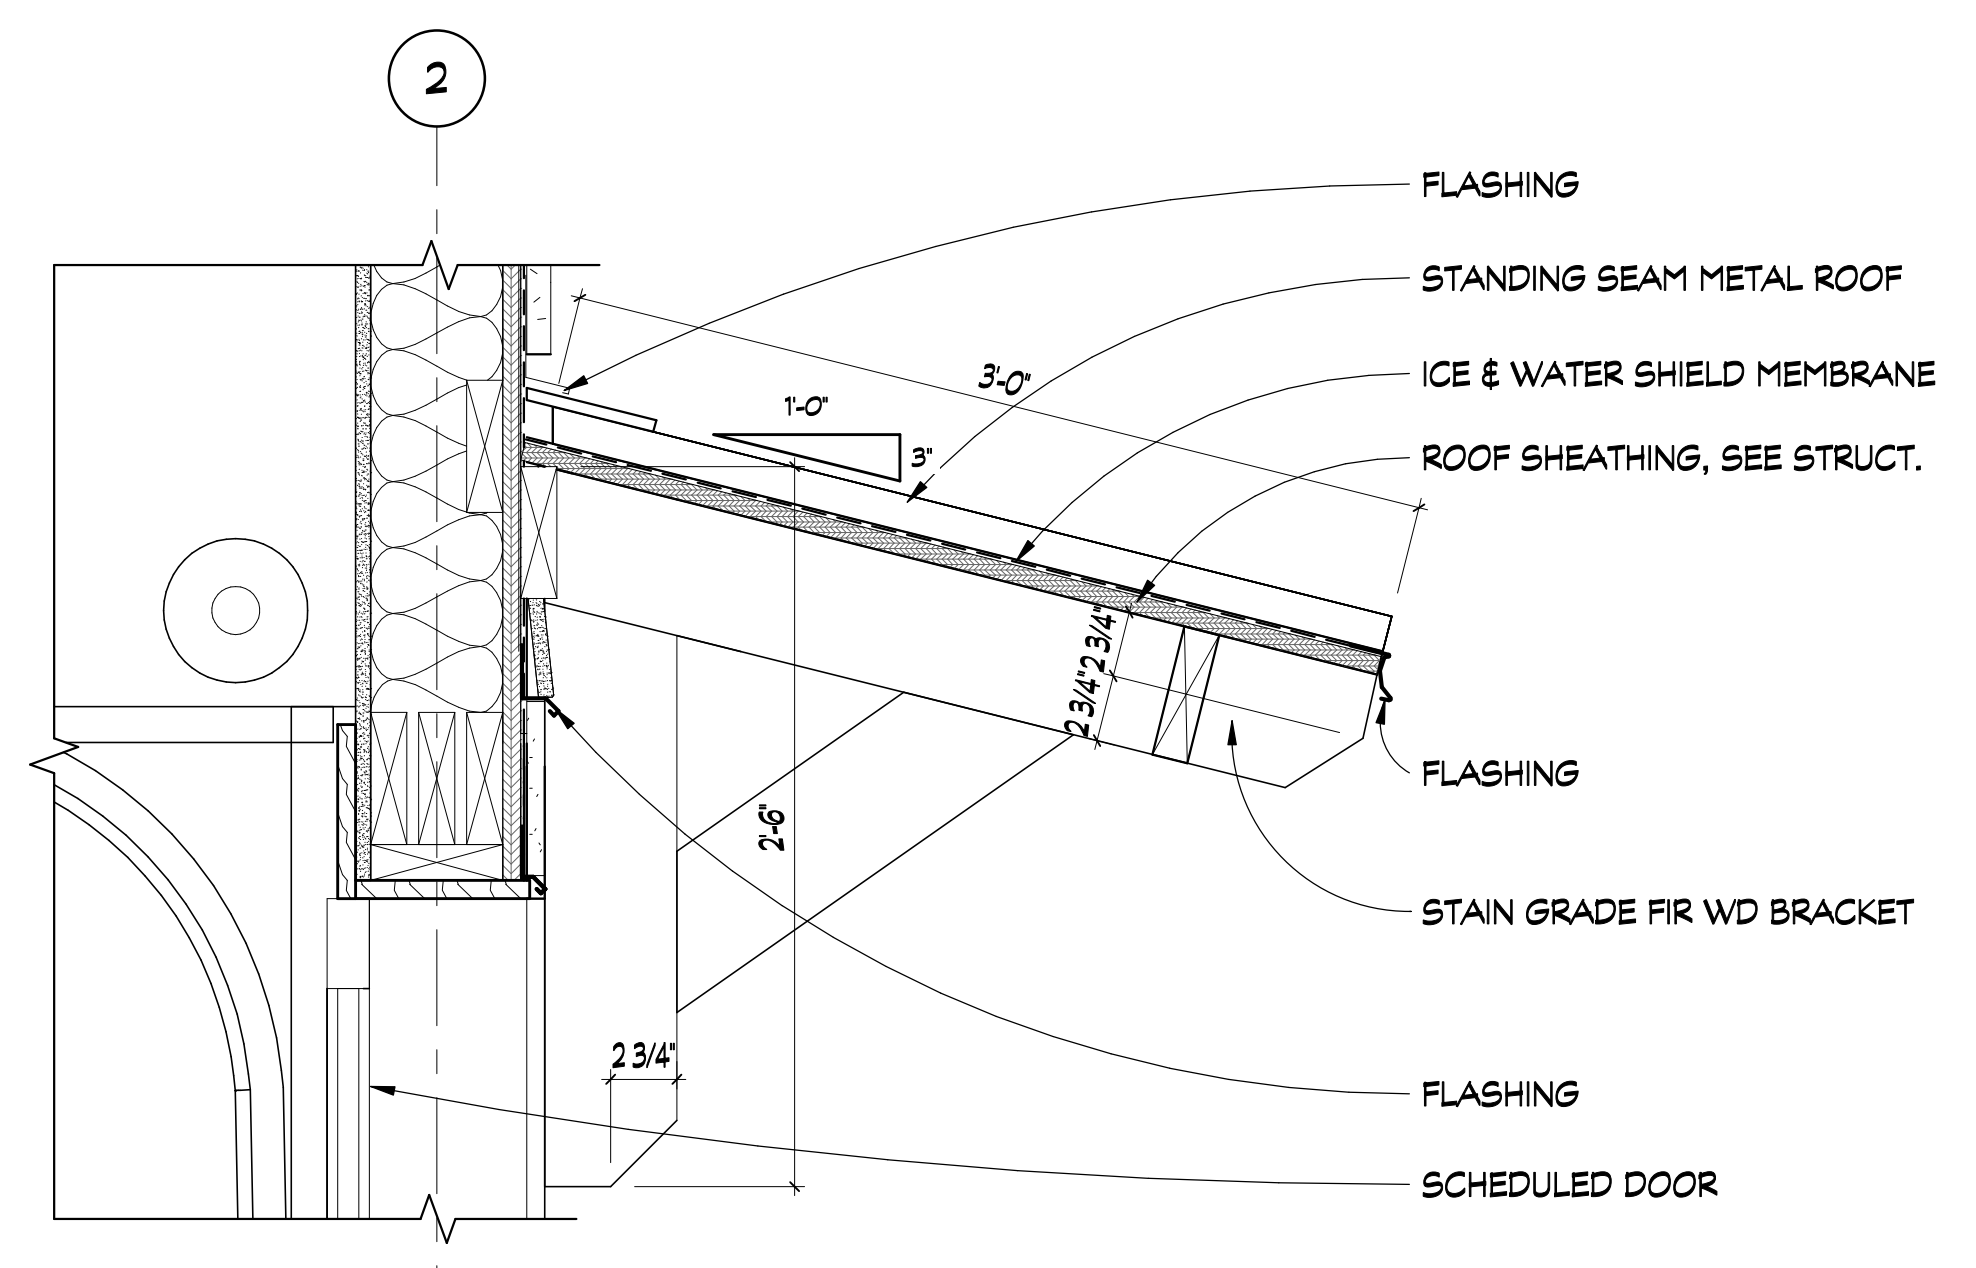


10 CANOPY DETAIL
A310 SCALE: 1 1/2" = 1'-0"

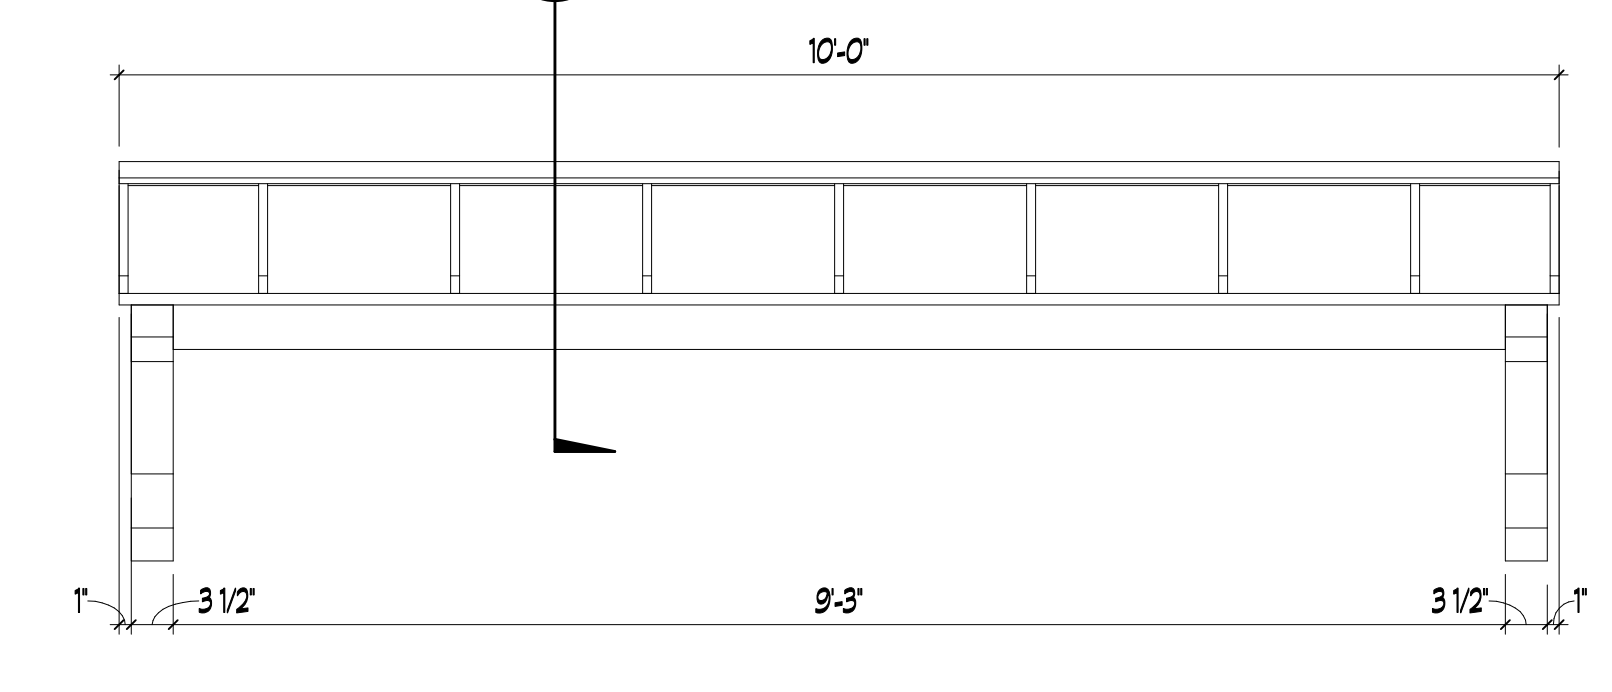

11 CANOPY ELEVATION
A201 SCALE: 3/4" = 1'-0"

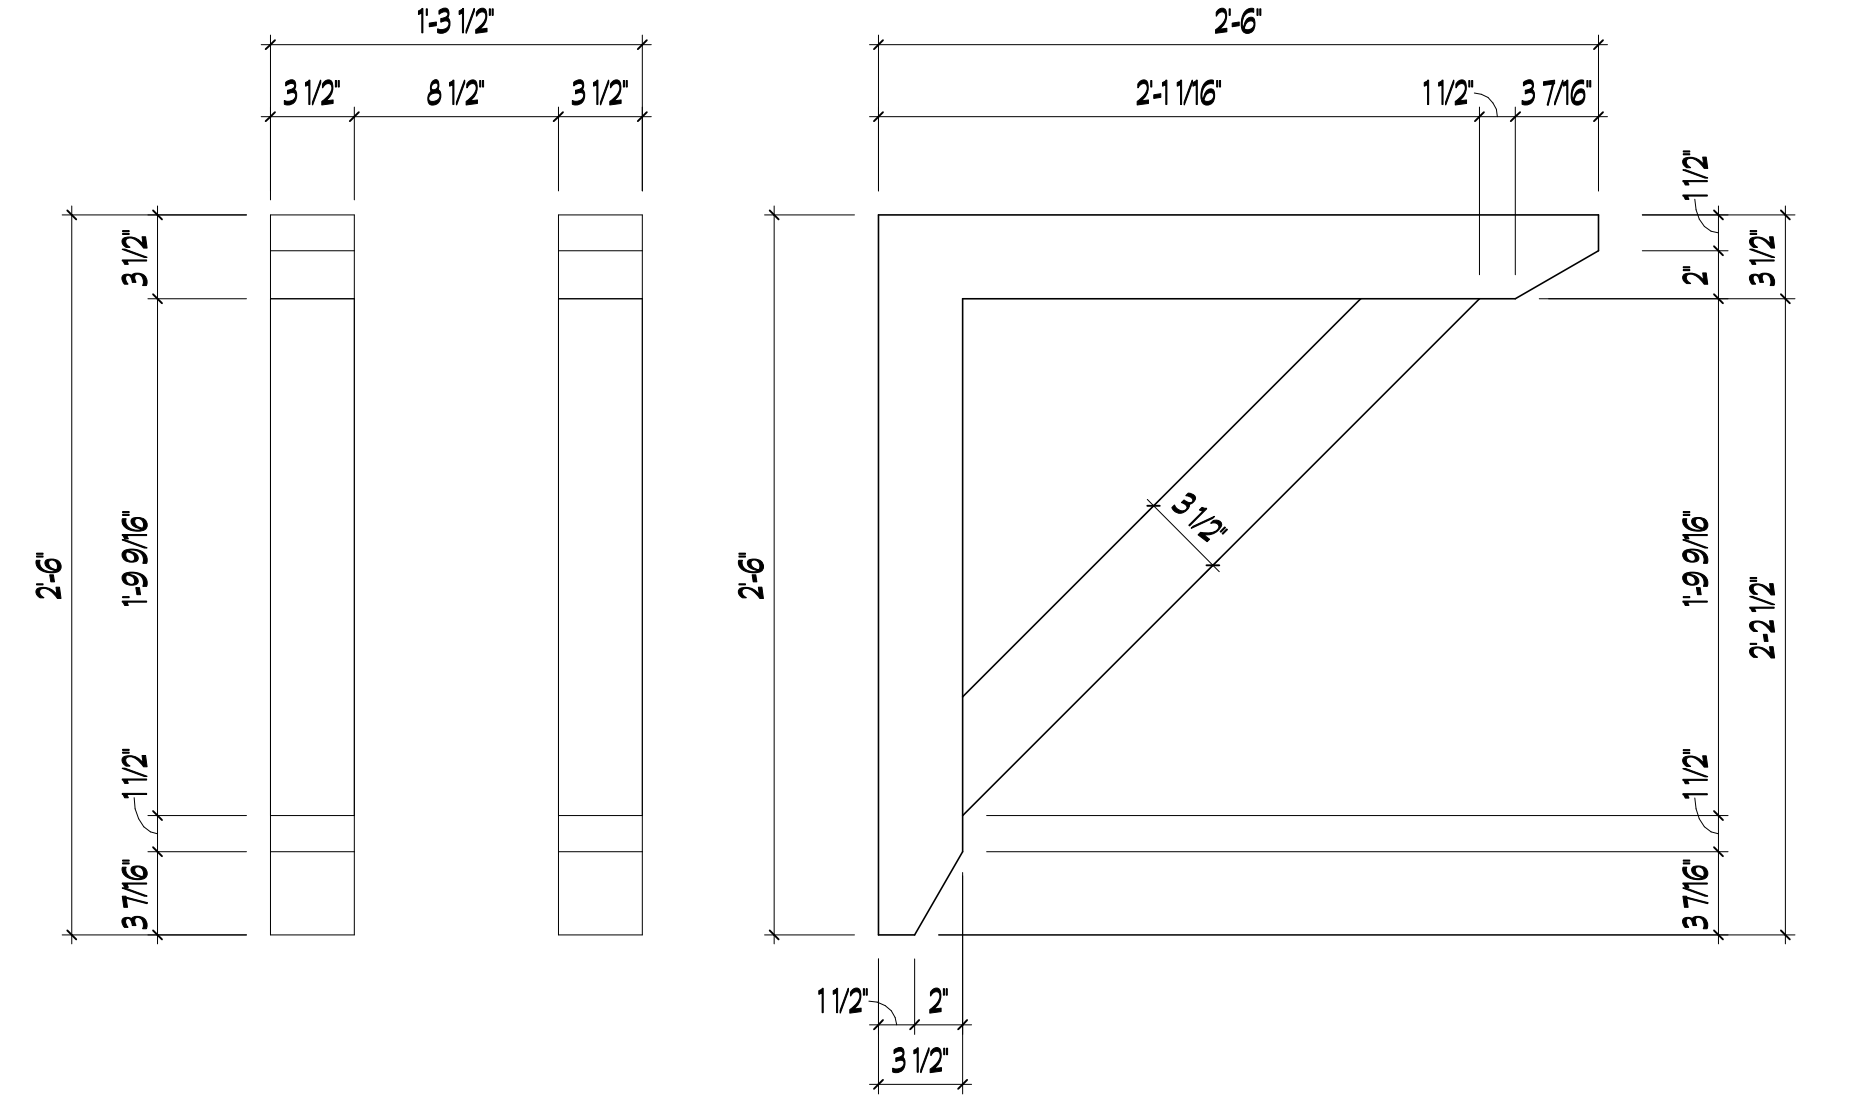


12 BRACKET 1 DETAIL
A201 SCALE: 1 1/2" = 1'-0"

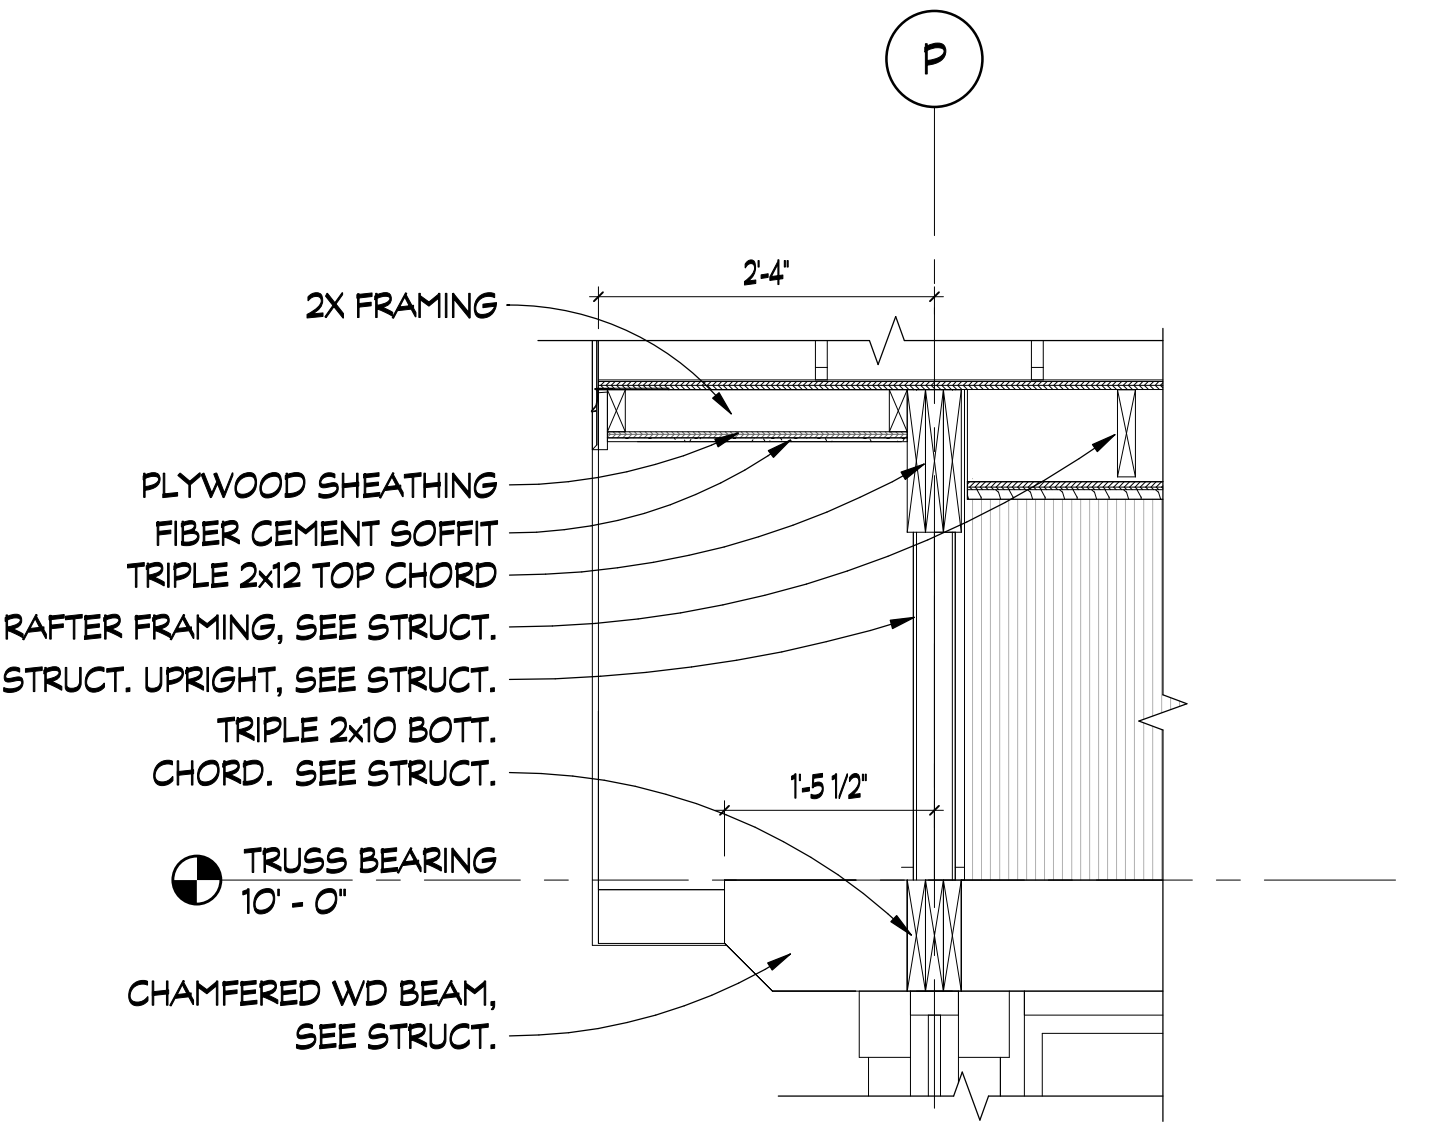



13 PORCH RAKE DETAIL
A303 SCALE: 3/4" = 1'-0"

NOTES:
1. BUILD FROM STAIN GRADE FIR
2. SEE ELEVATIONS FOR SINGLE V. DOUBLE BRACKET LOCATIONS

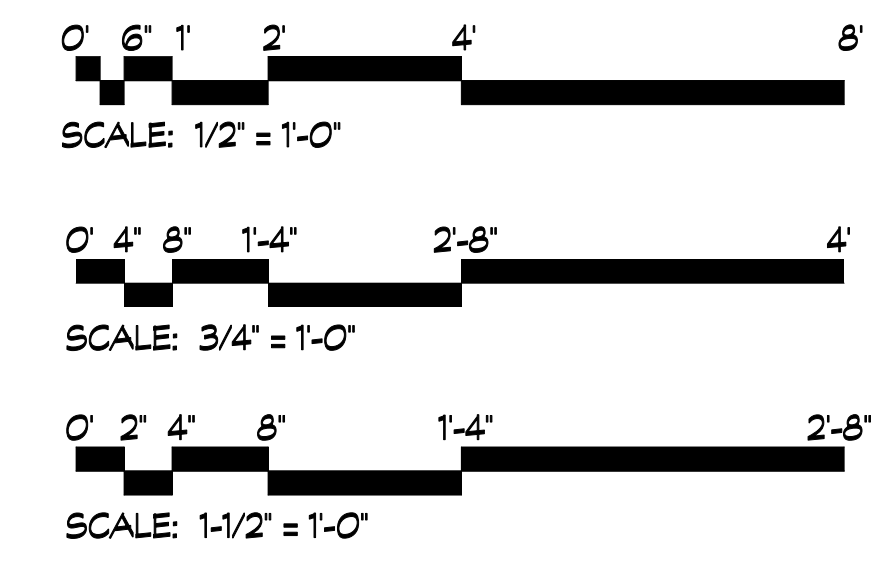


REVISIONS				
REV #	DATE	APPROV	BY	REVISION
1	2/16/22	EA		ISSUE FOR PERMIT

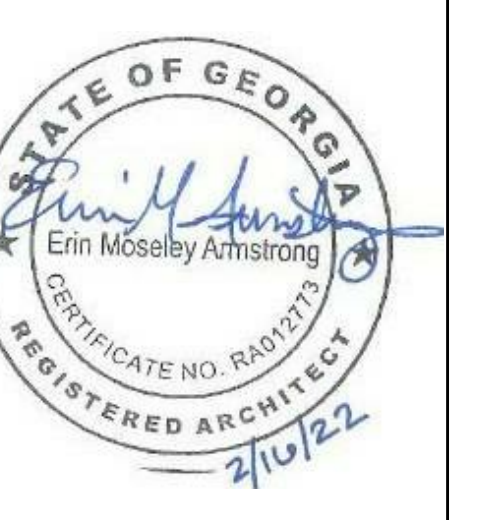


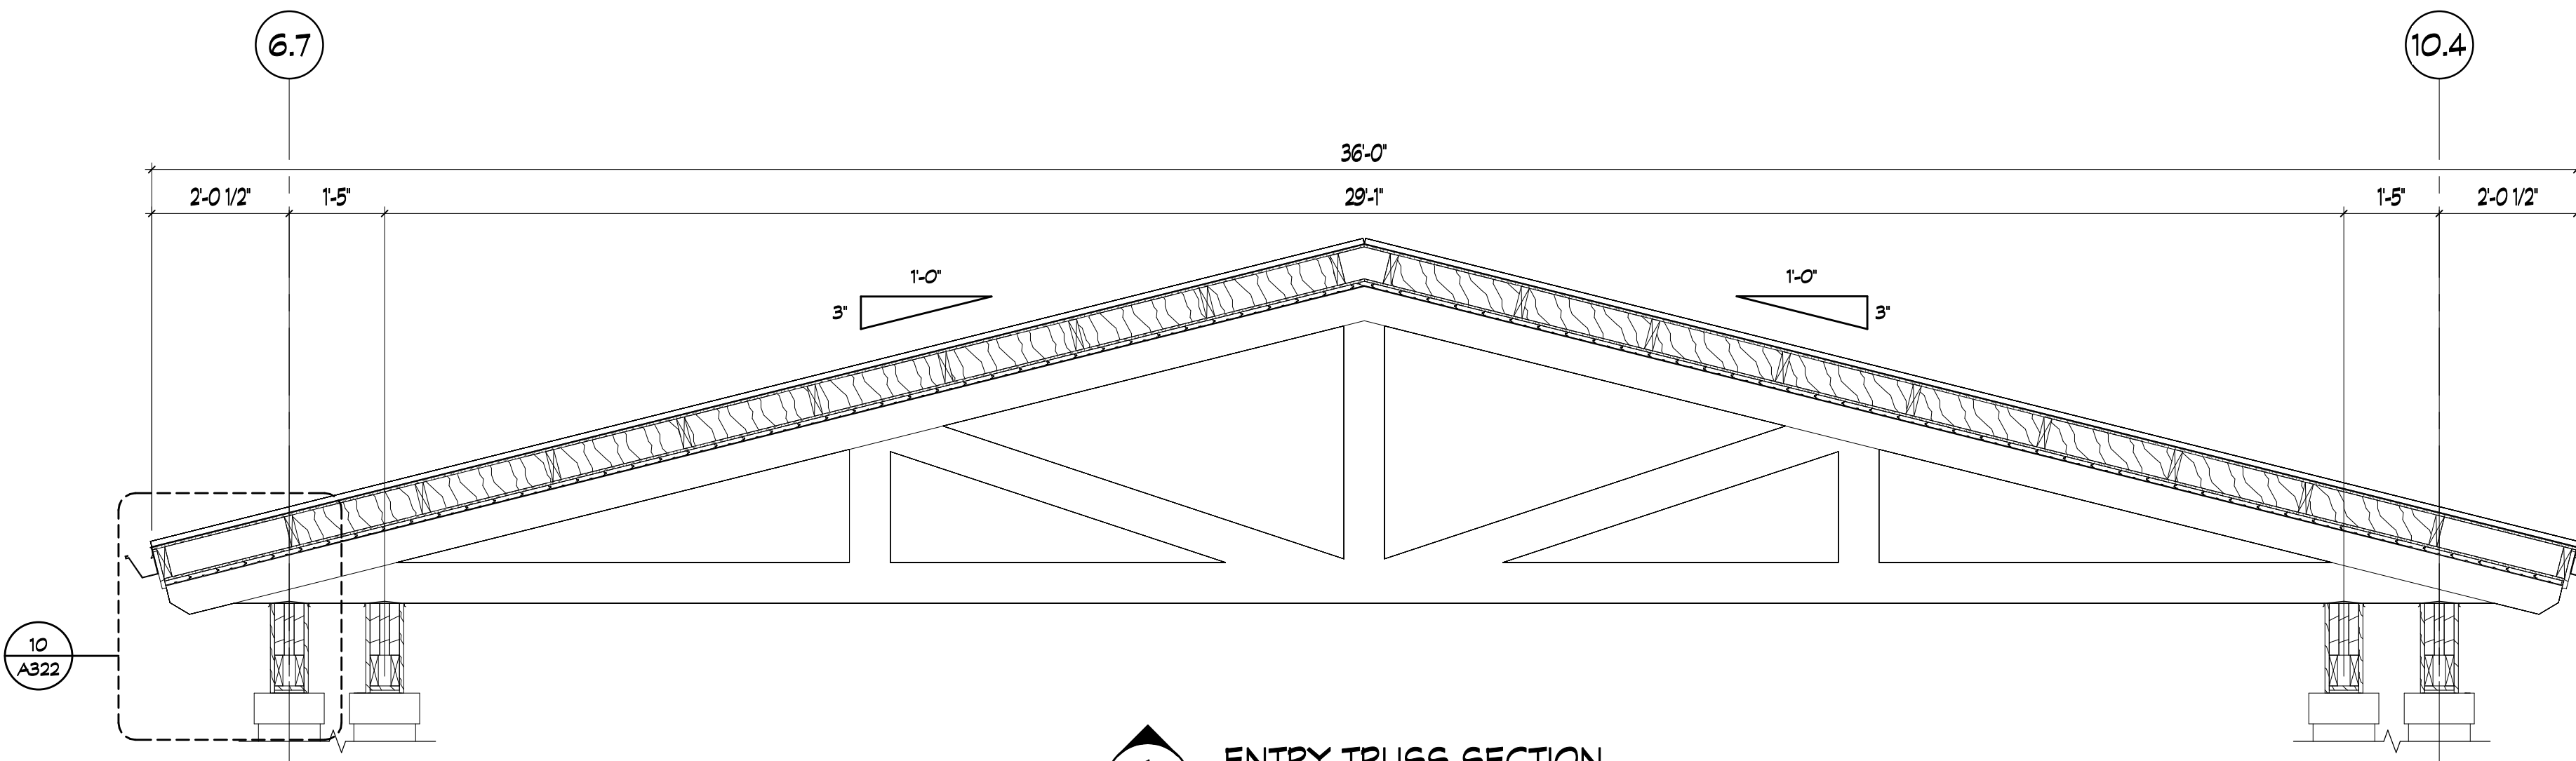

1 ENTRY TRUSS SECTION
SCALE: 1/2" = 1'-0"

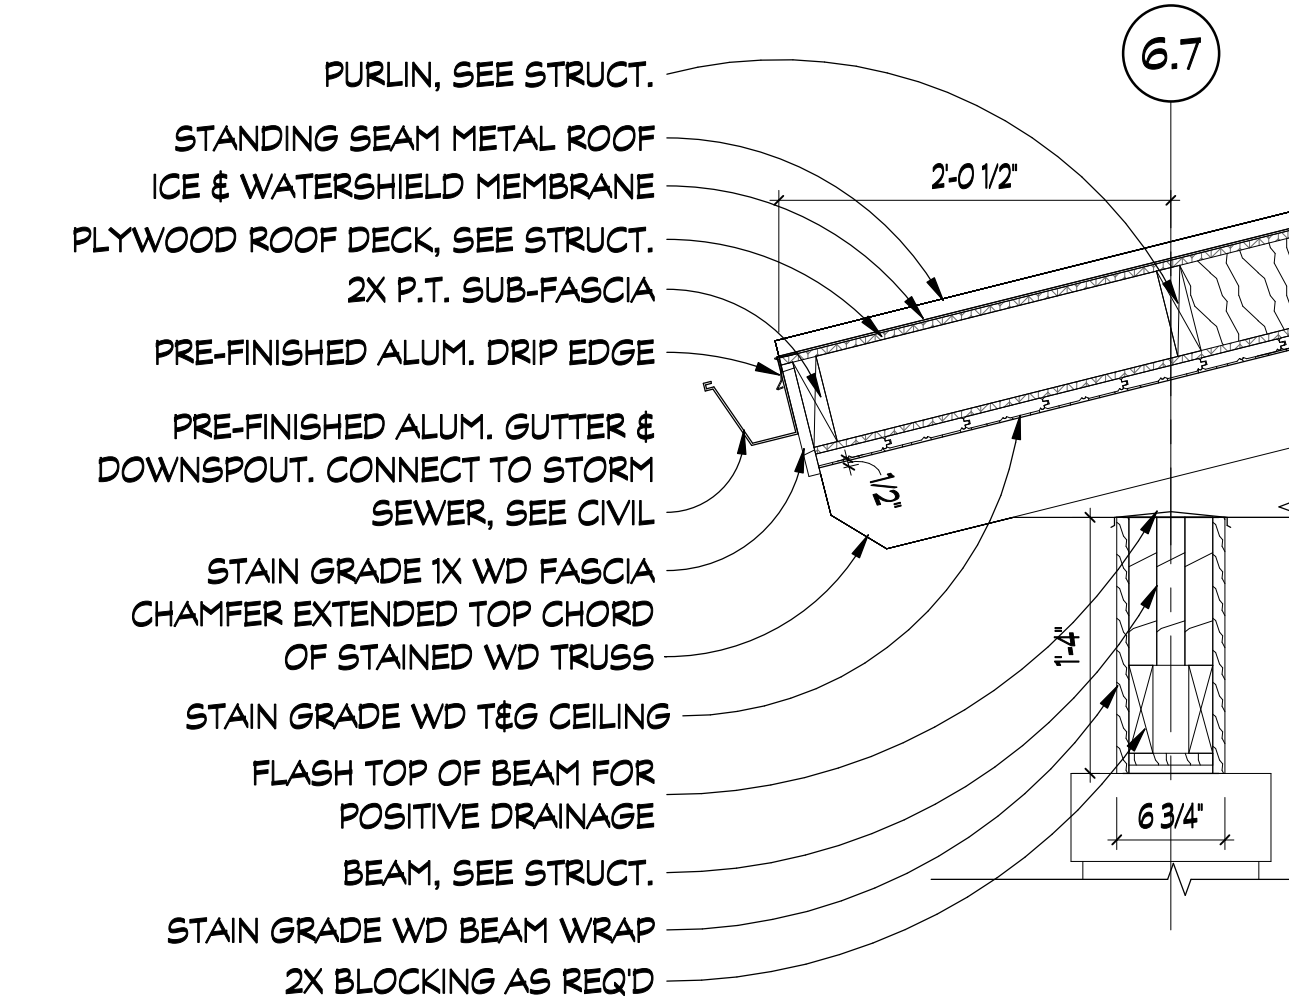


10 BEAM AND EAVE DETAIL
SCALE: 1" = 1'-0"

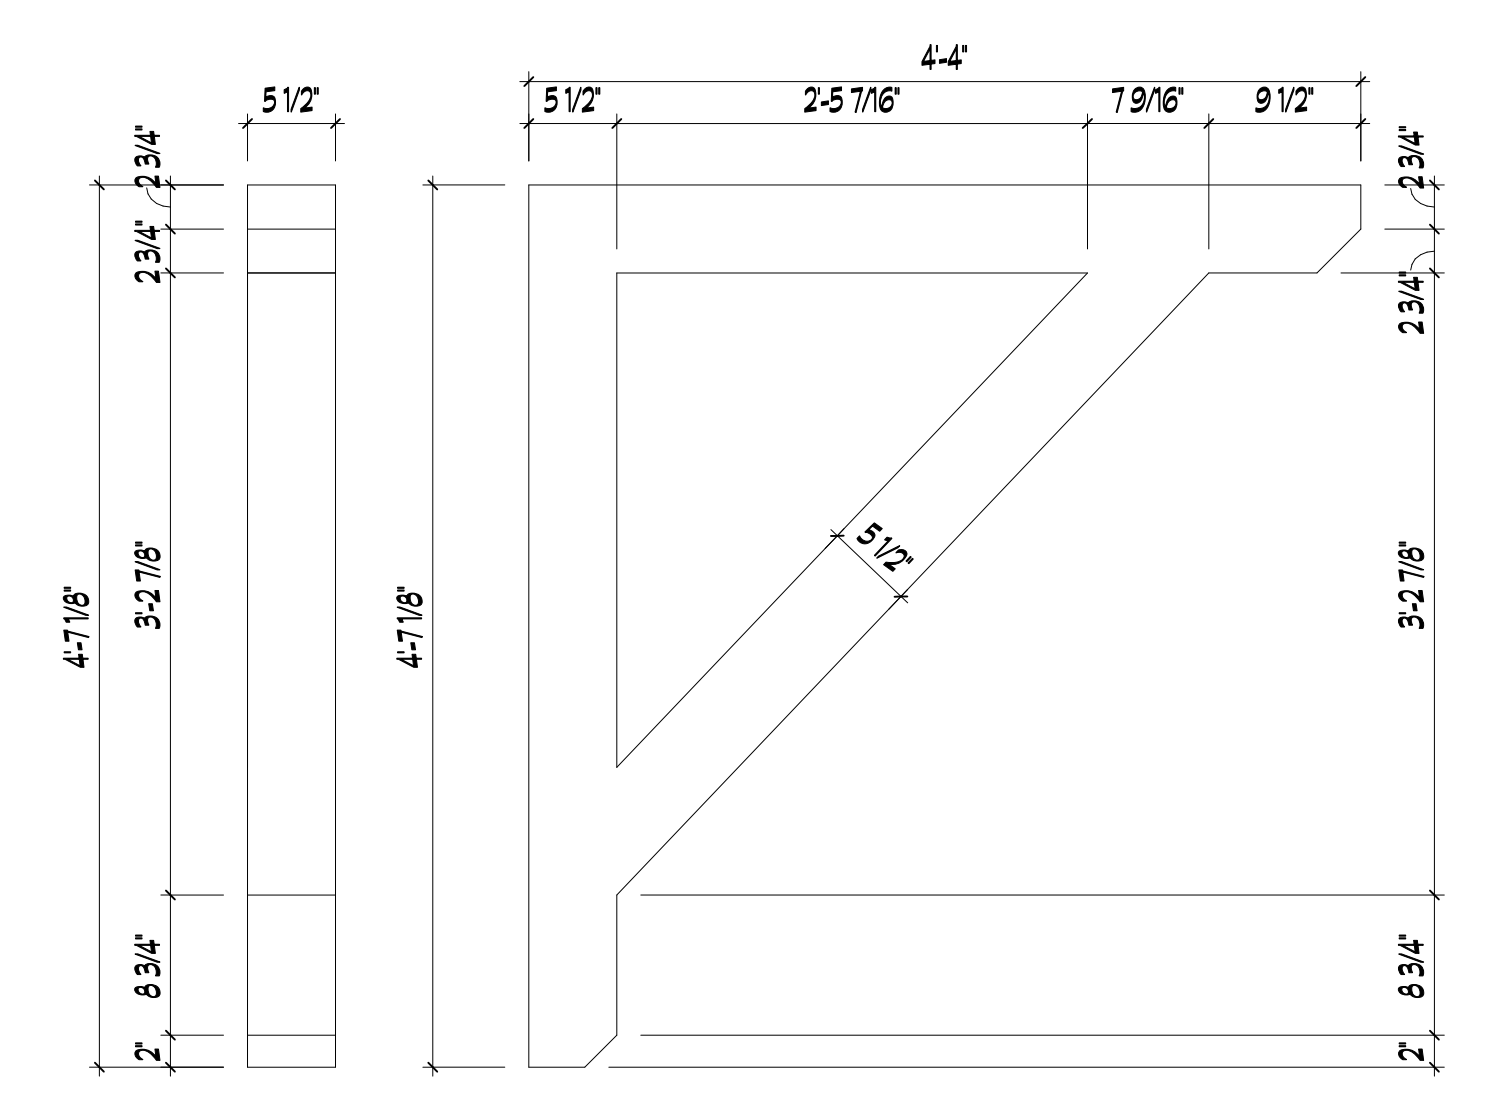


6 BRACKET 2 DETAIL
SCALE: 1" = 1'-0"


NOTES:
1. BUILD FROM STAIN GRADE FIR

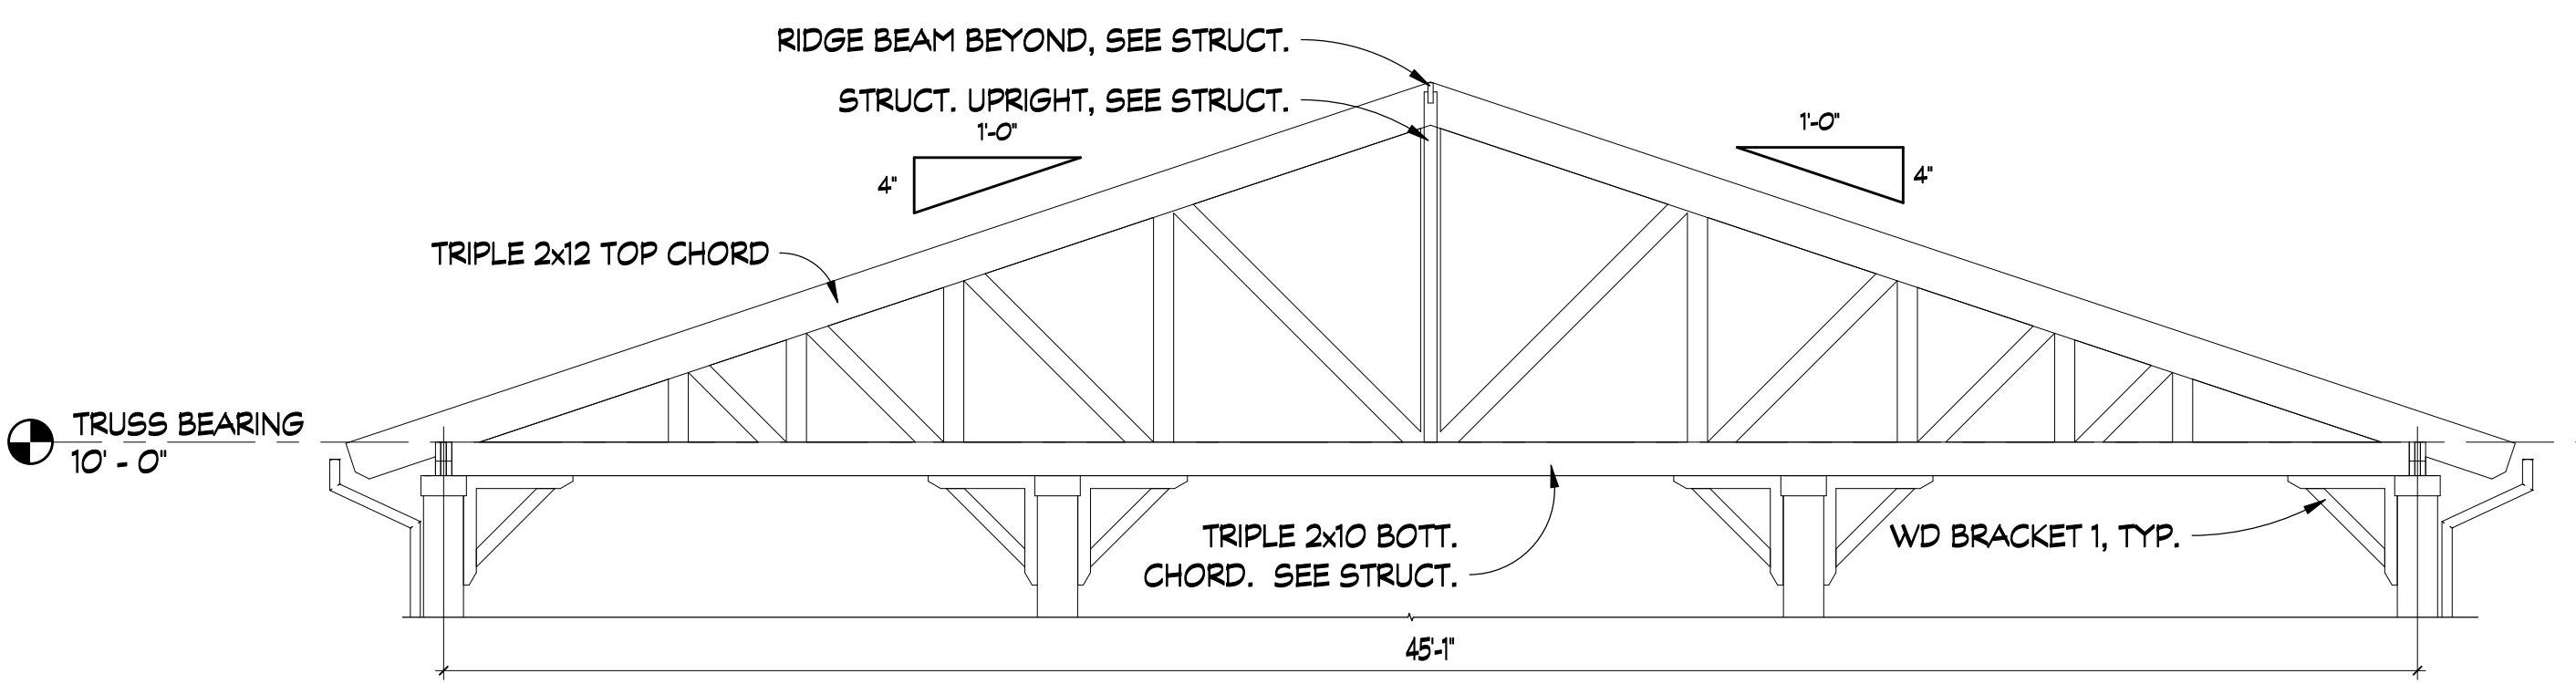


2 TRUSS ELEVATION
SCALE: 1/4" = 1'-0"

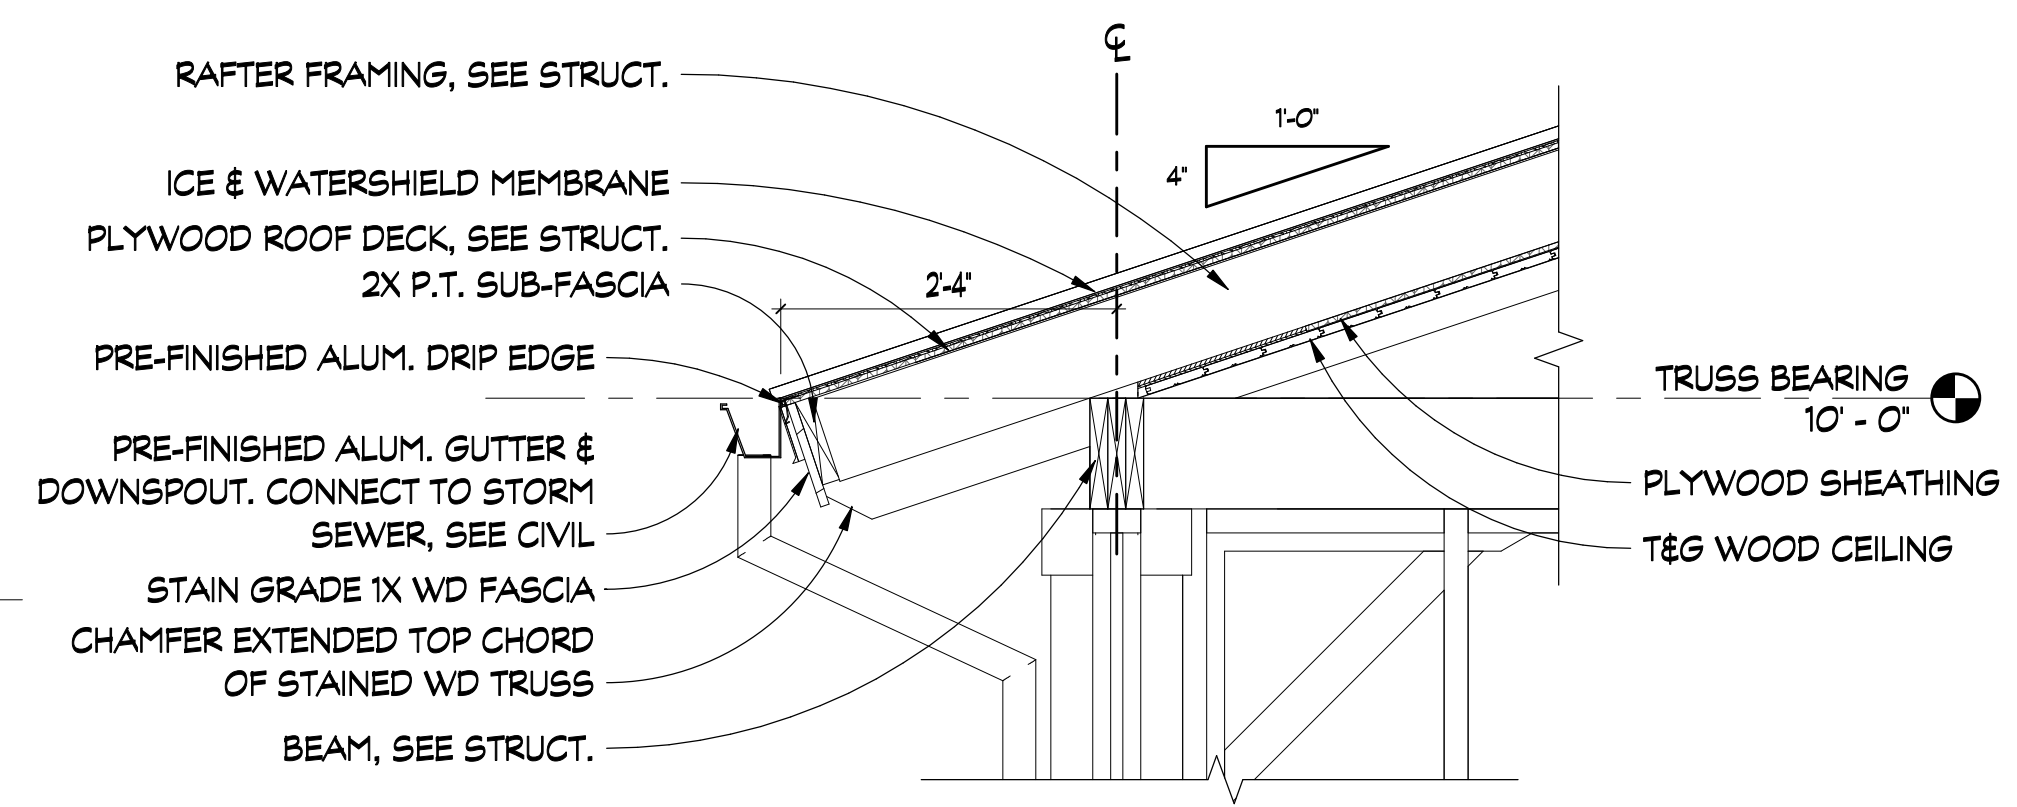


11 BEAM AND EAVE DETAIL
SCALE: 3/4" = 1'-0"

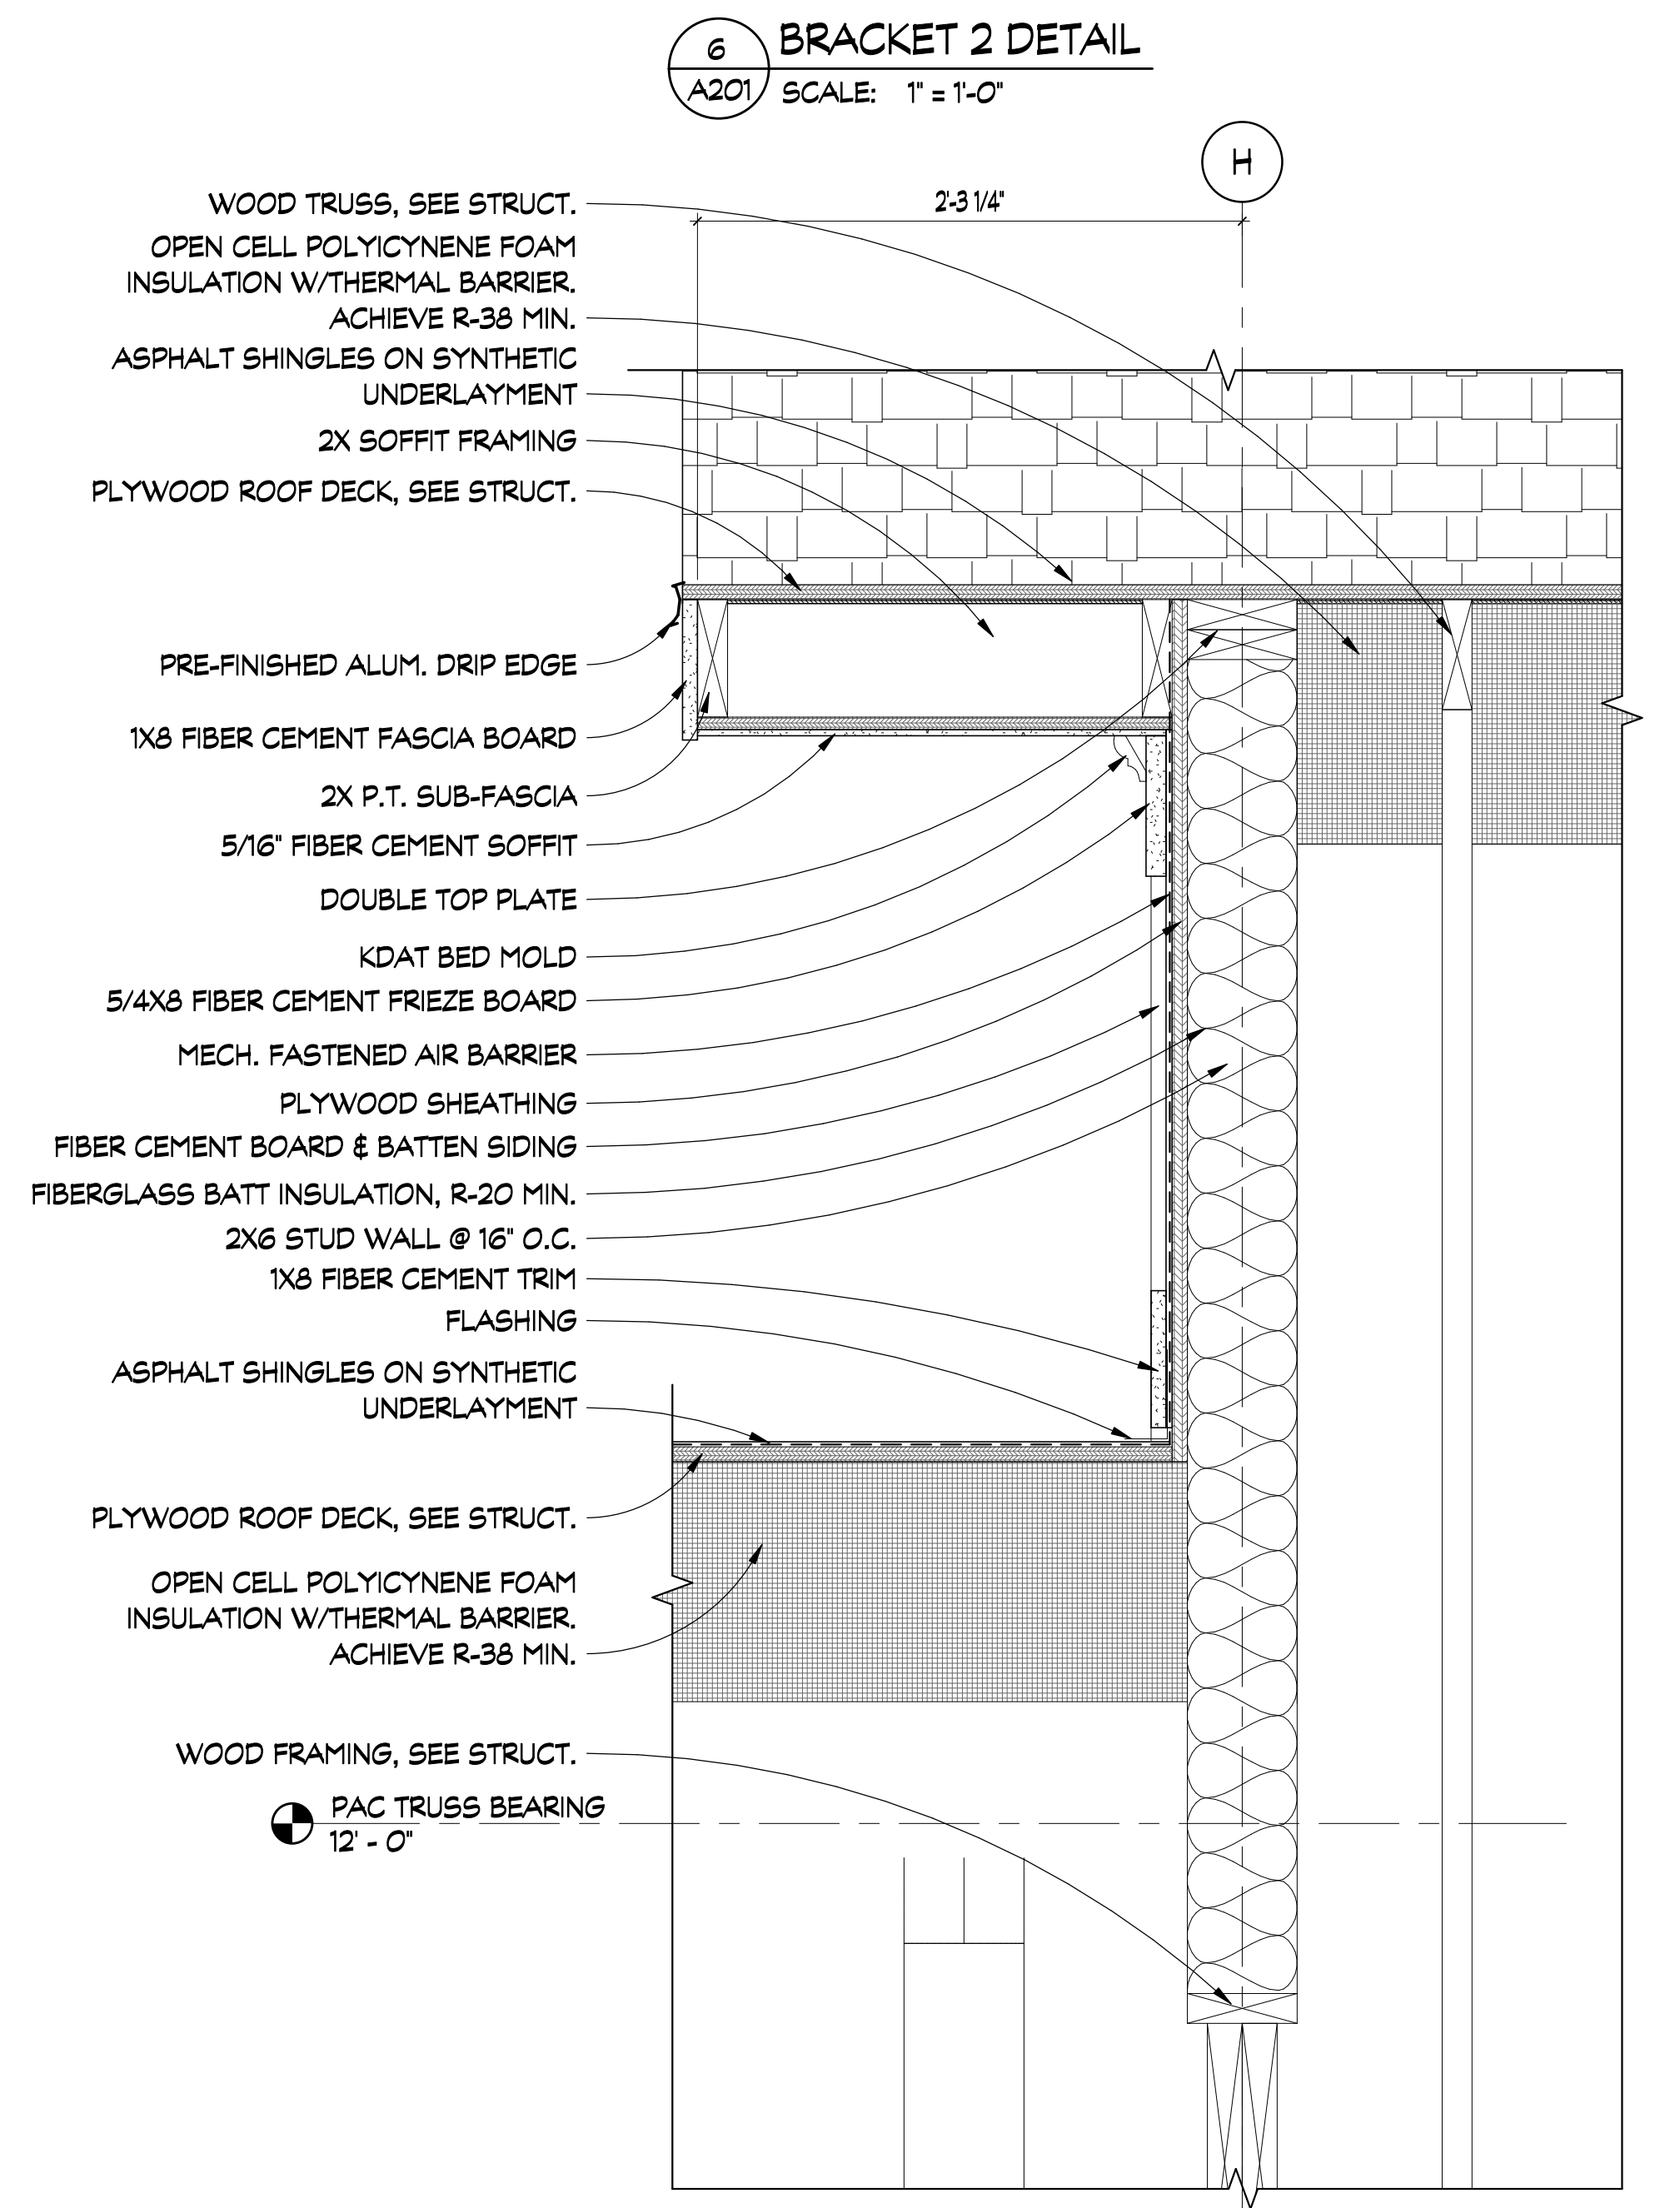


5 ROOF ENDWALL DETAIL
SCALE: 1 1/2" = 1'-0"

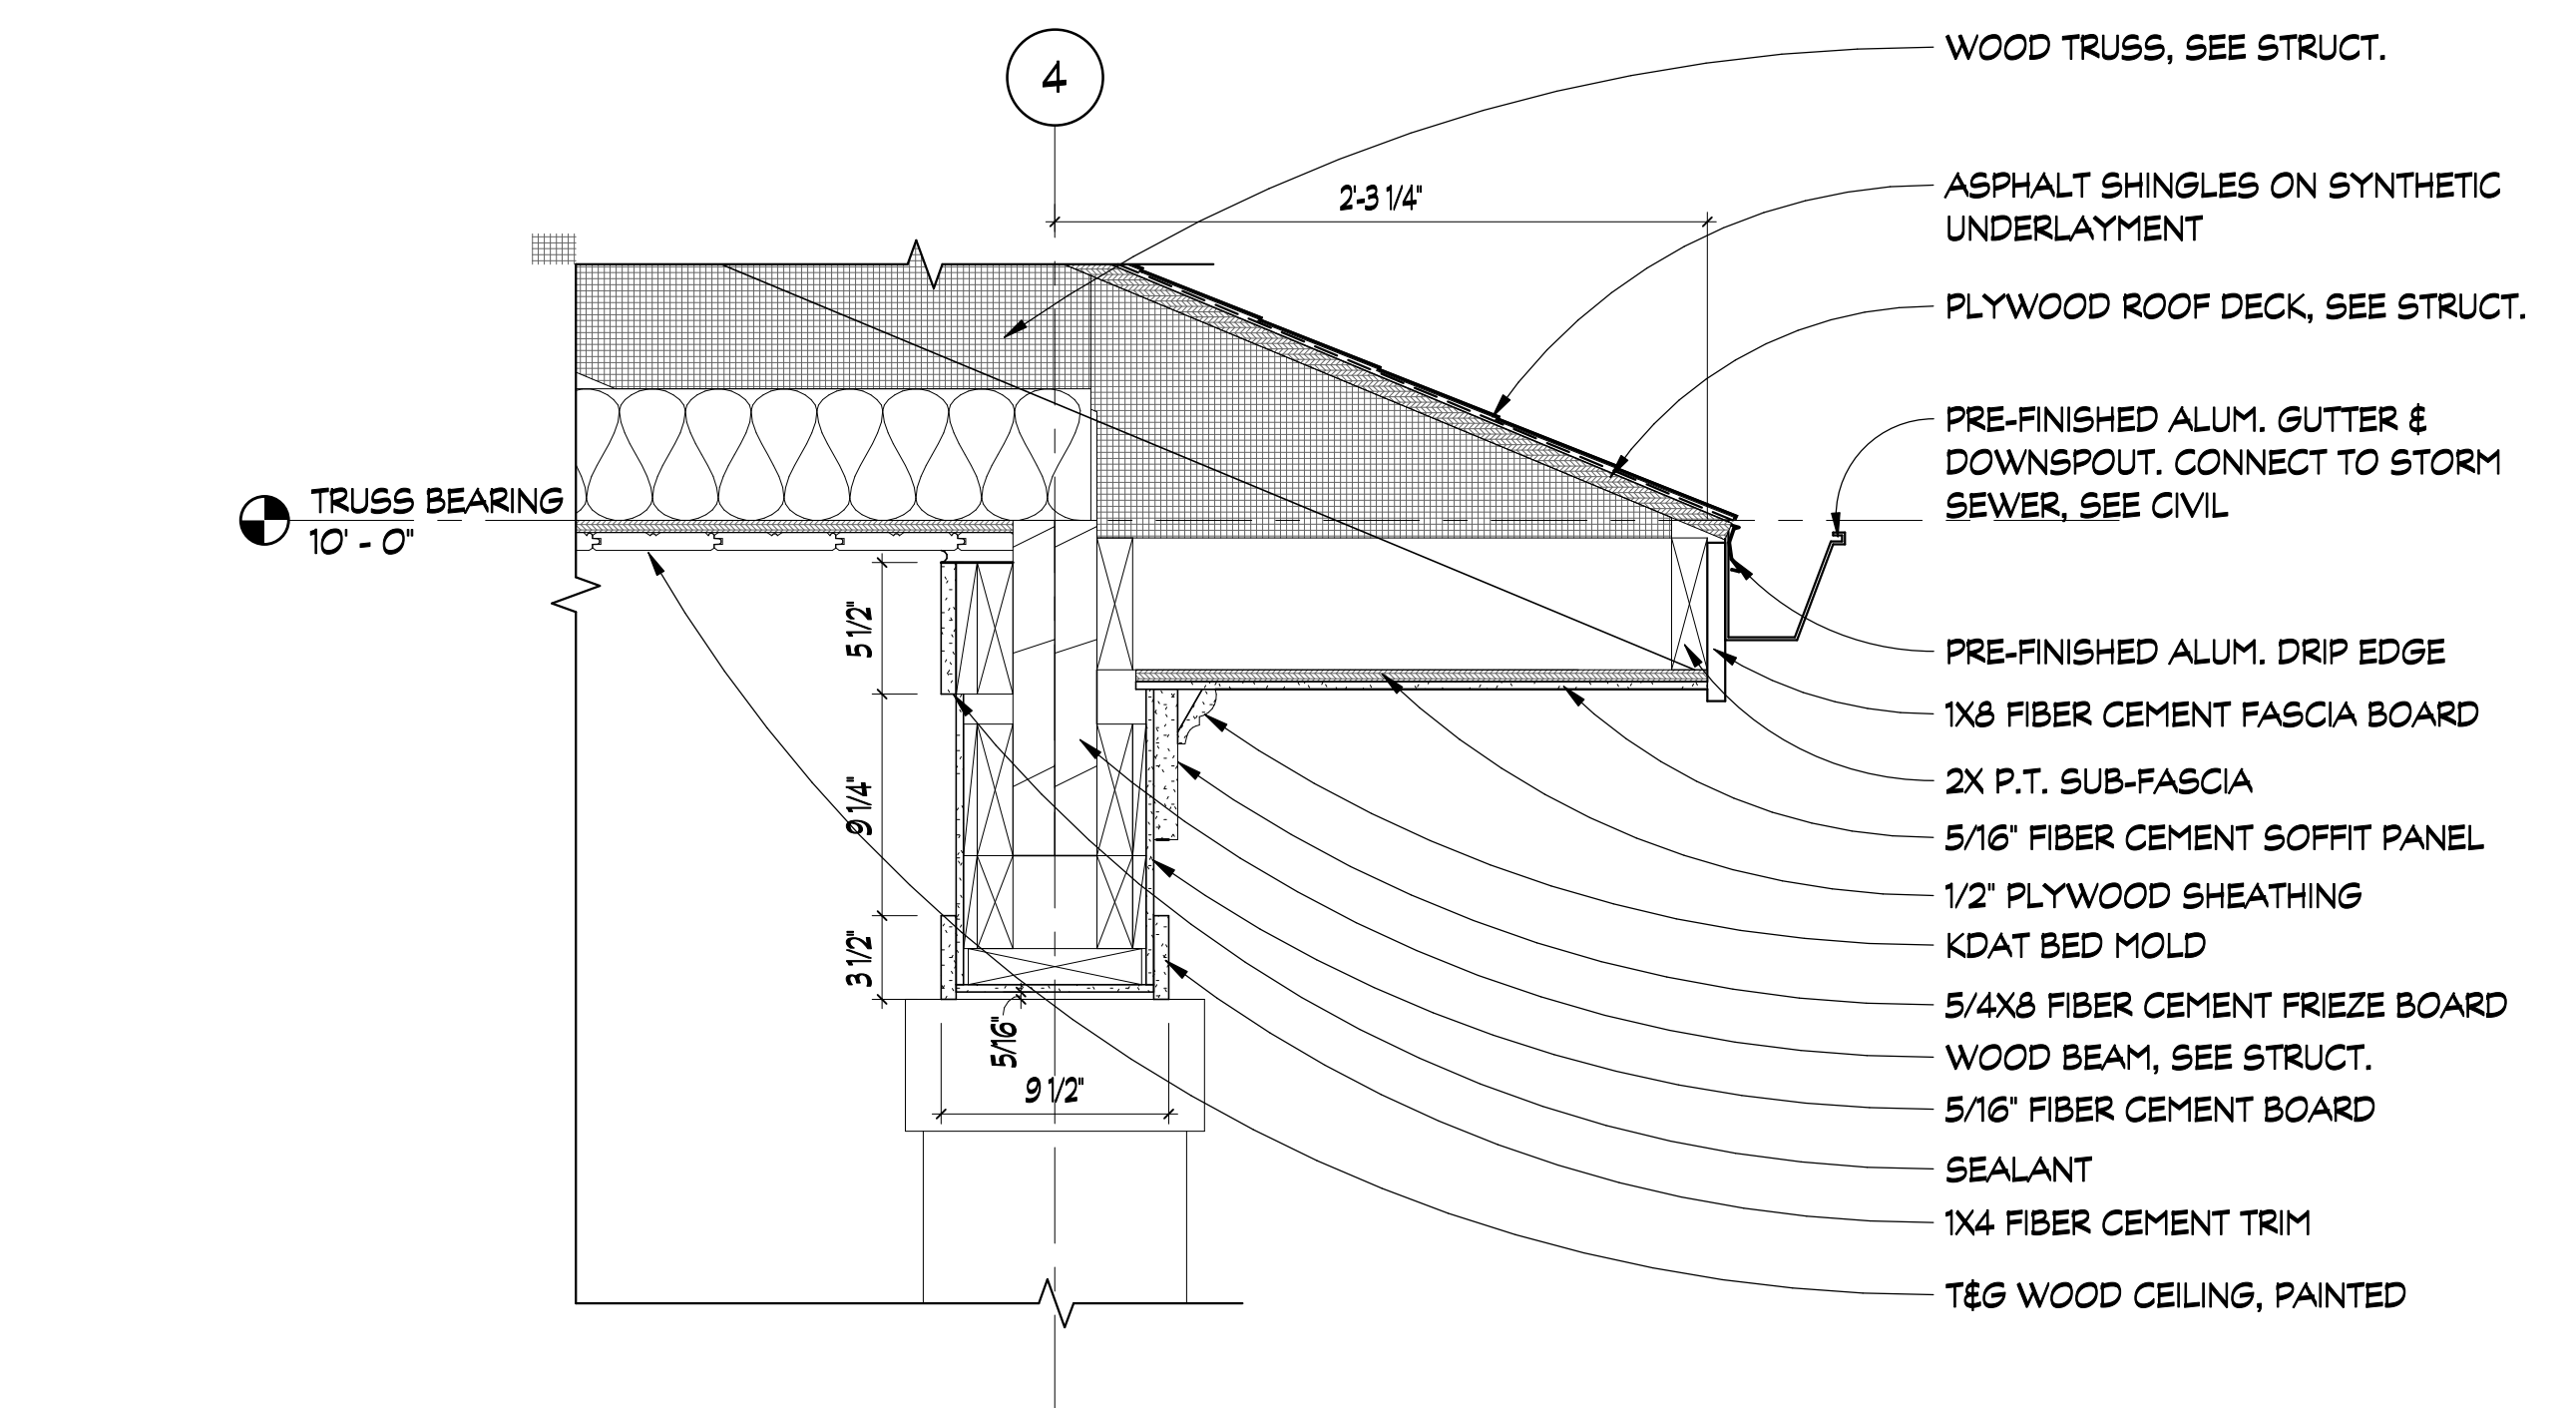


3 EAVE DETAIL
SCALE: 1 1/2" = 1'-0"

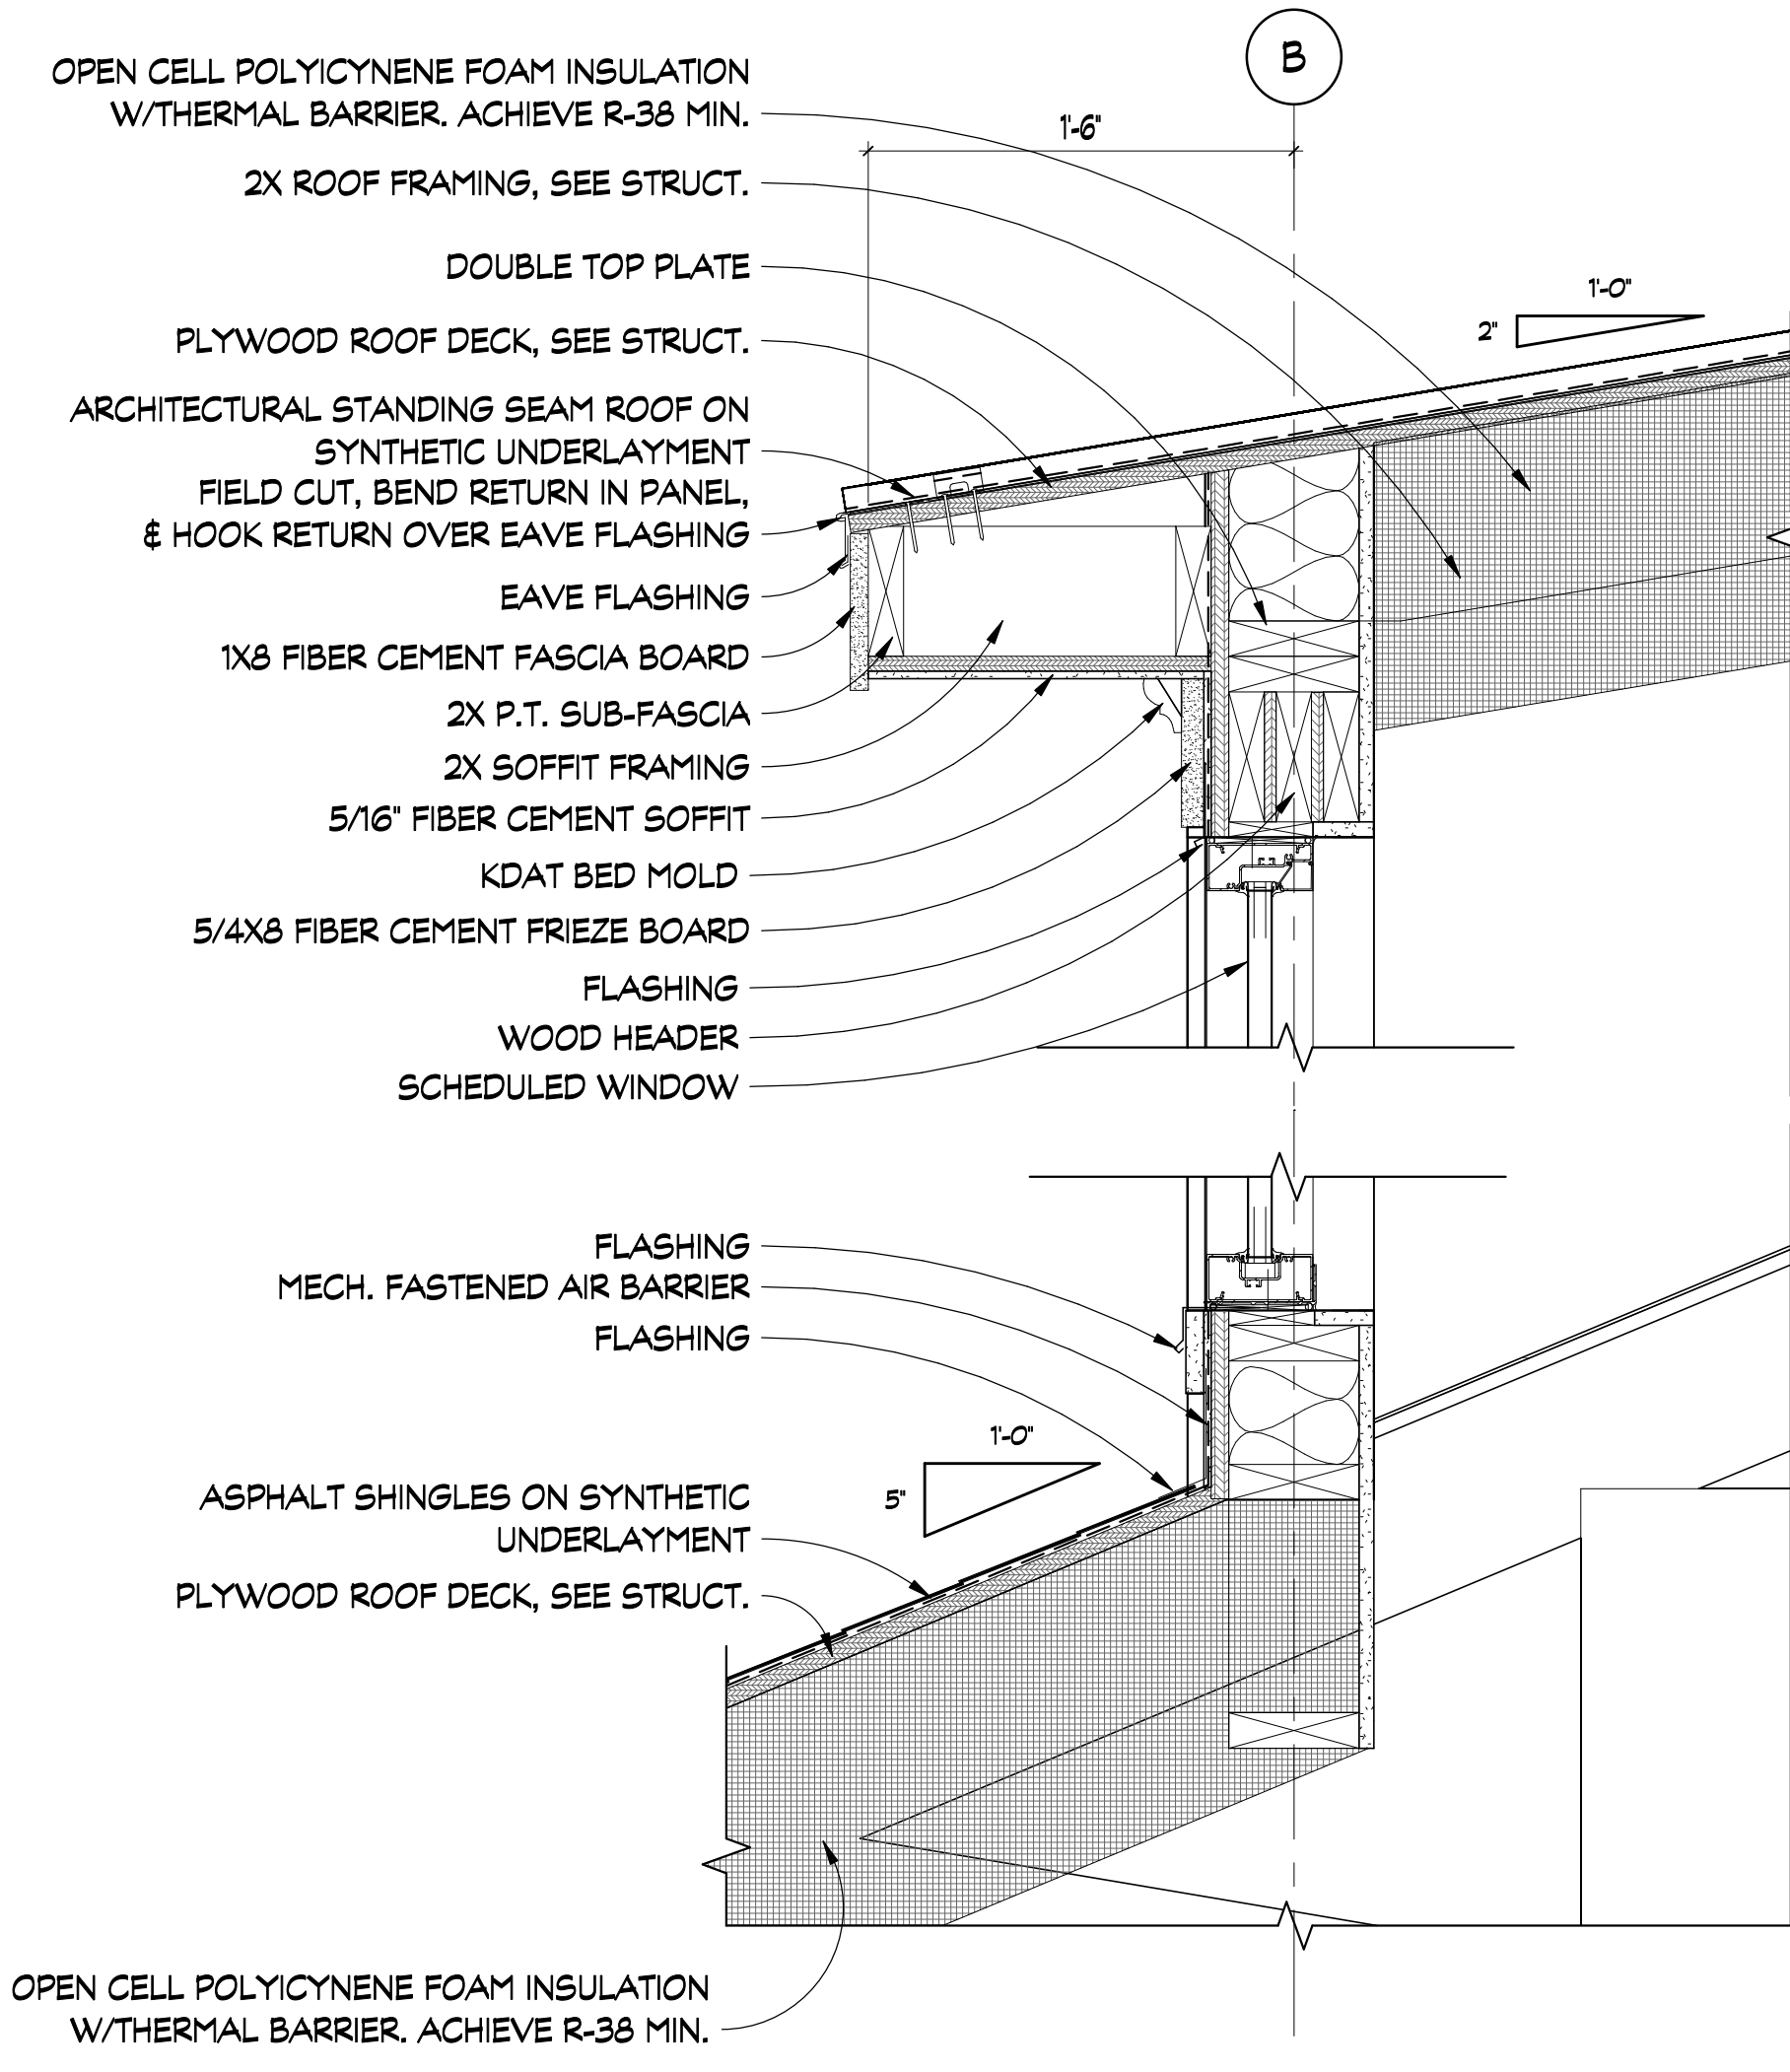


4 EAVE @ DORMER DETAIL
SCALE: 1 1/2" = 1'-0"

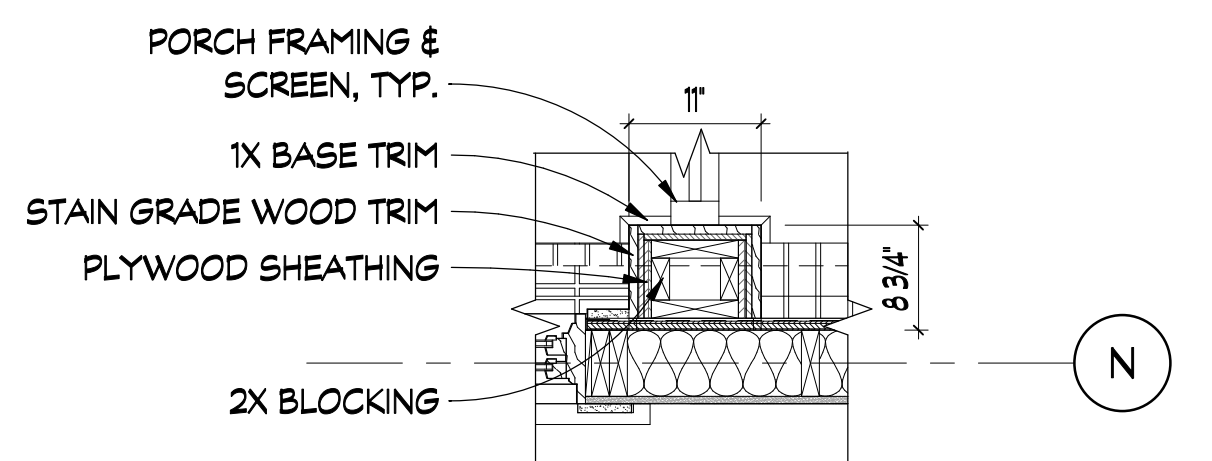


8 ENGAGED COLUMN DETAIL
SCALE: 3/4" = 1'-0"

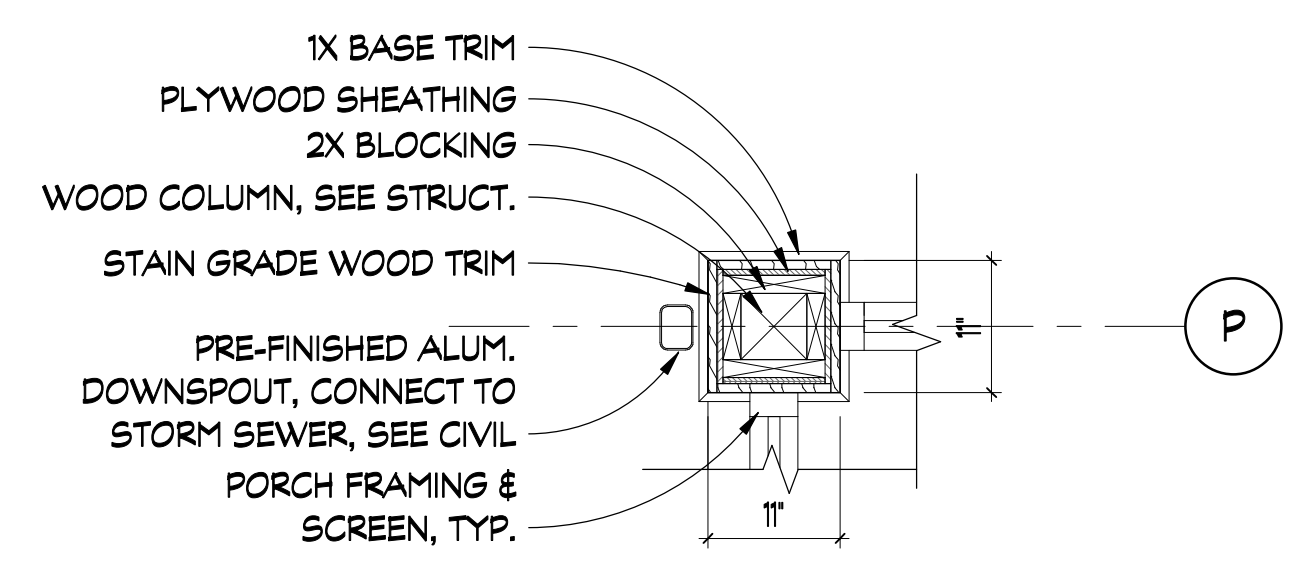


9 PORCH COLUMN DETAIL
SCALE: 3/4" = 1'-0"

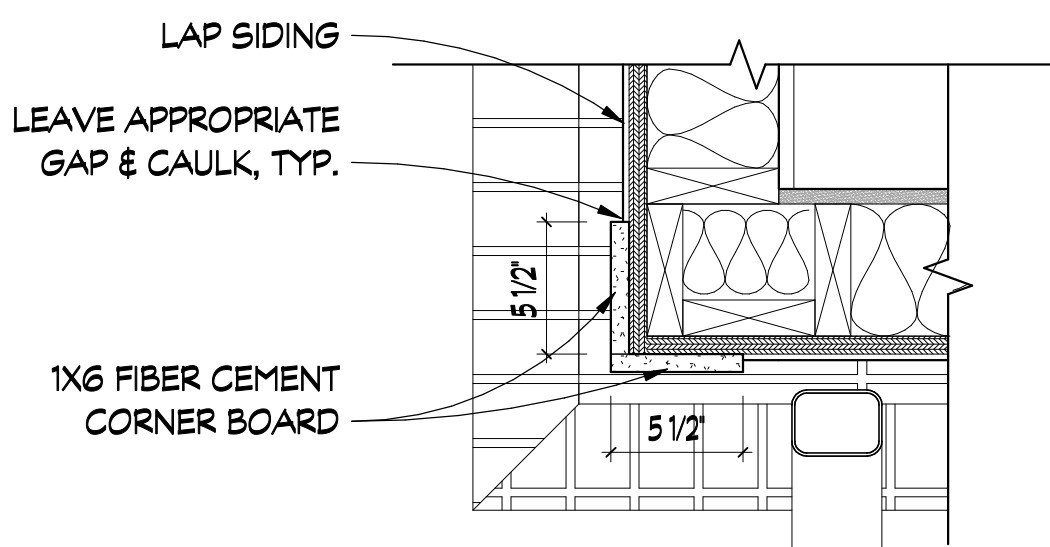

7 TYPICAL CORNER BOARD DETAIL
SCALE: 1 1/2" = 1'-0"

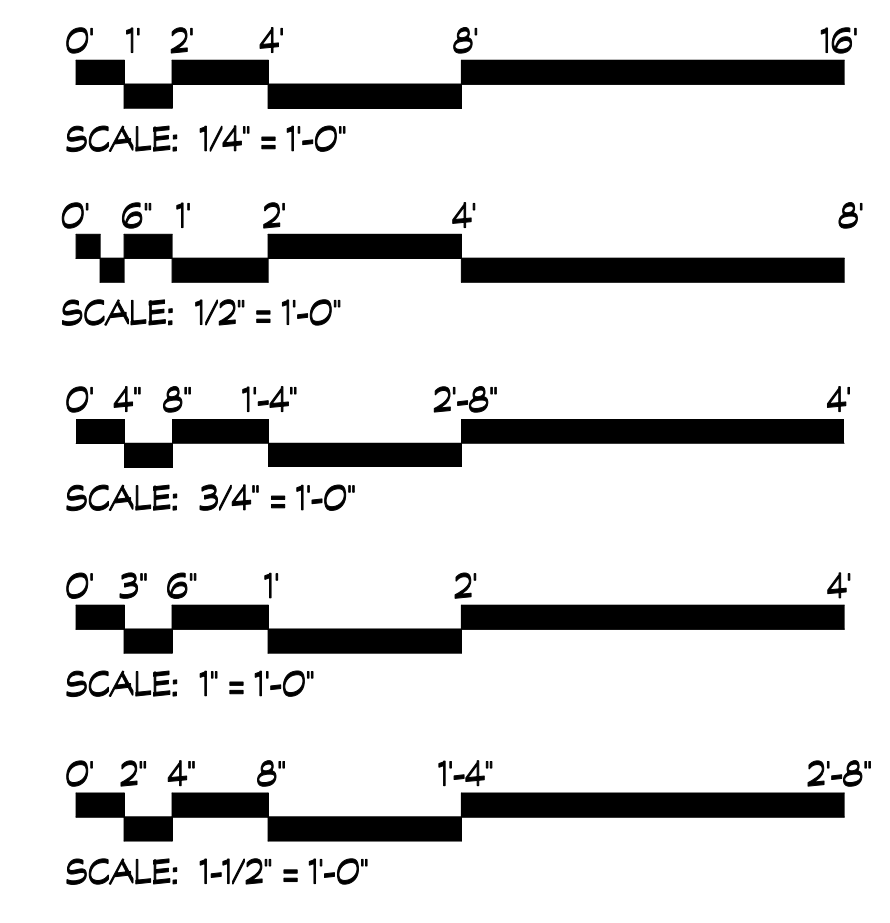

REVISIONS			
REV #	DATE	APRVD BY	REVISION
1	2/16/22	EA	ISSUE FOR PERMIT

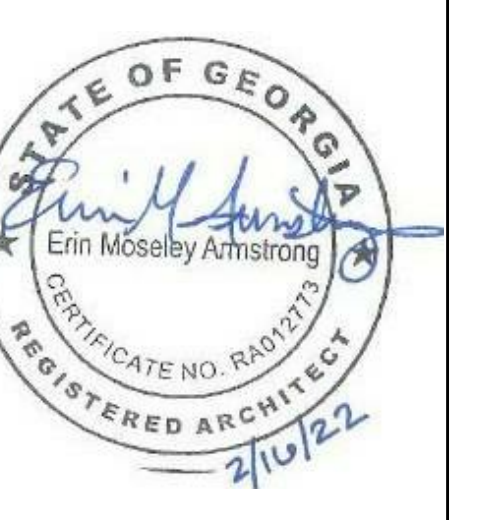


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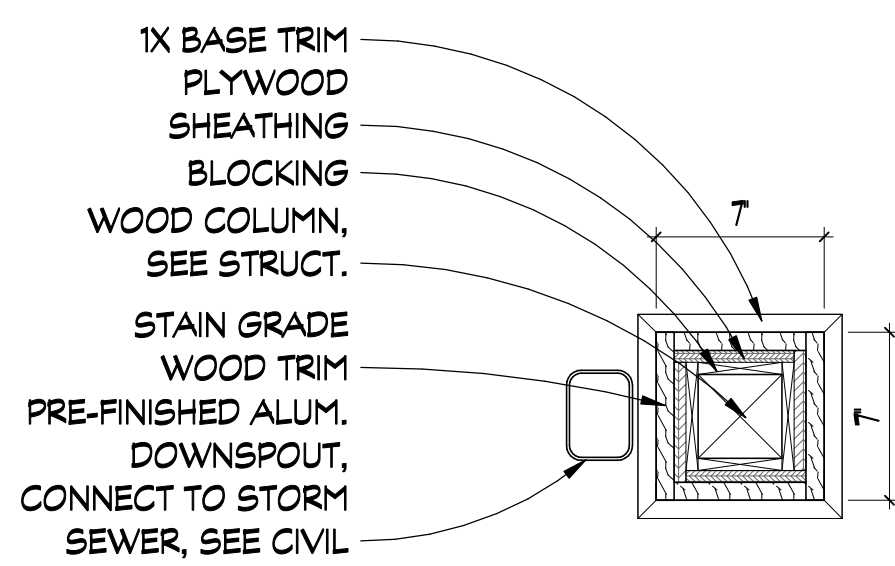
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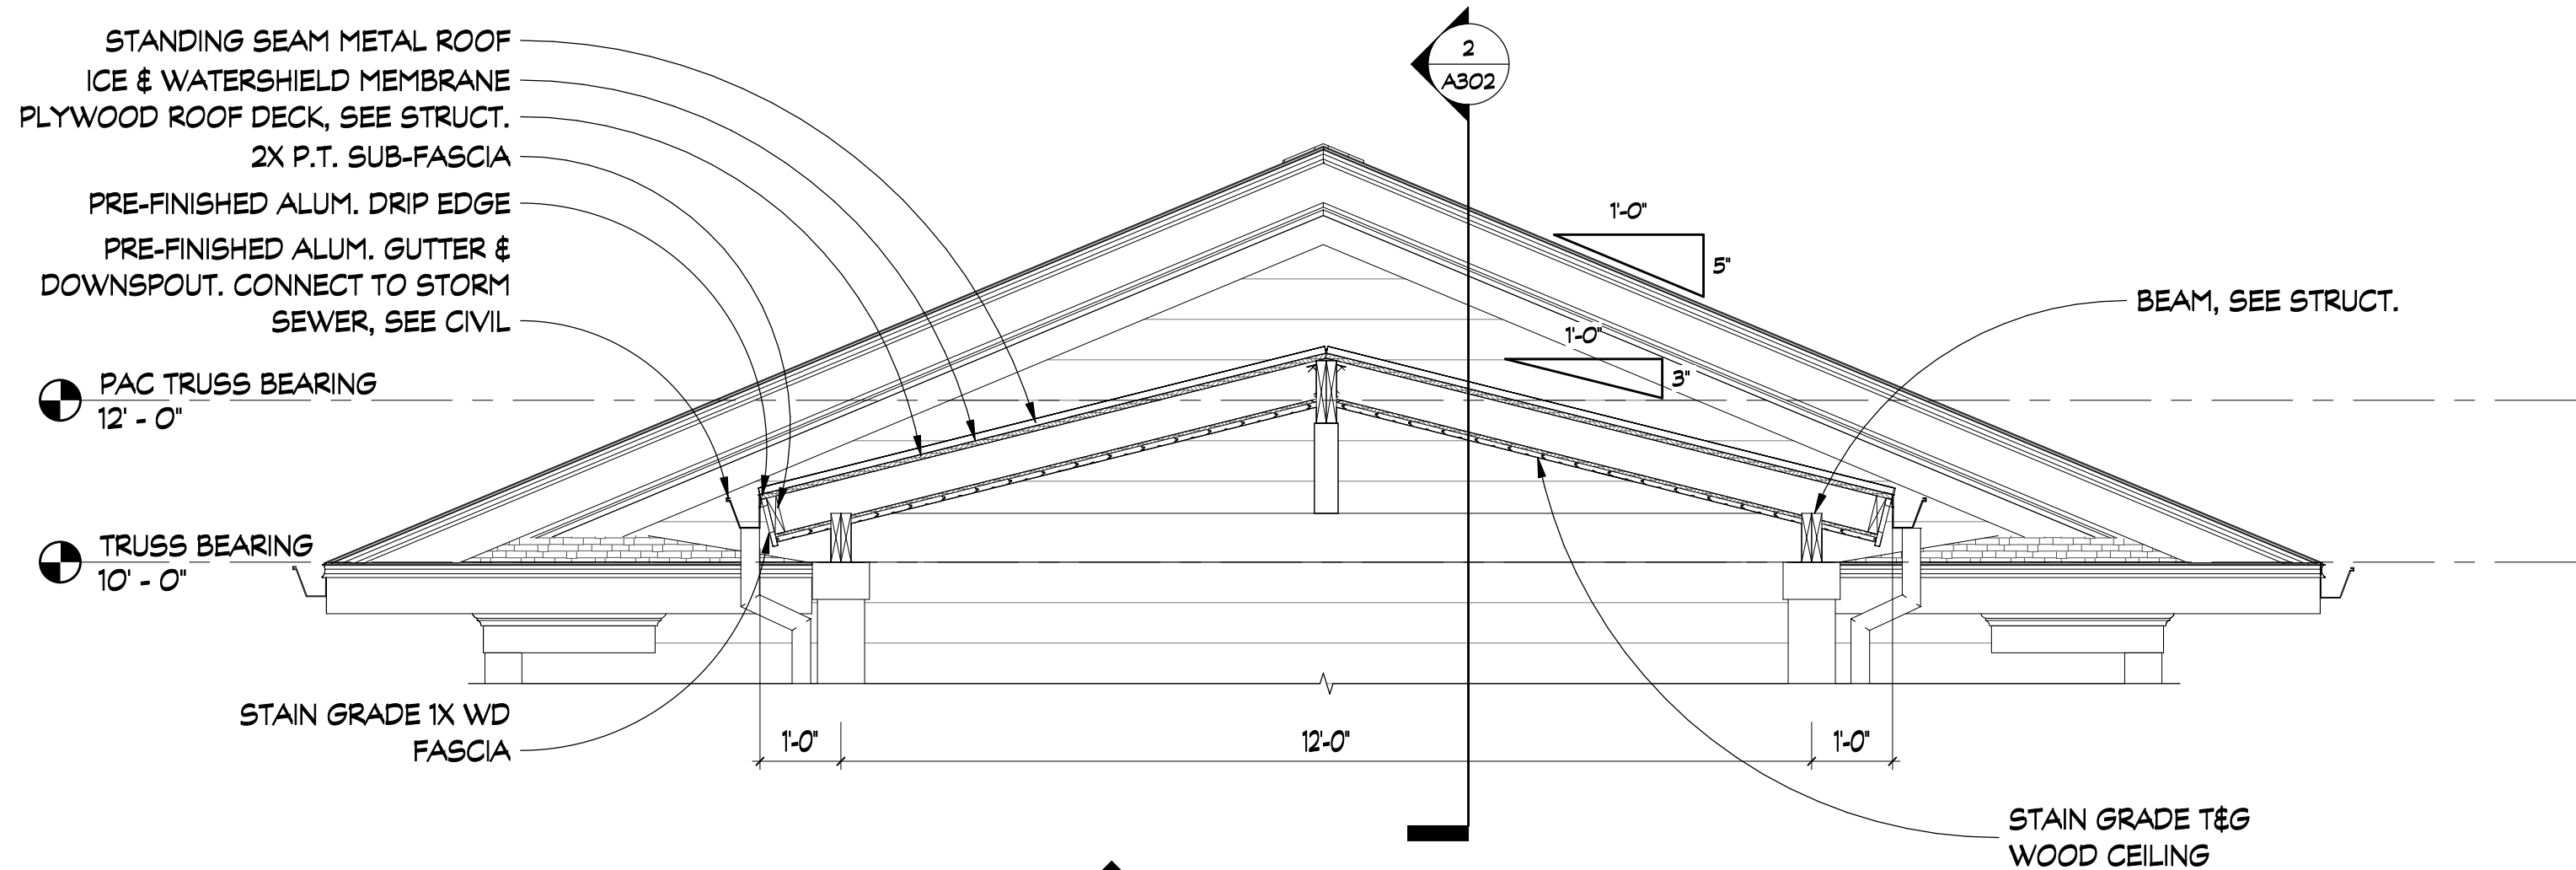
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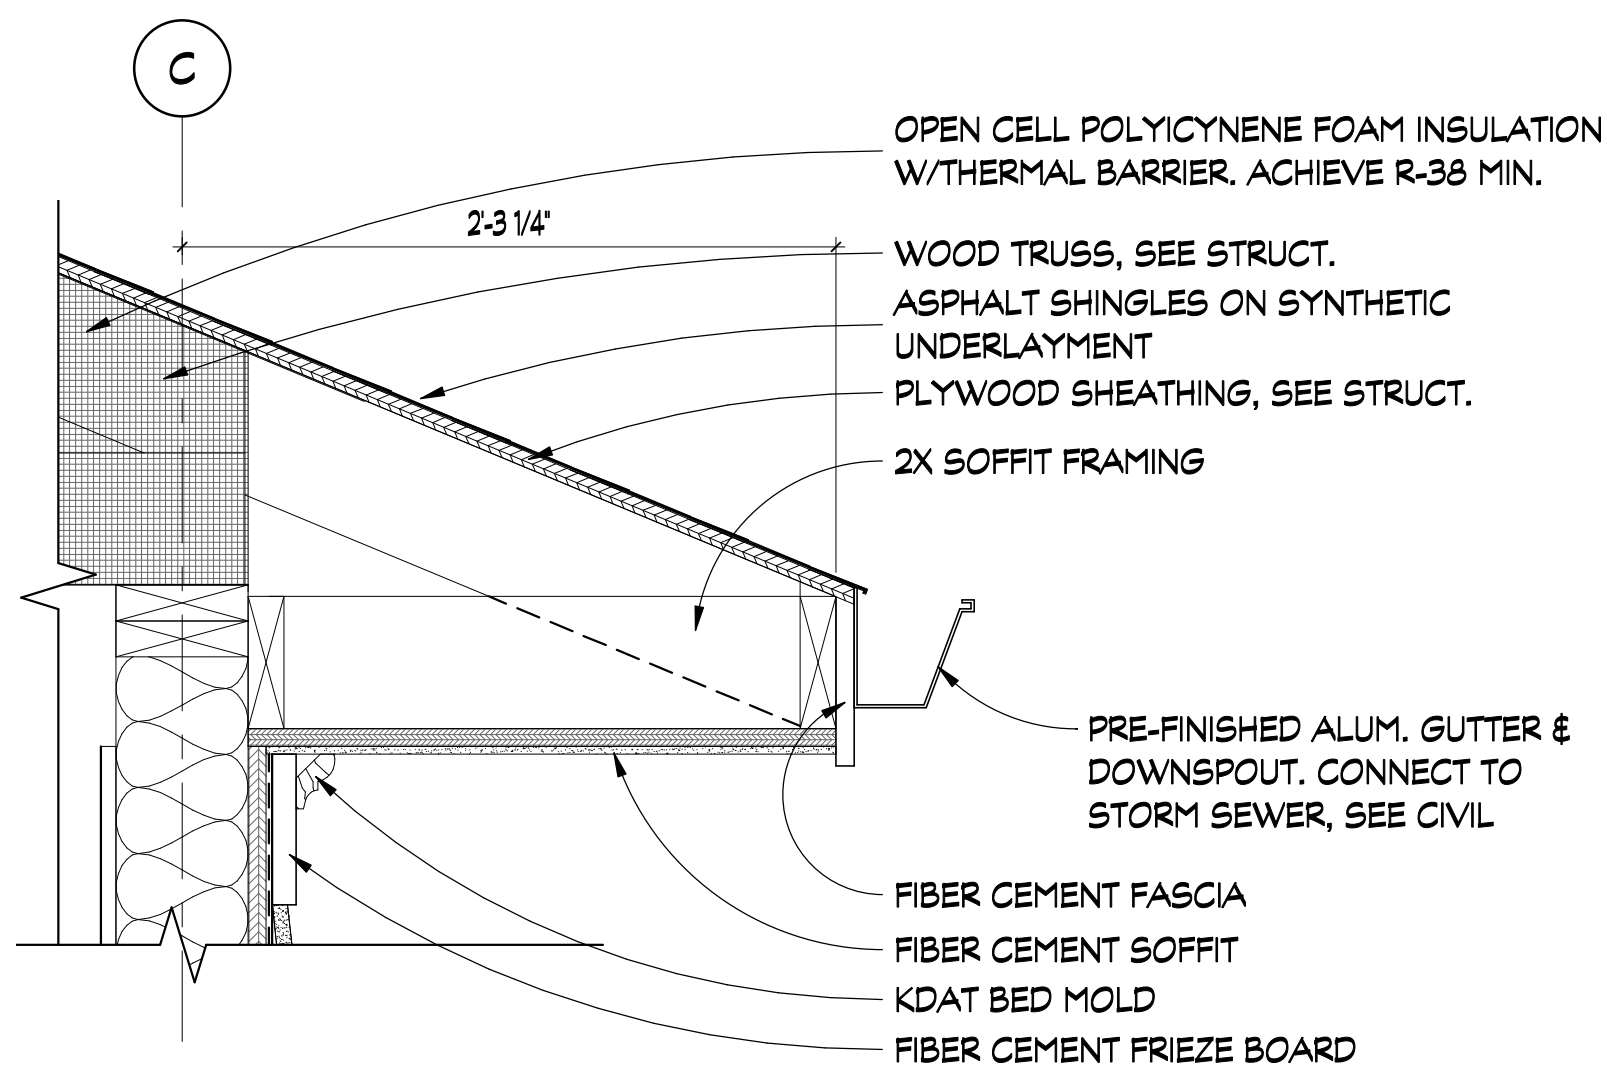
1 FAUX WINDOW DETAIL
A102 SCALE: 1 1/2" = 1'-0"




2 COLUMN WRAP DETAIL
A102 SCALE: 1 1/2" = 1'-0"




3 WALKWAY ROOF SECTION
A105 SCALE: 1/2" = 1'-0"

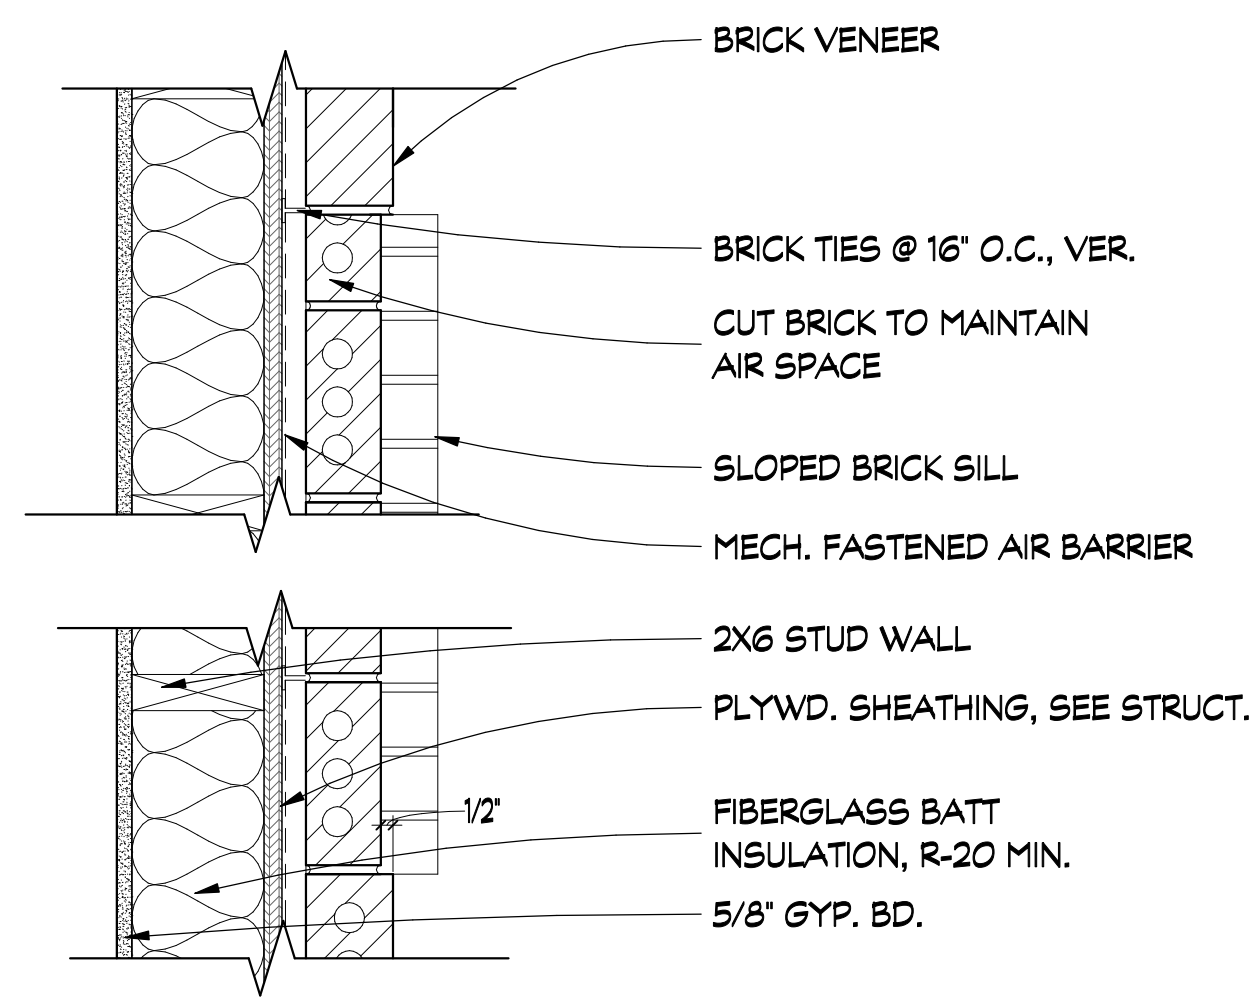


4 EAVE DETAIL
A310 SCALE: 1 1/2" = 1'-0"

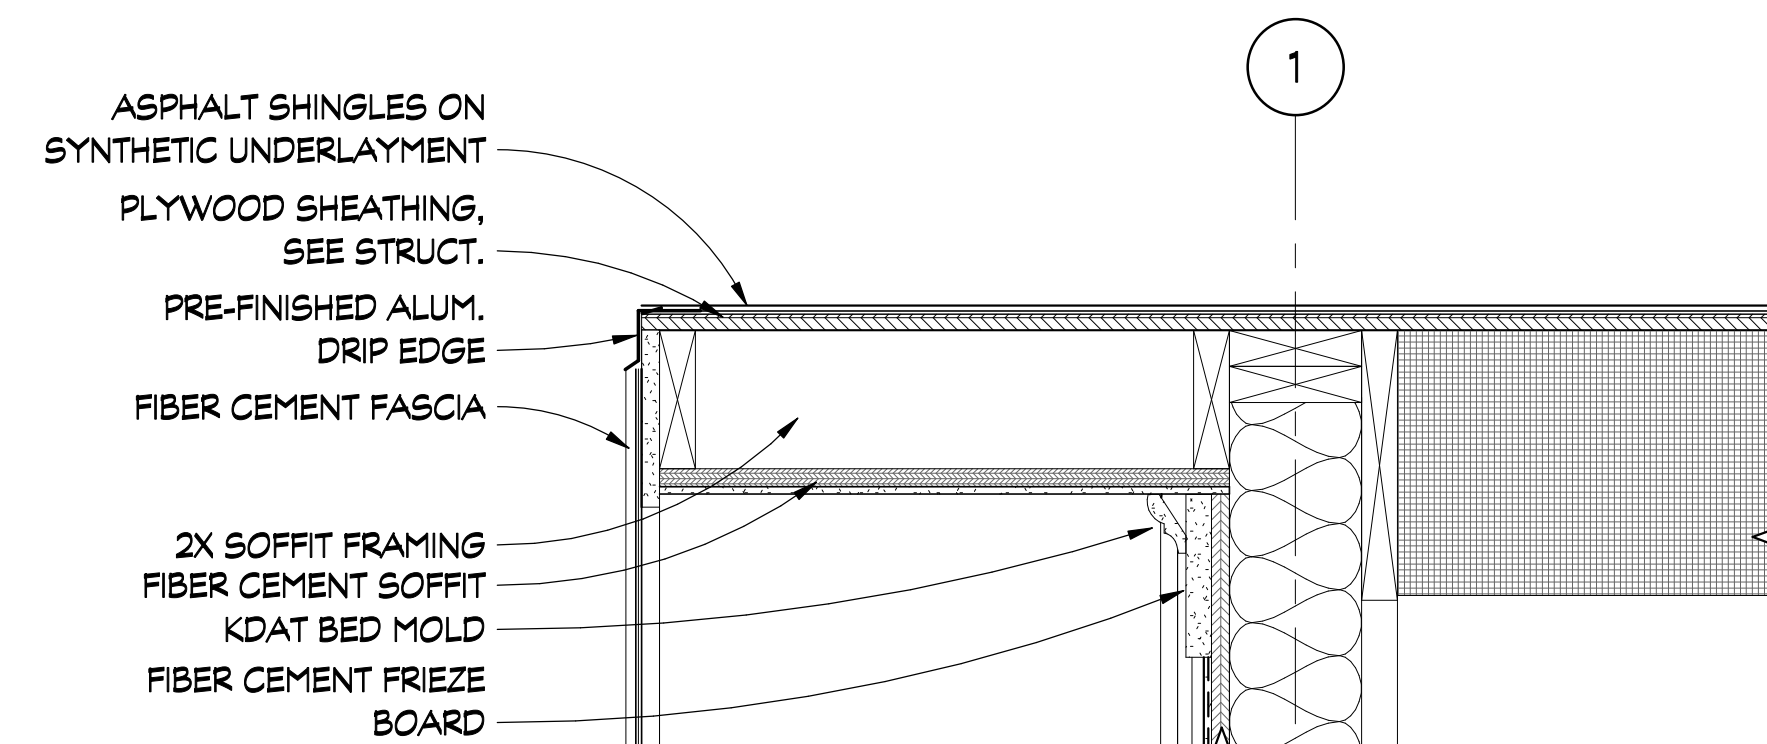


5 RAKE DETAIL
A311 SCALE: 1 1/2" = 1'-0"

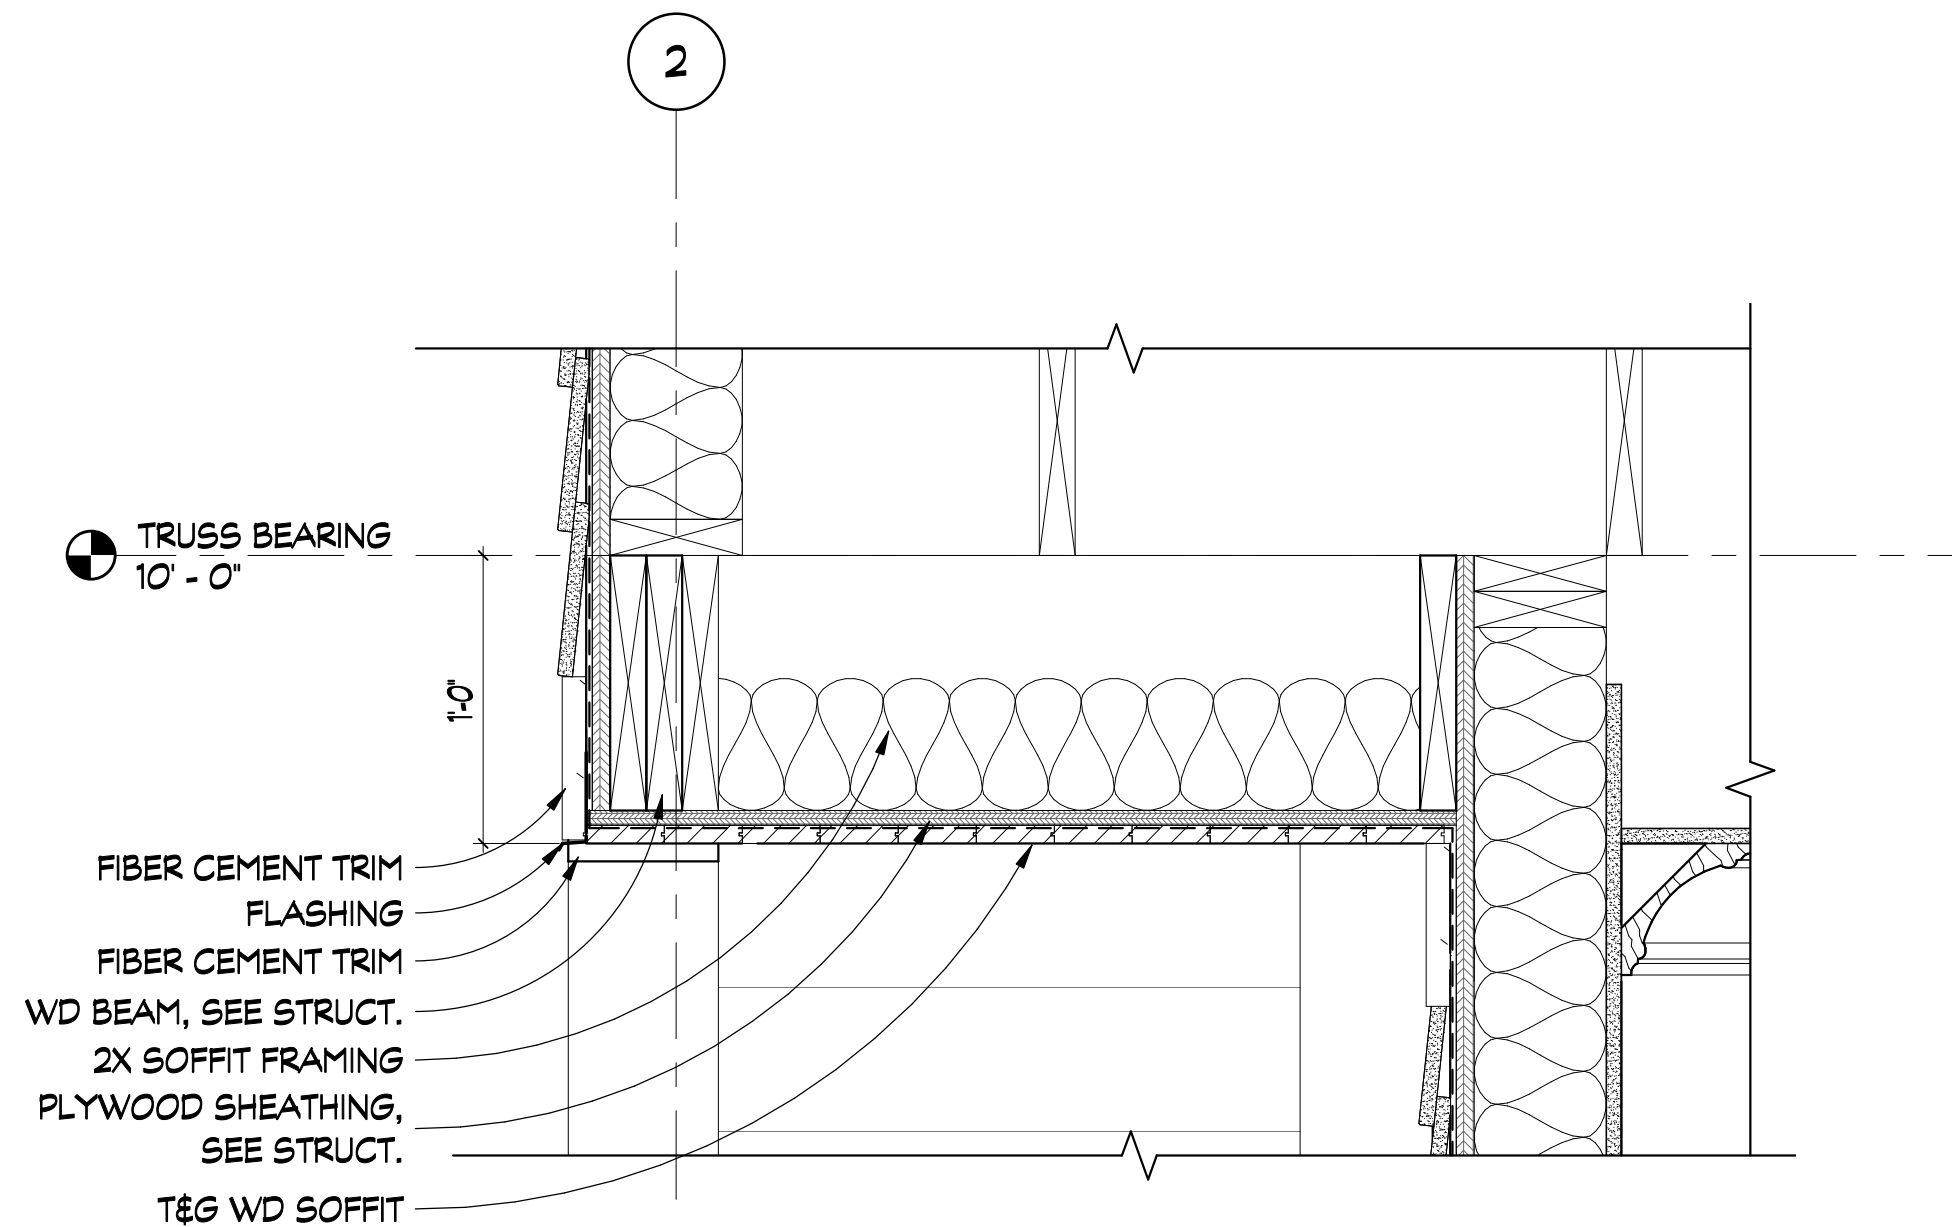




6 SOFFIT DETAIL
A311 SCALE: 1 1/2" = 1'-0"

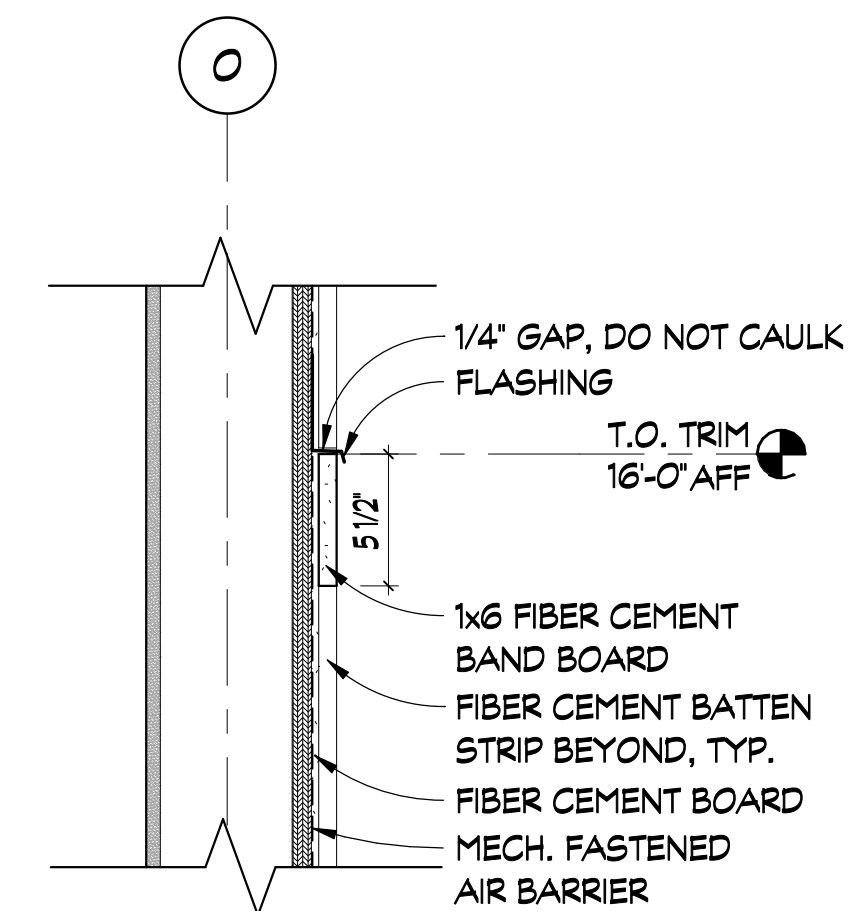

7 BAND BOARD DETAIL
A201 SCALE: 1 1/2" = 1'-0"

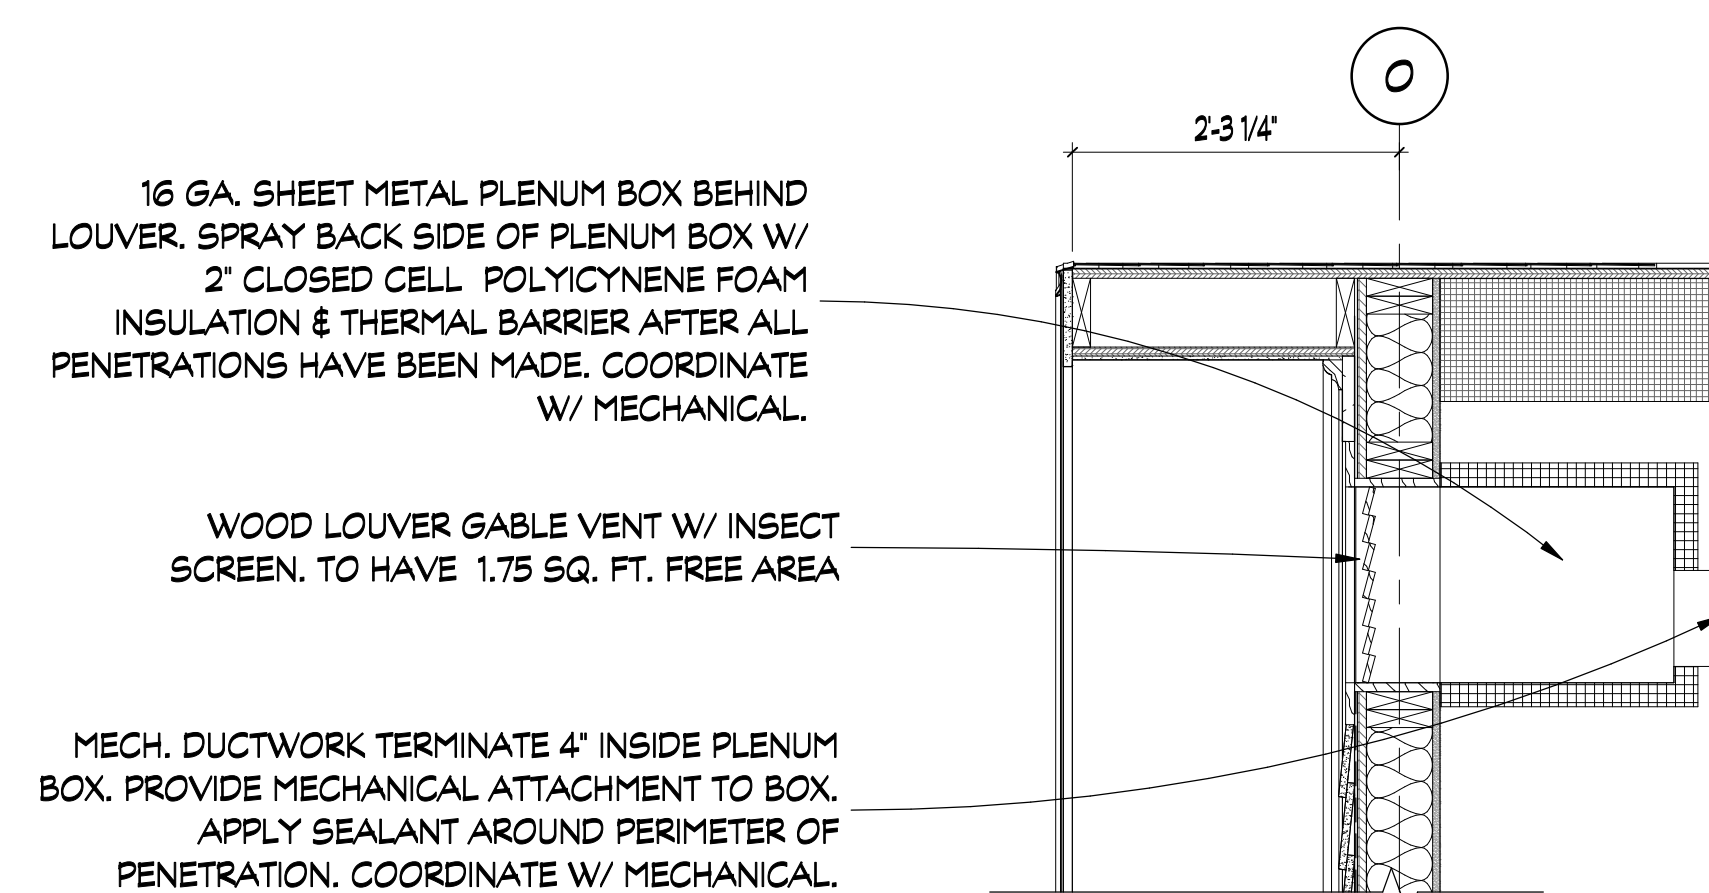

8 LOUVER VENT DETAIL
A108 SCALE: 3/4" = 1'-0"

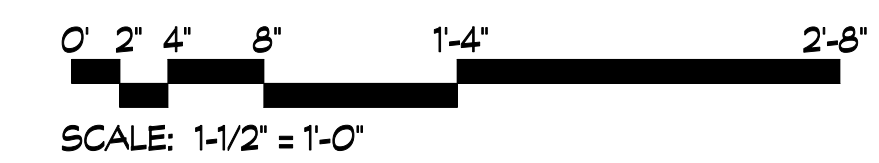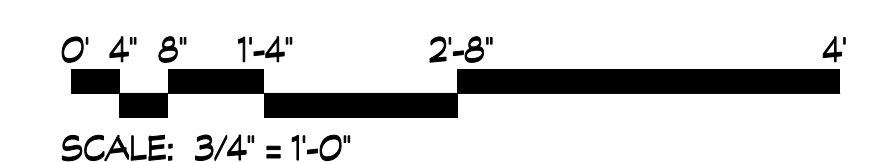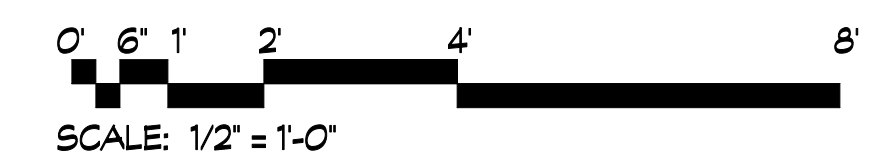


















REVISIONS			
REV #	DATE	APRVD BY	REVISION
1	2/16/22	EA	ISSUE FOR PERMIT




DA PROJECT NUMBER & NAME:
1893


DRAWING TITLE:
**EXTERIOR
DETAILS**

DRAWING NO:
A323

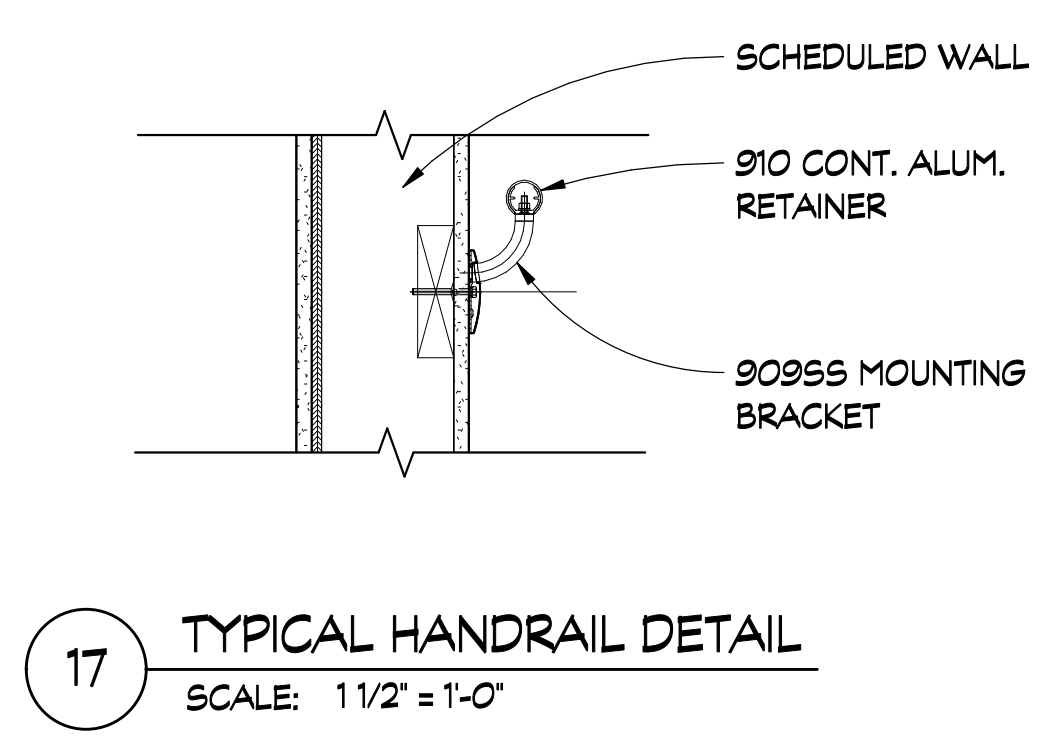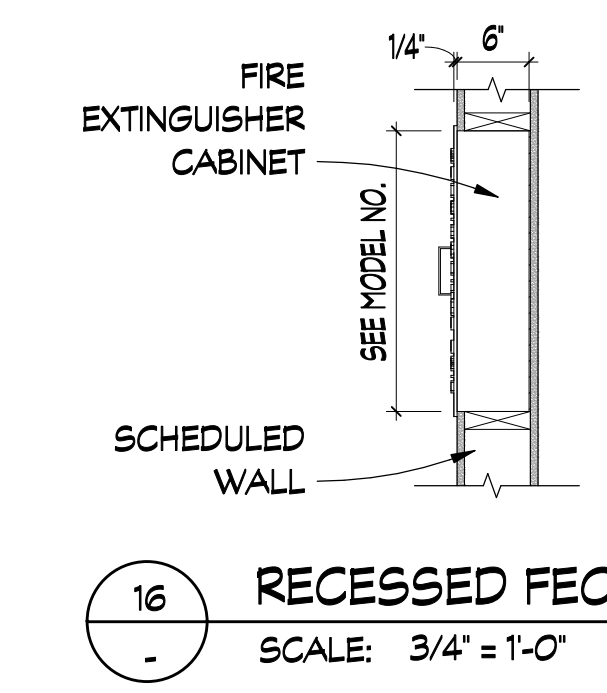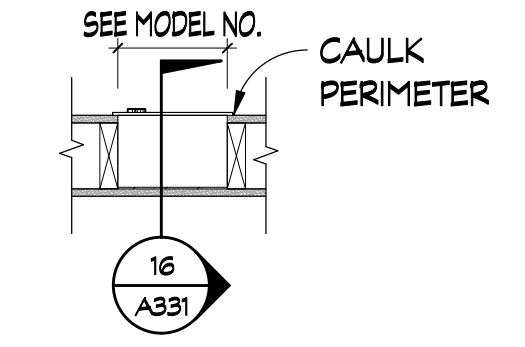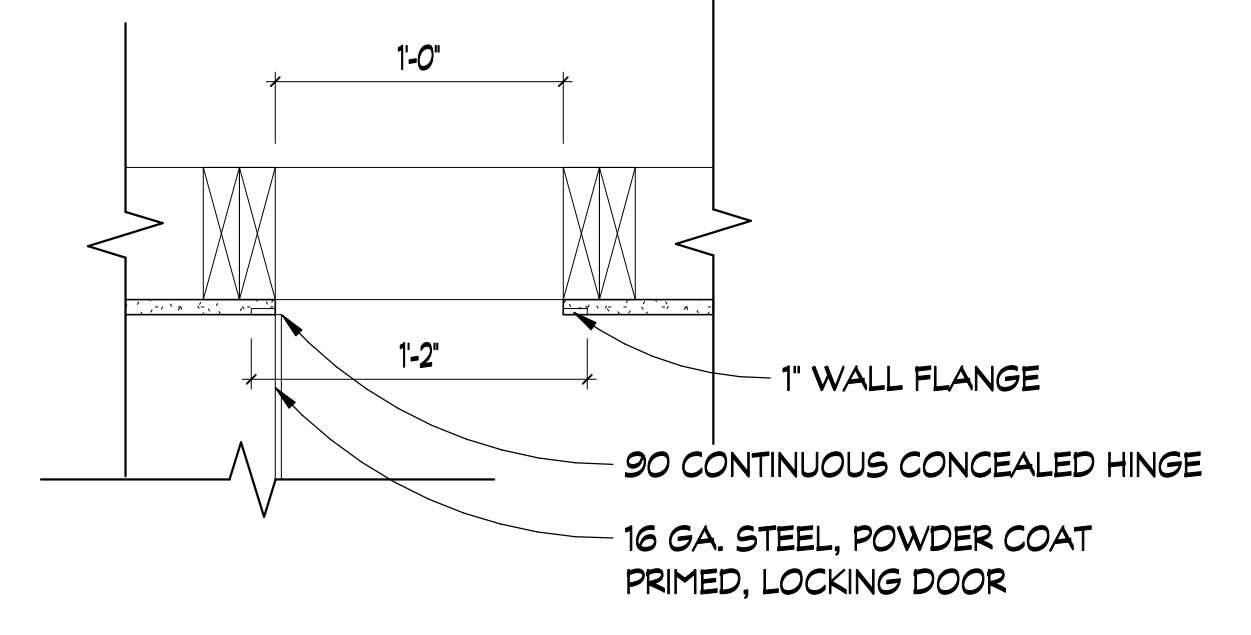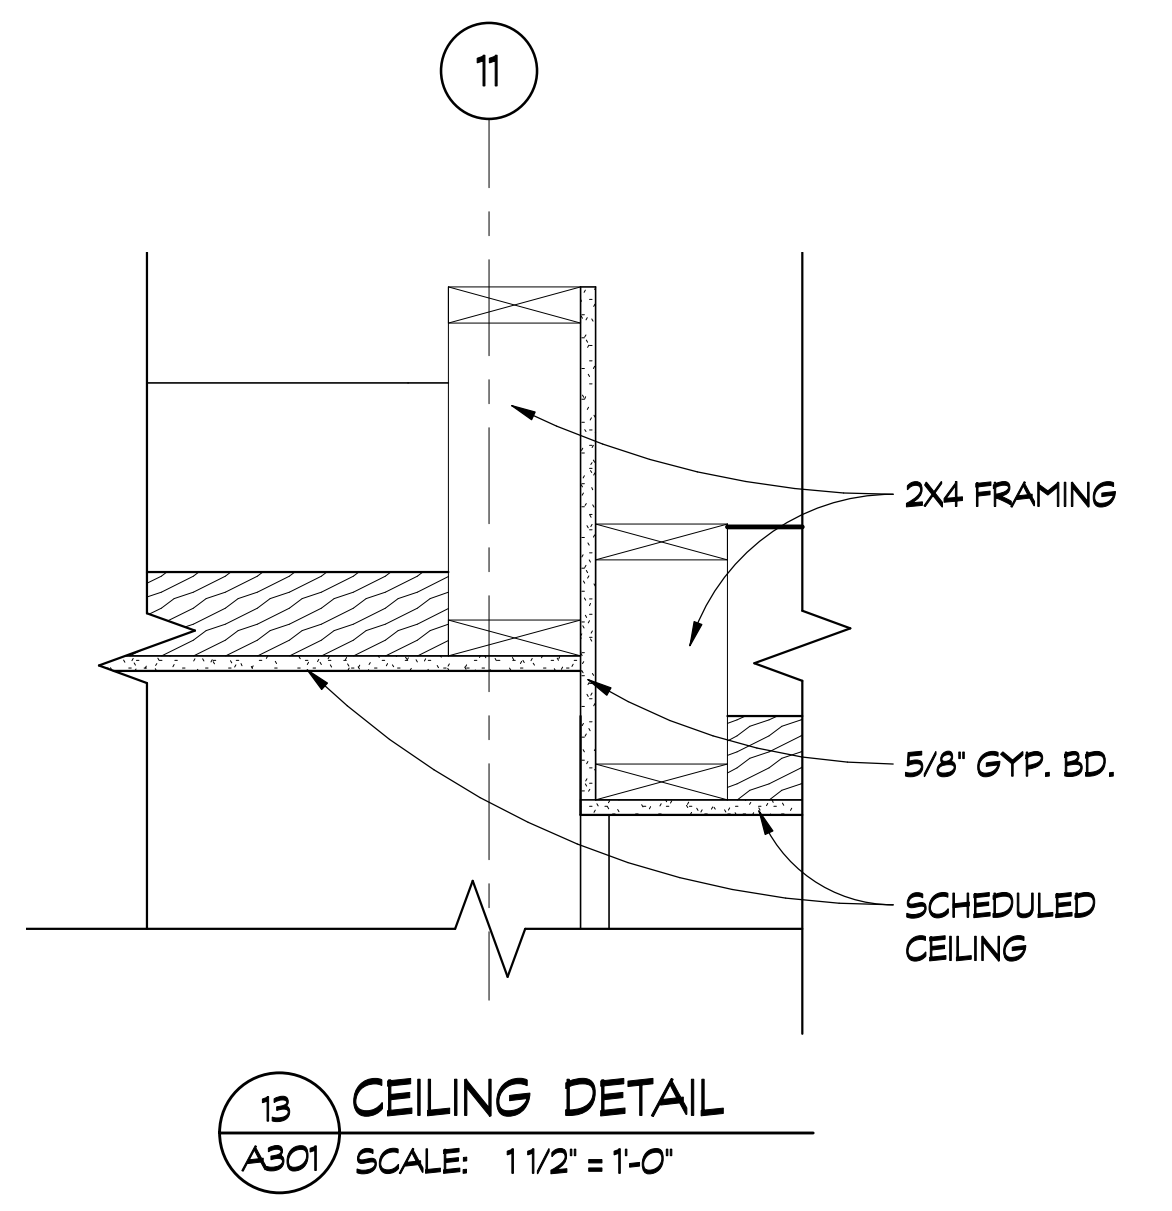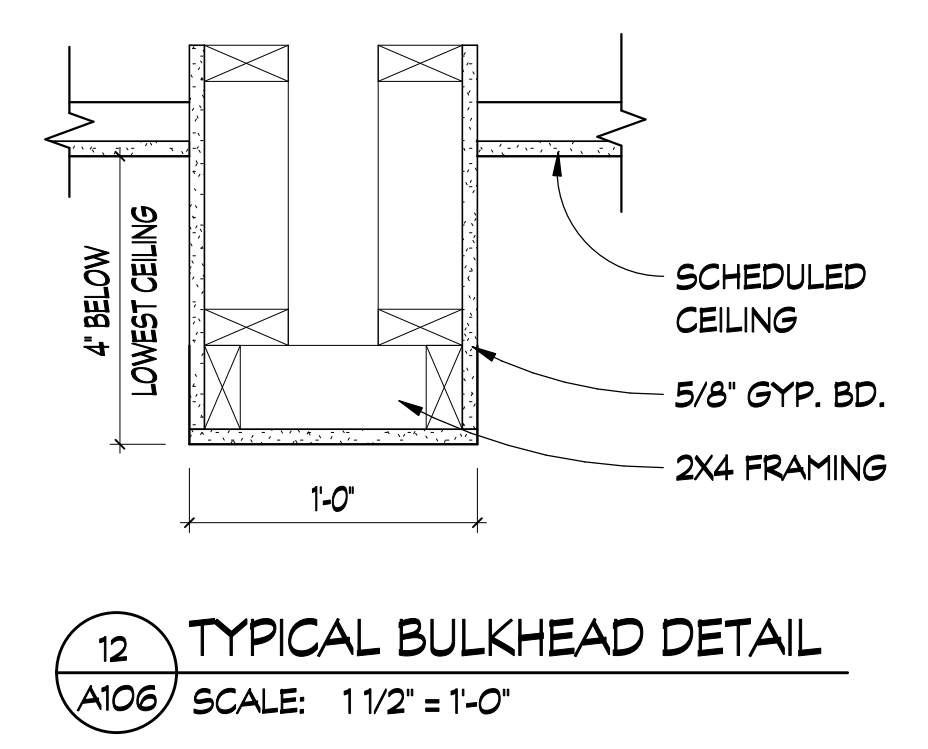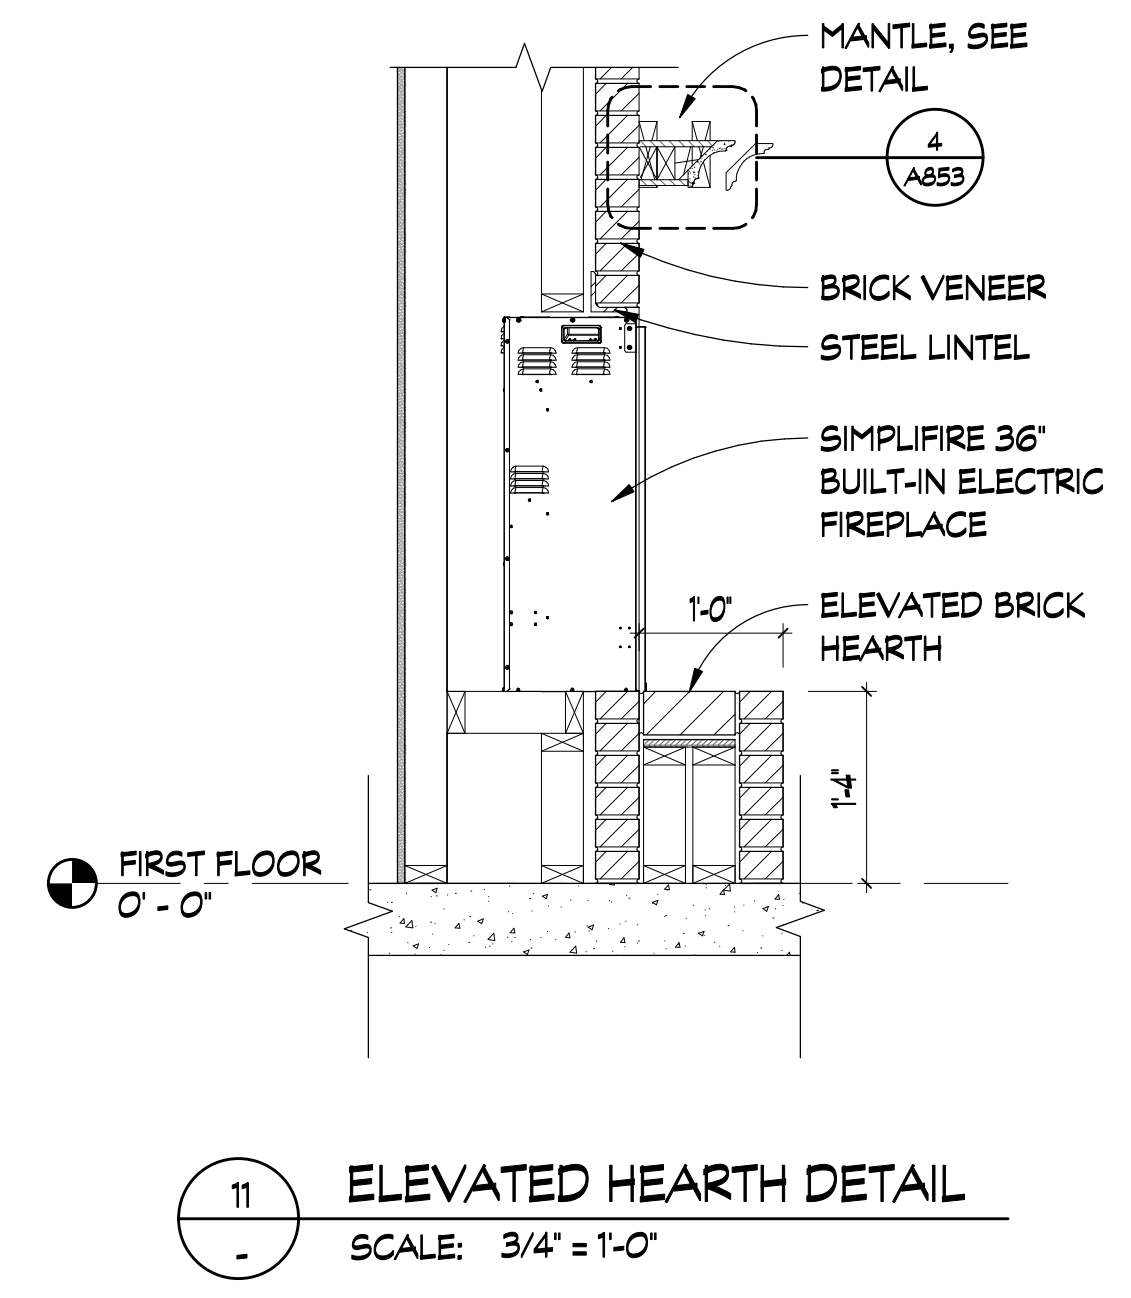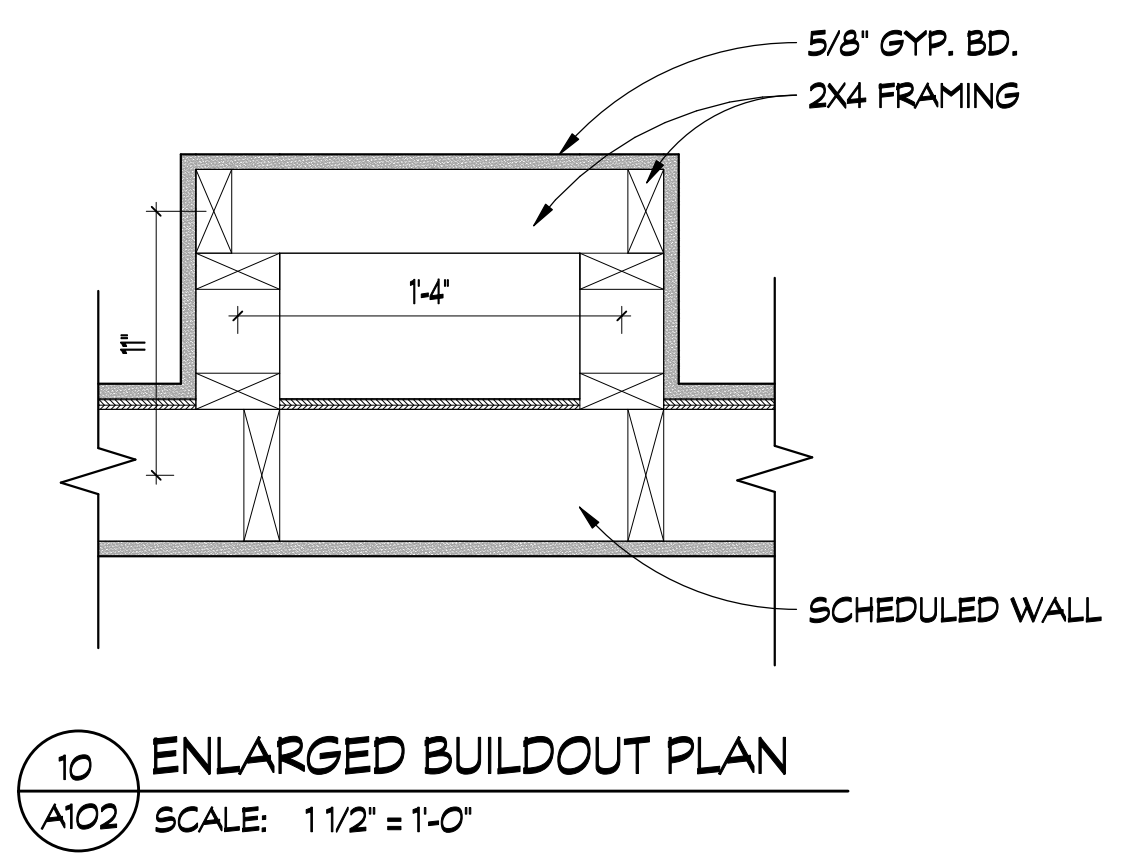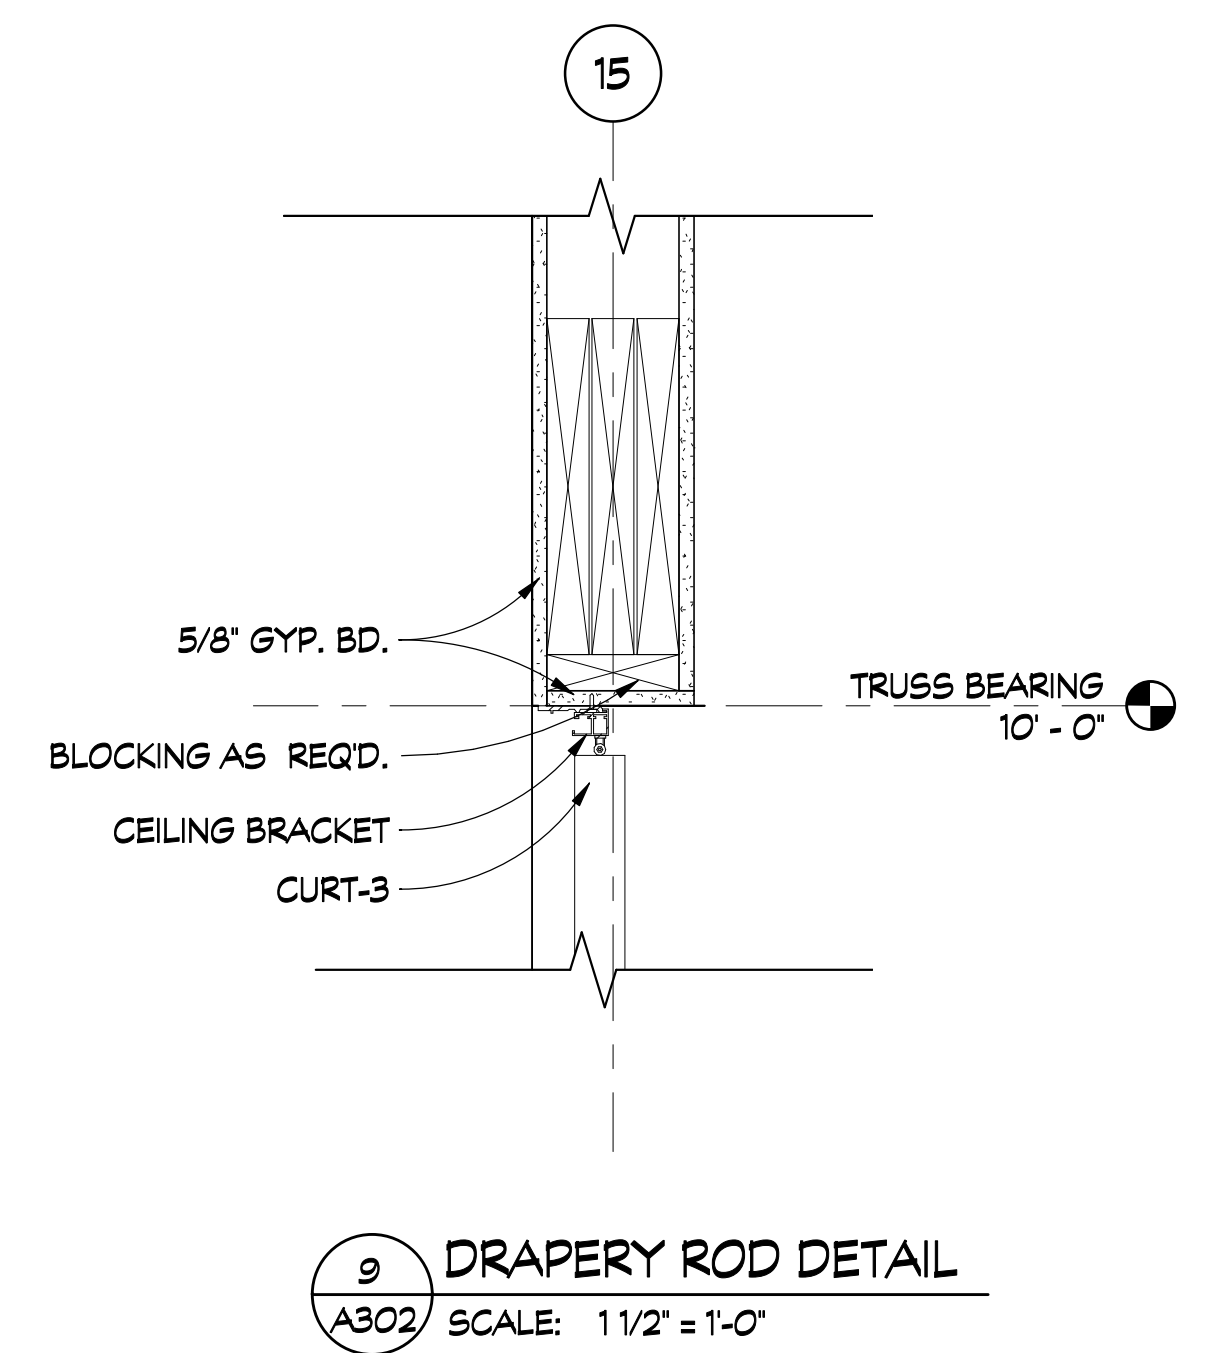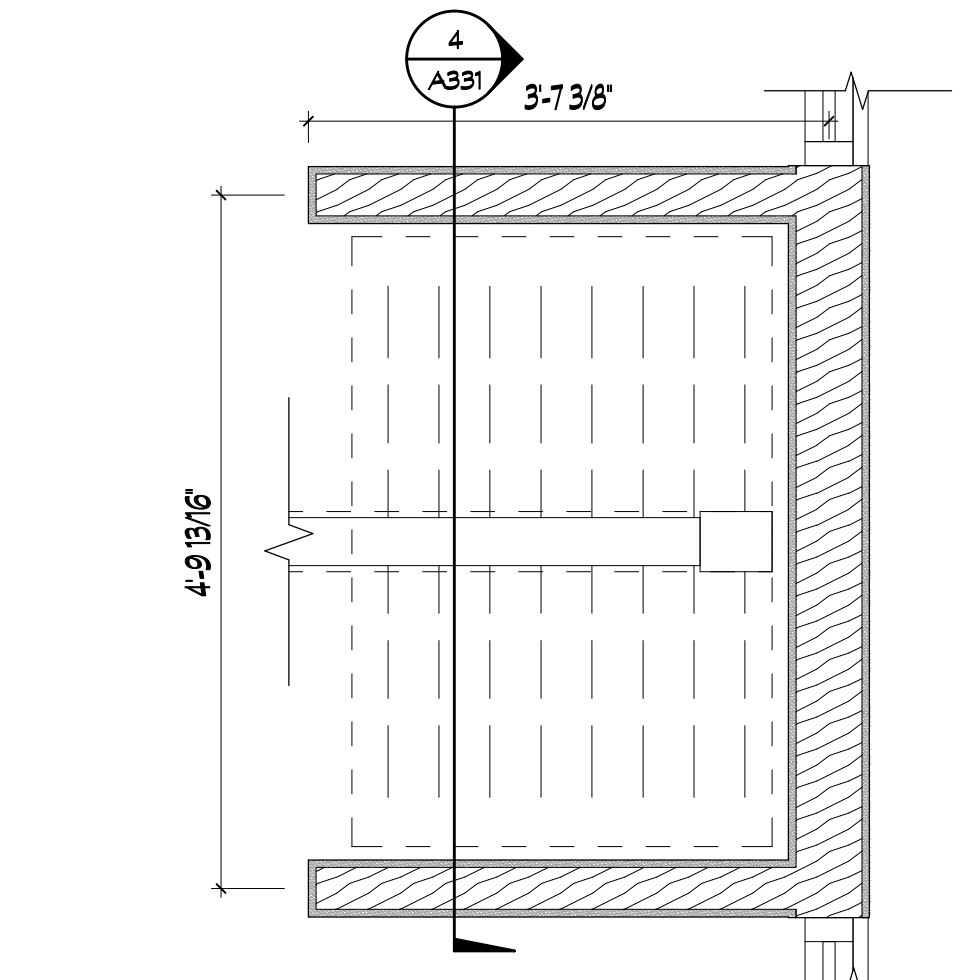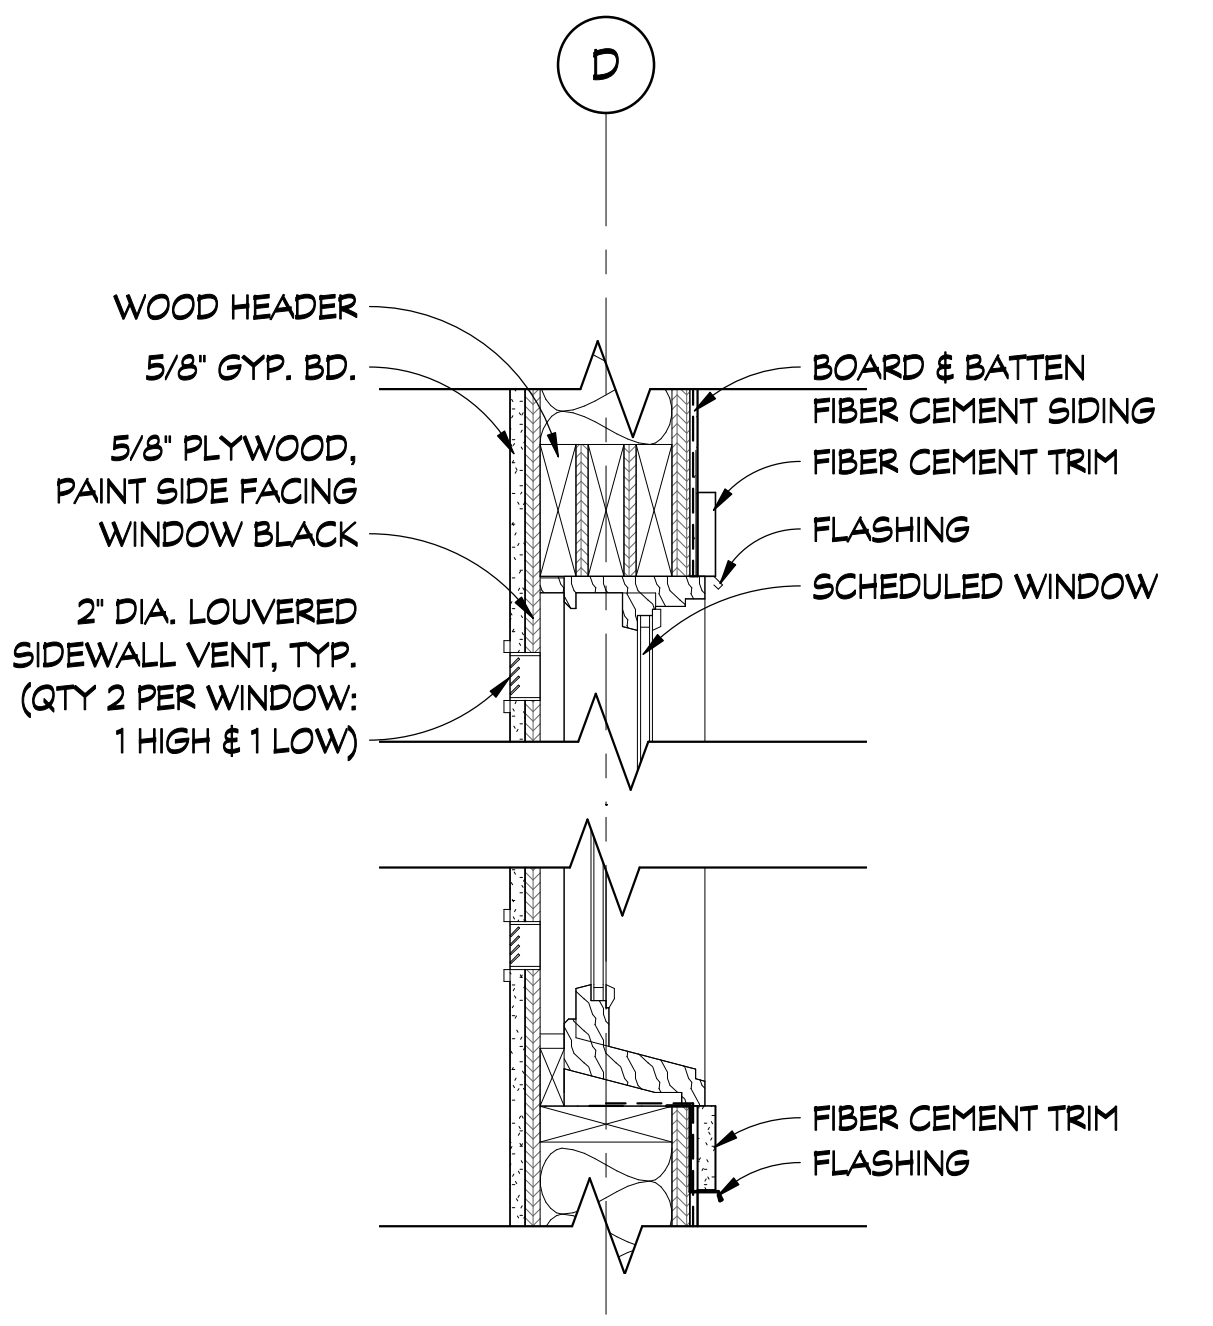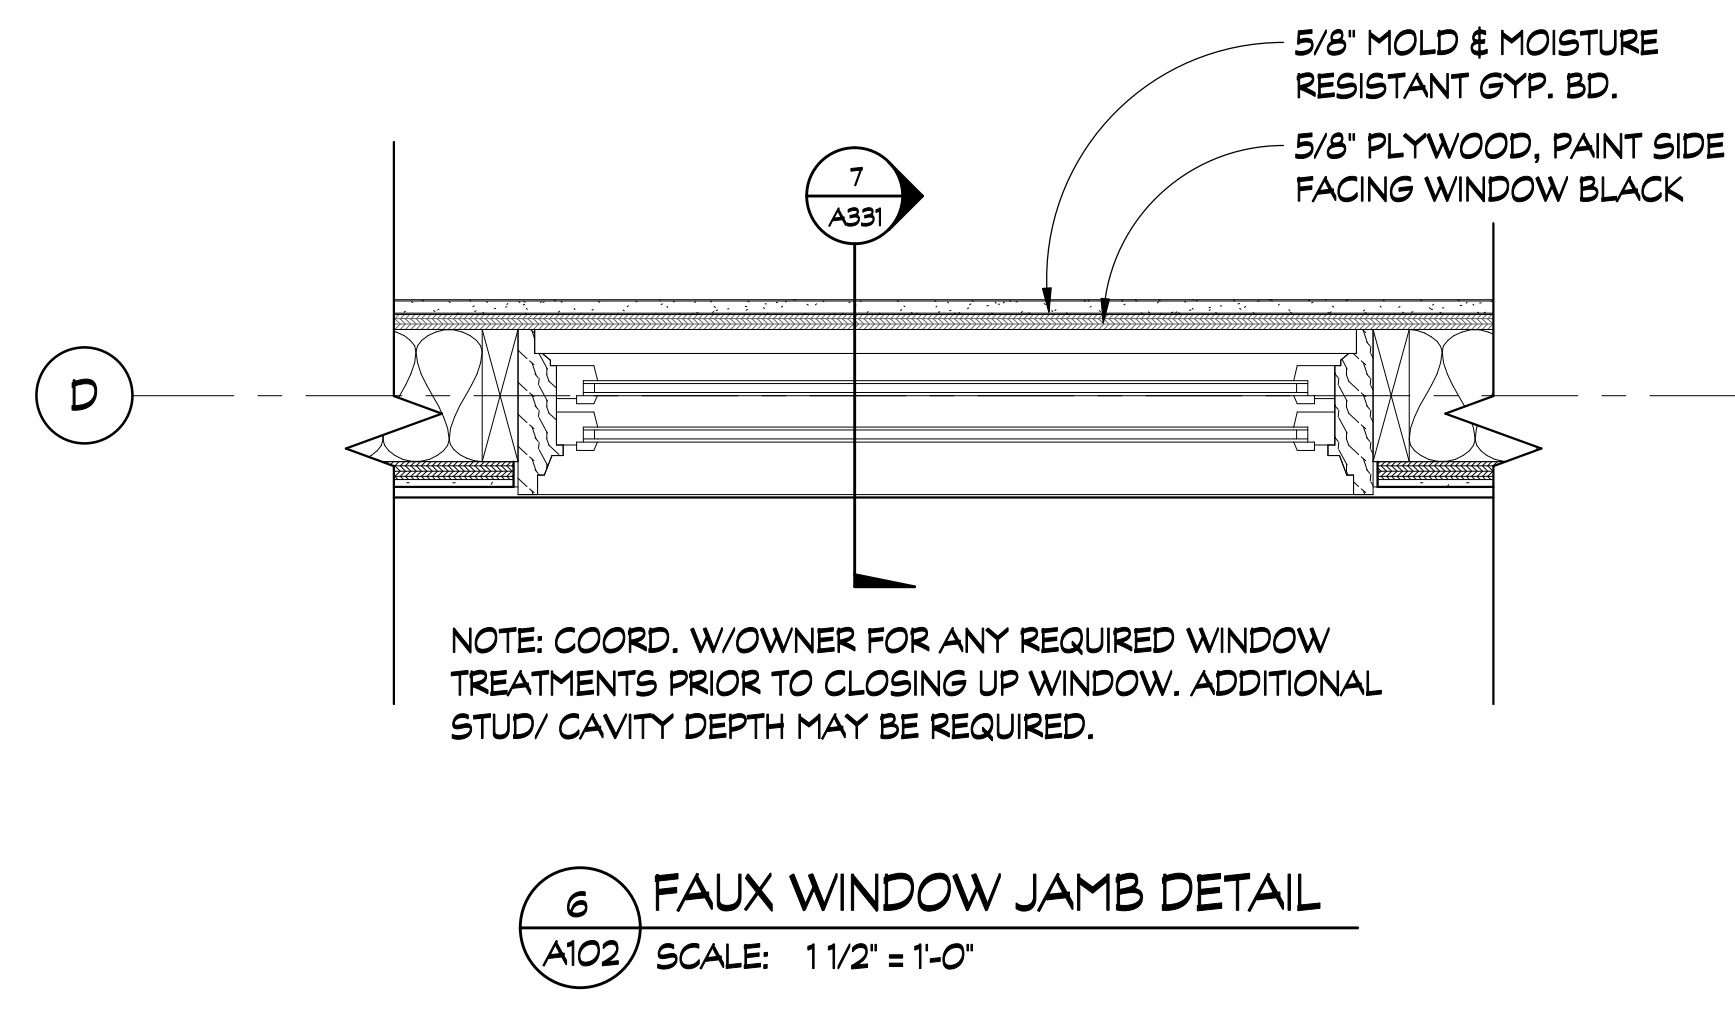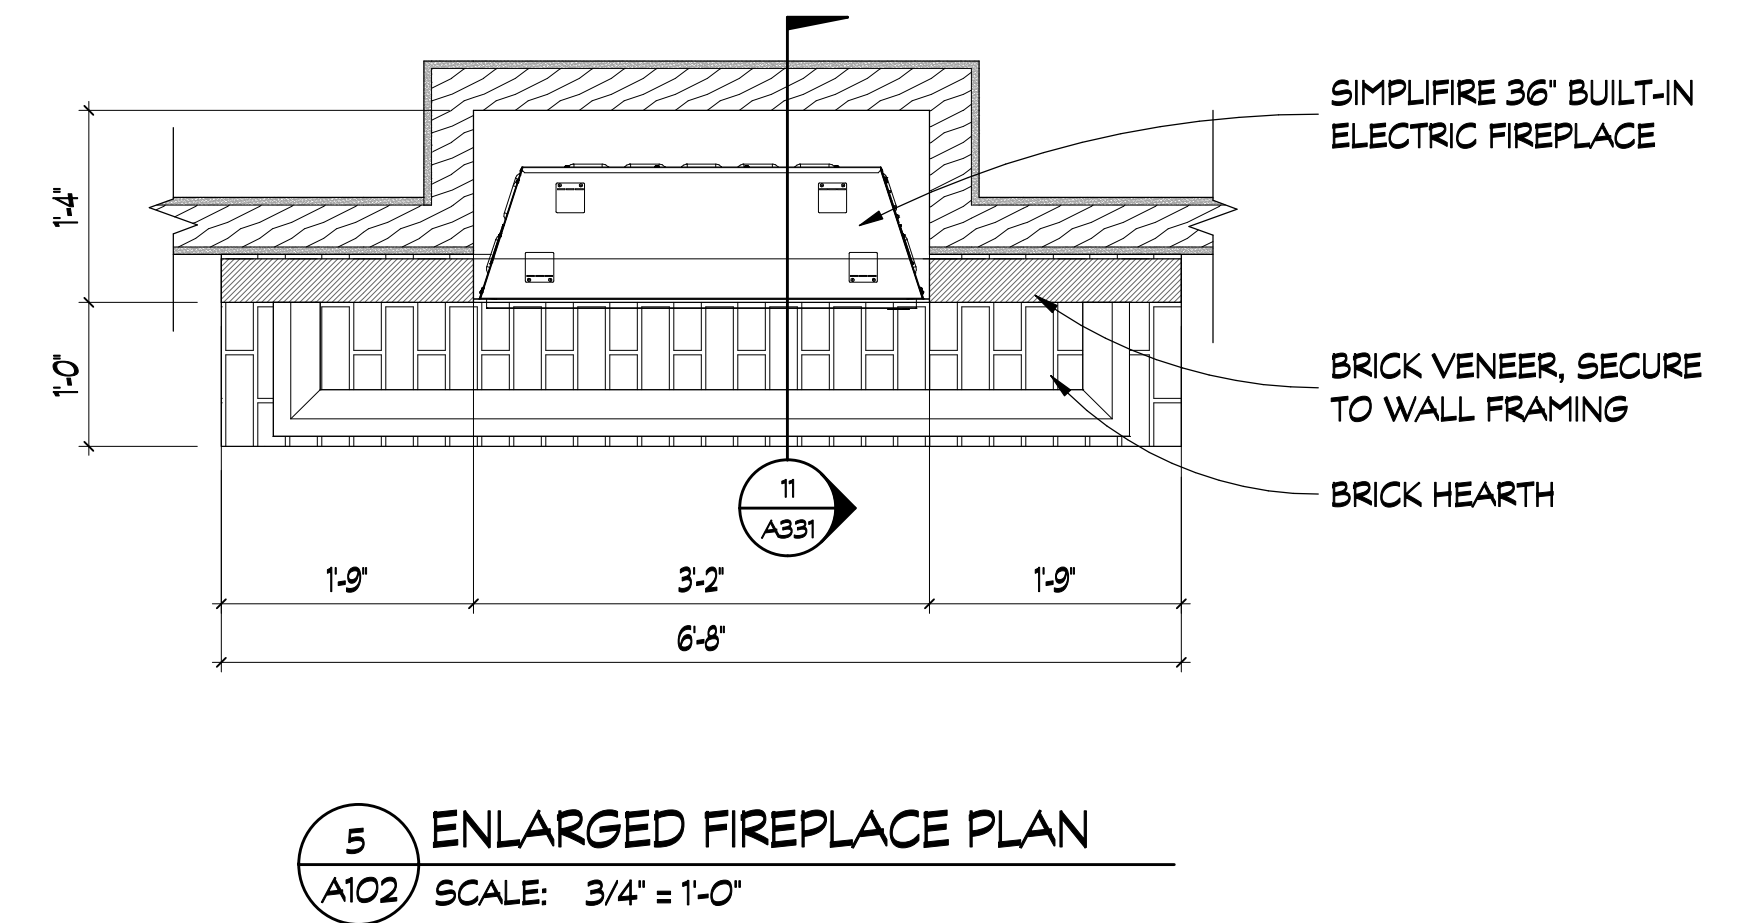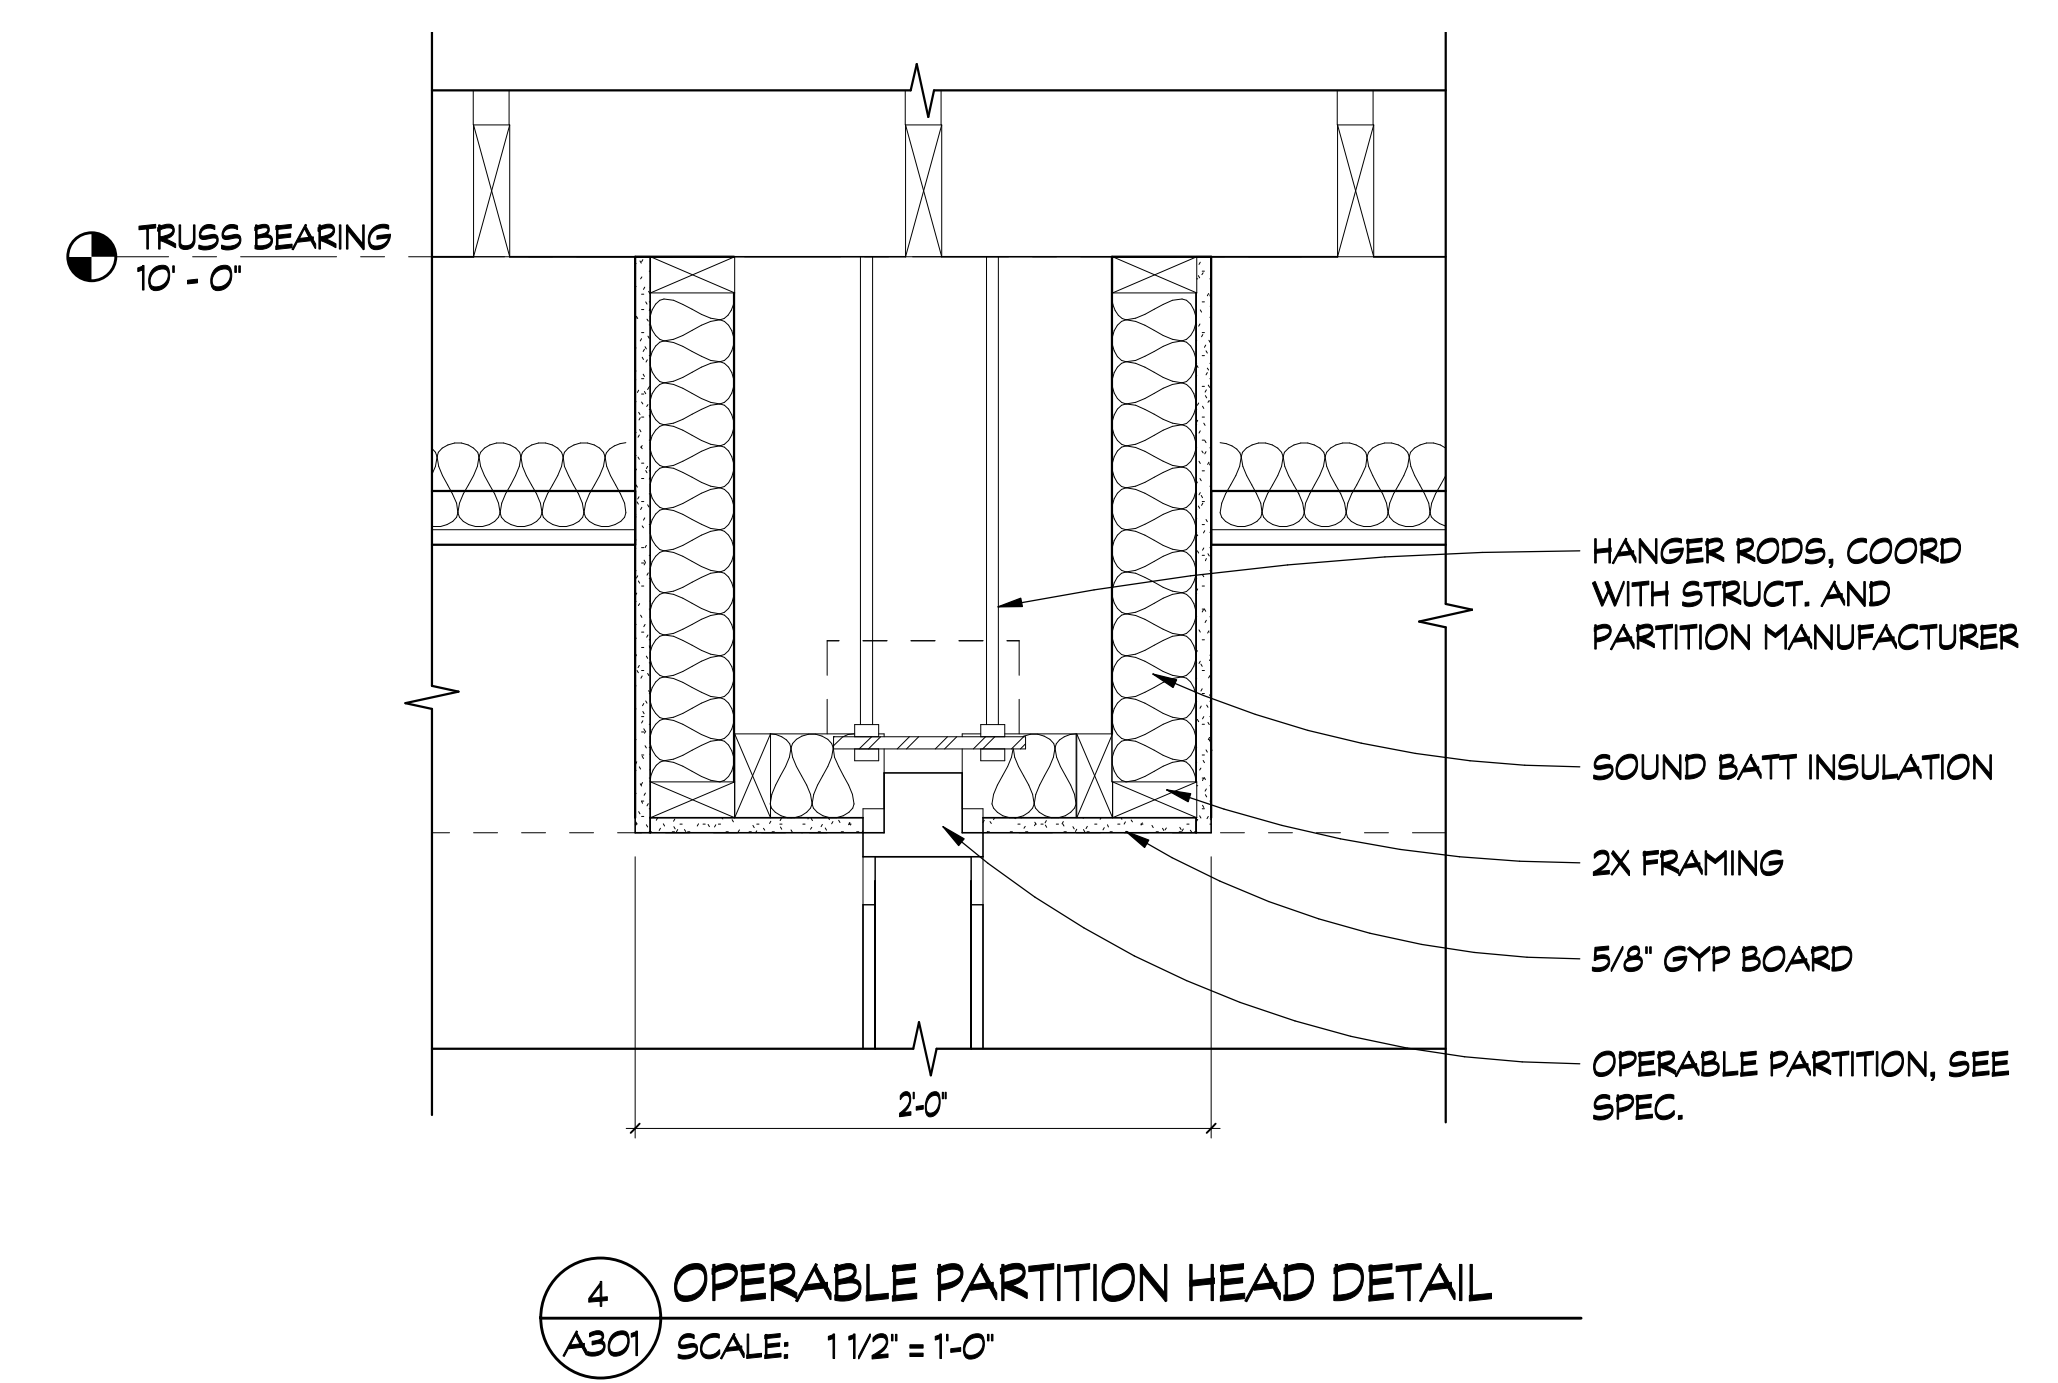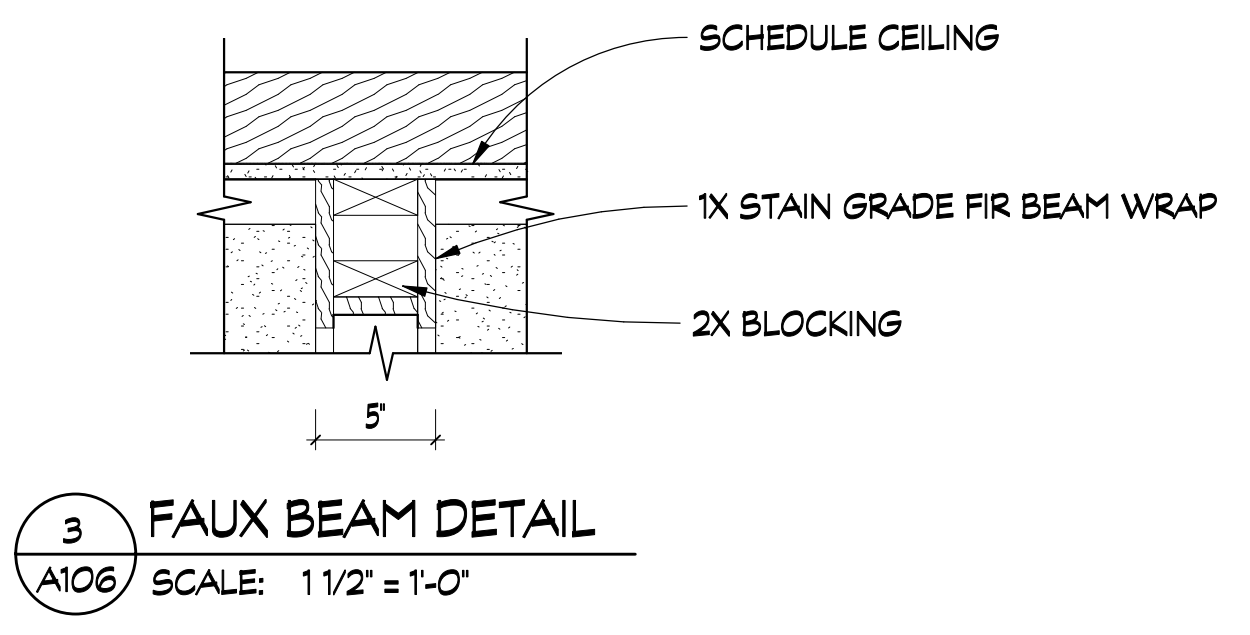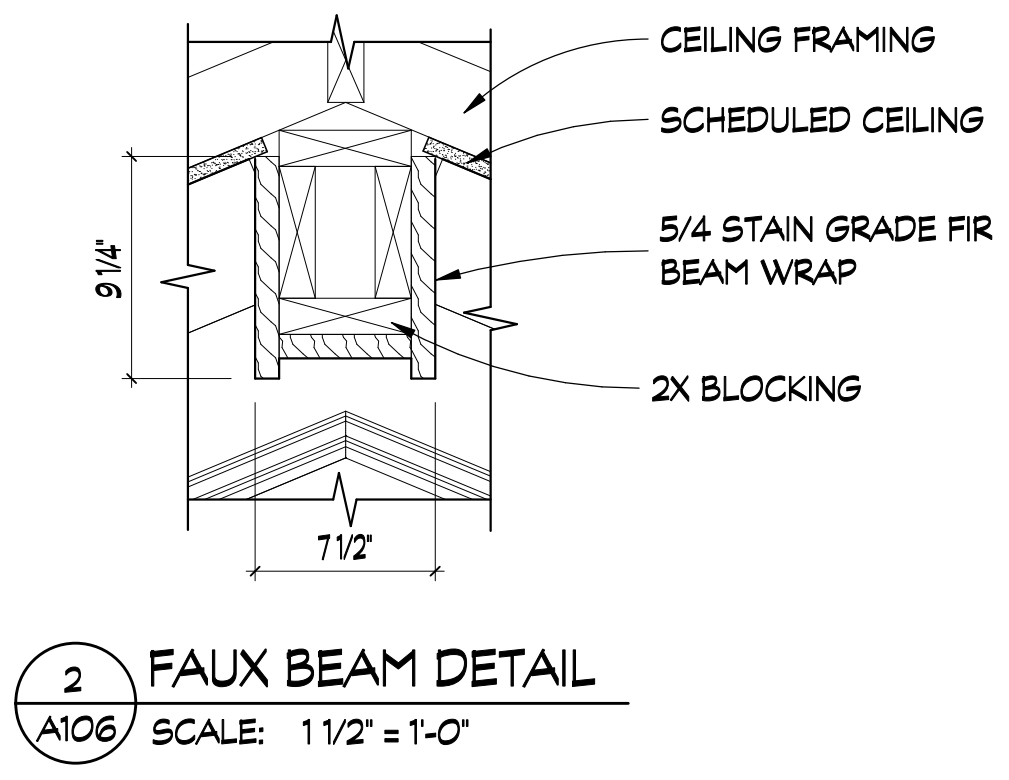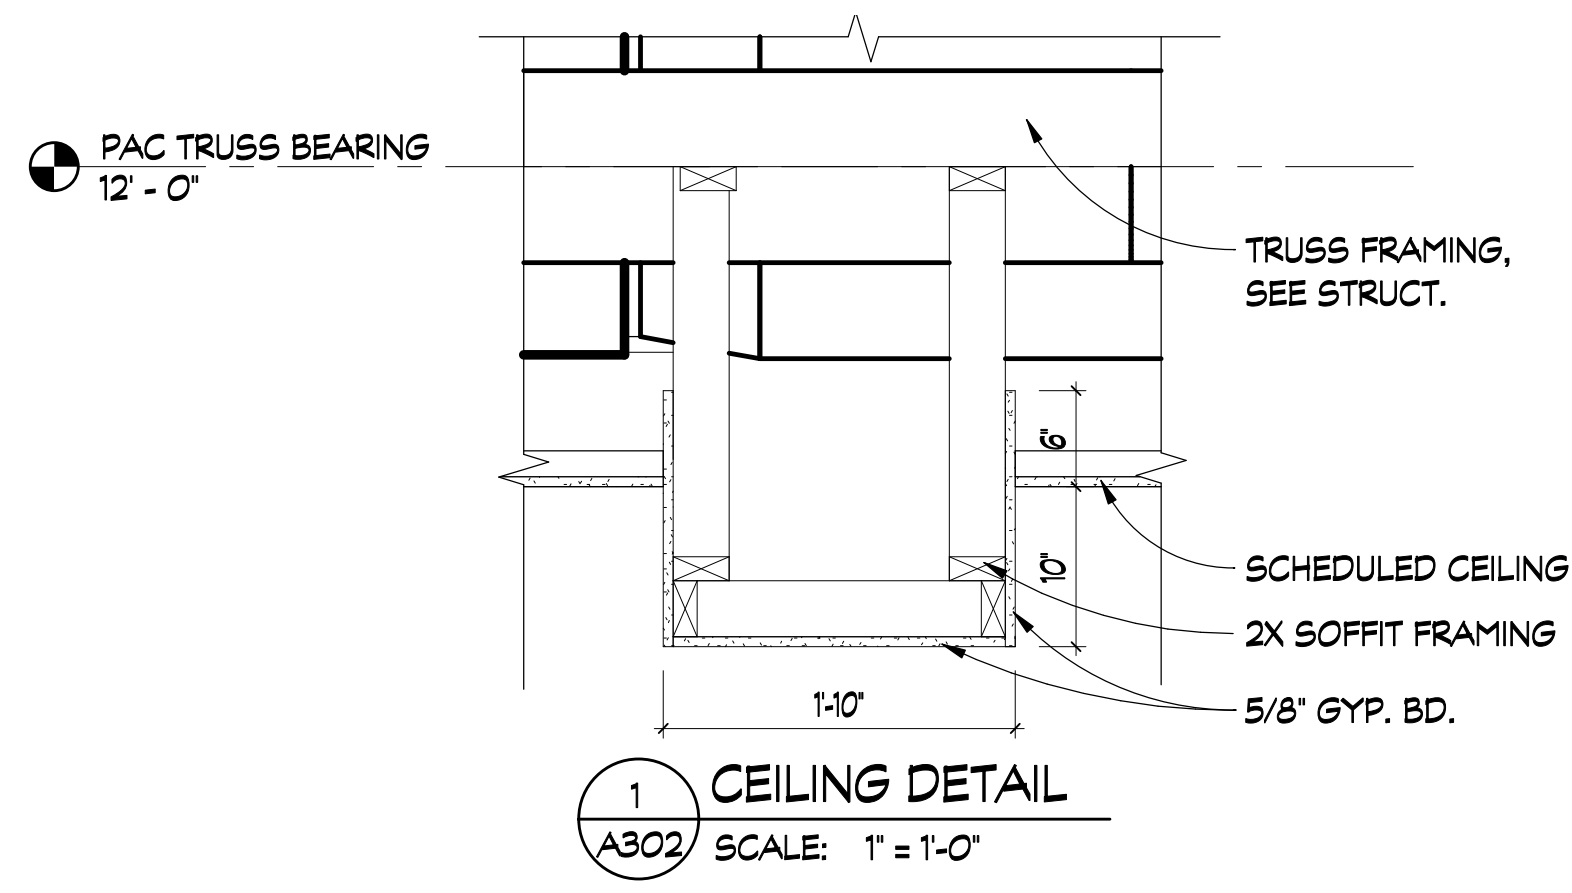


REVISIONS			
REV #	DATE	APPROV BY	REVISION
1	2/16/22	EA	ISSUE FOR PERMIT

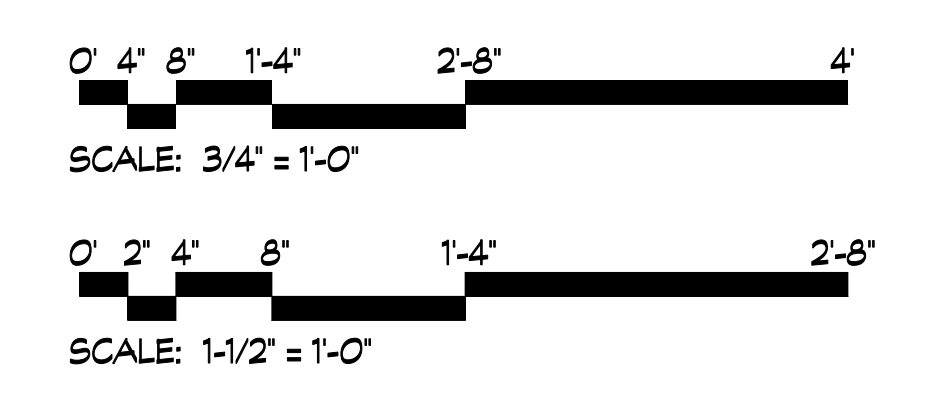


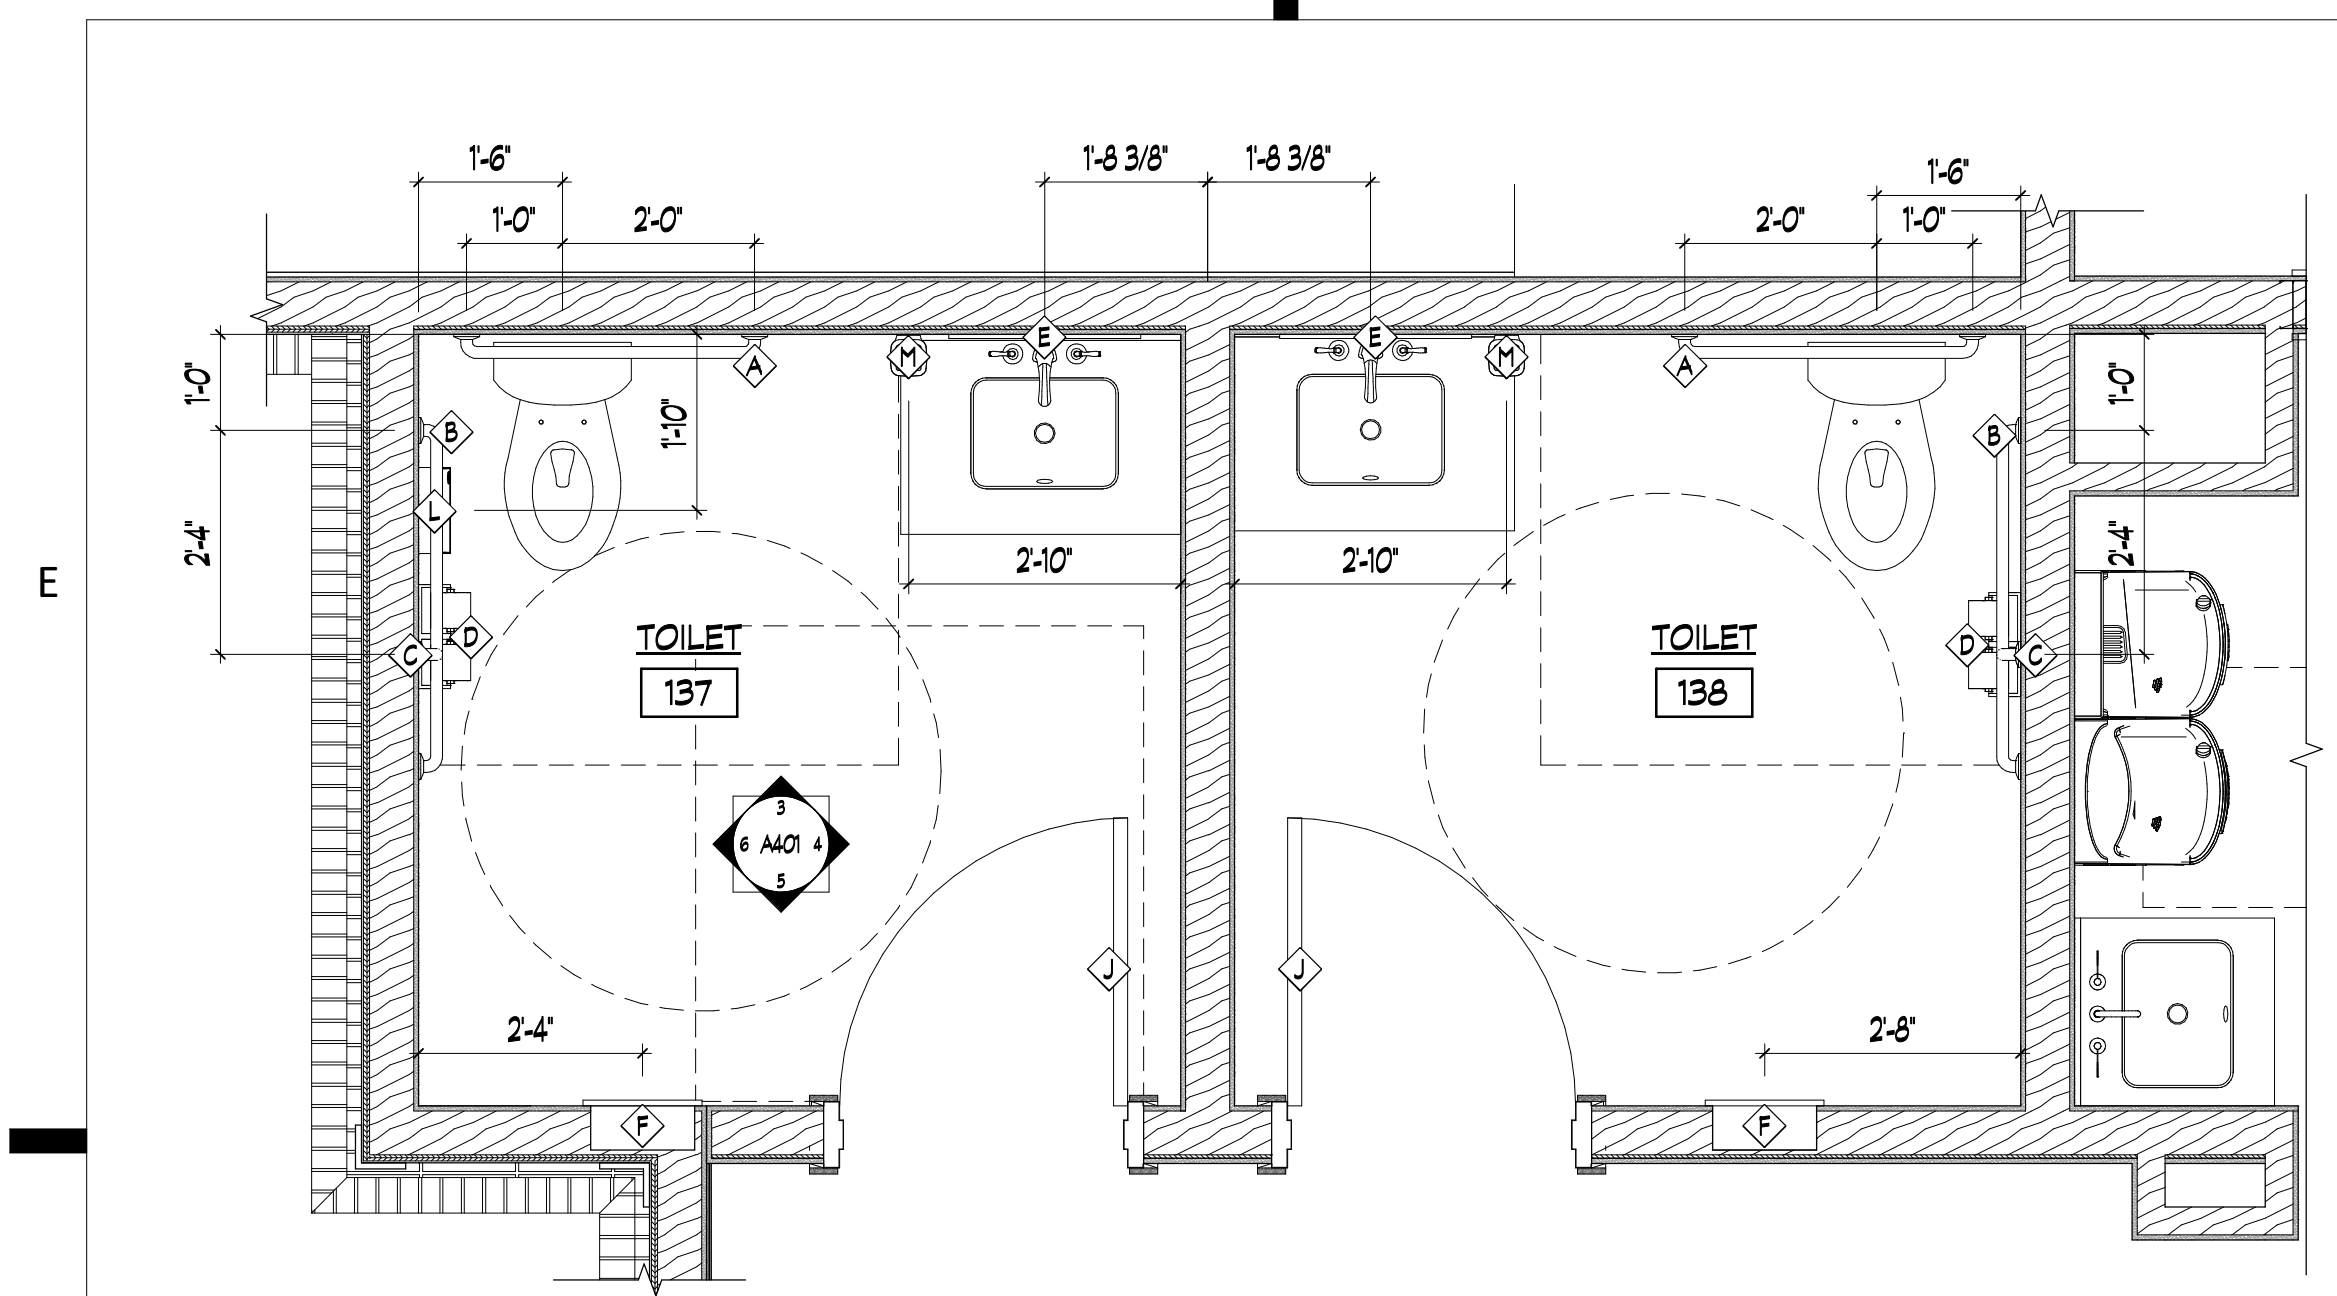


1 TOILET 137 & 138 PLAN
A102 SCALE: 1/2" = 1'-0"

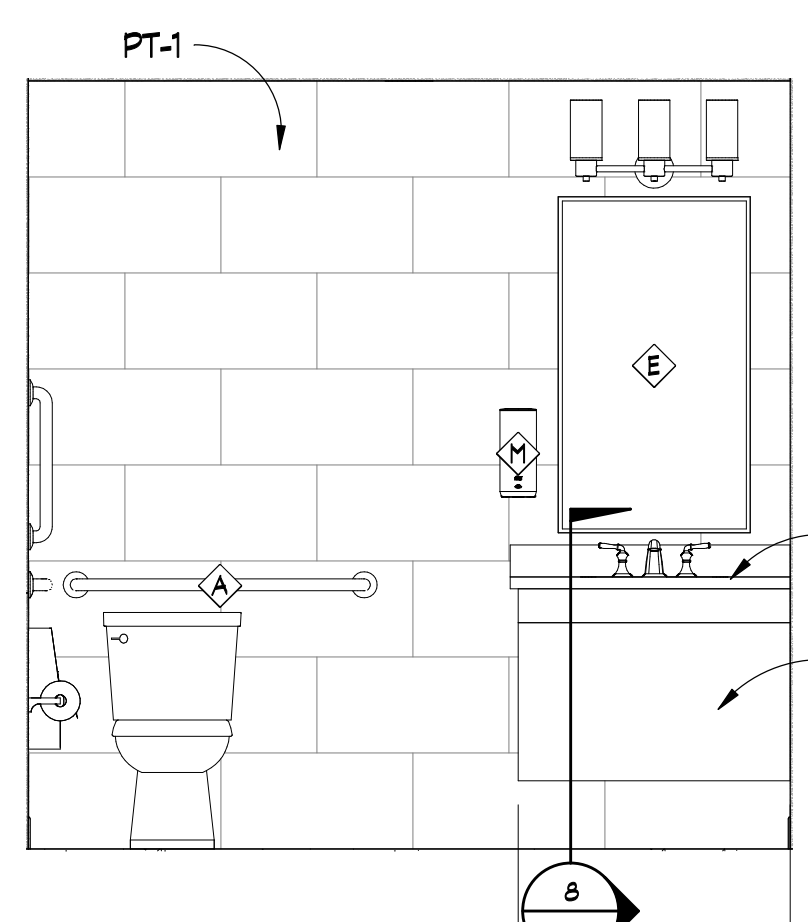


3 TOILET 137 & 138, TYP.
SCALE: 1/2" = 1'-0"

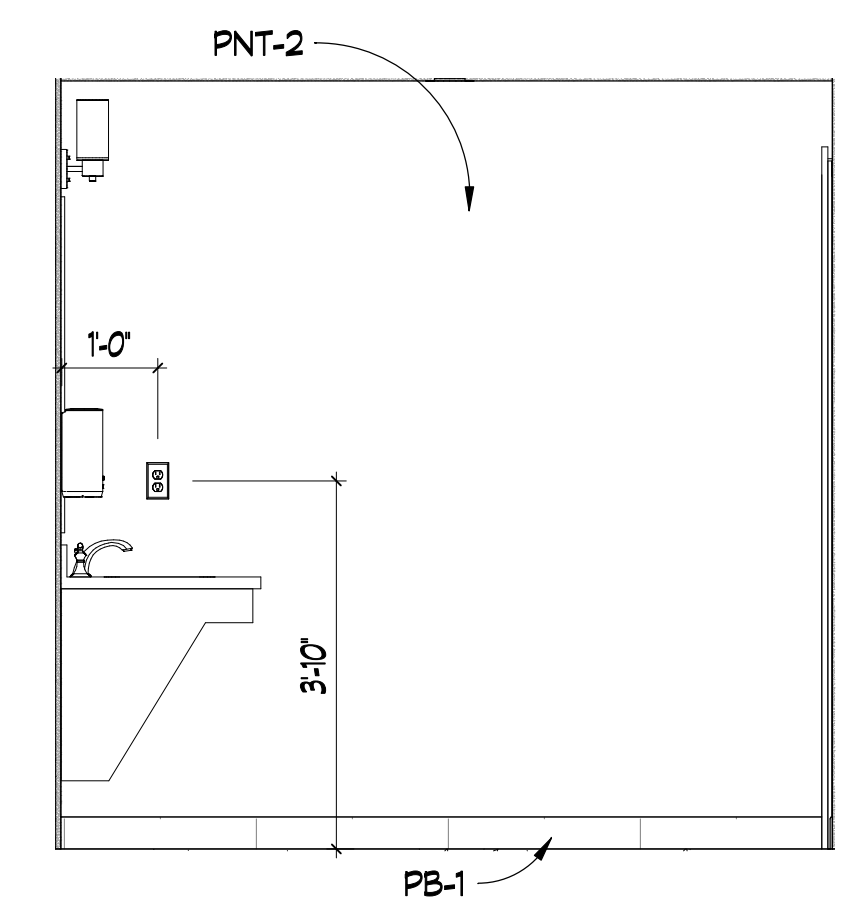


4 TOILET 137 & 138, TYP.
SCALE: 1/2" = 1'-0"

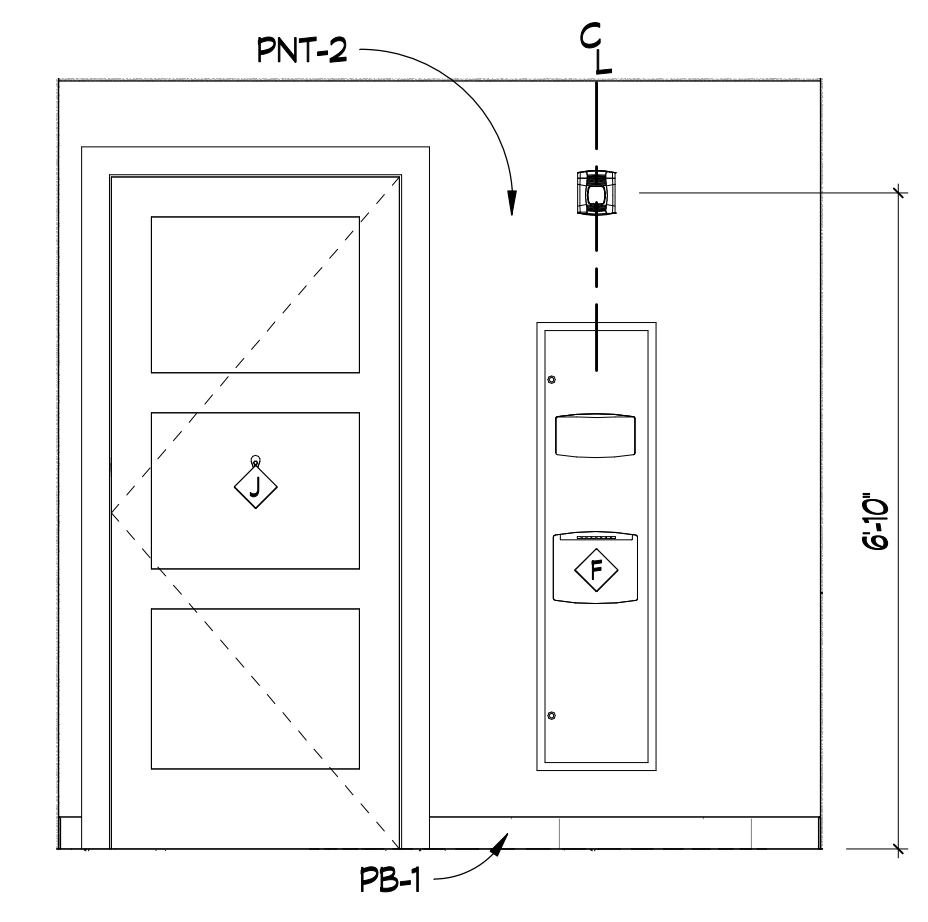


5 TOILET 137 & 138, TYP.
SCALE: 1/2" = 1'-0"

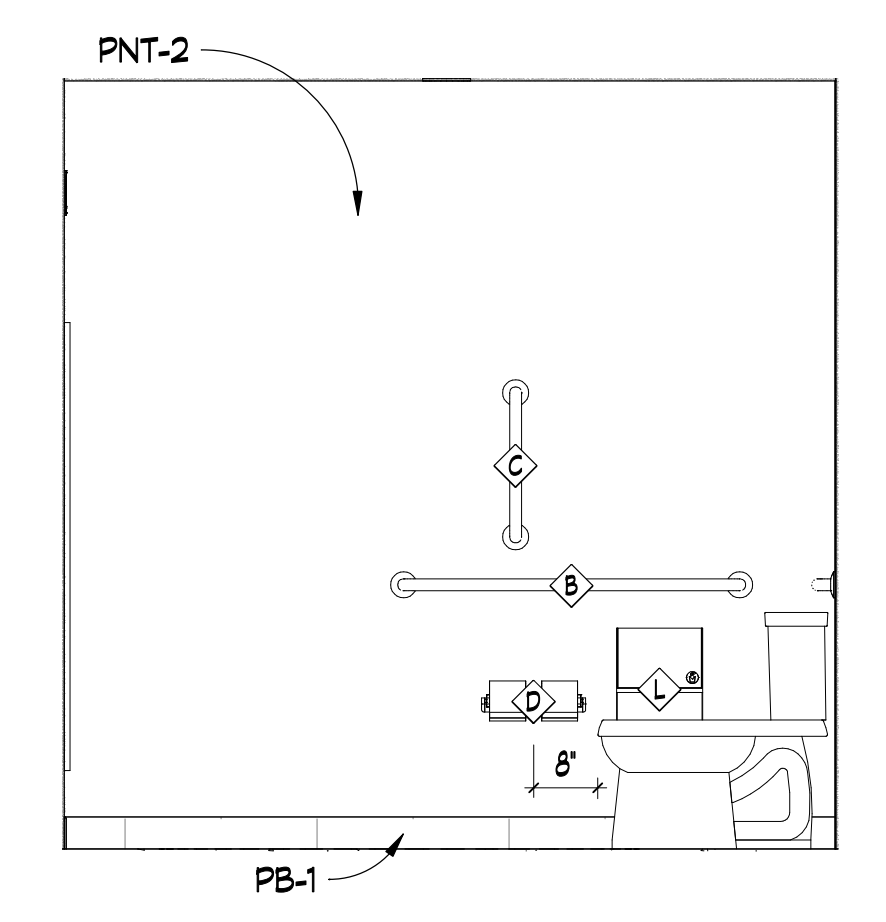


6 TOILET 137 & 138, TYP.
SCALE: 1/2" = 1'-0"

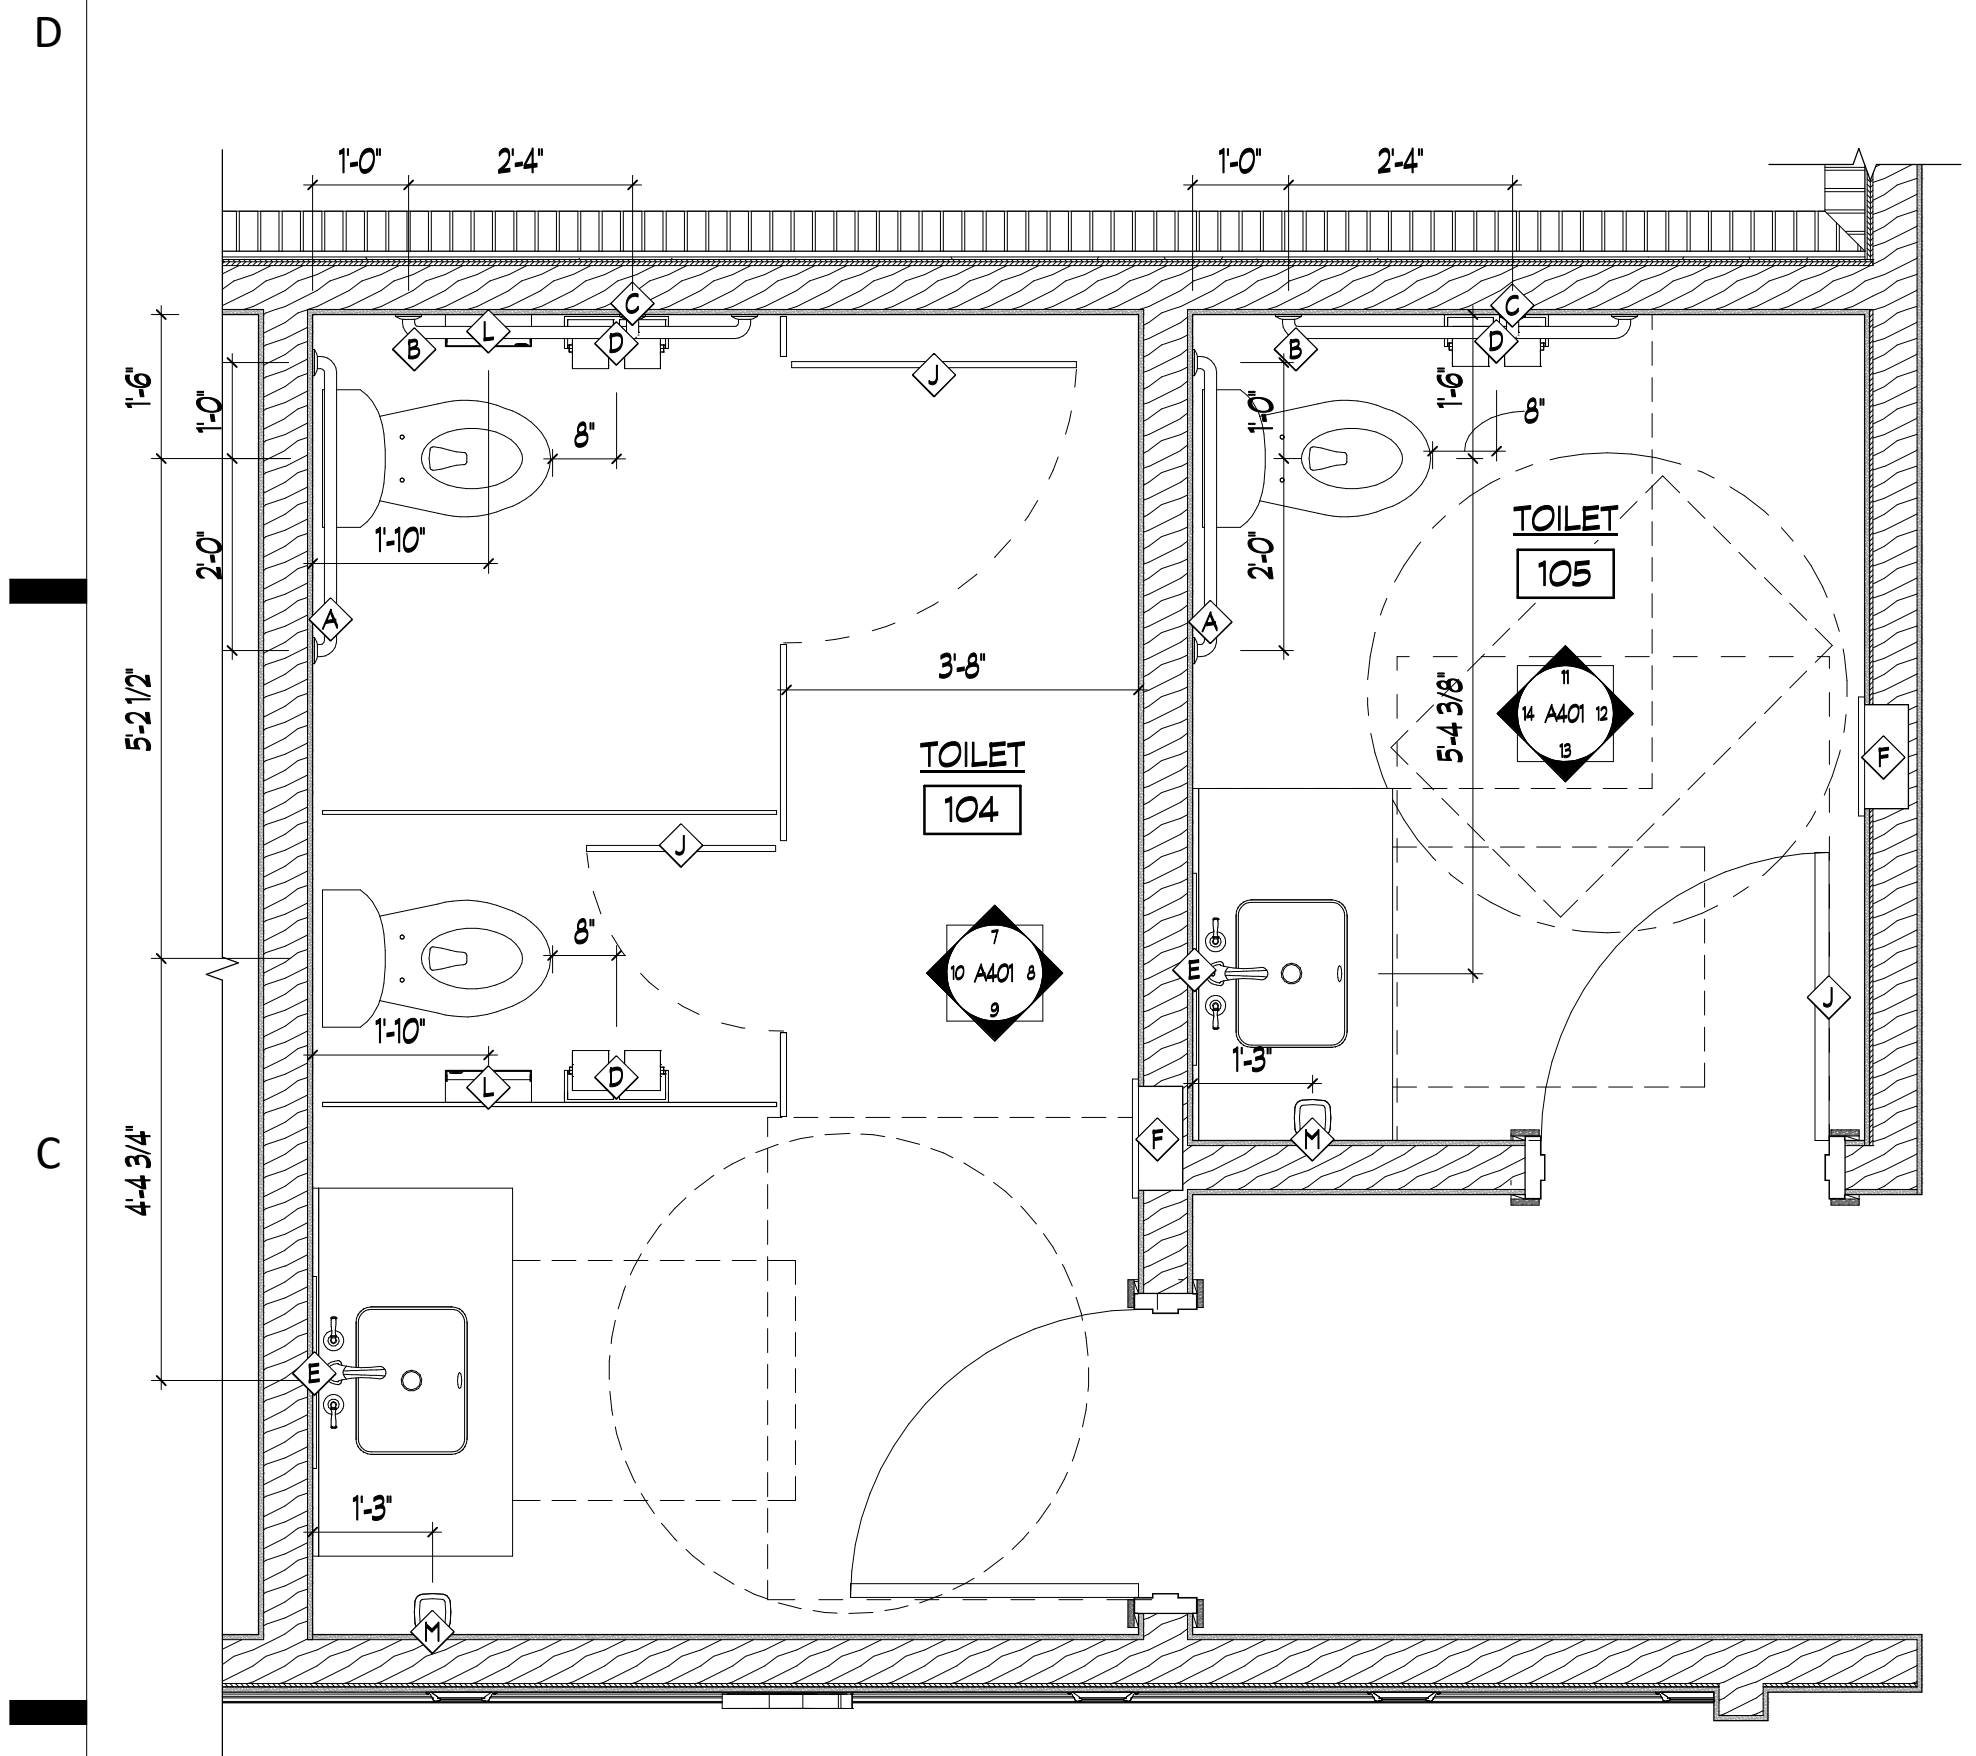


2 TOILET 104 & 105 PLAN
A102 SCALE: 1/2" = 1'-0"

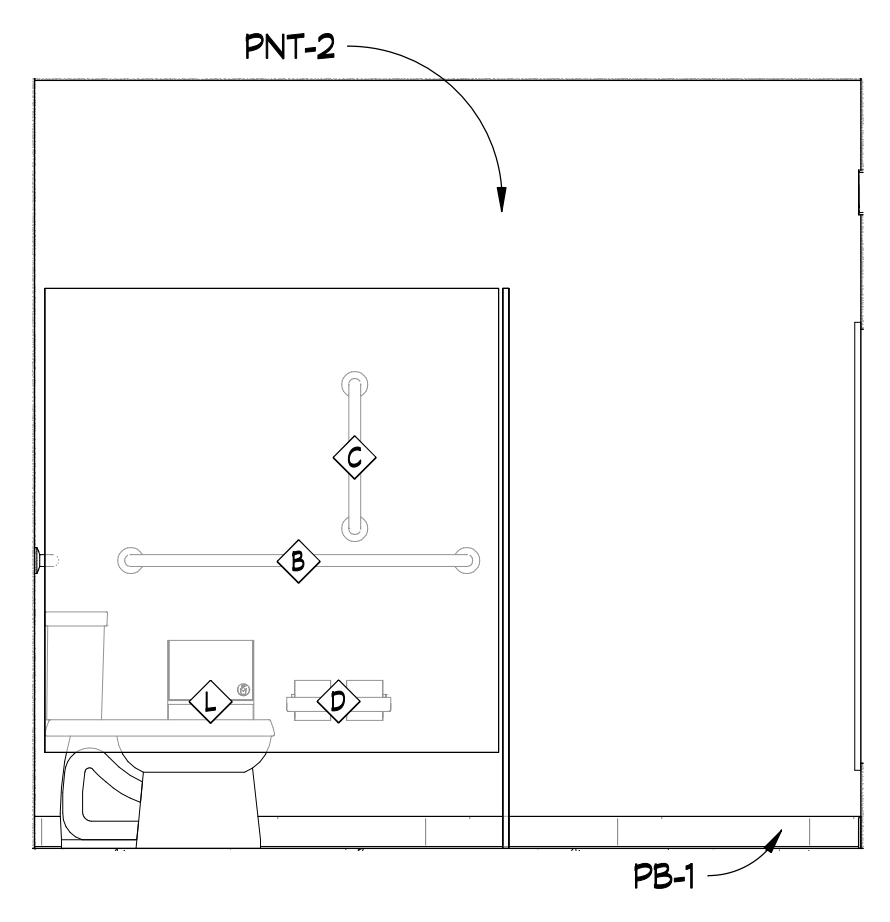


7 TOILET 104
SCALE: 1/2" = 1'-0"

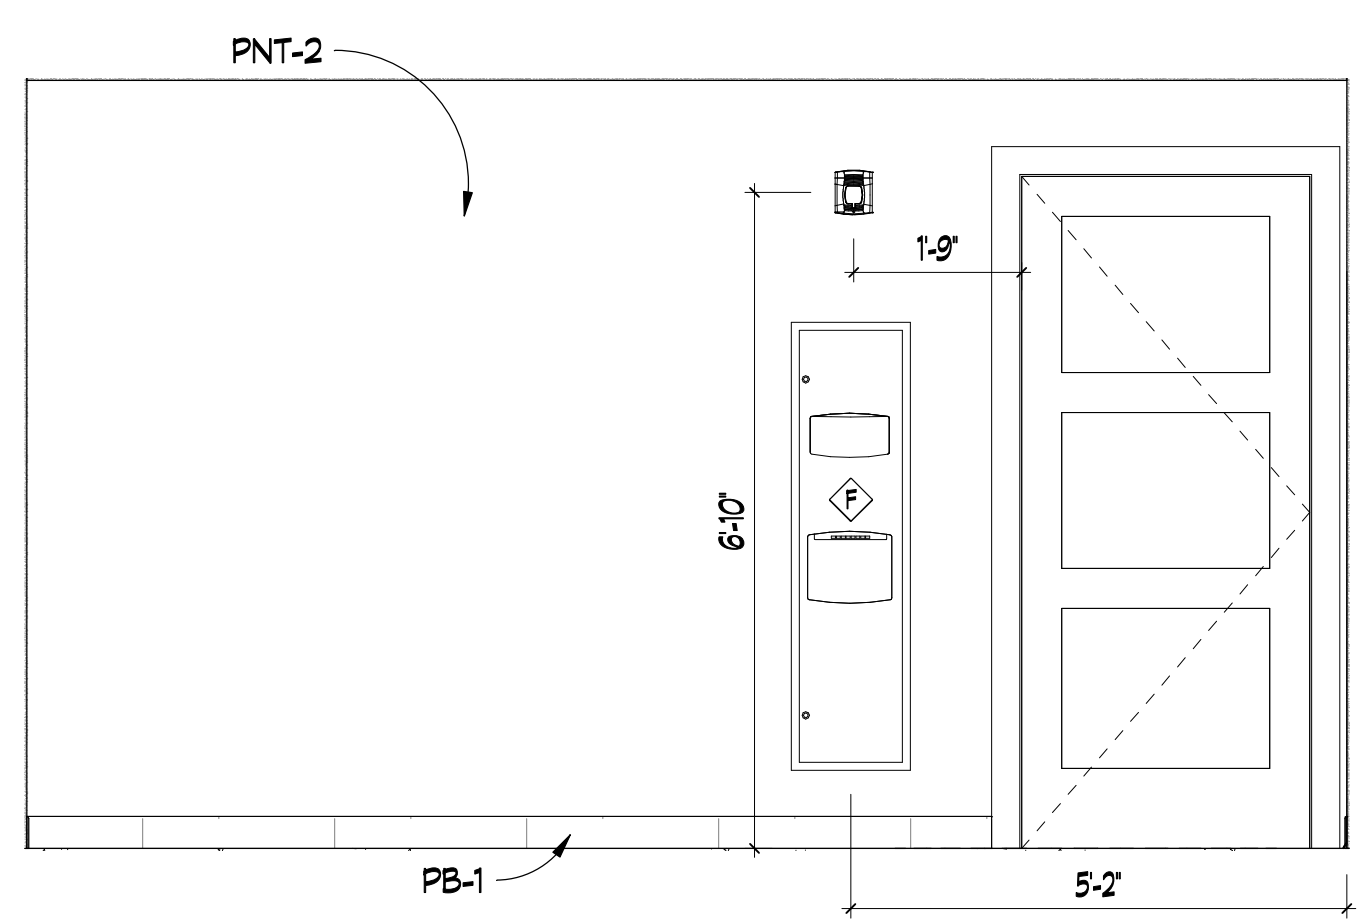


8 TOILET 104
SCALE: 1/2" = 1'-0"

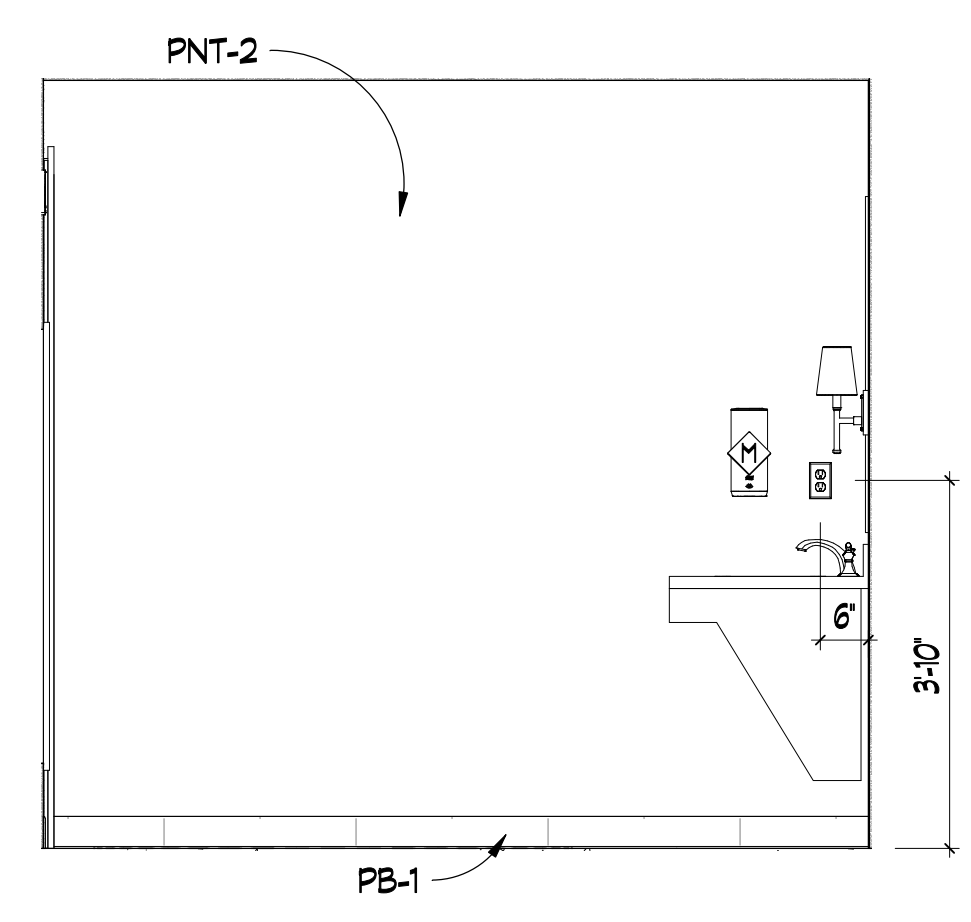


9 TOILET 104
SCALE: 1/2" = 1'-0"

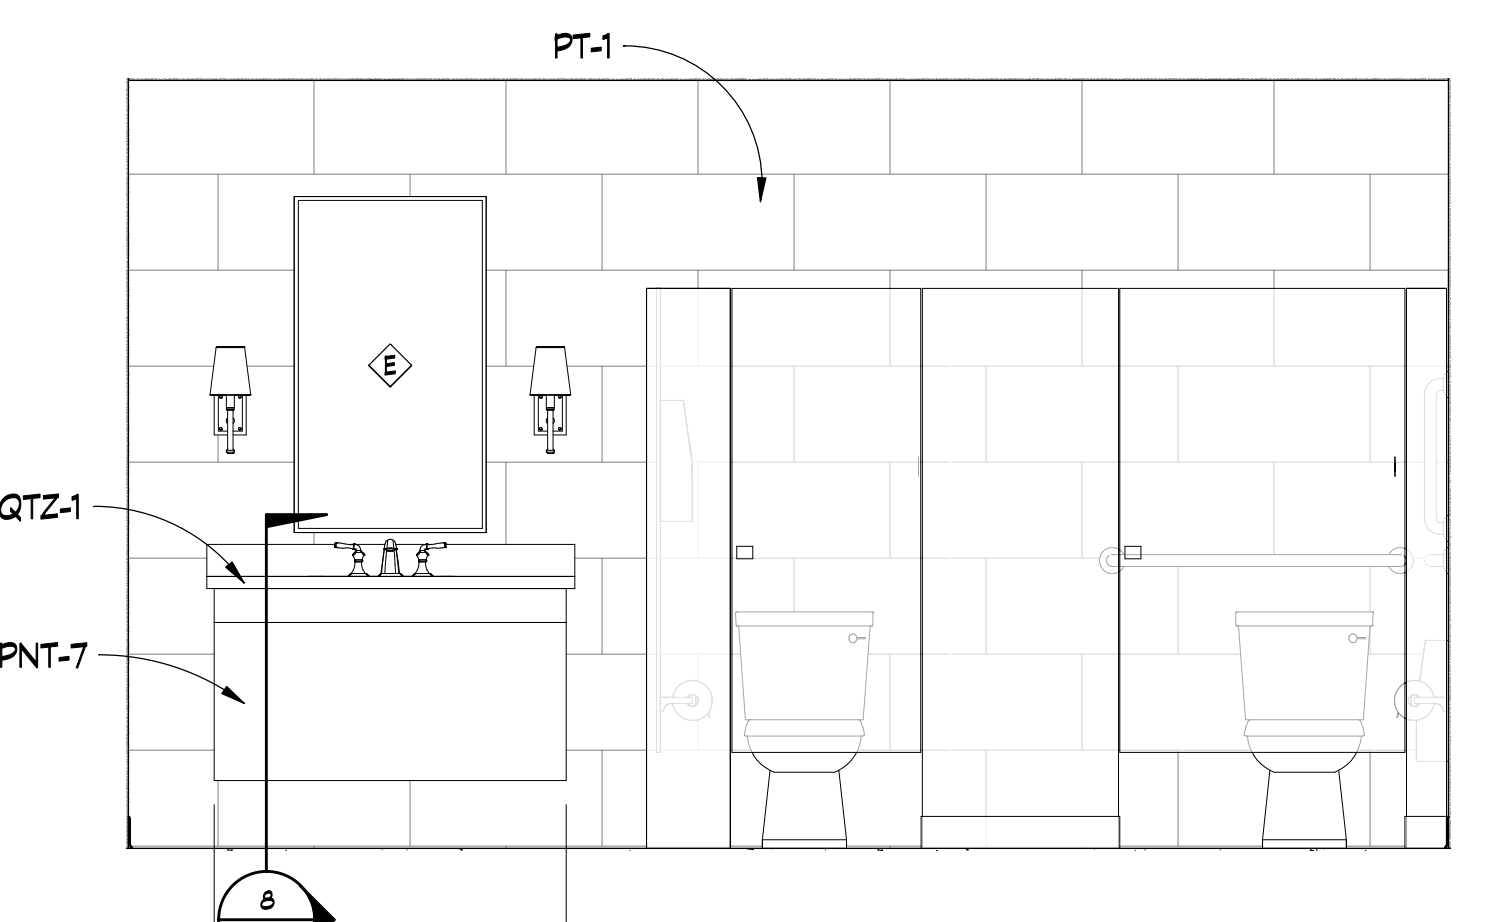


10 TOILET 104
SCALE: 1/2" = 1'-0"

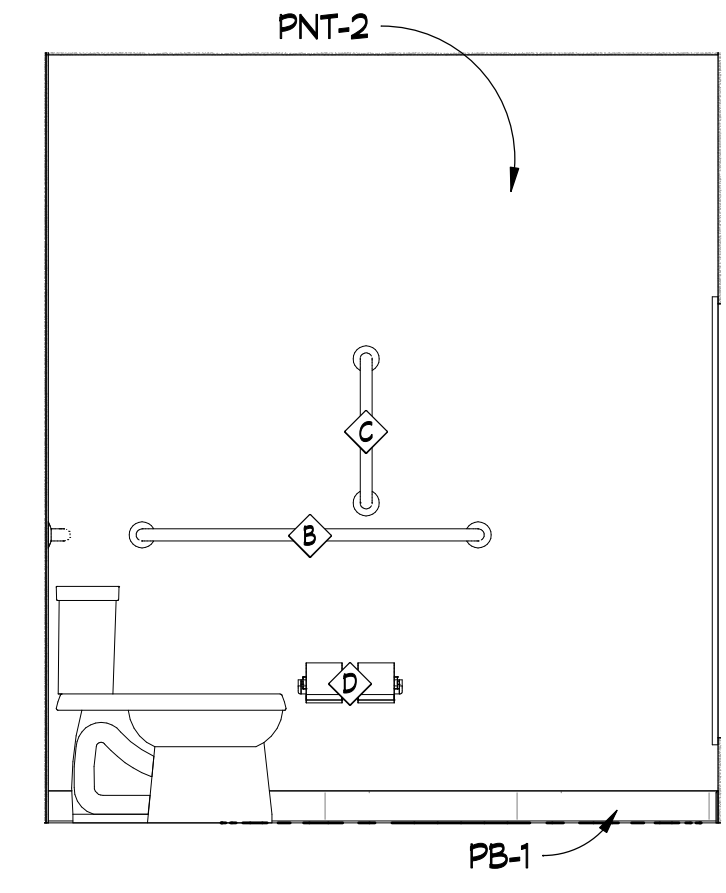


11 TOILET 105
SCALE: 1/2" = 1'-0"

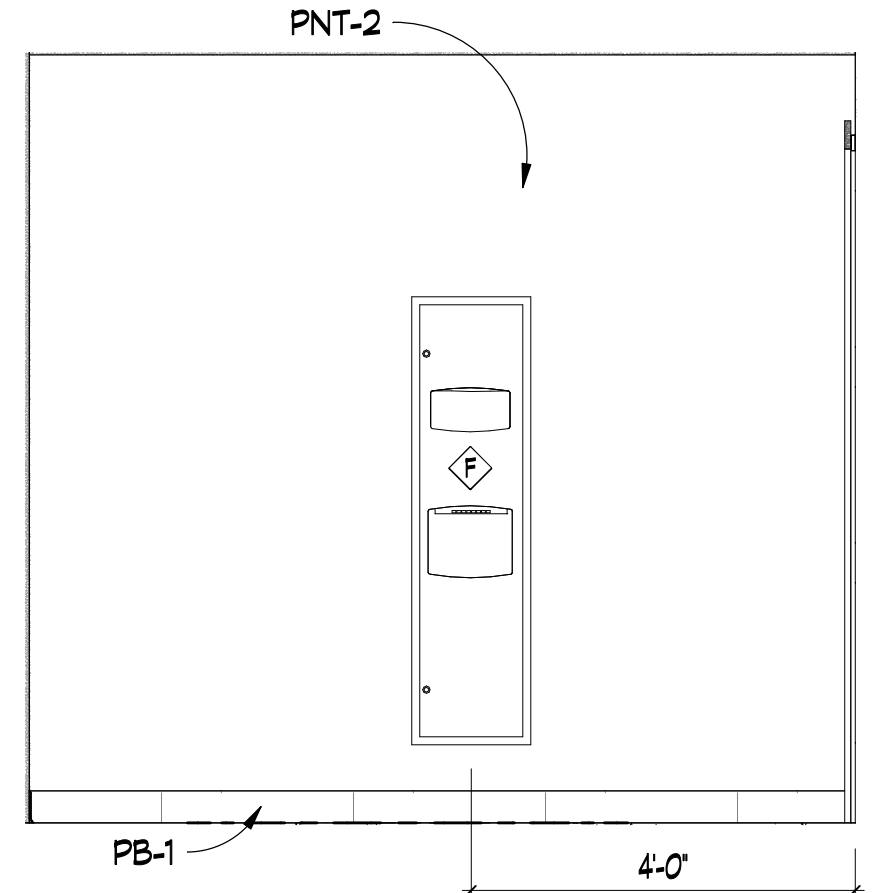

12 TOILET 105
SCALE: 1/2" = 1'-0"

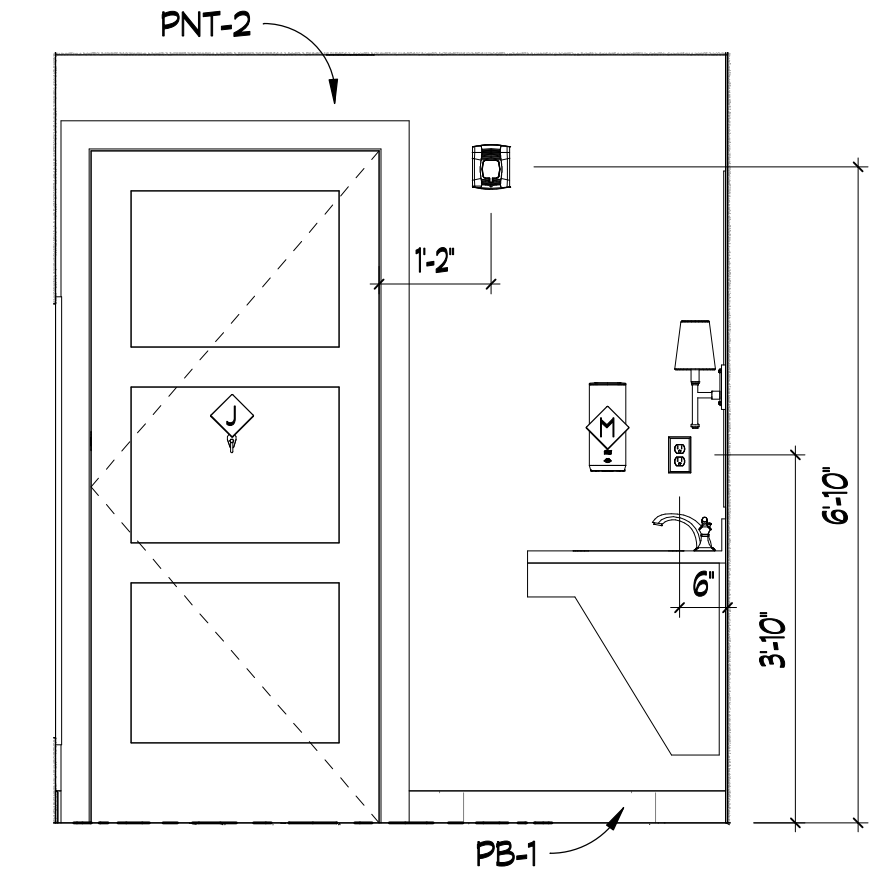



13 TOILET 105
SCALE: 1/2" = 1'-0"

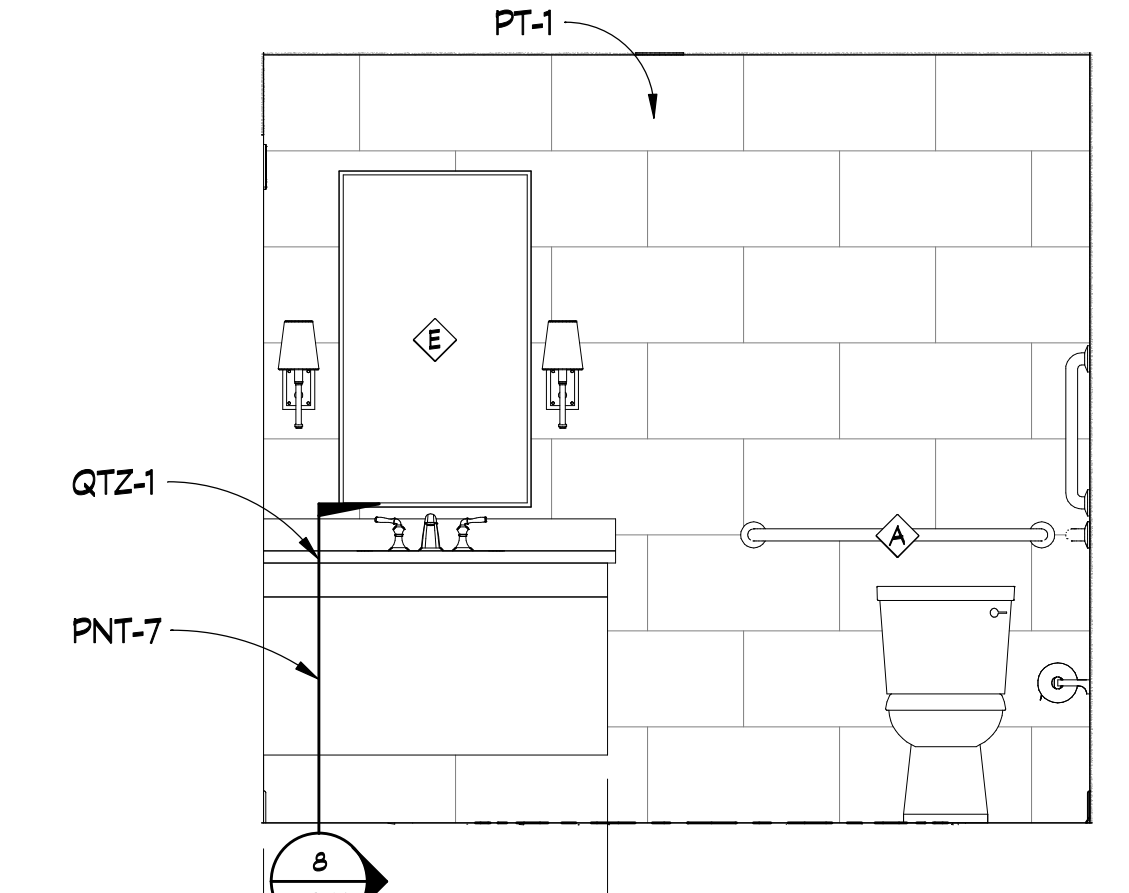

14 TOILET 105
SCALE: 1/2" = 1'-0"


TOILET ACCESSORY SCHEDULE			
	MANUFACTURER	DESCRIPTION	MODEL
A	WINGITS	MODERN ELEGANCE 36" GRAB BAR	WGB5MESN36
B	WINGITS	MODERN ELEGANCE 42" GRAB BAR	WGB5MESN42
C	WINGITS	MODERN ELEGANCE 18" GRAB BAR	WGB5MESN18
D	WINGITS	MODERN ELEGANCE DOUBLE TOILET PAPER HOLDER	WMEDPHSN
E	LAMPS PLUS	HELENA ANTIQUE SILVER 25" X 42" WALL MIRROR	47A99
F	BRADLEY CORPORATION	PAPER TOWEL DISPENSER / WASTE BIN	270-000000
G	WINGITS	MODERN ELEGANCE 24" GRAB BAR	WGB5MESN24
H	WINGITS	MODERN ELEGANCE 54" GRAB BAR	WGB5MESN54
J	WINGITS	MODERN ELEGANCE ROBE HOOK	WMESRHSN
K	INPRO CORP	SHOWER CURTAIN W/ TRACK	SEE A801 FOR INFO
L	BRADLEY CORPORATION	NAPKIN DISPOSAL, 15 GALLONS, SURFACE-MOUNTED	4722-150000
M	TORK	FOAM SOAP DISPENSER W/ INTUITION SENSOR, STAINLESS STEEL	466100
N	BRADLEY CORPORATION	UTILITY SHELF, 4 HOOKS / 3 HOLDERS	9933

TYP. TOILET ACCESSORY MOUNTING HEIGHTS

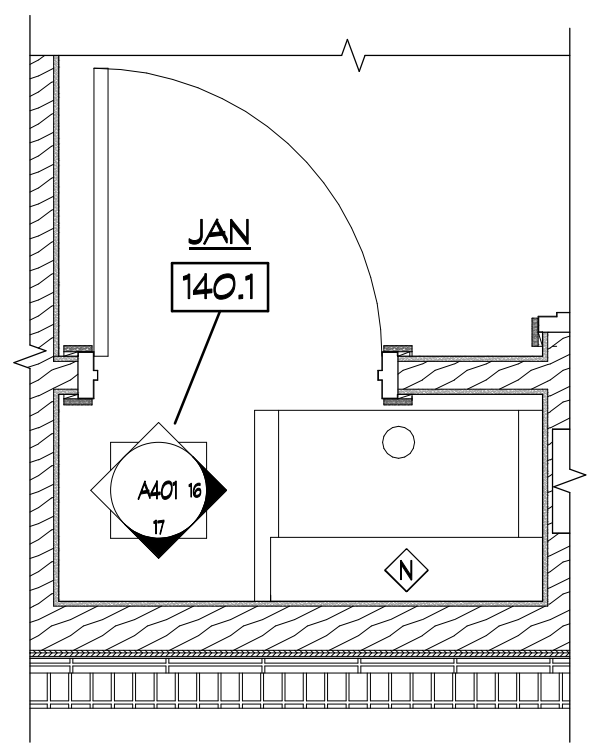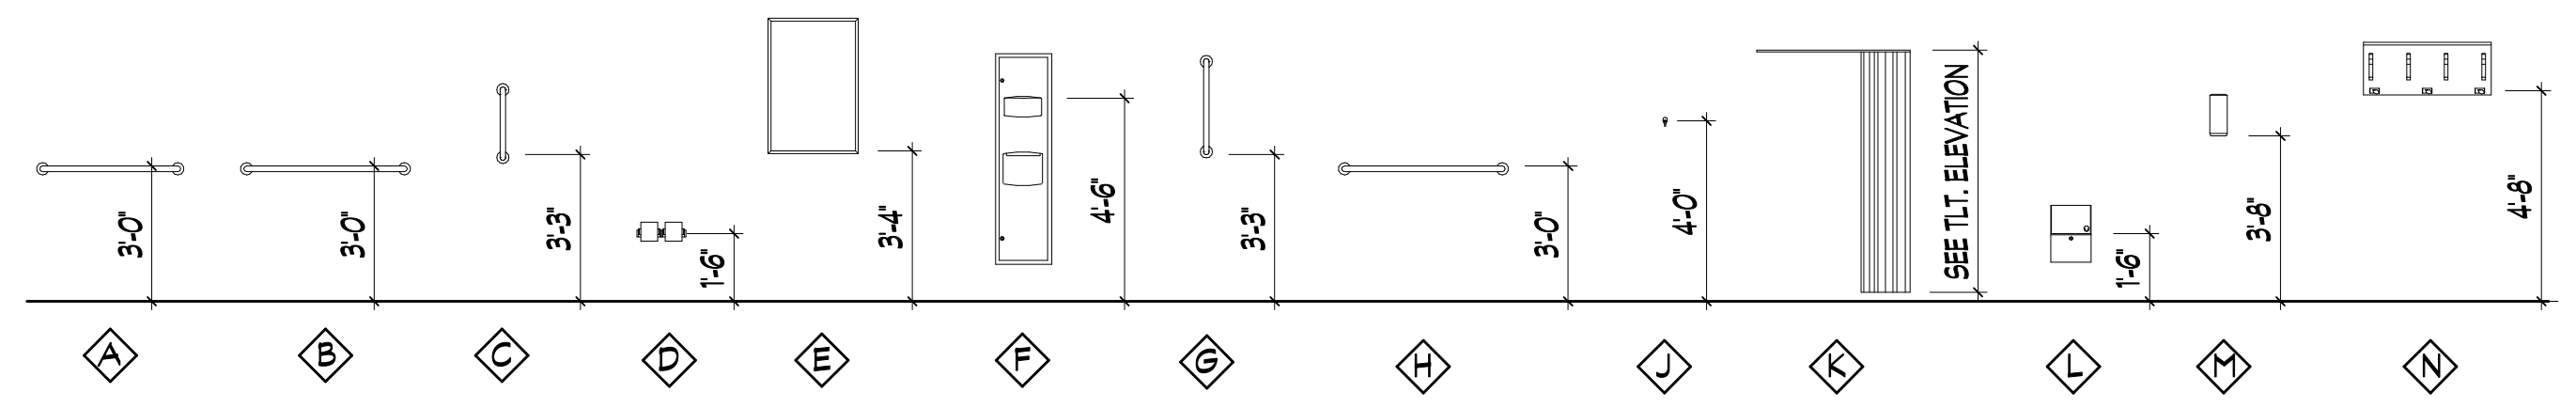


NOTE: FRP & MOP/BROOM HOLDER TYP. ALL JANITOR CLOSETS


15 JAN. CLST., TYP.
A102 SCALE: 1/2" = 1'-0"

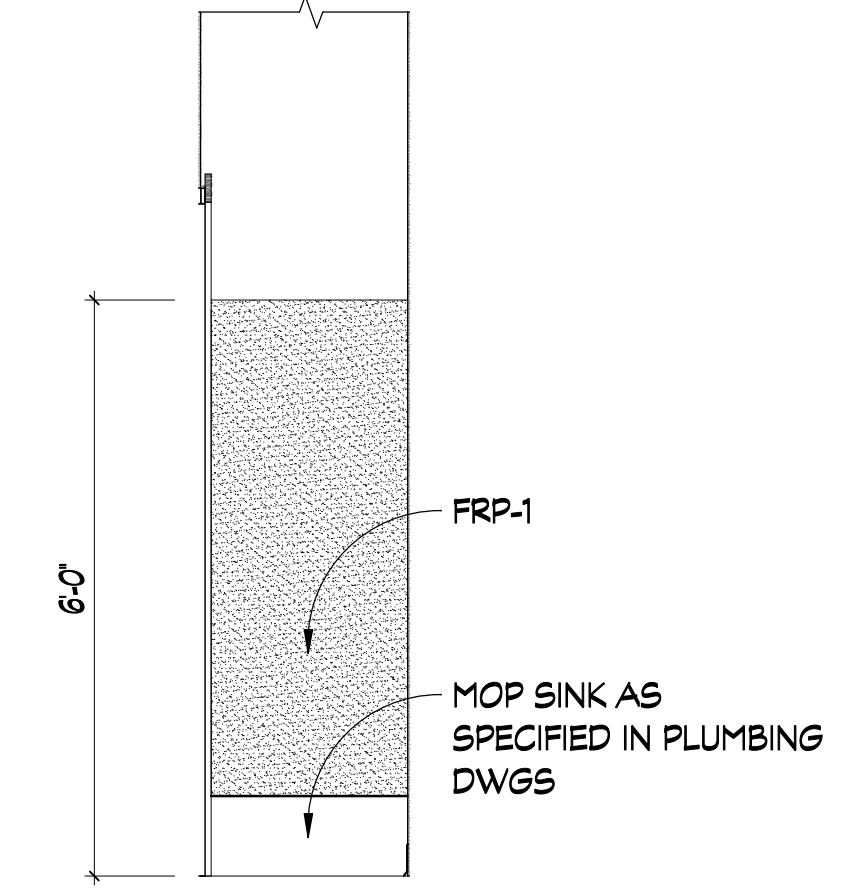


16 JAN. CLST., TYP.
SCALE: 1/2" = 1'-0"

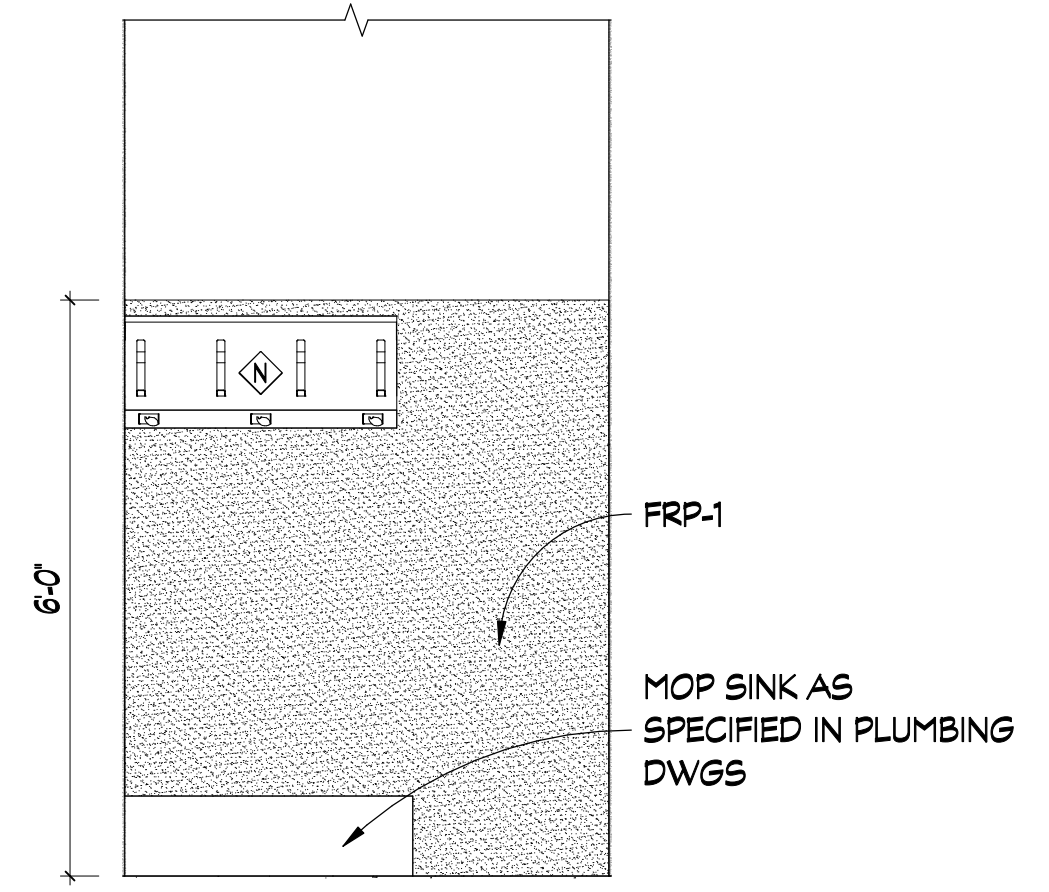

17 JAN. CLST., TYP.
SCALE: 1/2" = 1'-0"

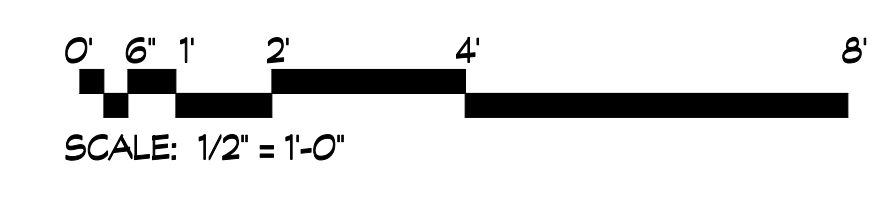

REVISIONS			
REV #	DATE	APPROV	REVISION
1	11/17/21	EA	65% SET
2	2/16/22	EA	ISSUE FOR PERMIT









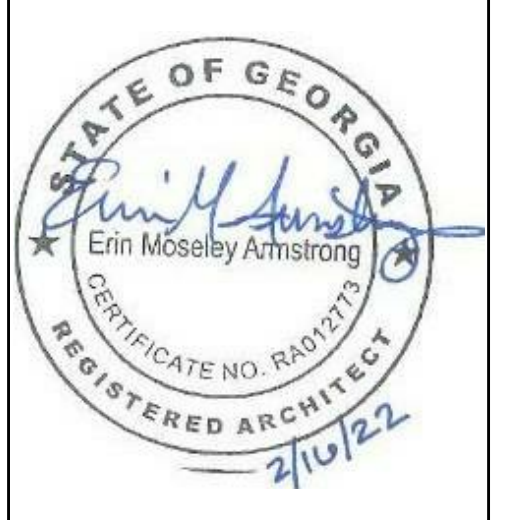


DA PROJECT NUMBER & NAME:
1893

DRAWING TITLE:
**ENLARGED
TOILET
PLANS**

DRAWING NO.:







A401

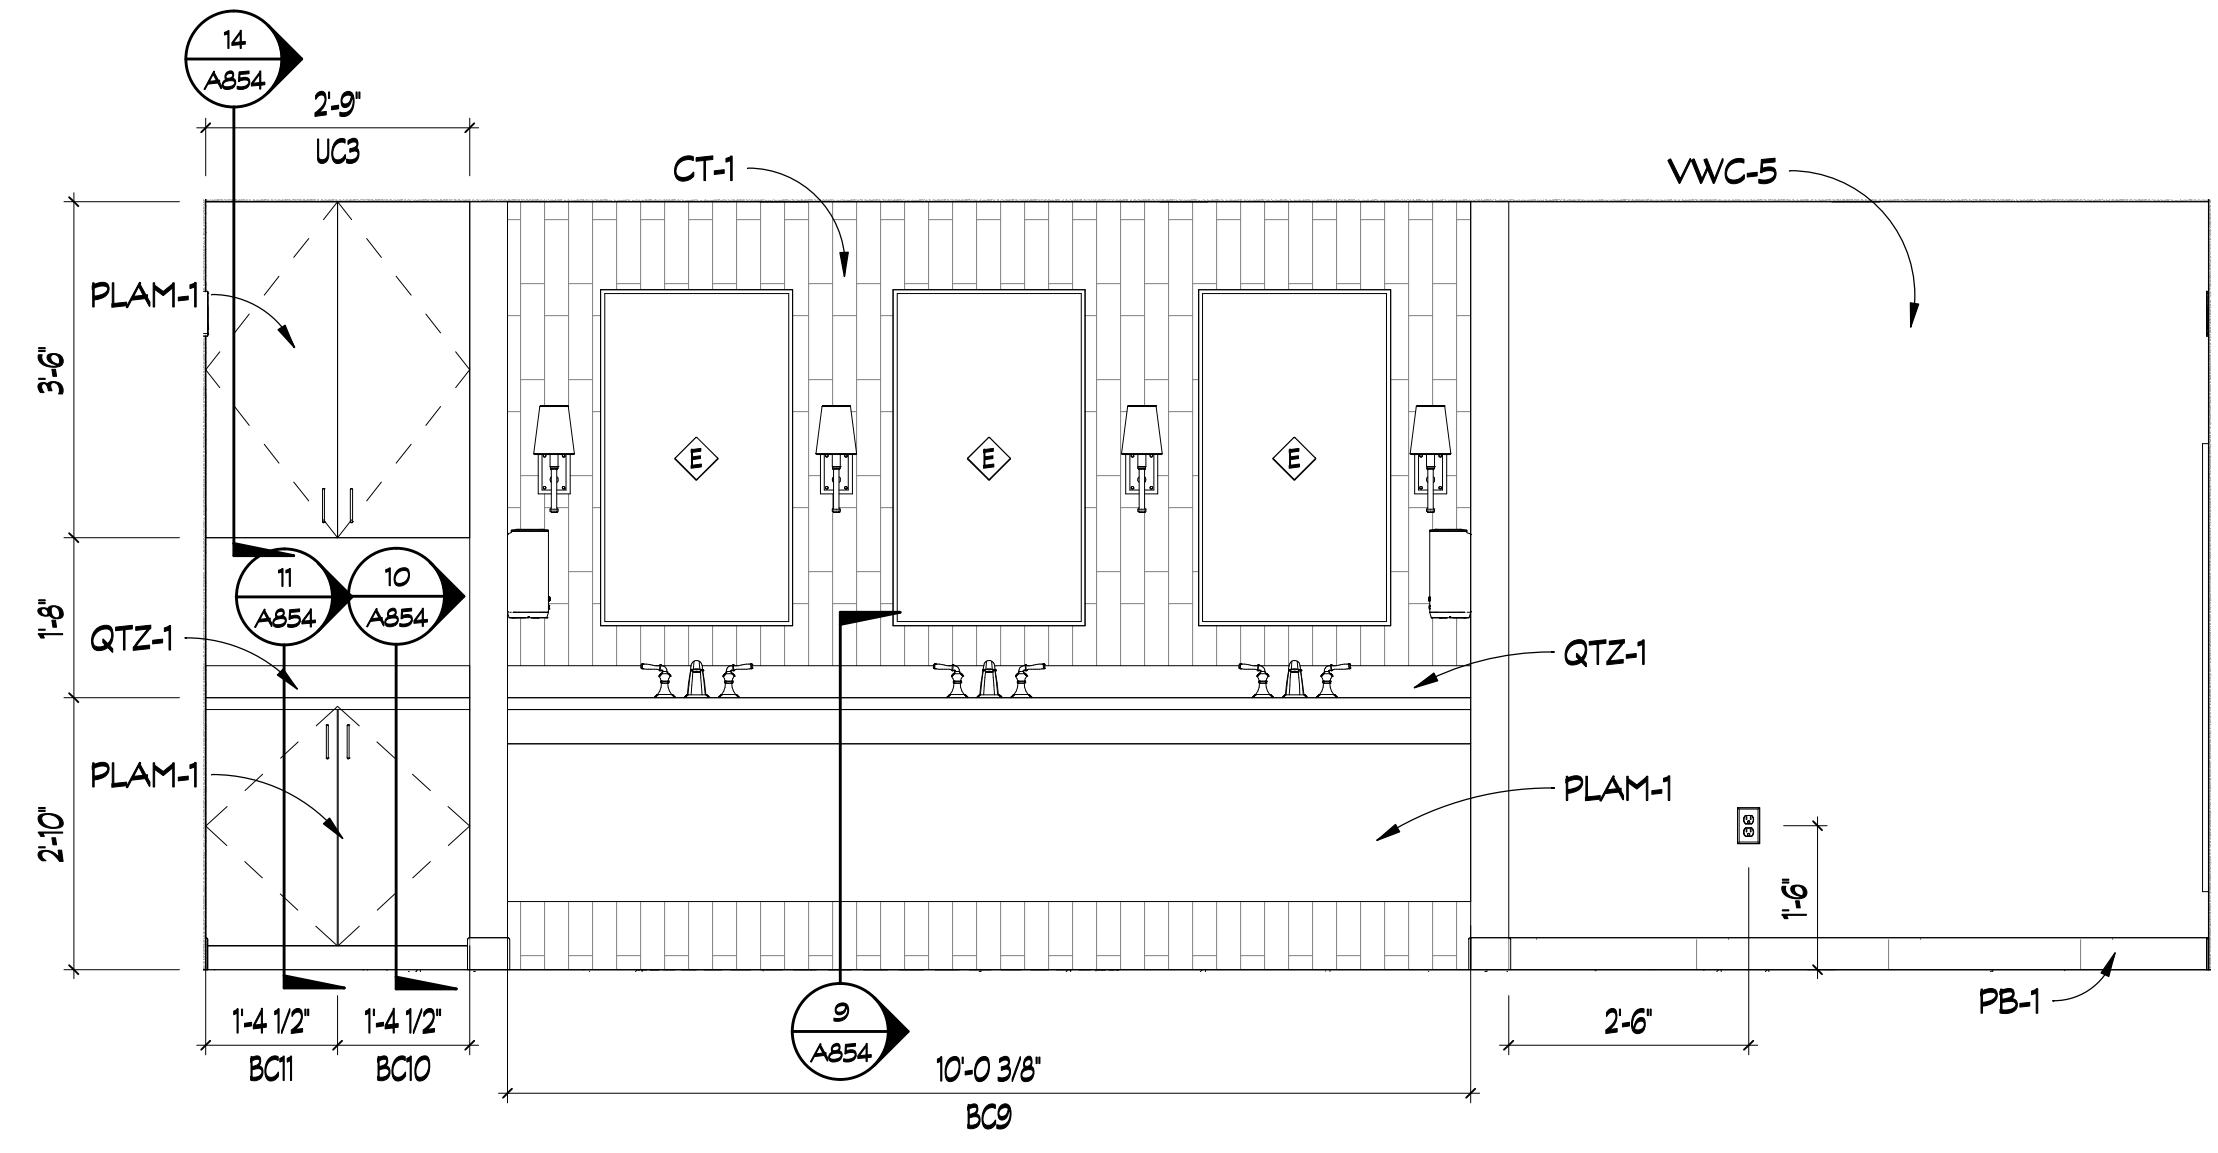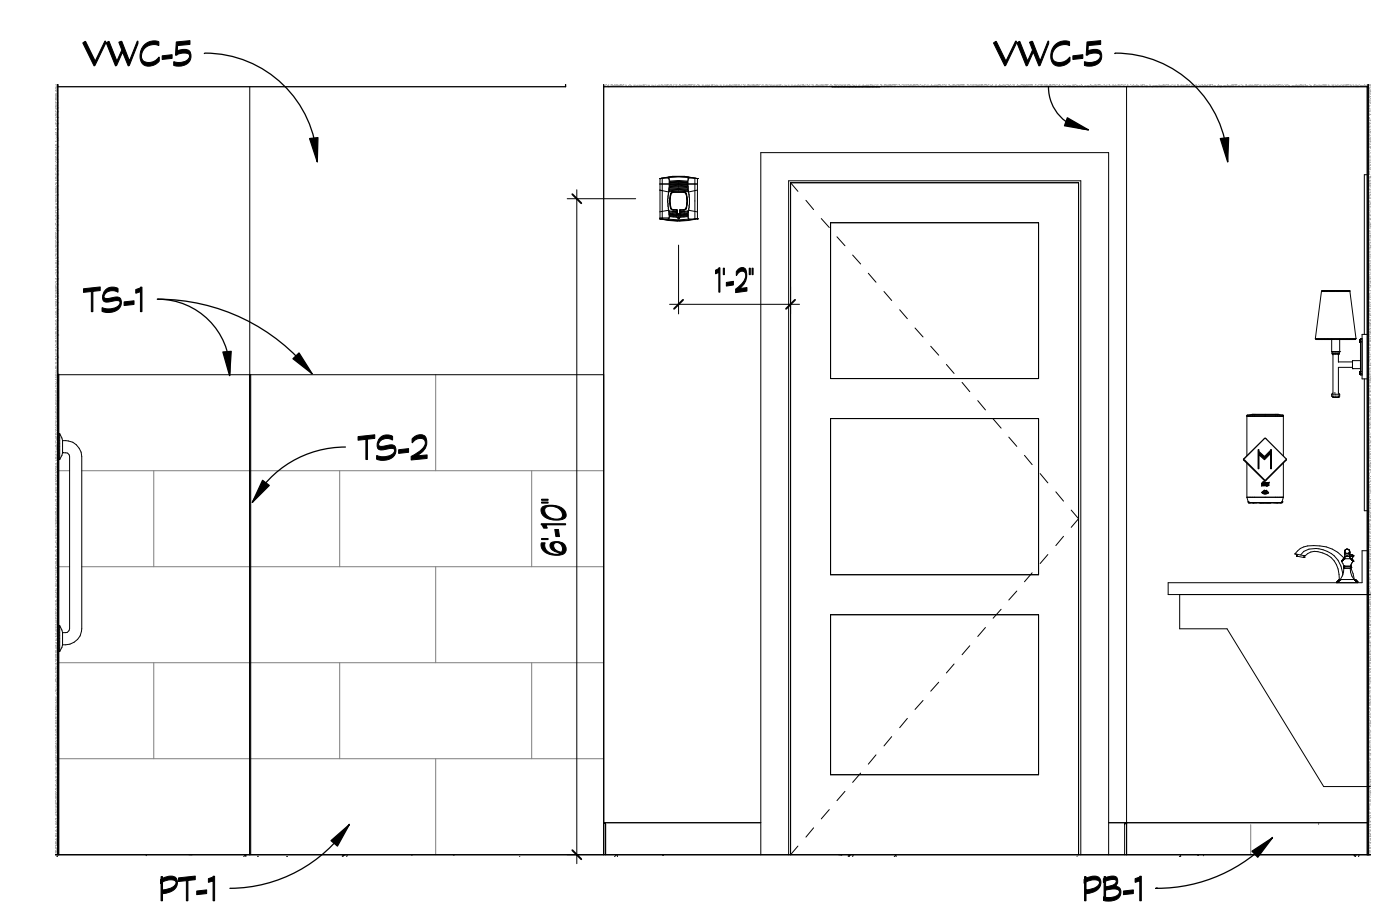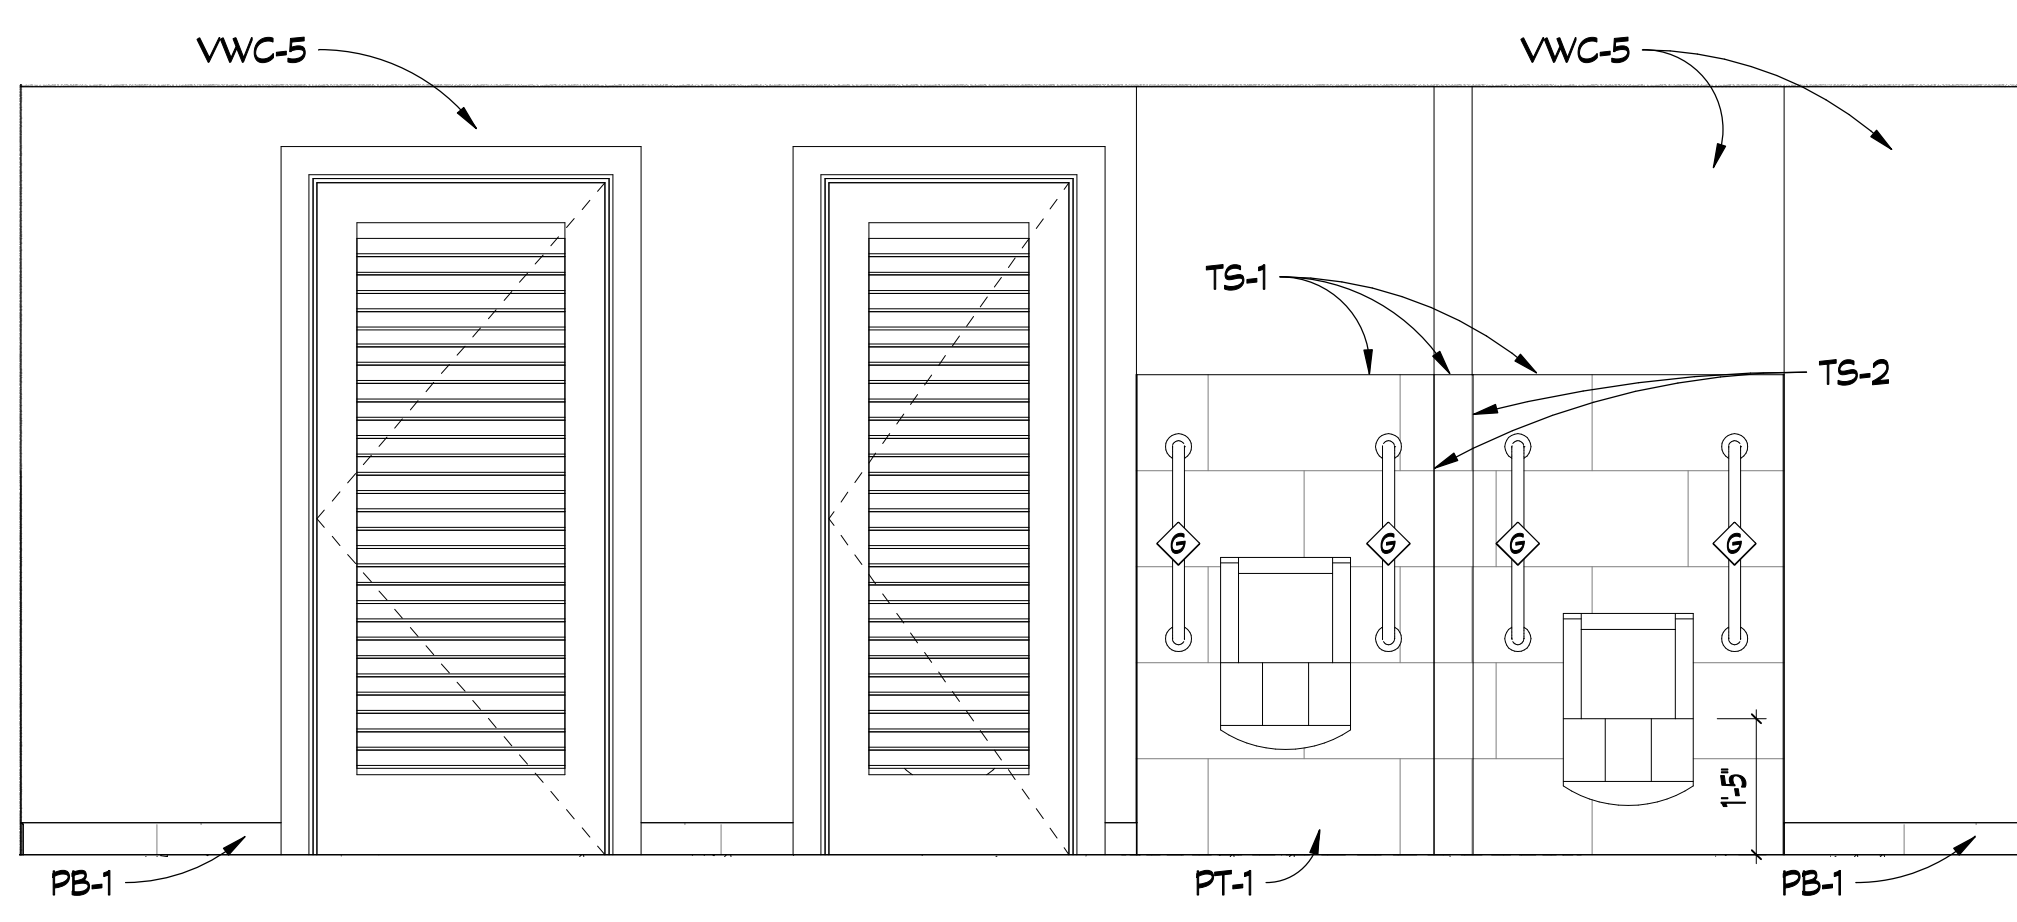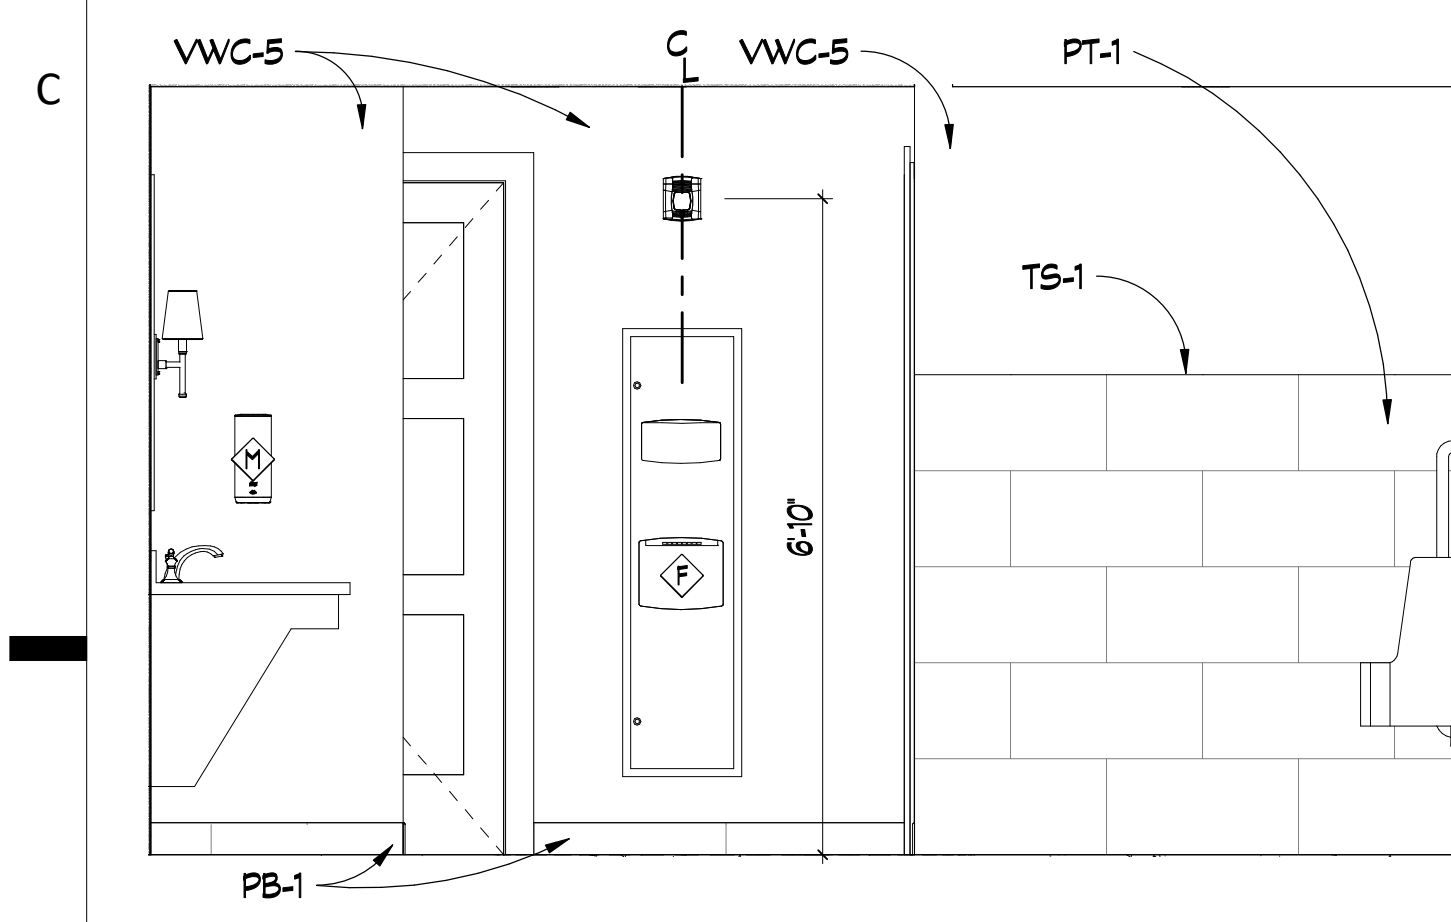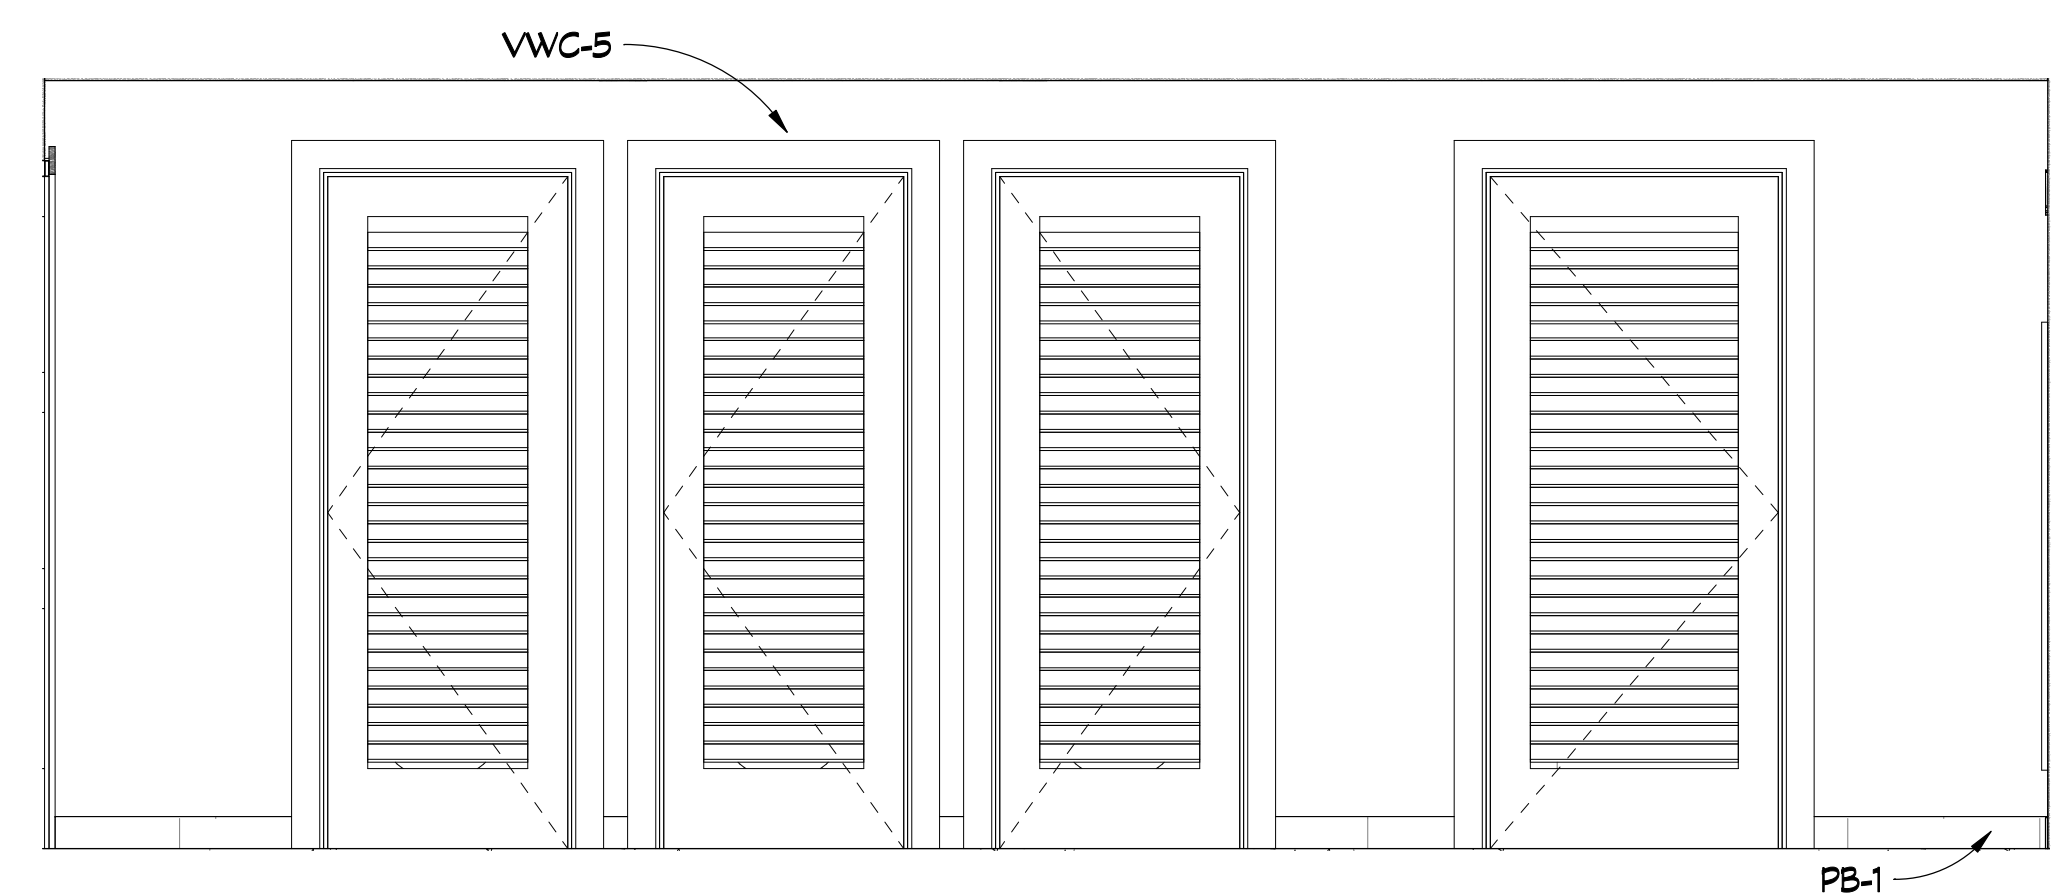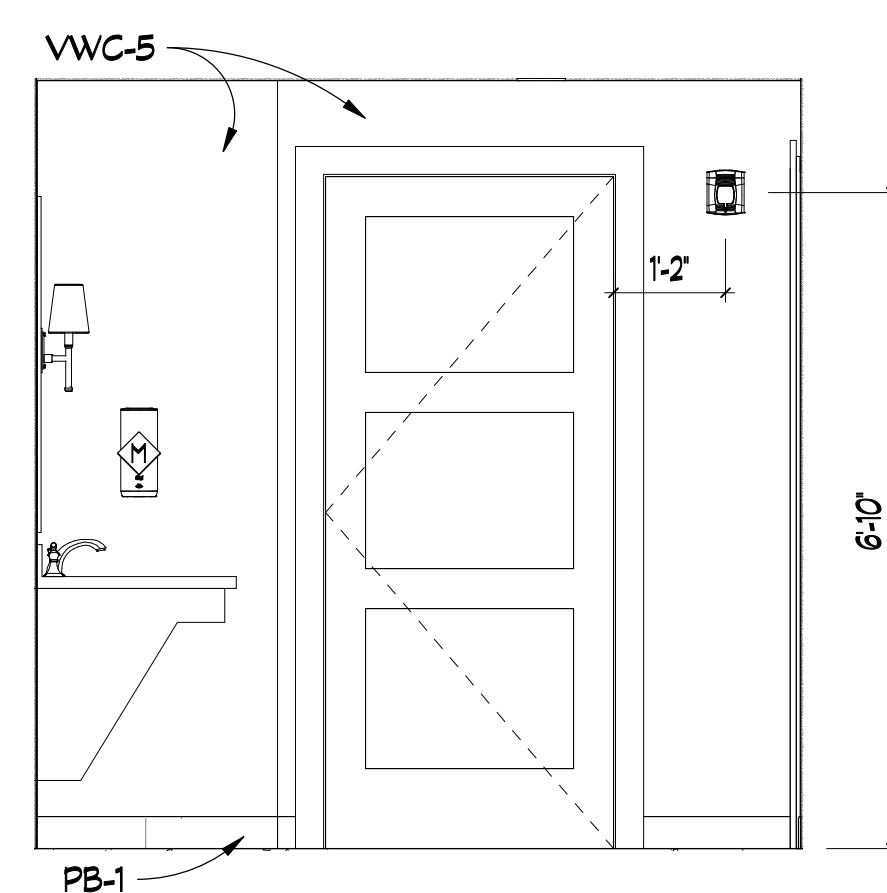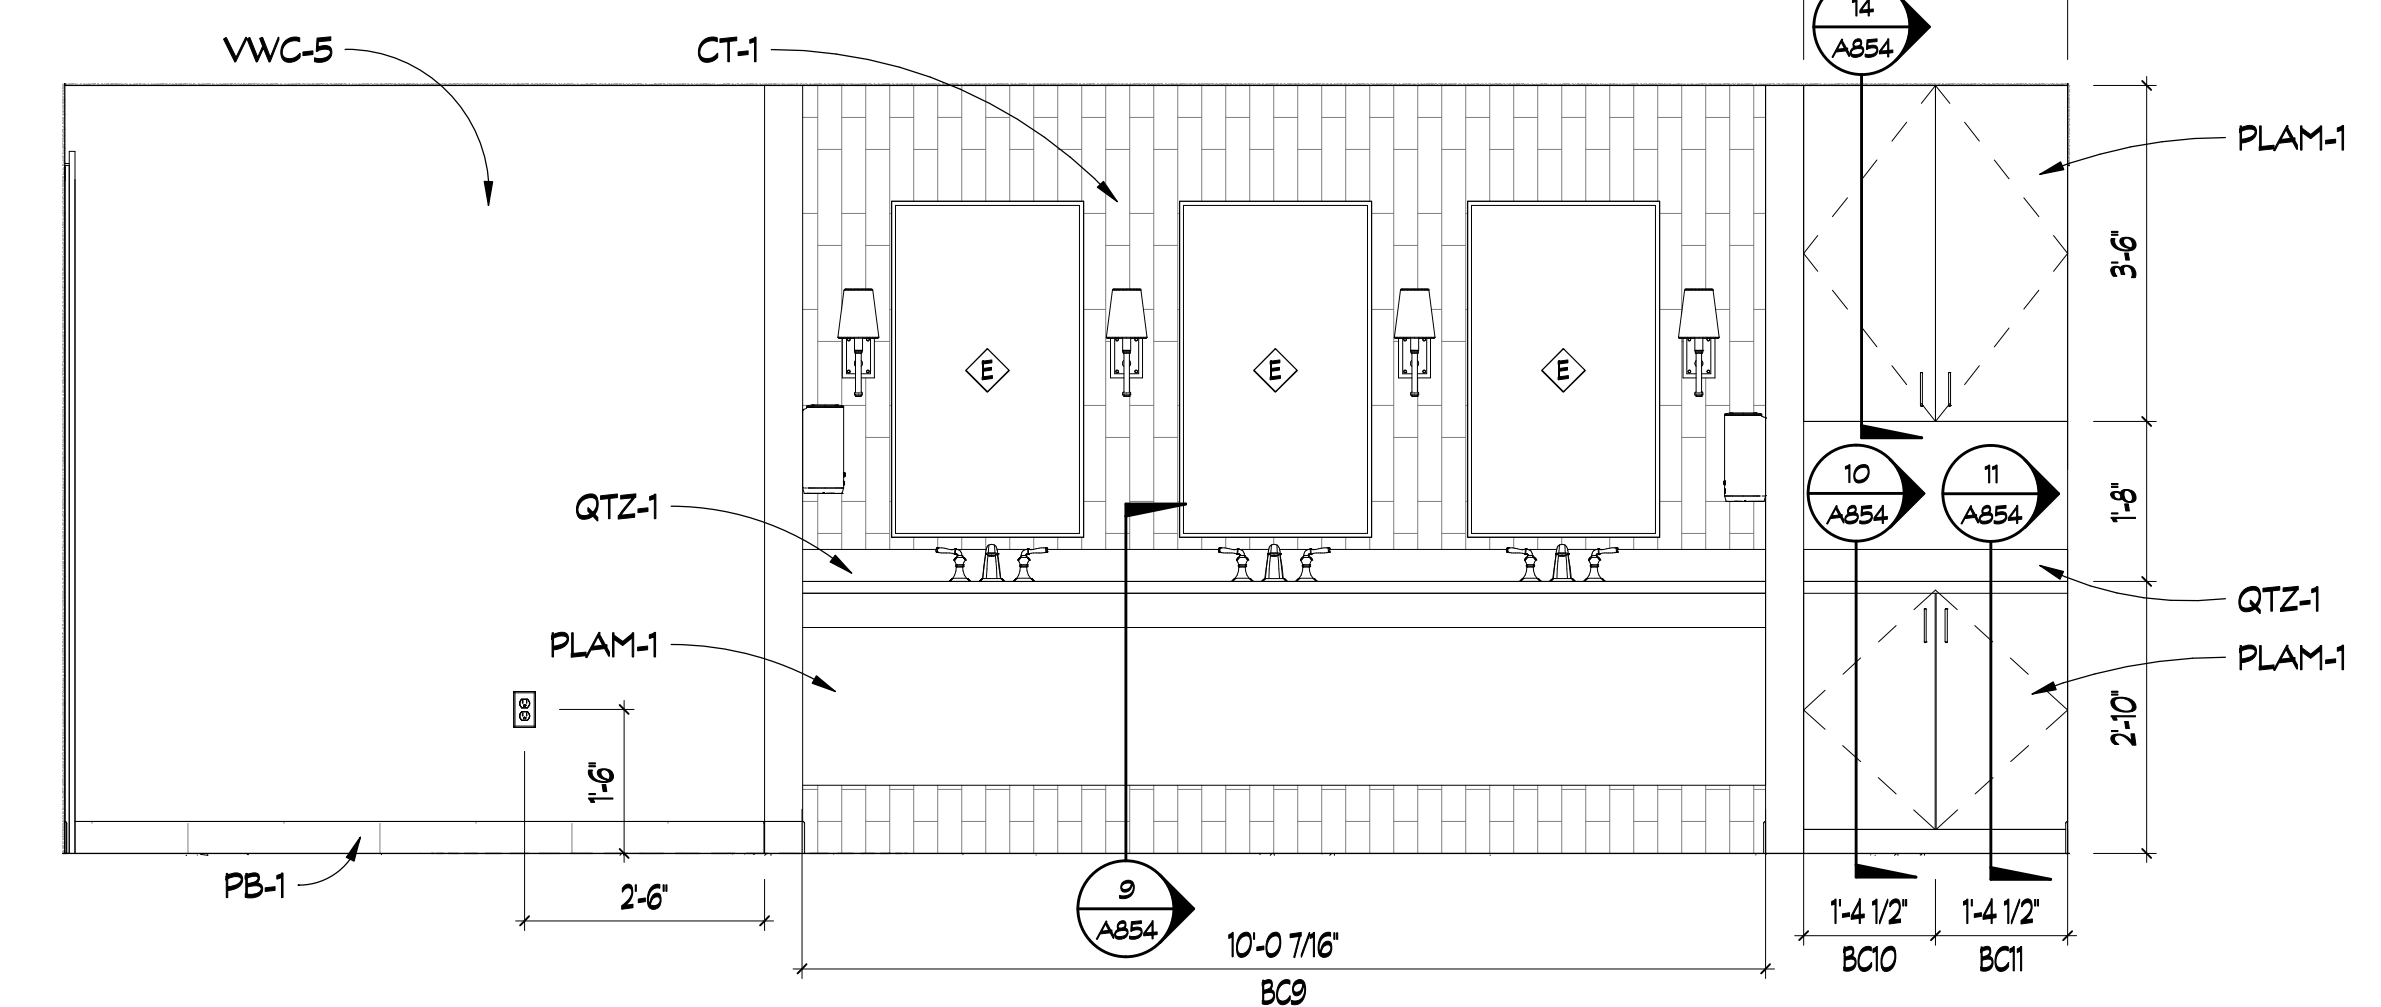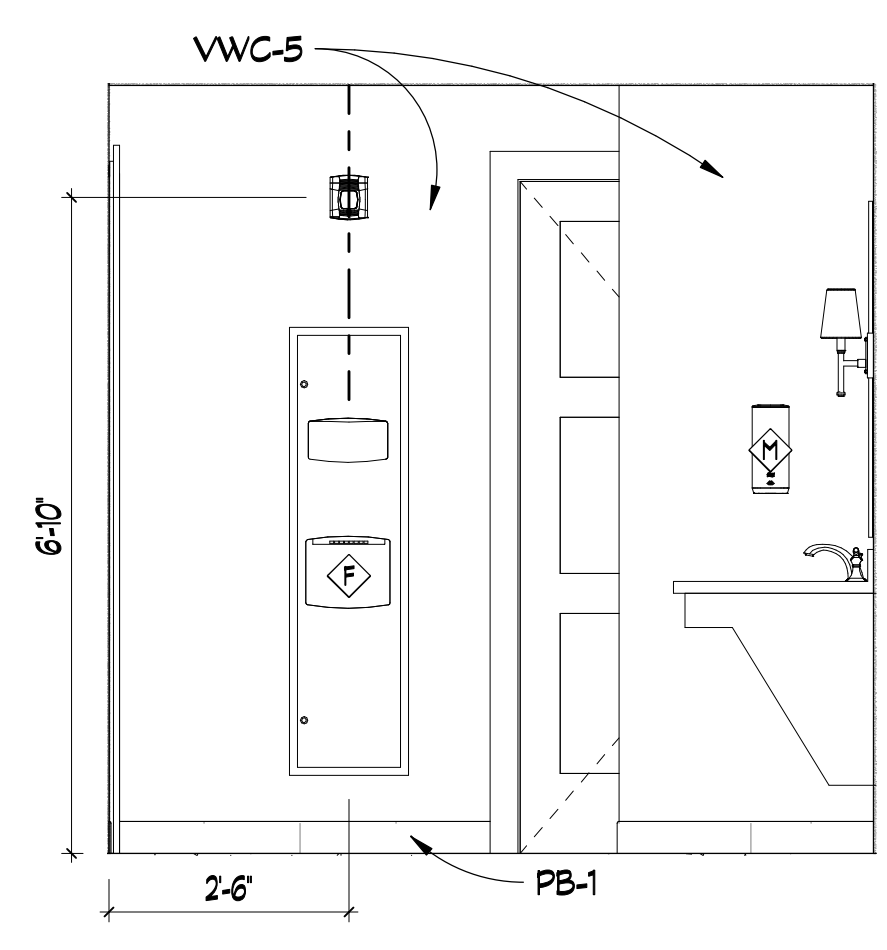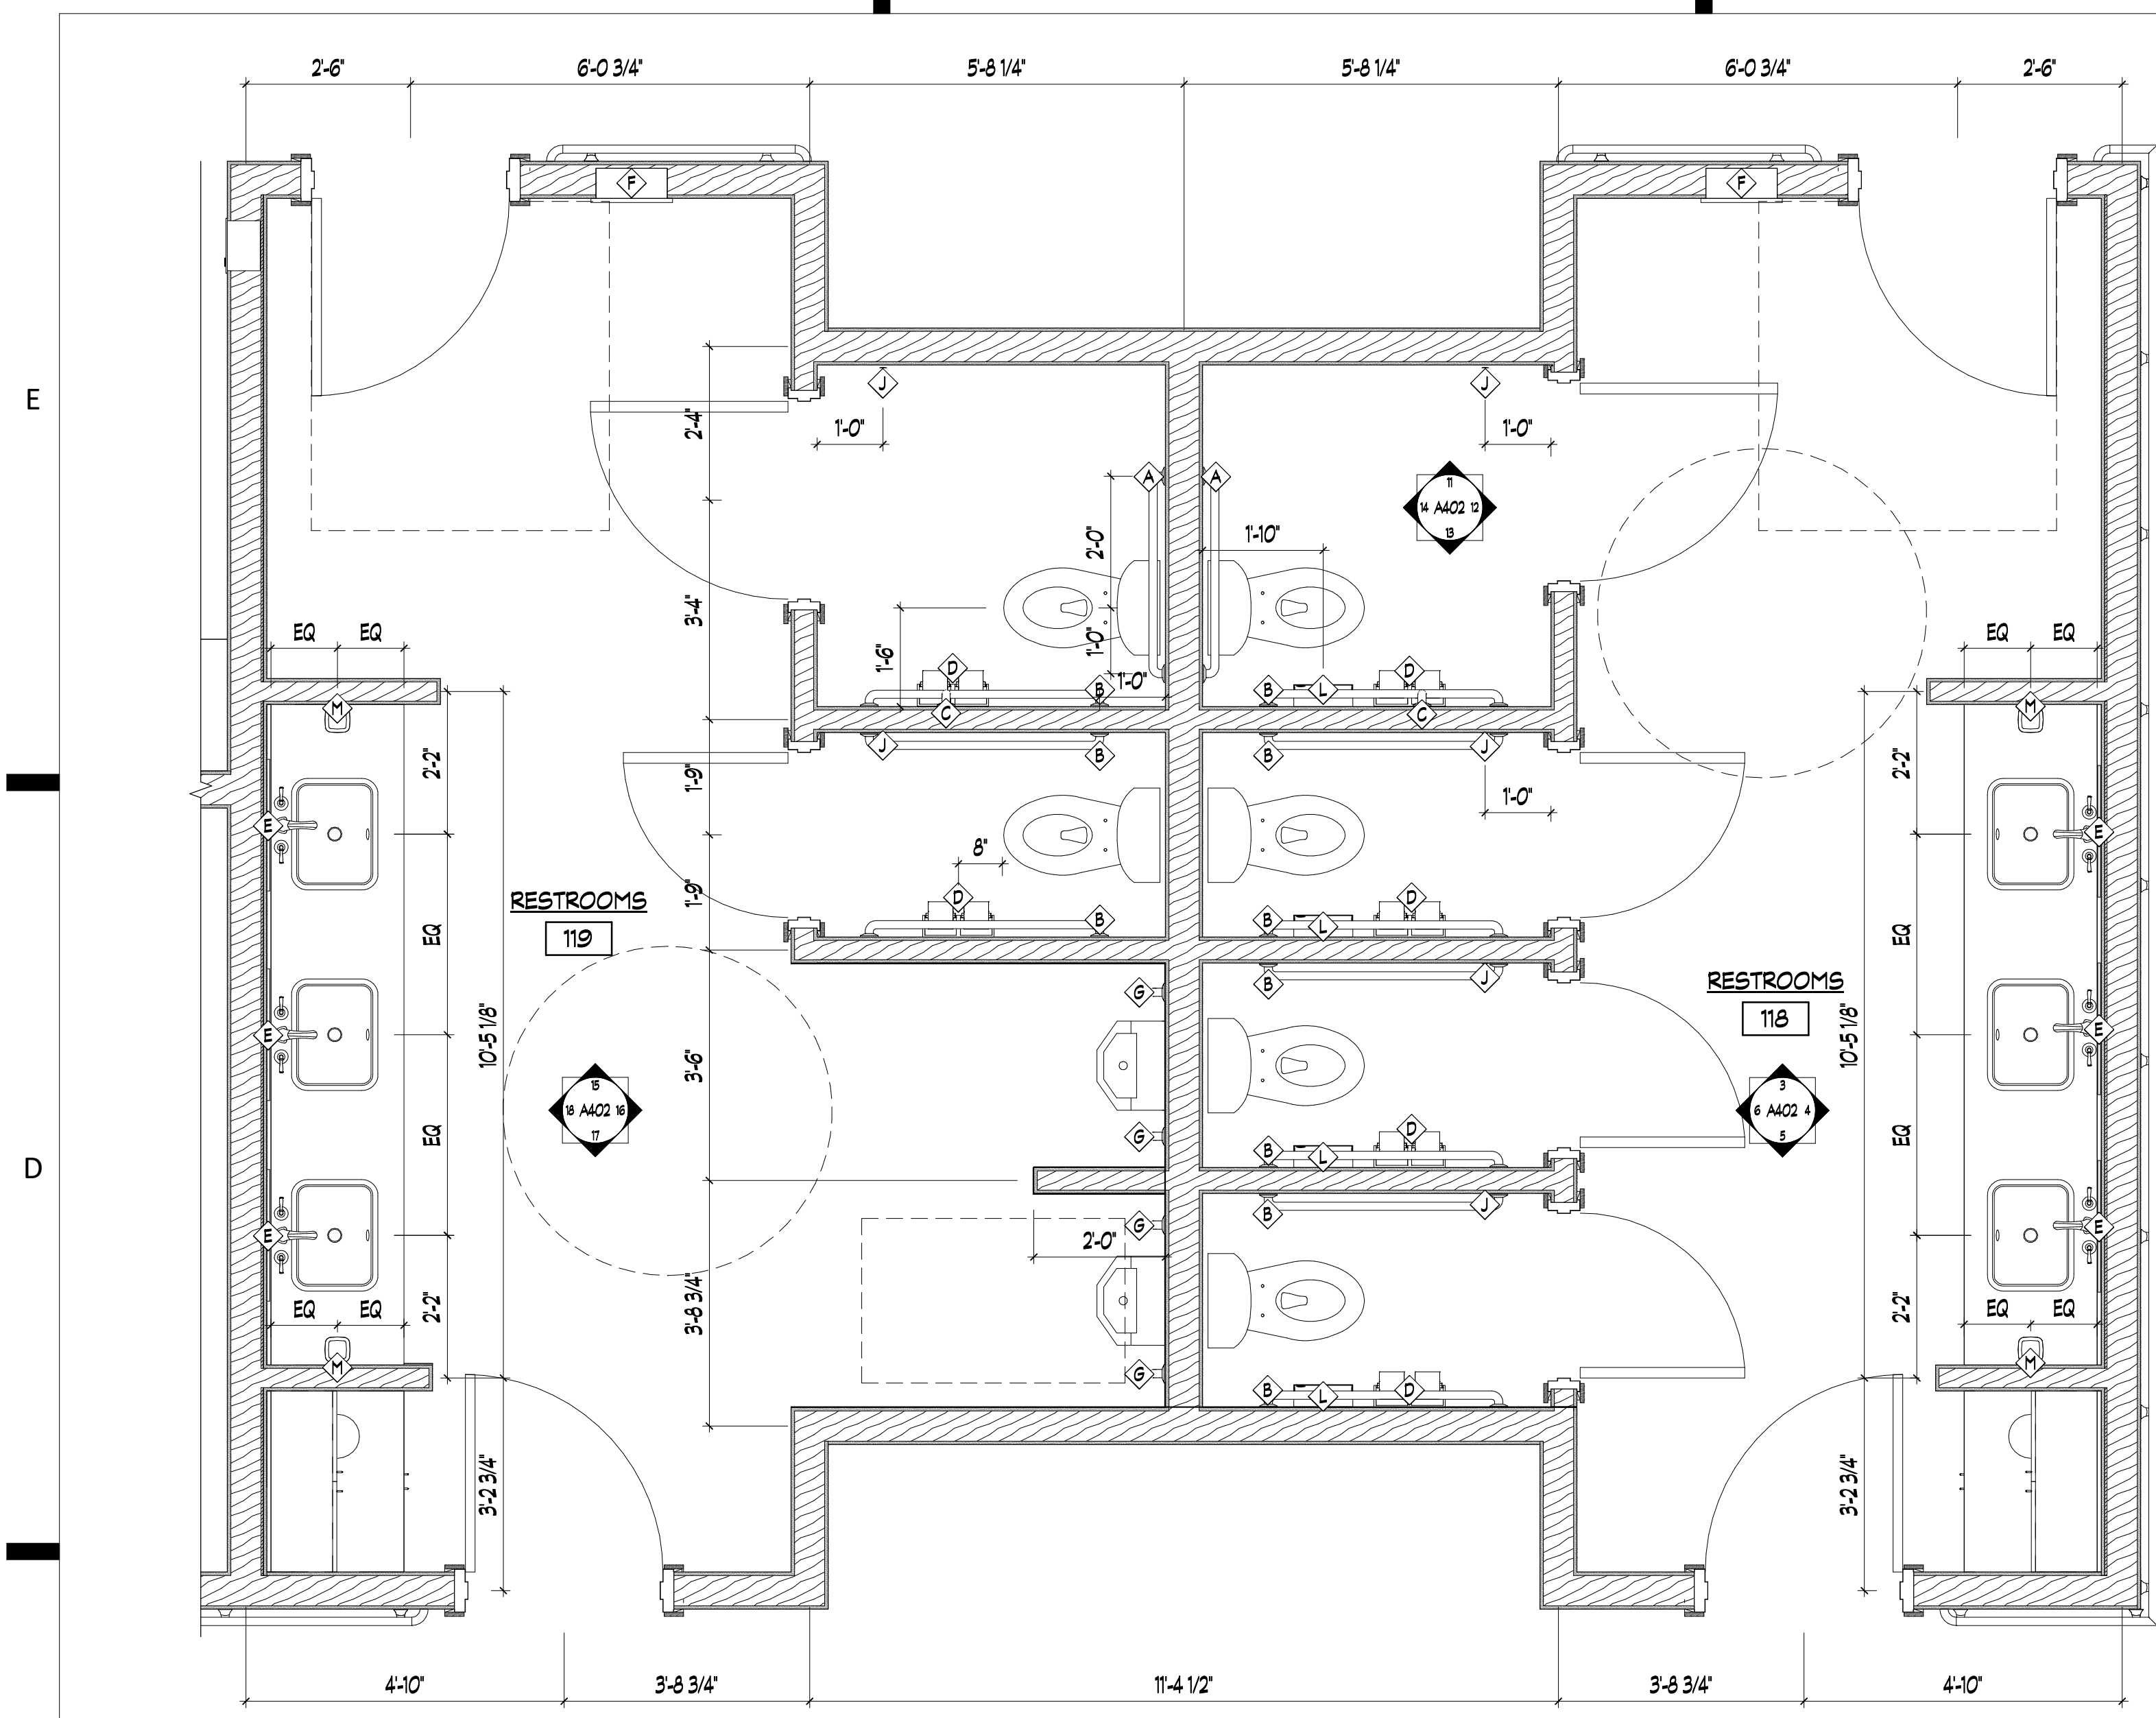

TOILET ACCESSORY SCHEDULE

MANUFACTURER	DESCRIPTION	MODEL
A WINGITS	MODERN ELEGANCE 36" GRAB BAR	WGB5MESN36
B WINGITS	MODERN ELEGANCE 42" GRAB BAR	WGB5MESN42
C WINGITS	MODERN ELEGANCE 18" GRAB BAR	WGB5MESN18
D WINGITS	MODERN ELEGANCE DOUBLE TOILET PAPER HOLDER	WMEDTPHN
E LAMPS PLUS	HELENA ANTIQUE SILVER 25" X 42" WALL MIRROR	47A09
F BRADLEY CORPORATION	PAPER TOWEL DISPENSER / WASTE BIN	270-000000
G WINGITS	MODERN ELEGANCE 24" GRAB BAR	WGB5MESN24
H WINGITS	MODERN ELEGANCE 54" GRAB BAR	WGB5MESN54
J WINGITS	MODERN ELEGANCE ROBE HOOK	WMESRHSN
K INPRO CORP	SHOWER CURTAIN W/ TRACK	SEE A801 FOR INFO
L BRADLEY CORPORATION	NAPKIN DISPOSAL, 1.5 GALLONS, SURFACE-MOUNTED	4722-150000
M TORK	FOAM SOAP DISPENSER W/ INTUITION SENSOR, STAINLESS STEEL	466100
N BRADLEY CORPORATION	UTILITY SHELF, 4 HOOKS / 3 HOLDERS	9933

TYP. TOILET ACCESSORY MOUNTING HEIGHTS

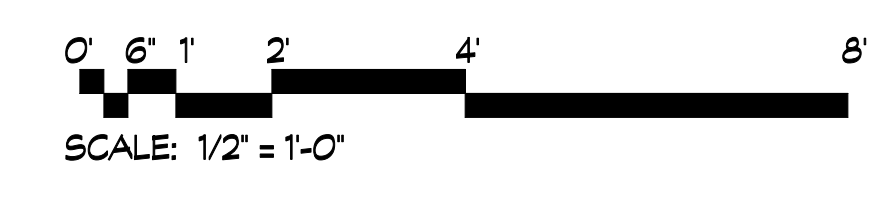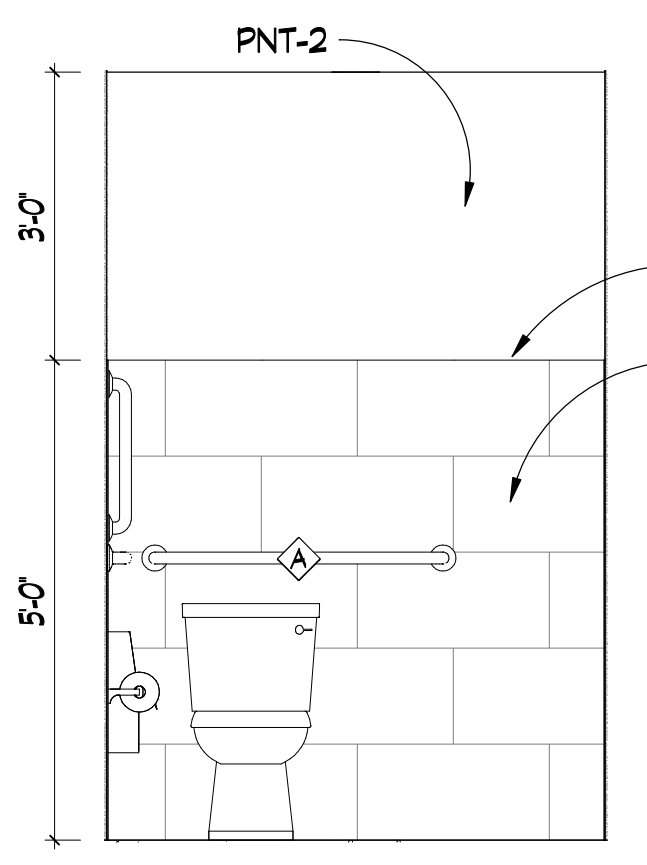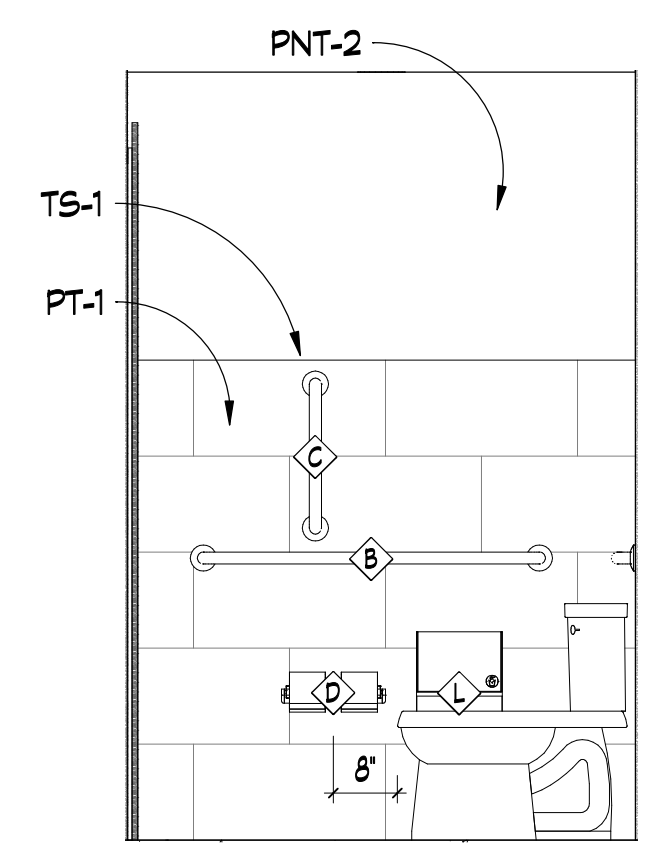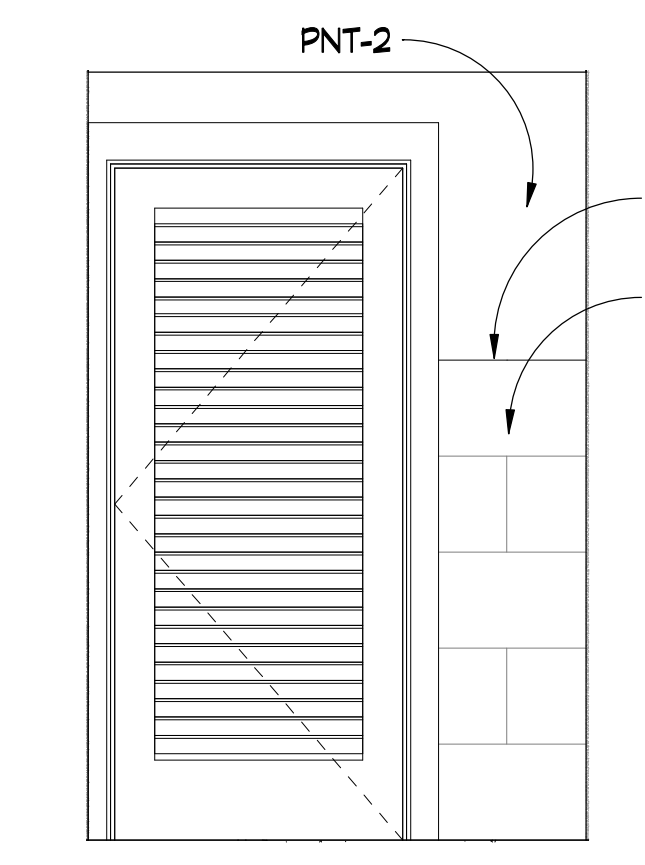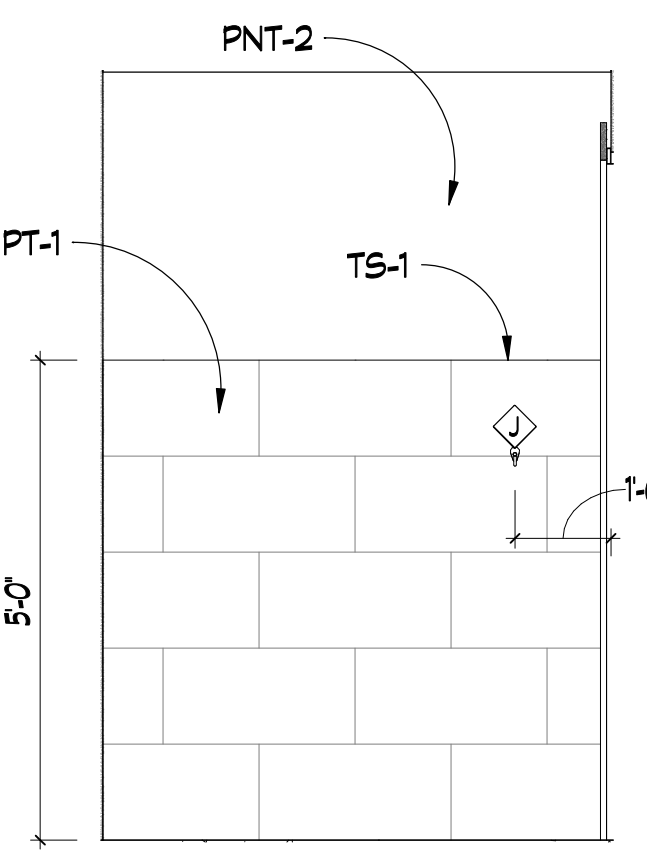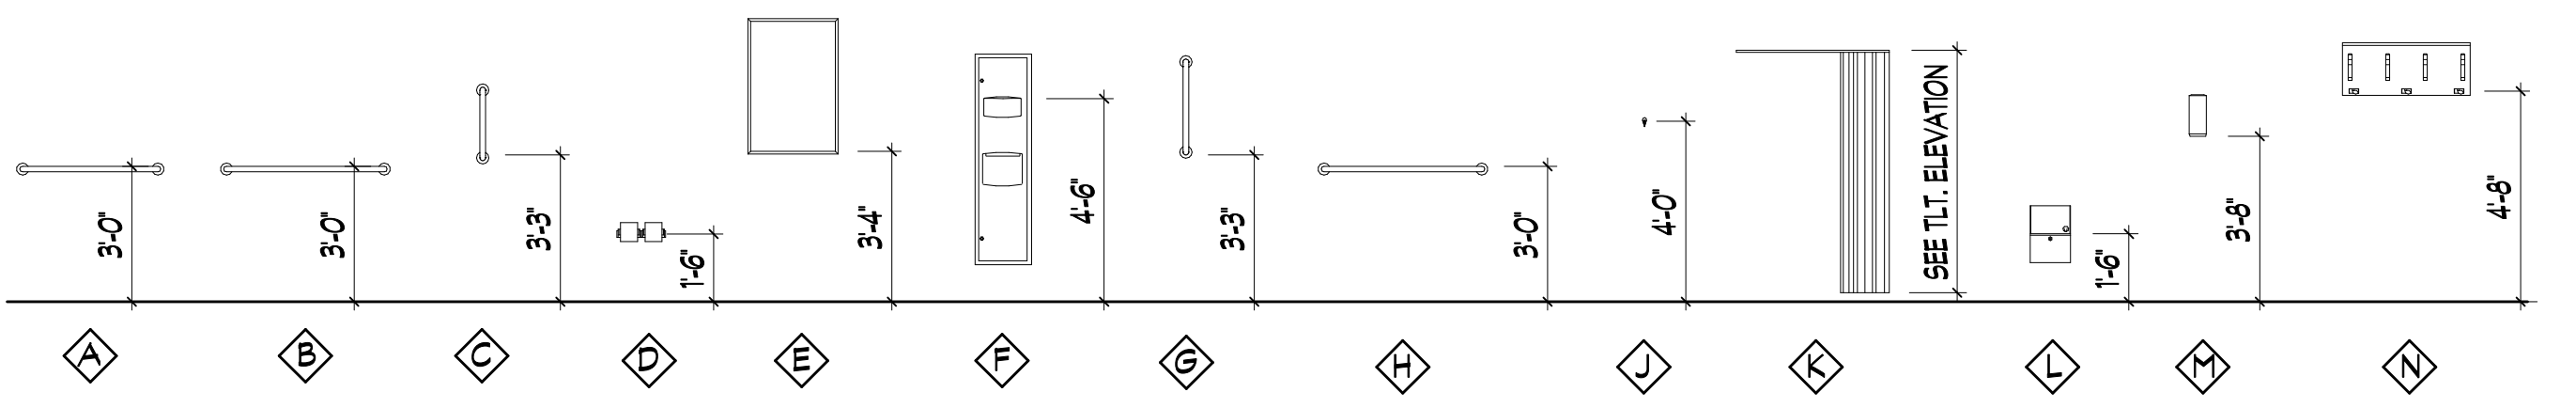


REVISIONS			
REV #	DATE	APPROV	REVISION
1	11/17/21	EA	65% SET
2	2/16/22	EA	ISSUE FOR PERMIT




DA PROJECT NUMBER & NAME:
1893

DRAWING TITLE:
**ENLARGED
TOILET
PLANS**


DRAWING NO:
A403

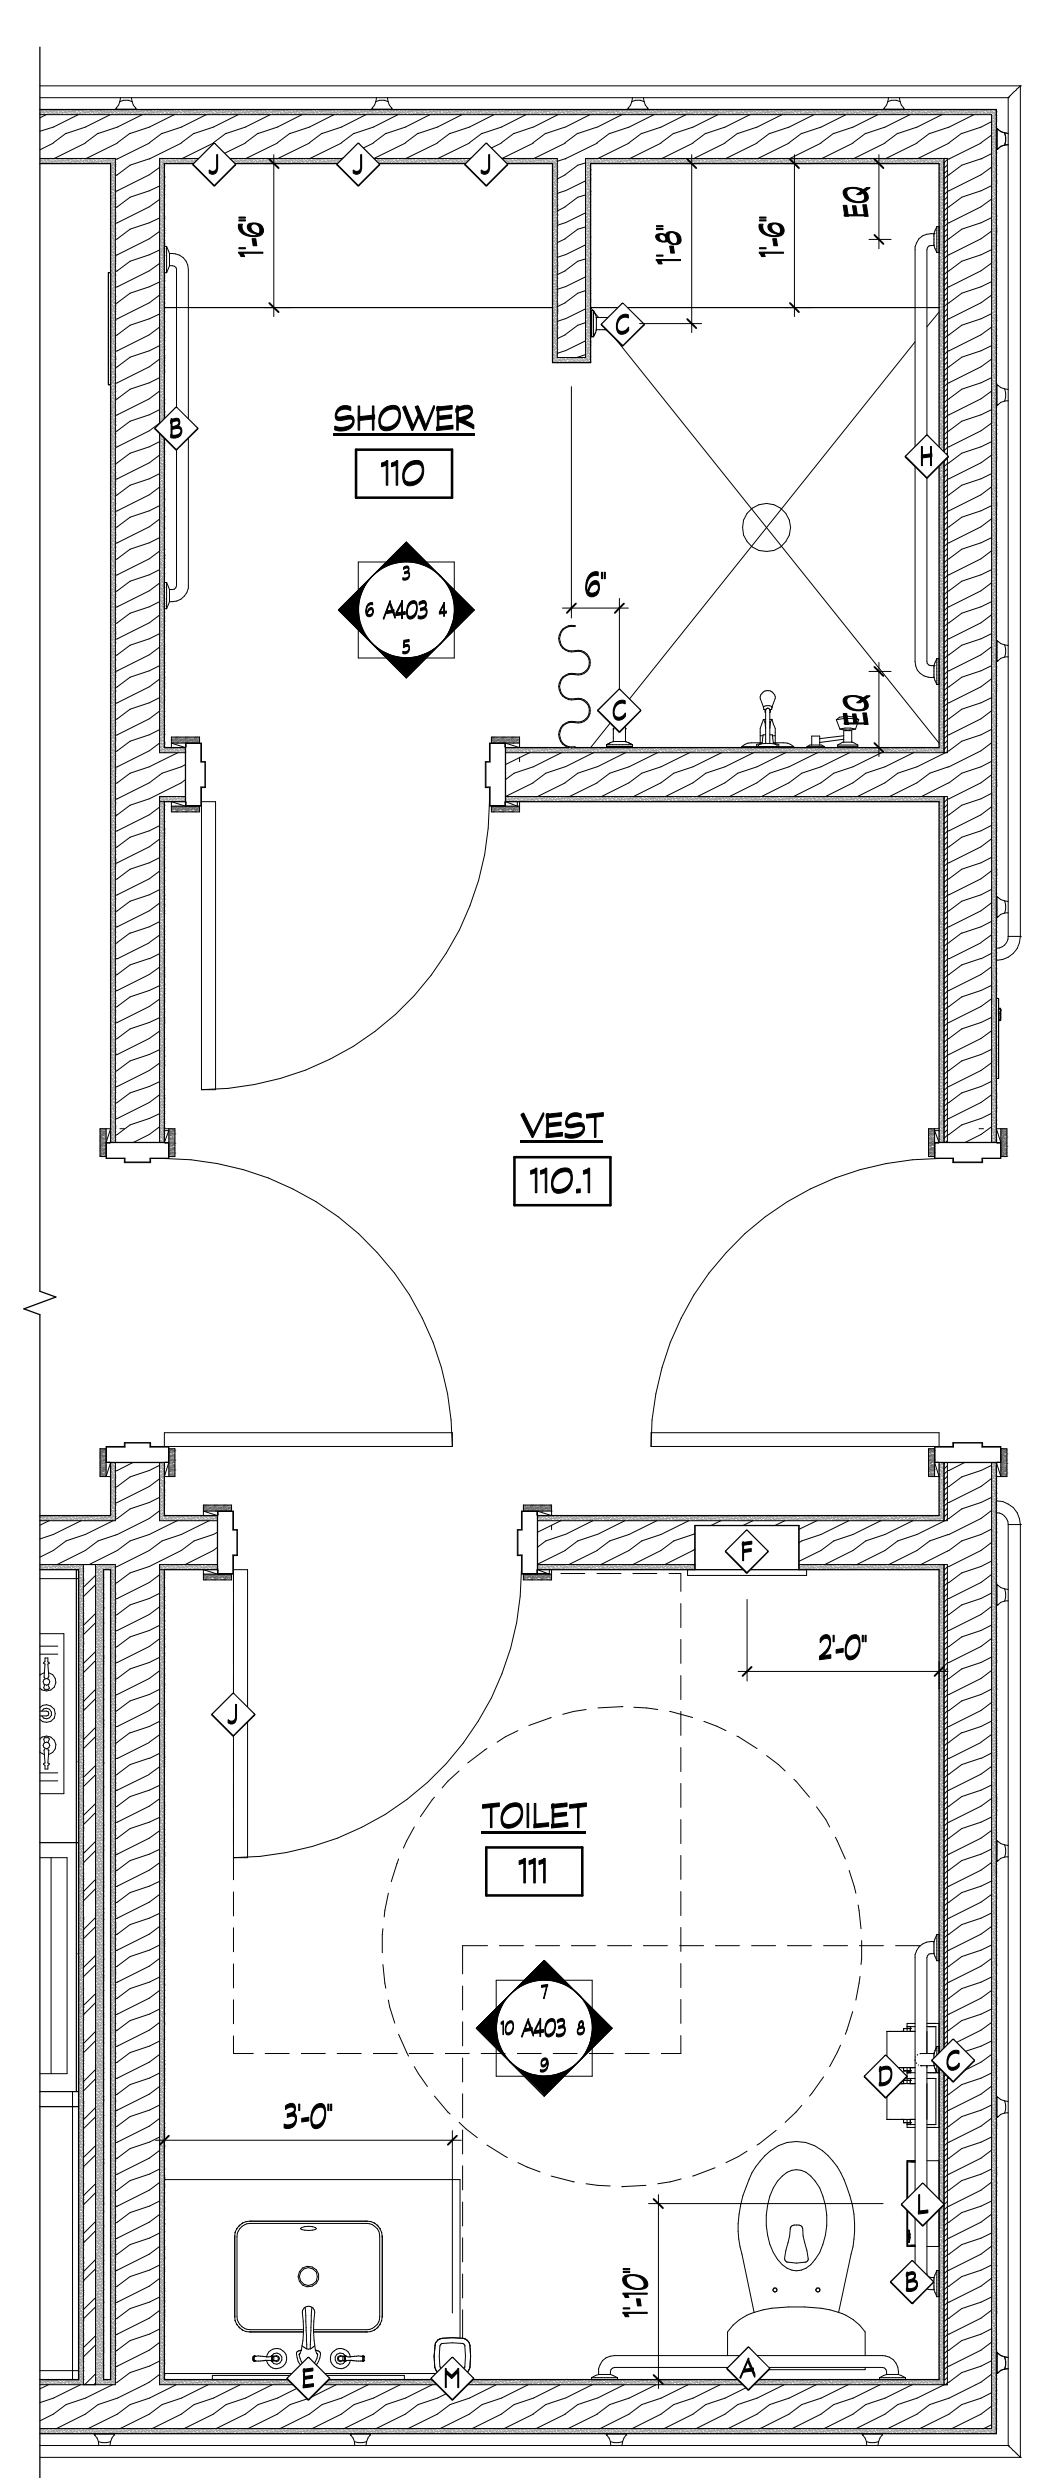


1 SHOWER 110 & TOILET 111 PLAN
A102 / SCALE: 1/2" = 1'-0"

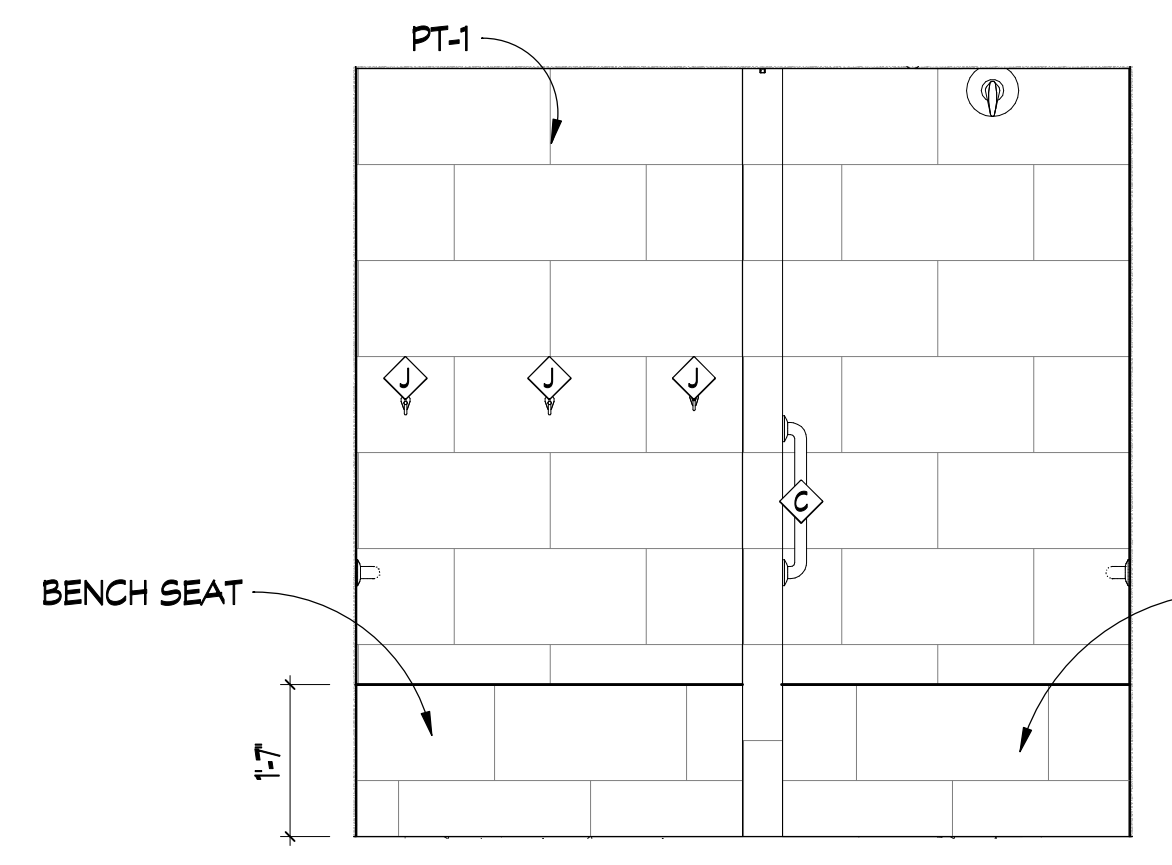


3 SHOWER 110
SCALE: 1/2" = 1'-0"

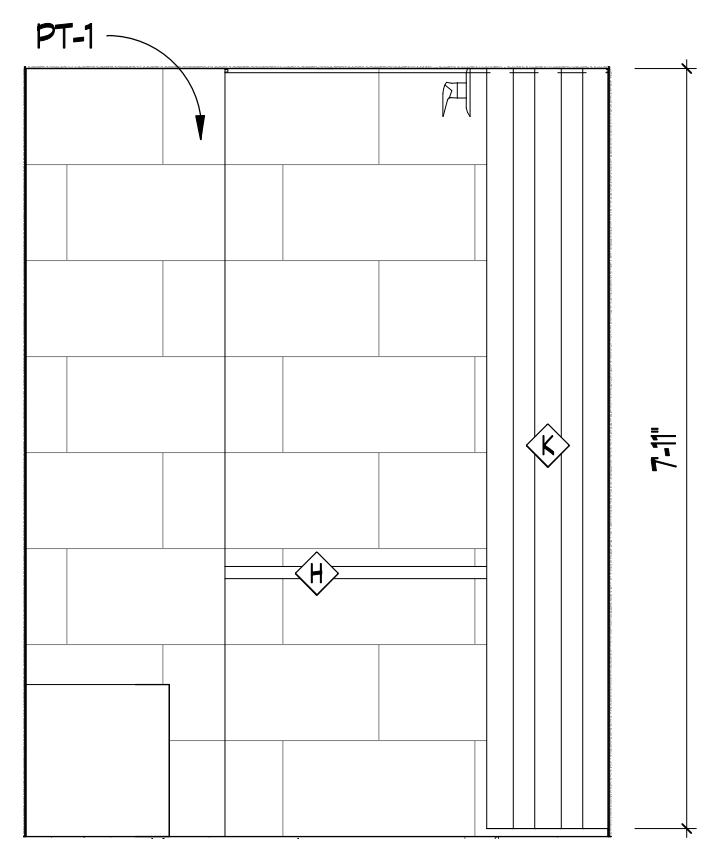


4 SHOWER 110
SCALE: 1/2" = 1'-0"

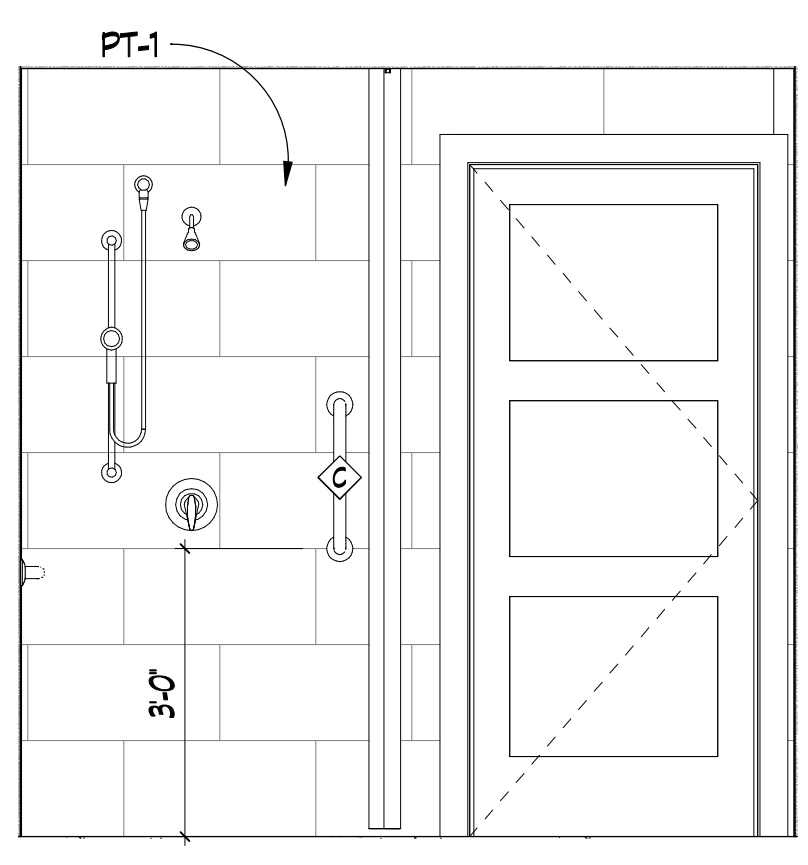


5 SHOWER 110
SCALE: 1/2" = 1'-0"

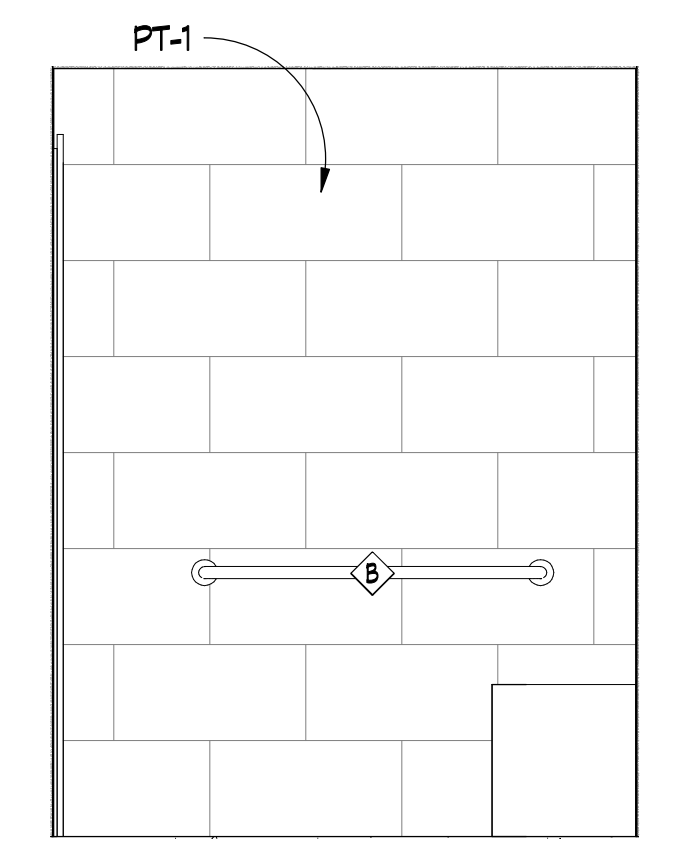


6 SHOWER 110
SCALE: 1/2" = 1'-0"

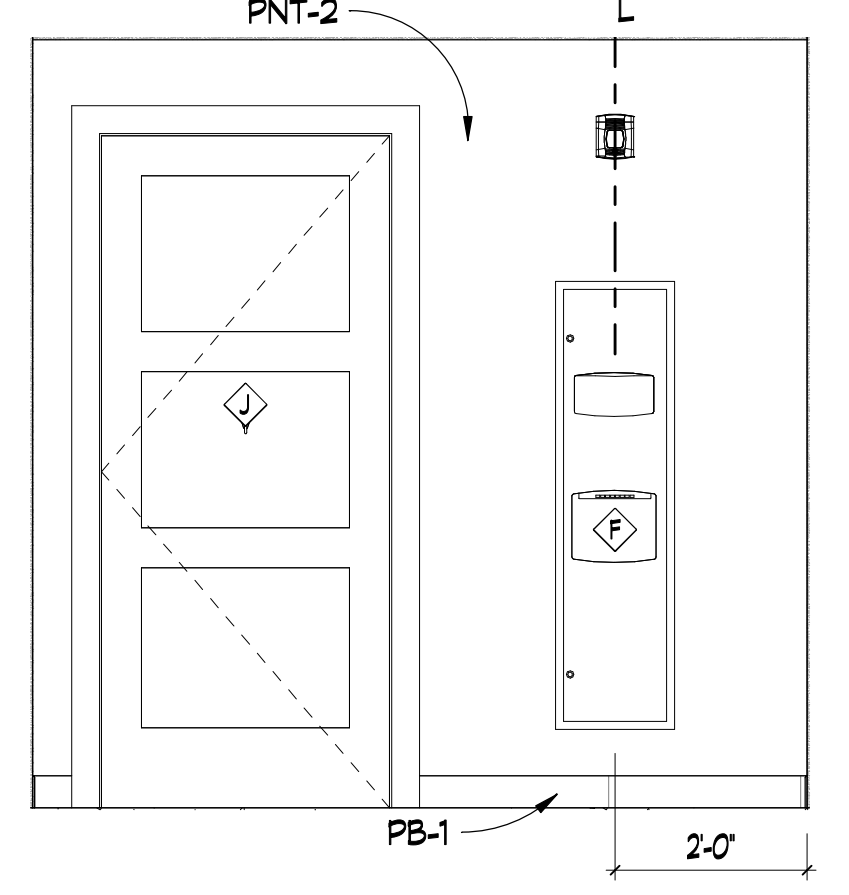


7 TOILET 111
SCALE: 1/2" = 1'-0"

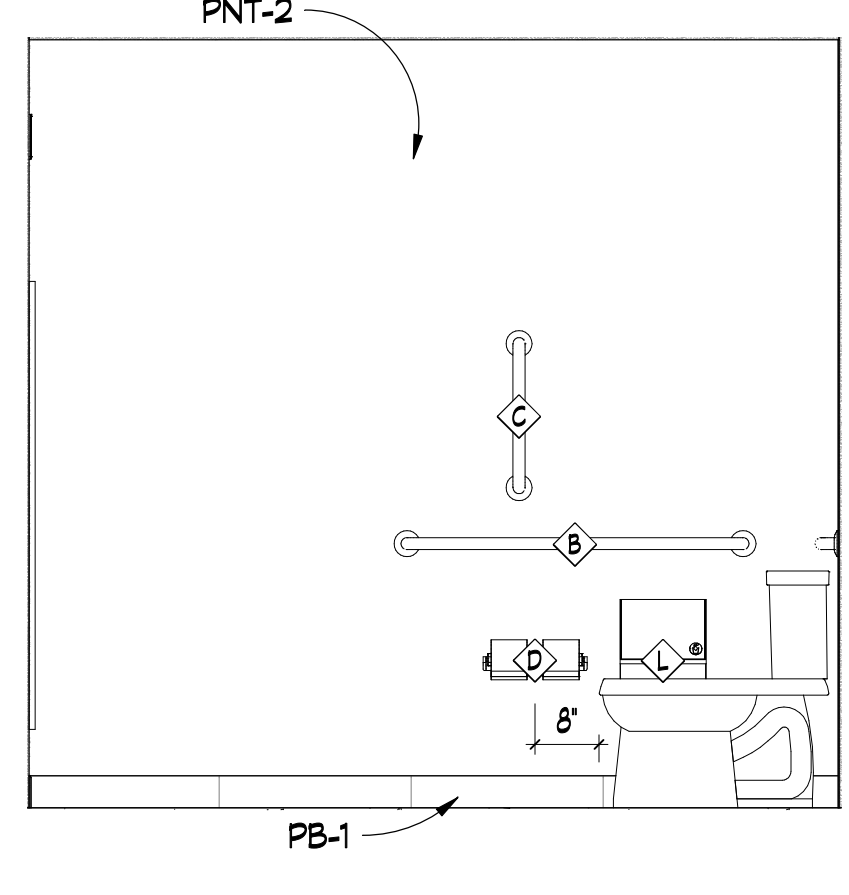


8 TOILET 111
SCALE: 1/2" = 1'-0"

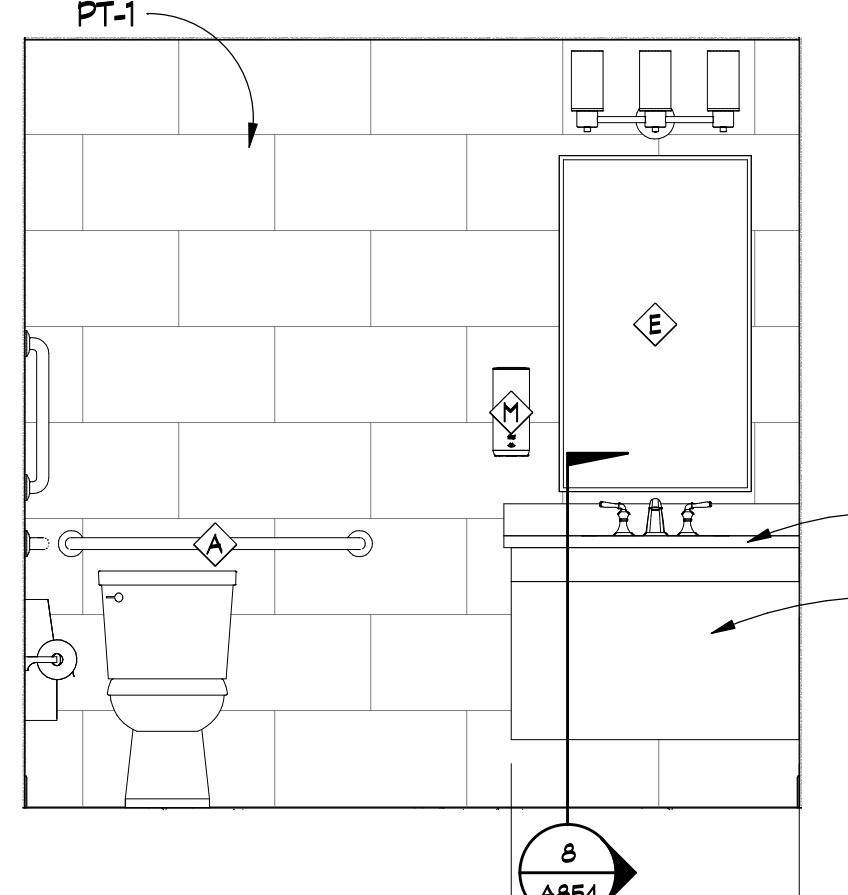


9 TOILET 111
SCALE: 1/2" = 1'-0"

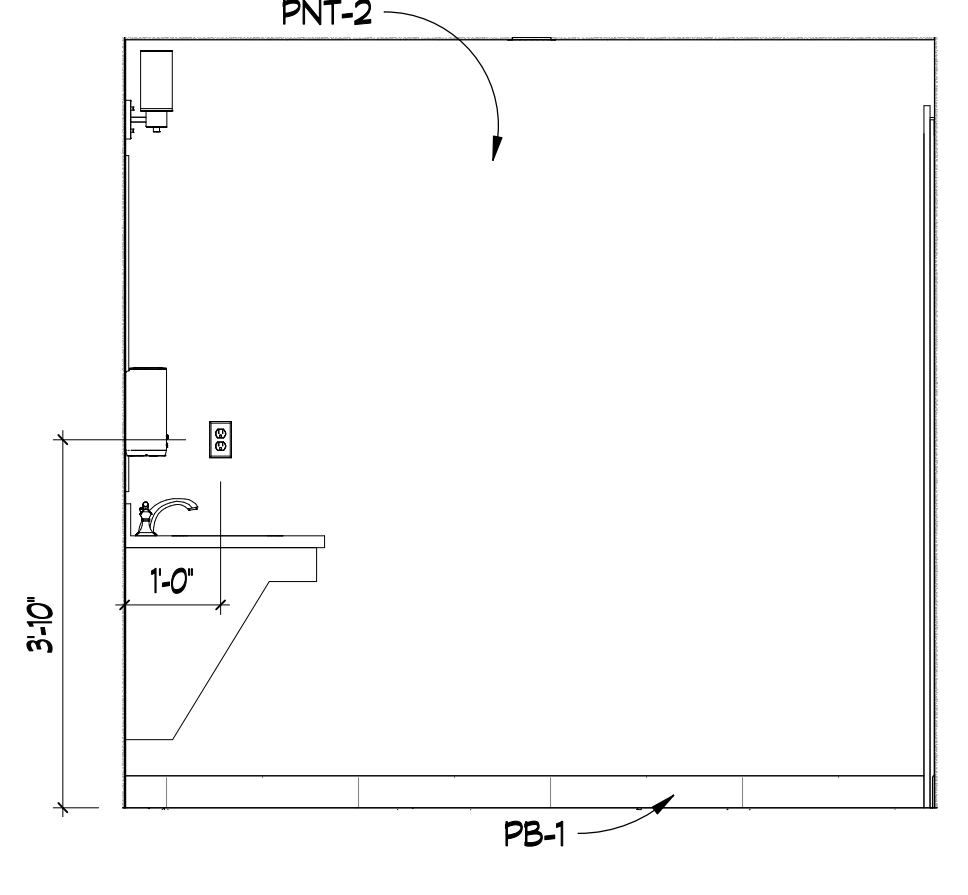


10 TOILET 111
SCALE: 1/2" = 1'-0"

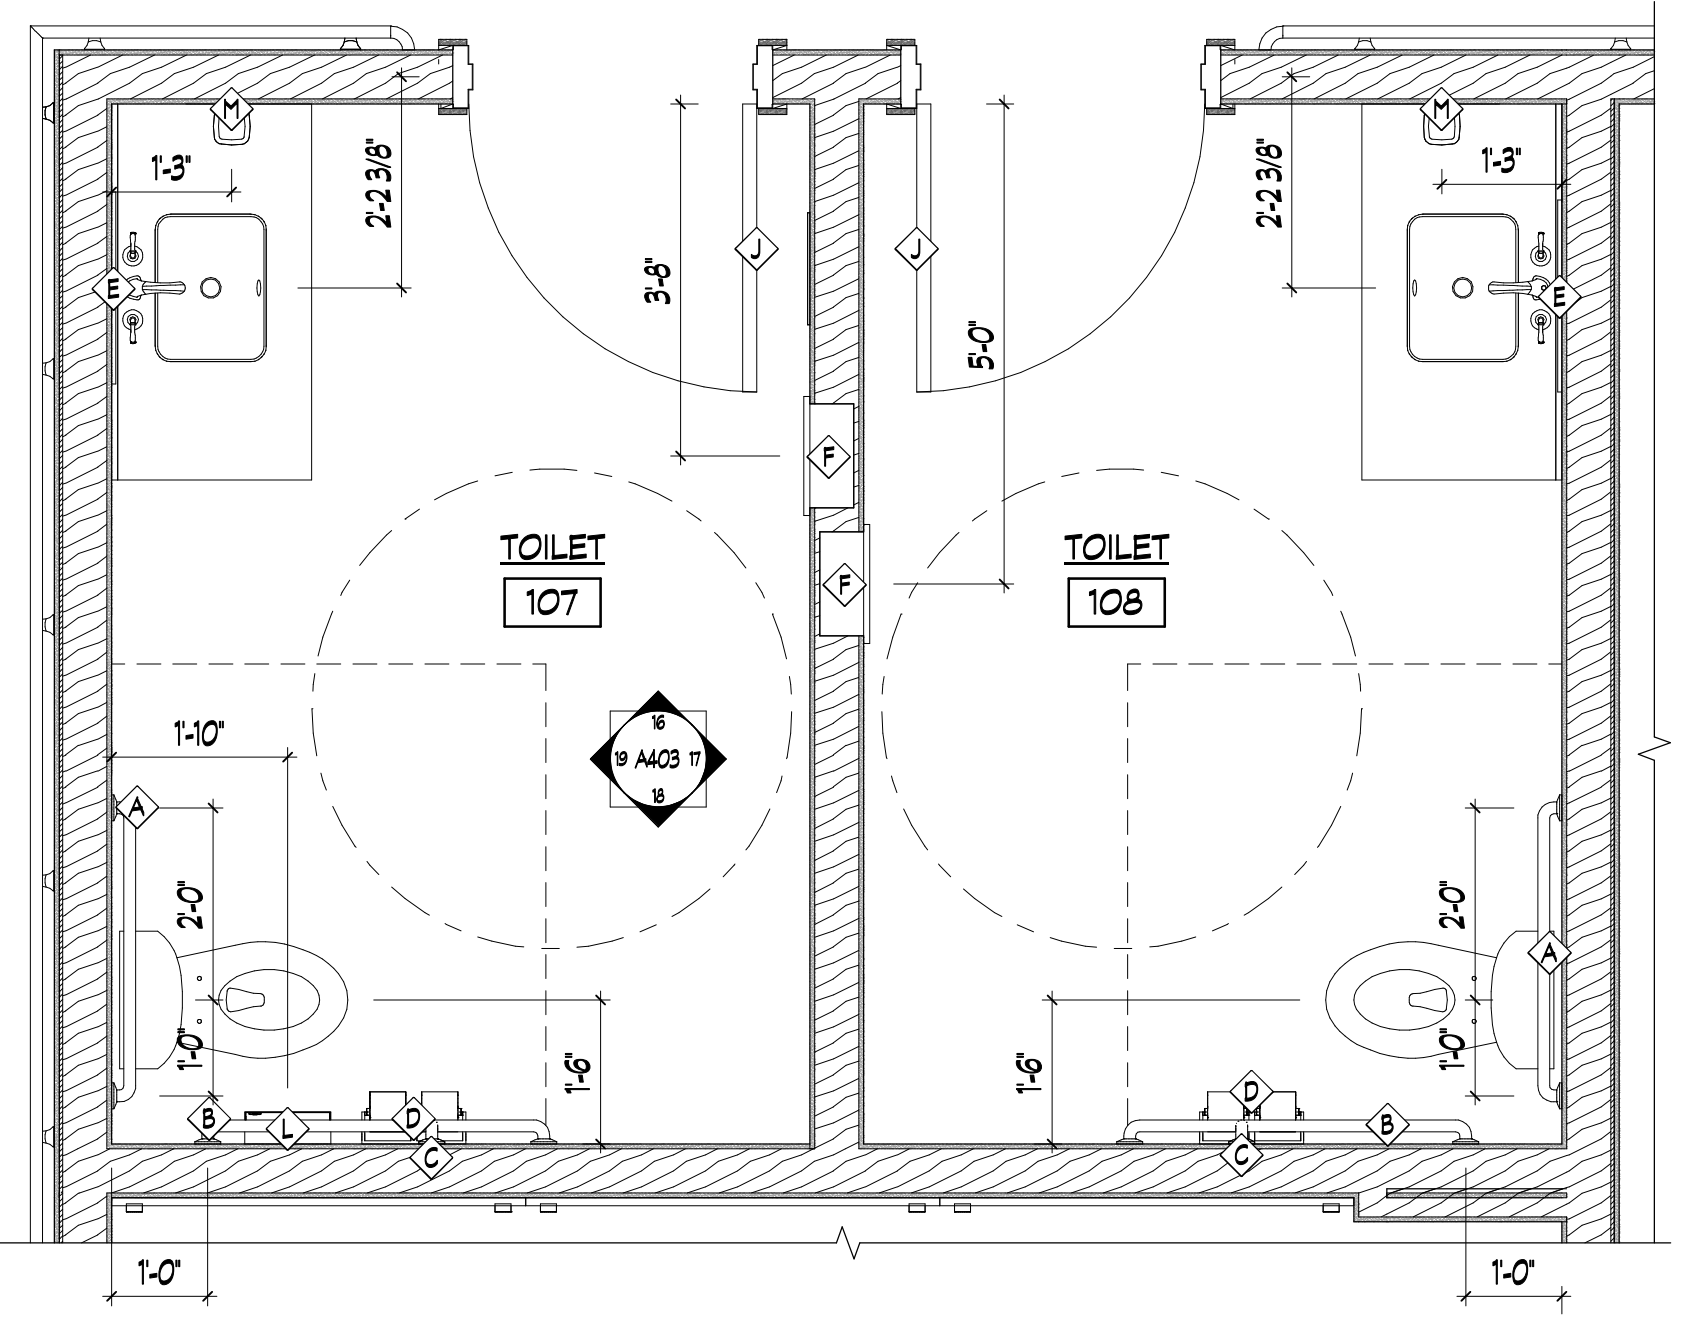


15 TOILET 107 & 108 PLAN
A102 / SCALE: 1/2" = 1'-0"

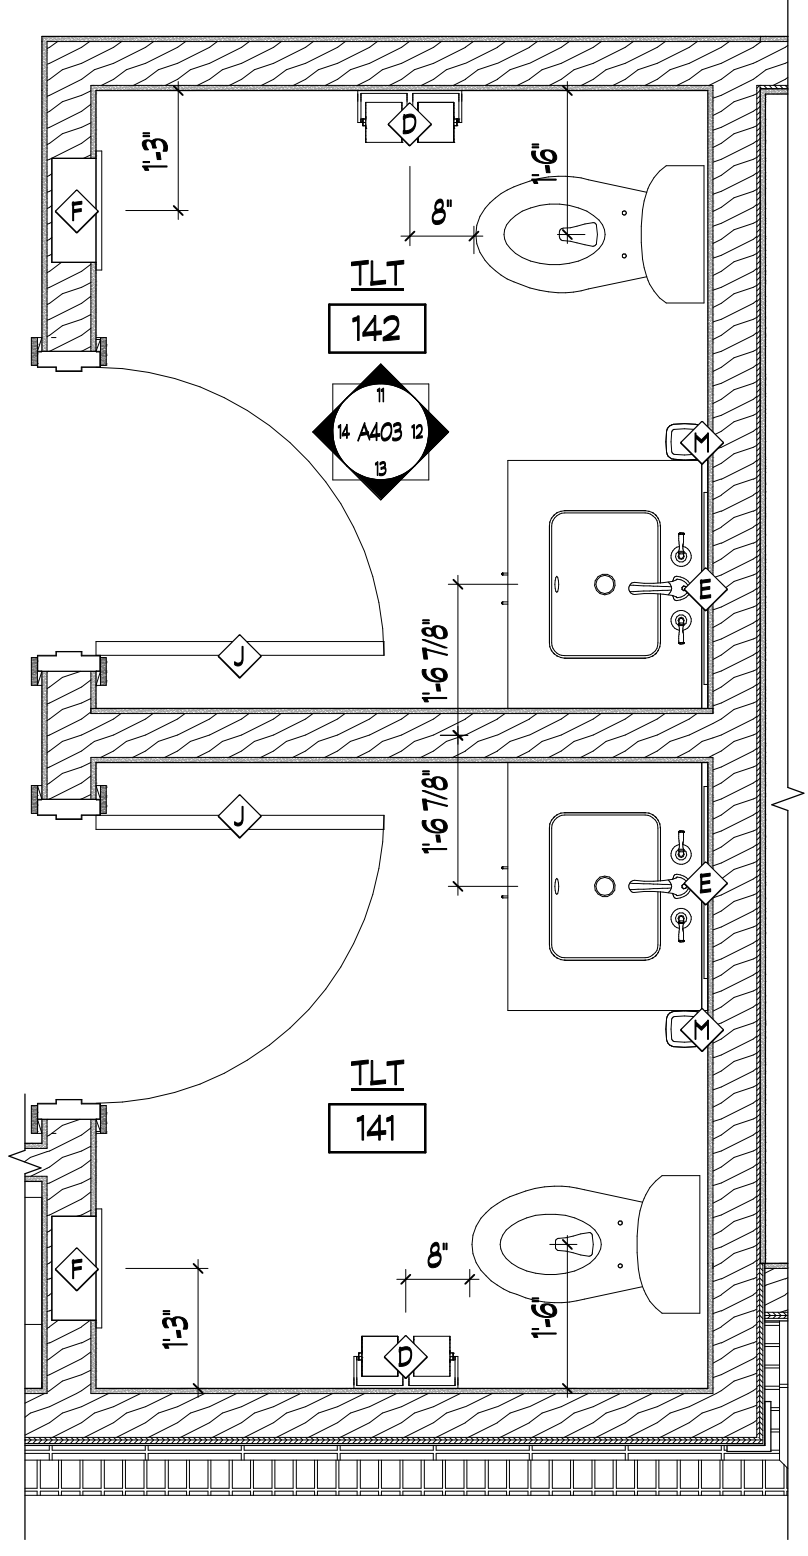


2 TOILET 141 & 142
A102 / SCALE: 1/2" = 1'-0"

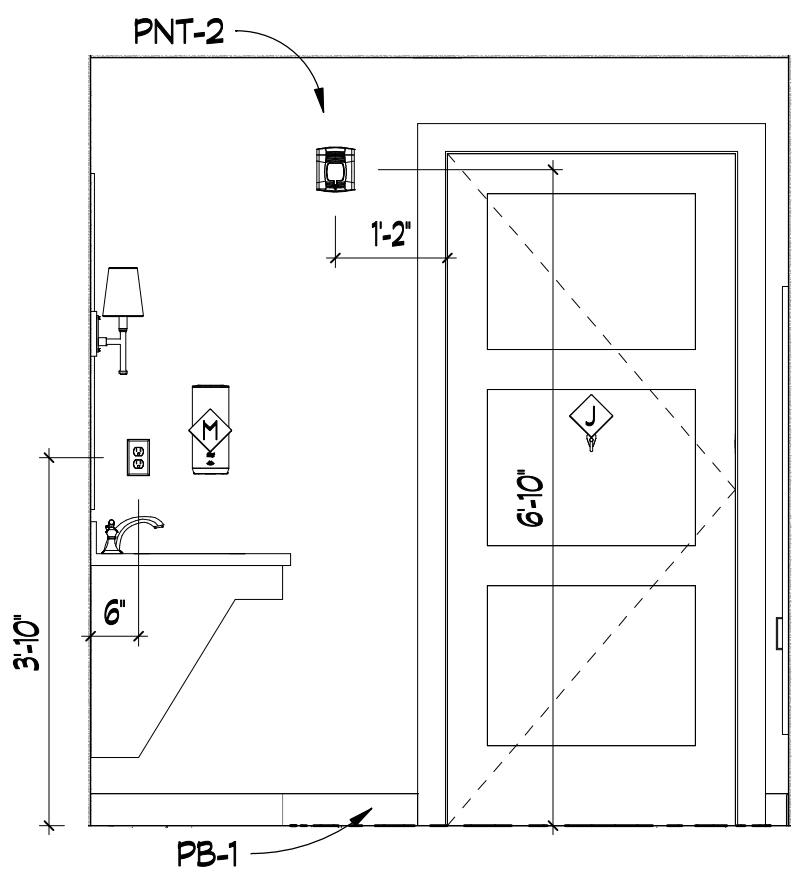


16 TOILET 107 & 108 TYP.
SCALE: 1/2" = 1'-0"

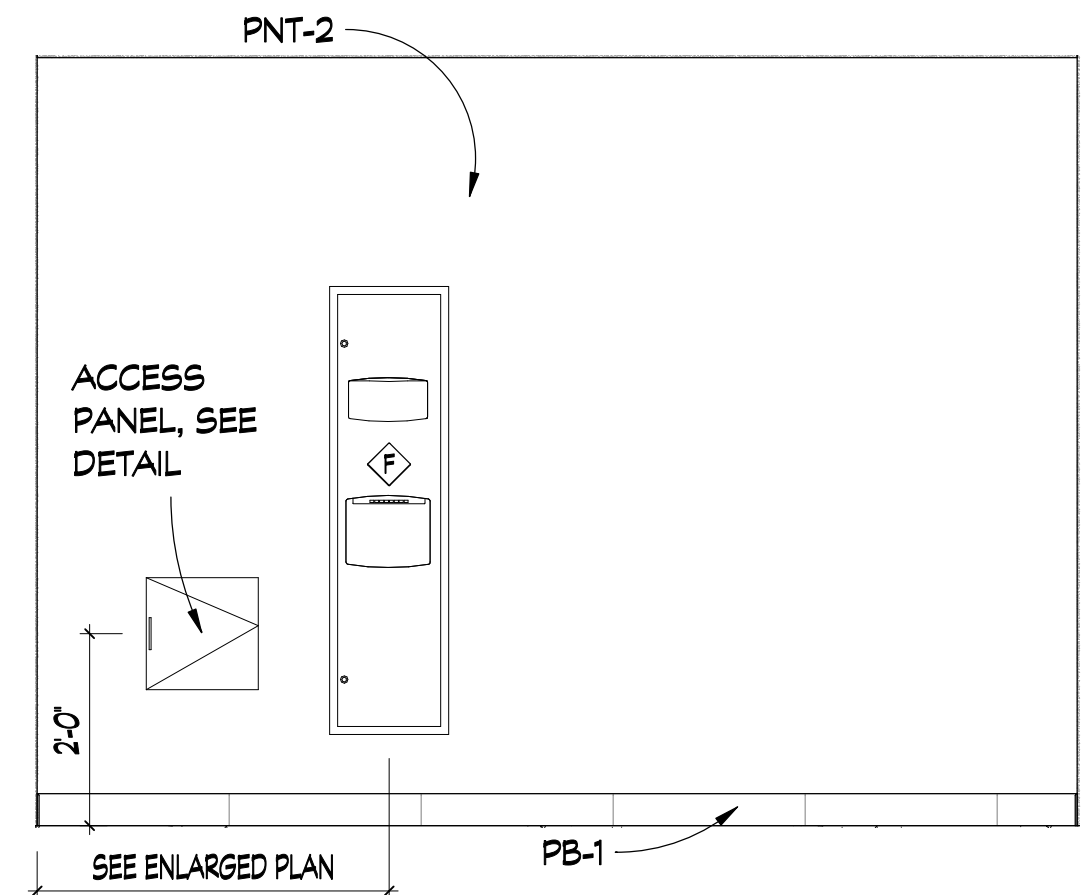


17 TOILET 107 & 108 TYP.
SCALE: 1/2" = 1'-0"

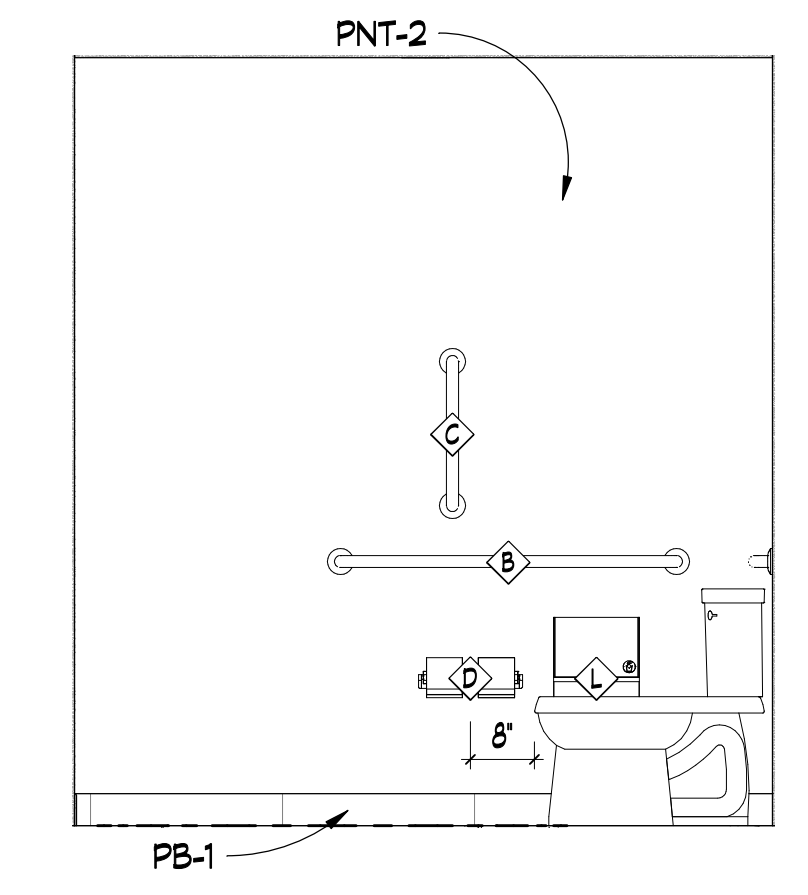


18 TOILET 107 & 108 TYP.
SCALE: 1/2" = 1'-0"

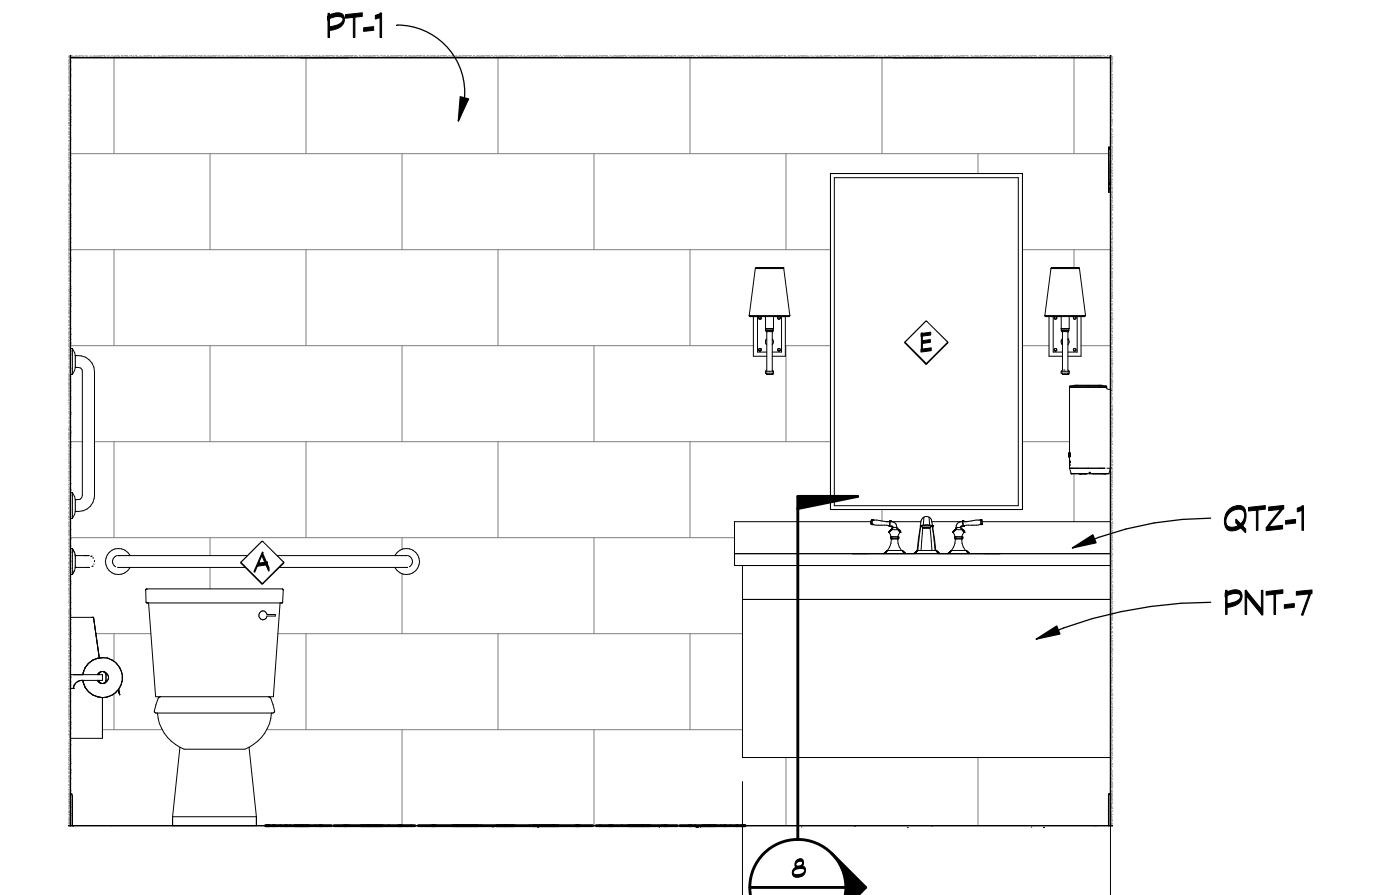


19 TOILET 107 & 108 TYP.
SCALE: 1/2" = 1'-0"

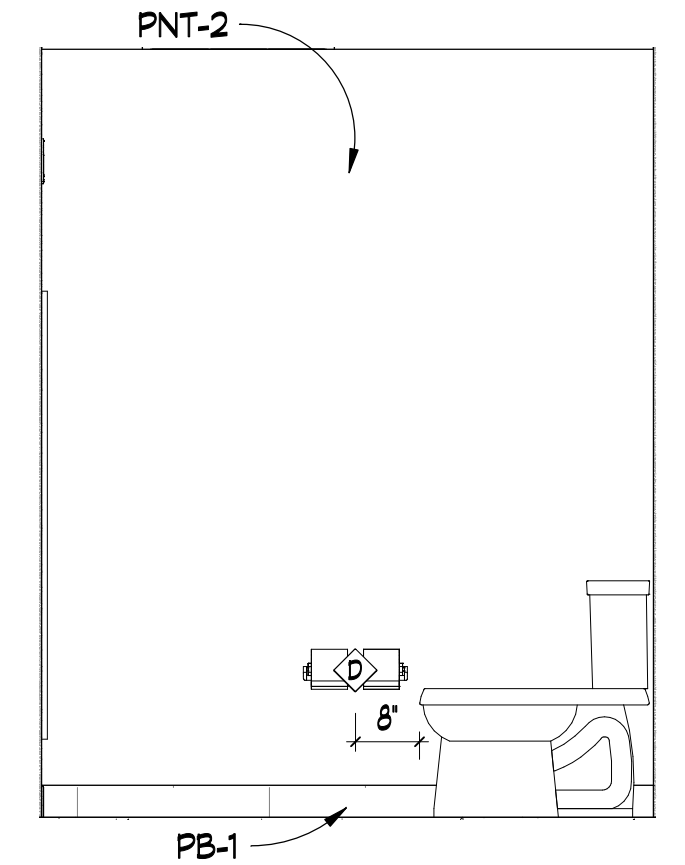


11 TOILET 141 & 142
SCALE: 1/2" = 1'-0"

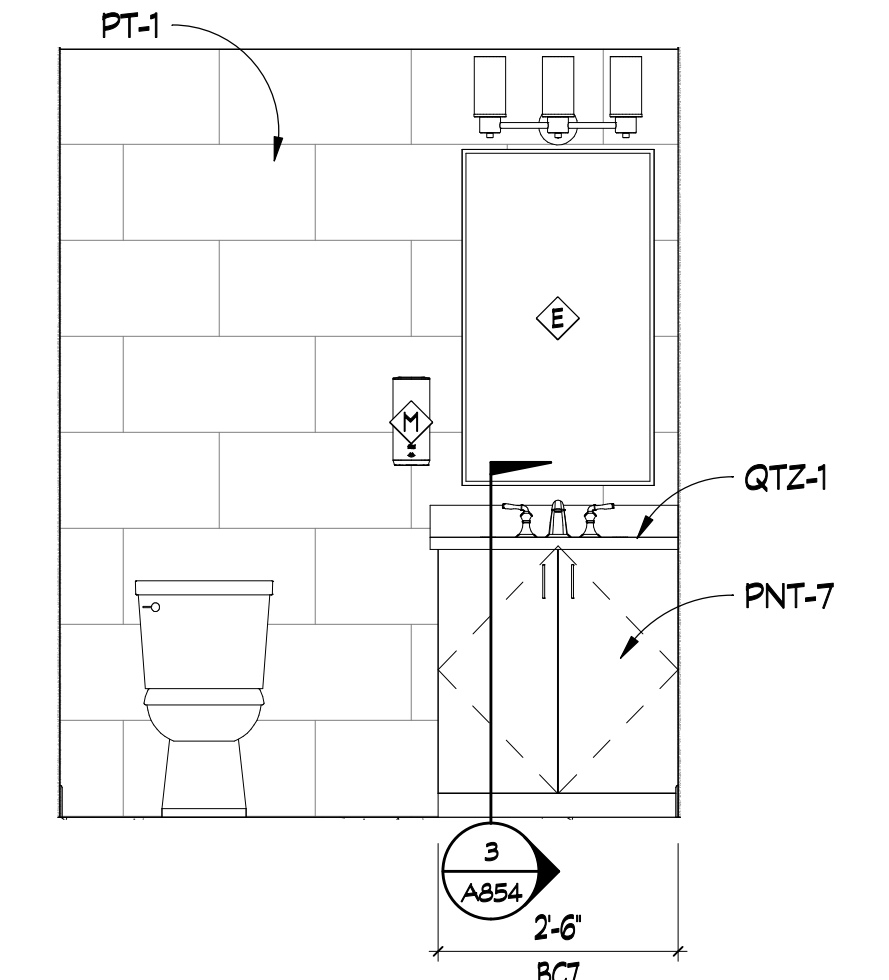

12 TOILET 141 & 142
SCALE: 1/2" = 1'-0"

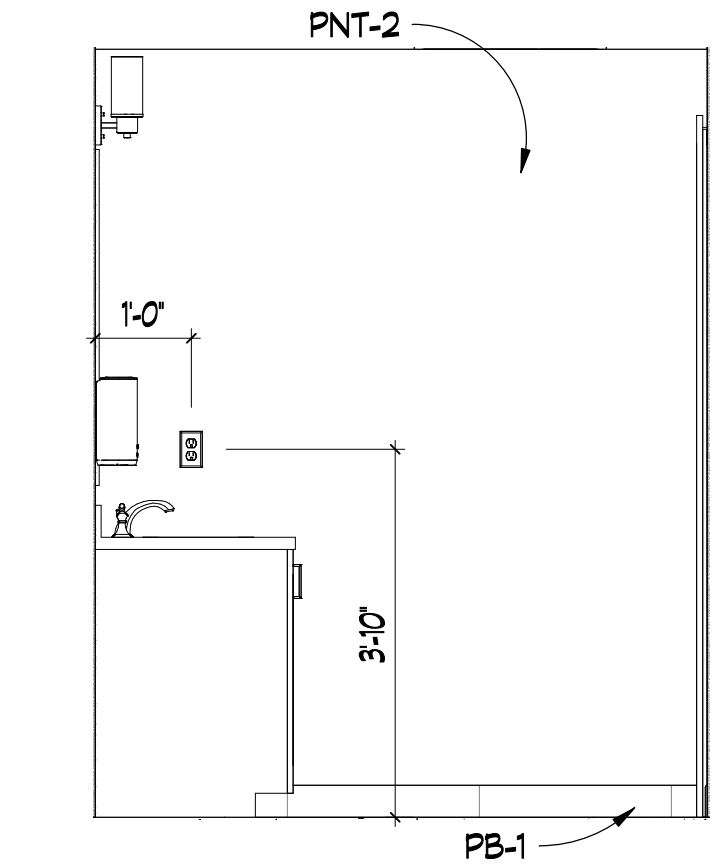



13 TOILET 141 & 142
SCALE: 1/2" = 1'-0"

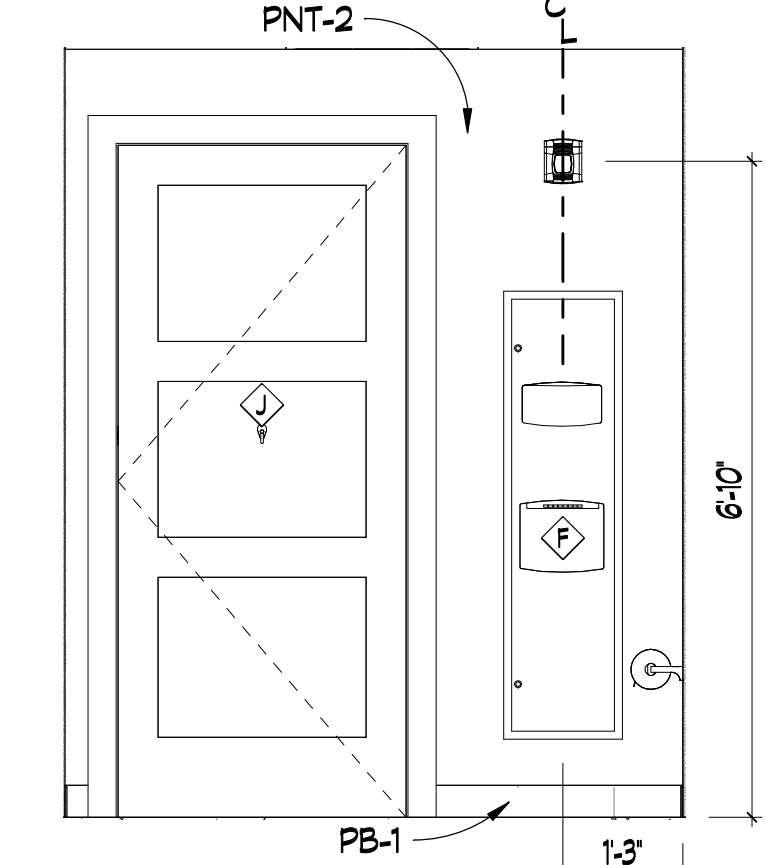

14 TOILET 141 & 142
SCALE: 1/2" = 1'-0"


TOILET ACCESSORY SCHEDULE			
-	MANUFACTURER	DESCRIPTION	MODEL
A	WINGITS	MODERN ELEGANCE 36" GRAB BAR	WGB5MESN36
B	WINGITS	MODERN ELEGANCE 42" GRAB BAR	WGB5MESN42
C	WINGITS	MODERN ELEGANCE 18" GRAB BAR	WGB5MESN18
D	WINGITS	MODERN ELEGANCE DOUBLE TOILET PAPER HOLDER	WMEDTPH6N
E	LAMPS PLUS	HELENA ANTIQUE SILVER 25" X 42" WALL MIRROR	47A99
F	BRADLEY CORPORATION	PAPER TOWEL DISPENSER / WASTE BIN	270-000000
G	WINGITS	MODERN ELEGANCE 24" GRAB BAR	WGB5MESN24
H	WINGITS	MODERN ELEGANCE 54" GRAB BAR	WGB5MESN54
J	WINGITS	MODERN ELEGANCE ROBE HOOK	WMESRHSN
K	INPRO CORP	SHOWER CURTAIN W/ TRACK	SEE A801 FOR INFO
L	BRADLEY CORPORATION	NAPKIN DISPOSAL, 1.5 GALLONS, SURFACE-MOUNTED	4722-150000
M	TORK	FOAM SOAP DISPENSER W/ INTUITION SENSOR, STAINLESS STEEL	466100
N	BRADLEY CORPORATION	UTILITY SHELF, 4 HOOKS / 3 HOLDERS	9933

TYP. TOILET ACCESSORY MOUNTING HEIGHTS

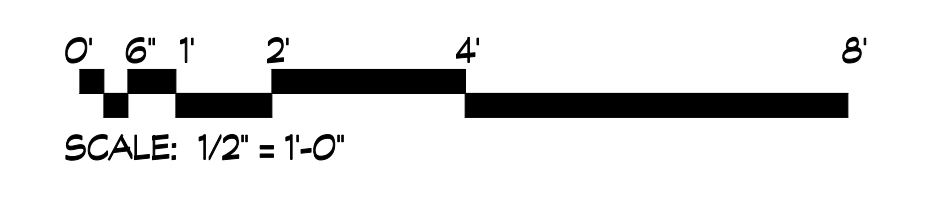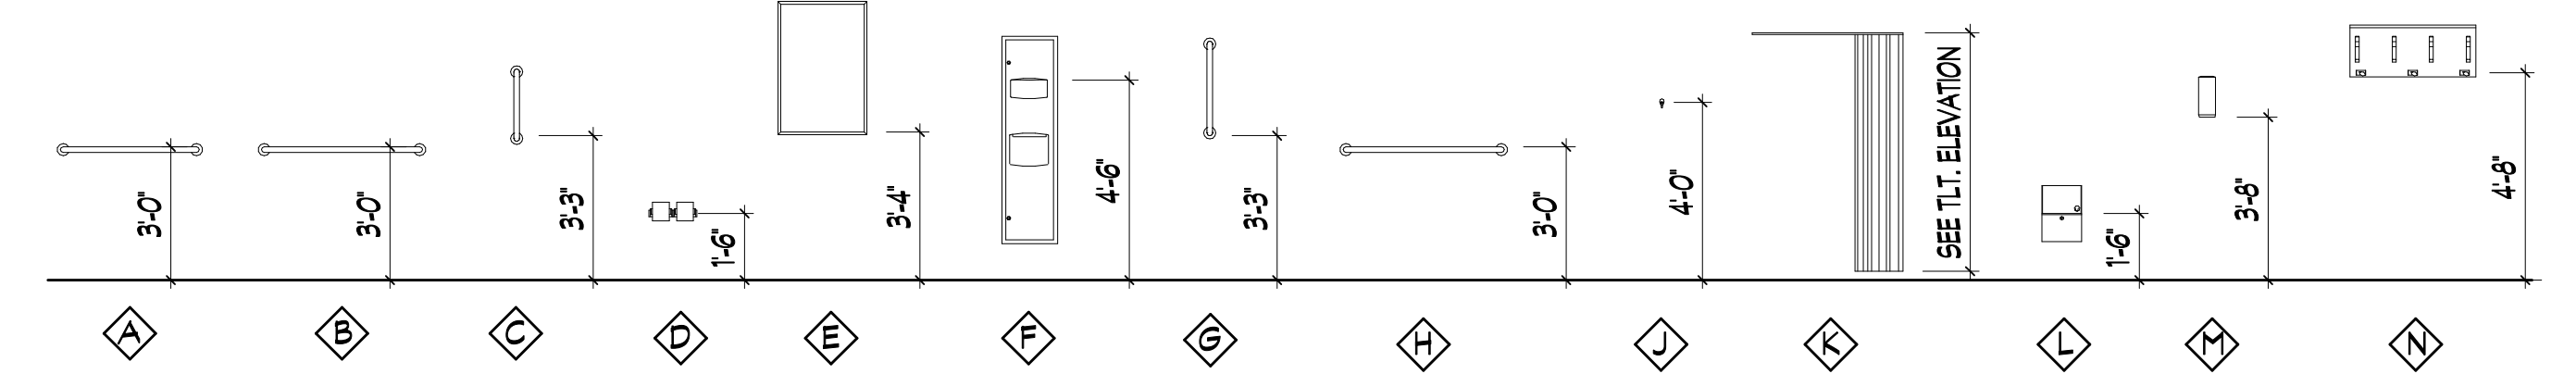

1 2 3 4 5 6

E
D
C
B
A

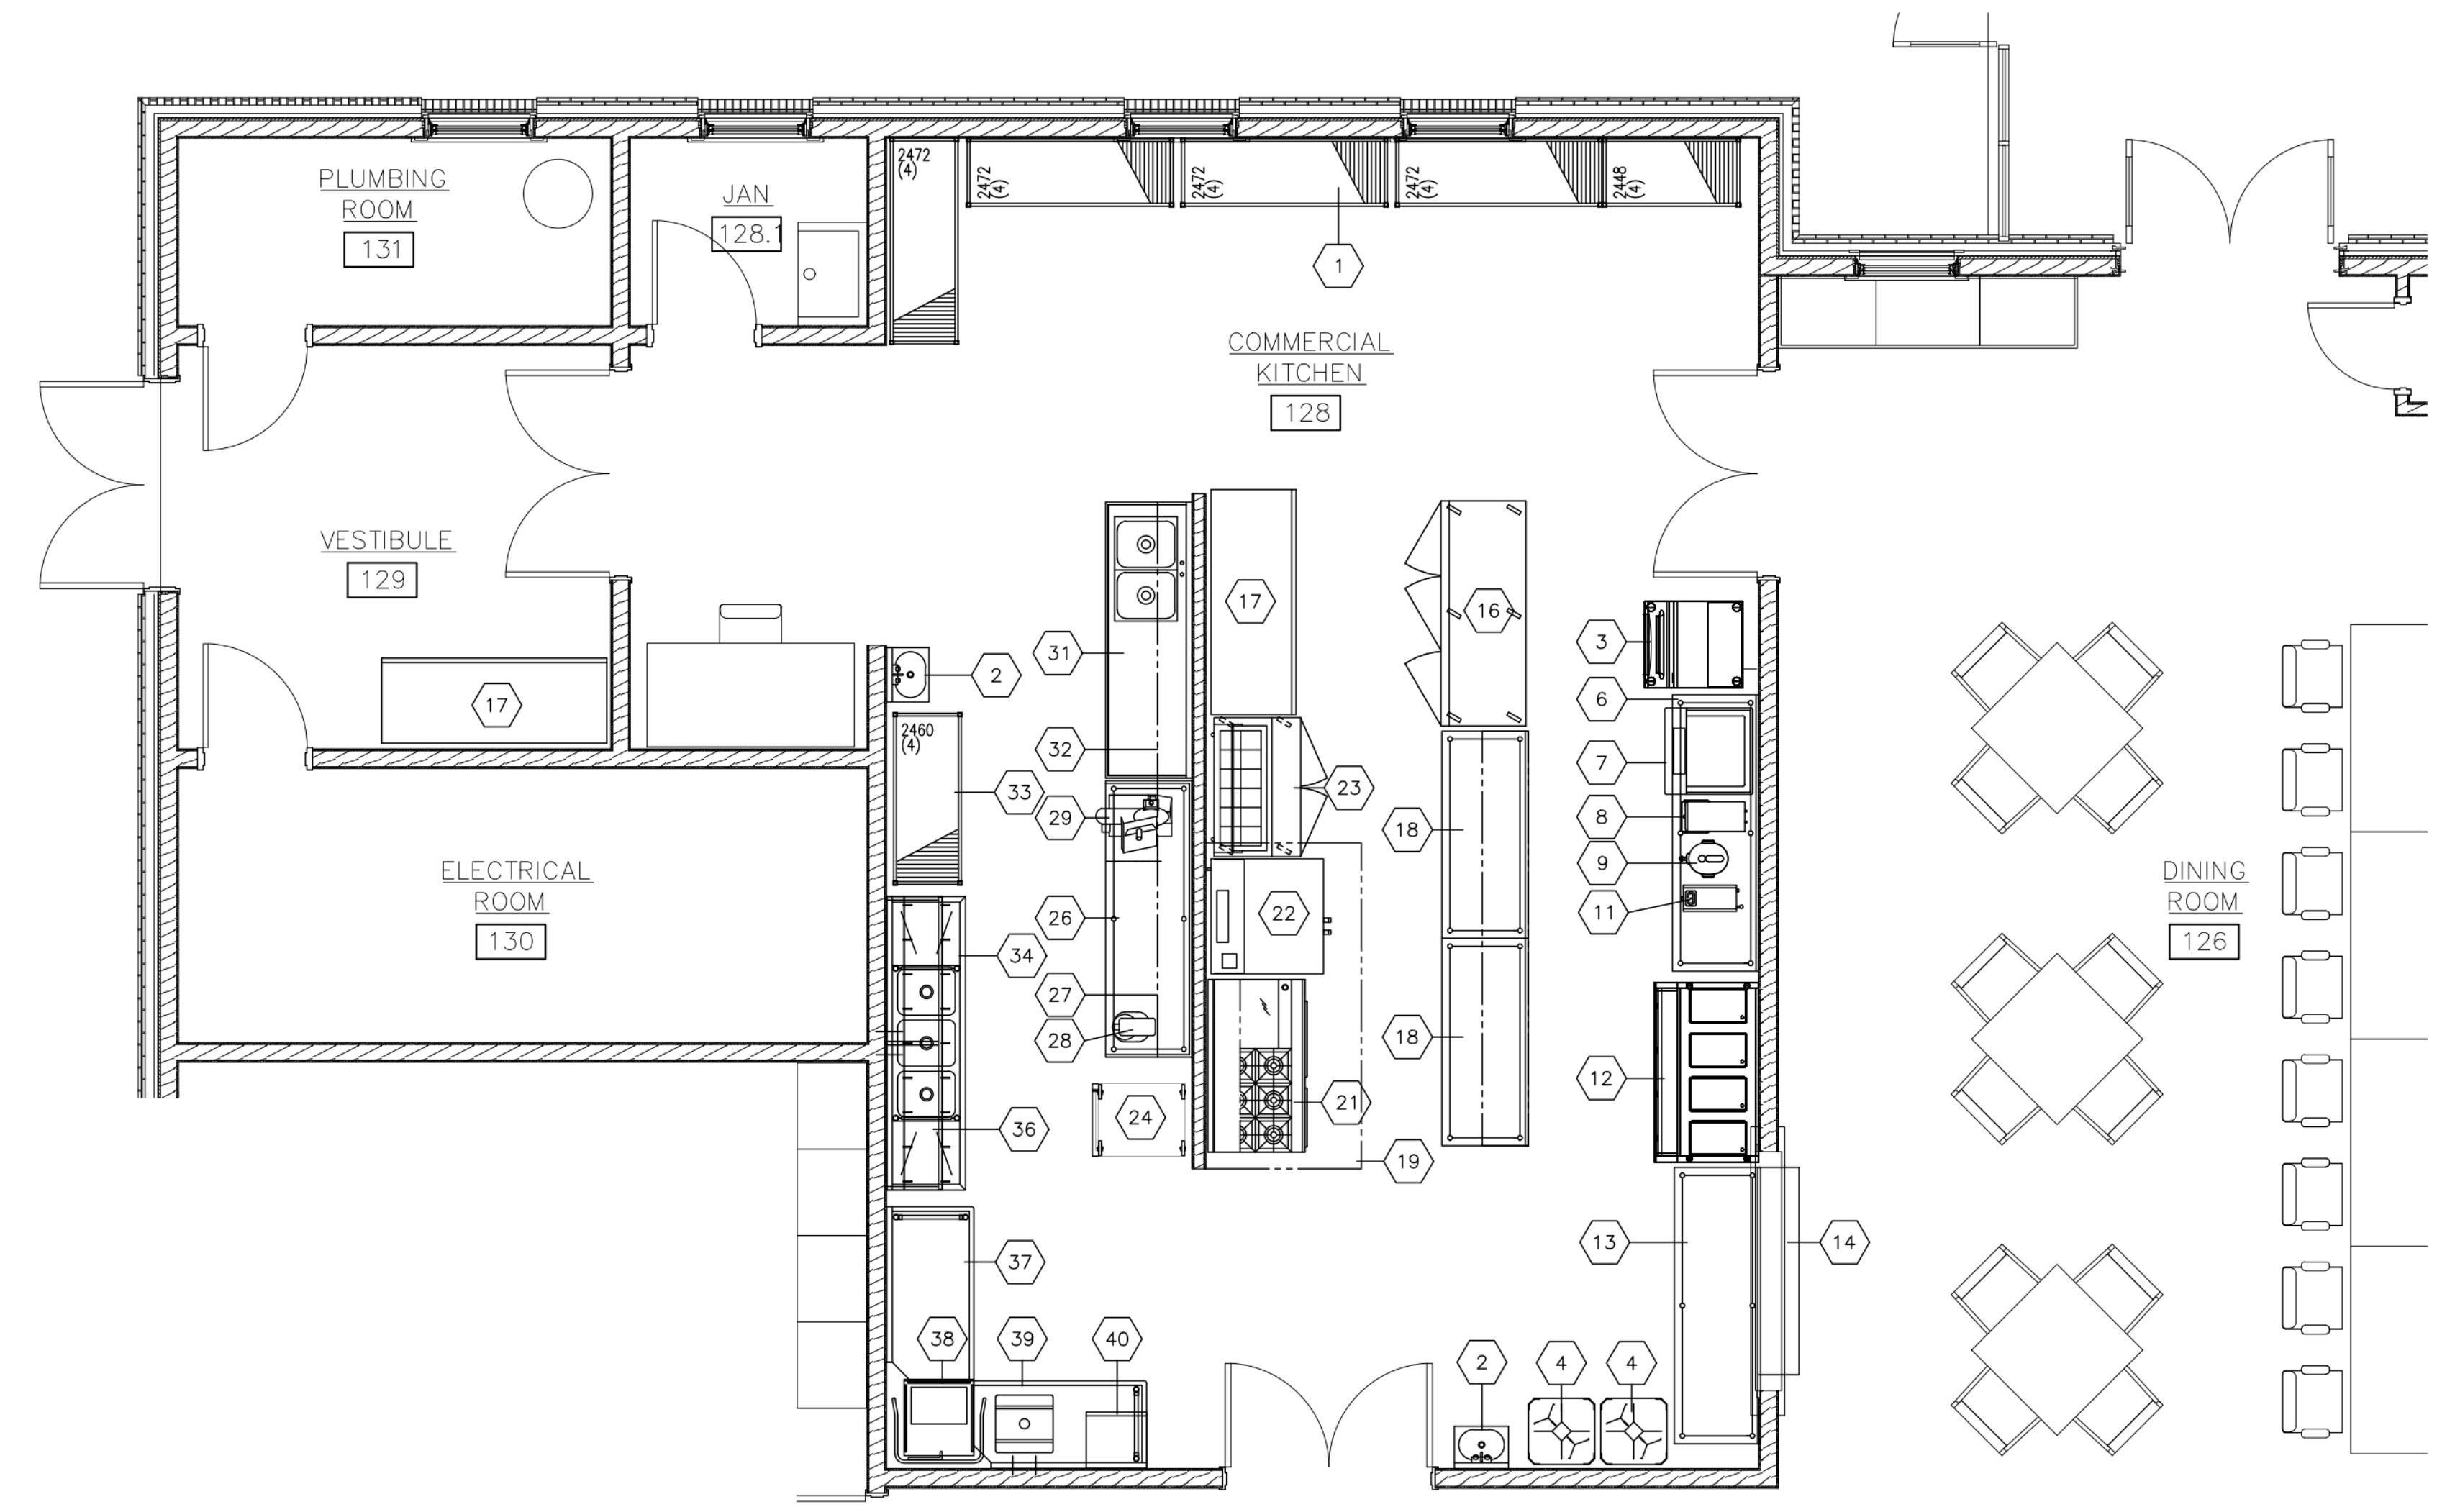

1 ENLARGED KITCHEN PLAN
SCALE: 1/4" = 1'-0"

Item No	Qty	Equipment Category
1	1	Dry Storage Shelving
2	2	Sink, Hand, Wall Mount
3	1	Ice Maker w/ Bin
4	2	Dish Dolly, Adjustable
5	-	-Spare Number-
6	1	Beverage Counter
7	1	Soda/Ice Dispenser (By Vendor)
8	1	Iced Tea Brewer (USF Beverage)
9	2	Tea Dispenser (USF Beverage)
10	-	-Spare Number-
11	1	Coffee Maker (USF Beverage)
12	1	Hot Food Table
13	1	Work Table
14	1	Pass Thru Shelf
15	-	-Spare Number-
16	1	Refrigerator, Reach-In
17	1	Freezer, Reach-In
18	2	Work Table W/Overshelf
19	1	Exhaust Hood System (By HVAC)
20	-	-Spare Number-
21	1	Range W/Griddle/Broiler
22	1	Double Convection Oven
23	1	Salad/Sandwich Prep Refrigerator
24	1	Holding/Proofing Cabinet
25	-	-Spare Number-
26	1	Work Table
27	1	Wall Shelf
28	1	Mixer, Counter
29	1	Slicer, Food
30	-	-Spare Number-
31	1	Prep Table W/Sinks
32	1	Wall Shelf
33	1	Clean Pot/Pan Shelving
34	1	Sink, Scullery, 3 Compartments
35	-	-Spare Number-
36	1	Wall Mount Shelf W/ Potrack
37	1	Dishable, Straight, Clean
38	1	Washer, Door Type, Low Temp
39	1	Dishable, Straight, Soiled
40	1	Shelf, Sort, Wall Mount Racks
40	-	-Spare Number-

THIS DRAWING IS NOT MEANT TO SUPPLANT ANY REQUIRED ARCHITECTURAL AND/OR ENGINEERING DRAWINGS. THIS DRAWING REFLECTS DATA ABOUT THE FOOD SERVICE EQUIPMENT IN ACCORDANCE WITH INFORMATION WE HAD WHEN THIS DRAWING WAS MADE. PLEASE REFER TO THE PROPER ARCHITECTURAL AND ENGINEERING DRAWINGS FOR ANY BUILDING OR SITE WORK INFORMATION.

PROJECT: JUD HICKEY CENTER
LOCATION: AUGUSTA, GA
OWNER/AGENT:
DETAILS OF: PRELIMINARY EQUIPMENT PLAN

US FOODS
P.O. BOX 869
LEXINGTON, SC 29071
LEXINGTON, SC - CONWAY, SC - CHARLESTON, SC - SAVANNAH, GA - AUGUSTA, GA

REVISION	
Δ	D.F.F. 7-2-21
Δ	D.F.F. 10-29-21

DRAWN BY:
DANNY FRICK
APPROVED BY:

DATE:
6-28-21
PROJECT NUMBER:
21-JH-001
SCALE:
1/4"=1'-0"

SHEET
1 OF 1

Member of the American Institute of Architects

PROJECT TITLE:
JUD C HICKEY CENTER


REVISIONS			
REV #	DATE	APPROV BY	REVISION
	2/16/22	EA	ISSUE FOR PERMIT

DA PROJECT NUMBER & NAME:
1893
DRAWING TITLE:
ENLARGED KITCHEN PLANS
DRAWING NO:
A410


NOTE: KITCHEN EQUIPMENT INCLUDED FOR REFERENCE ONLY.
SEE CUT SHEETS FROM OWNER FOR ADDITIONAL INFORMATION

1 2 3 4 5 6


E
D
C
B
A

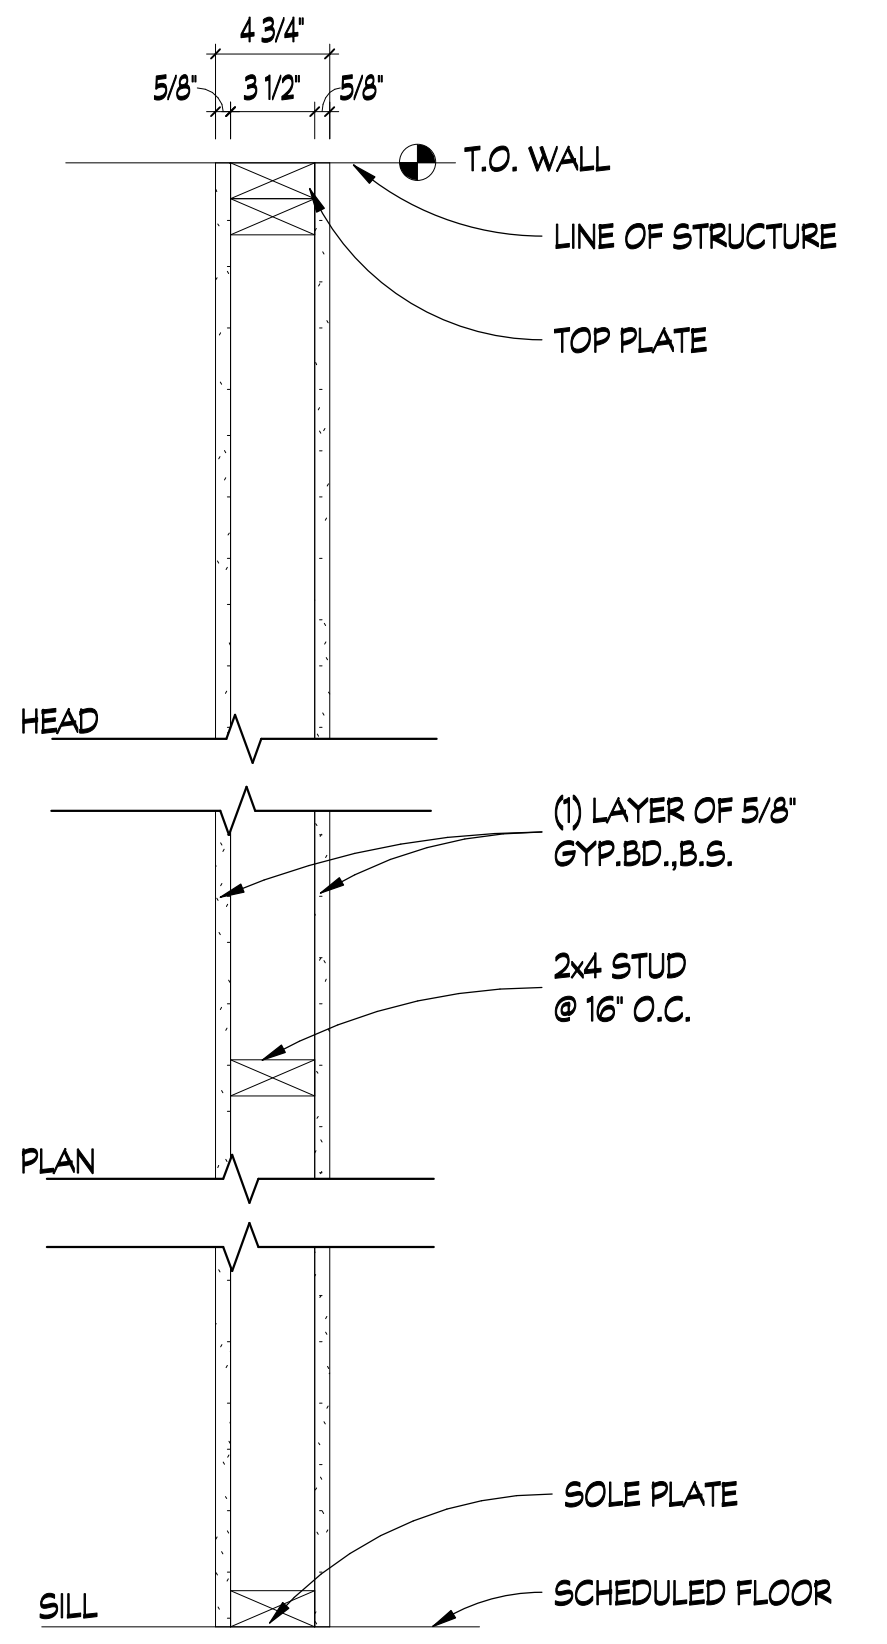


1 INTERIOR STUD WALL
SCALE: 1 1/2" = 1'-0"
FIRE RATING: [] S.T.C. RATING: []

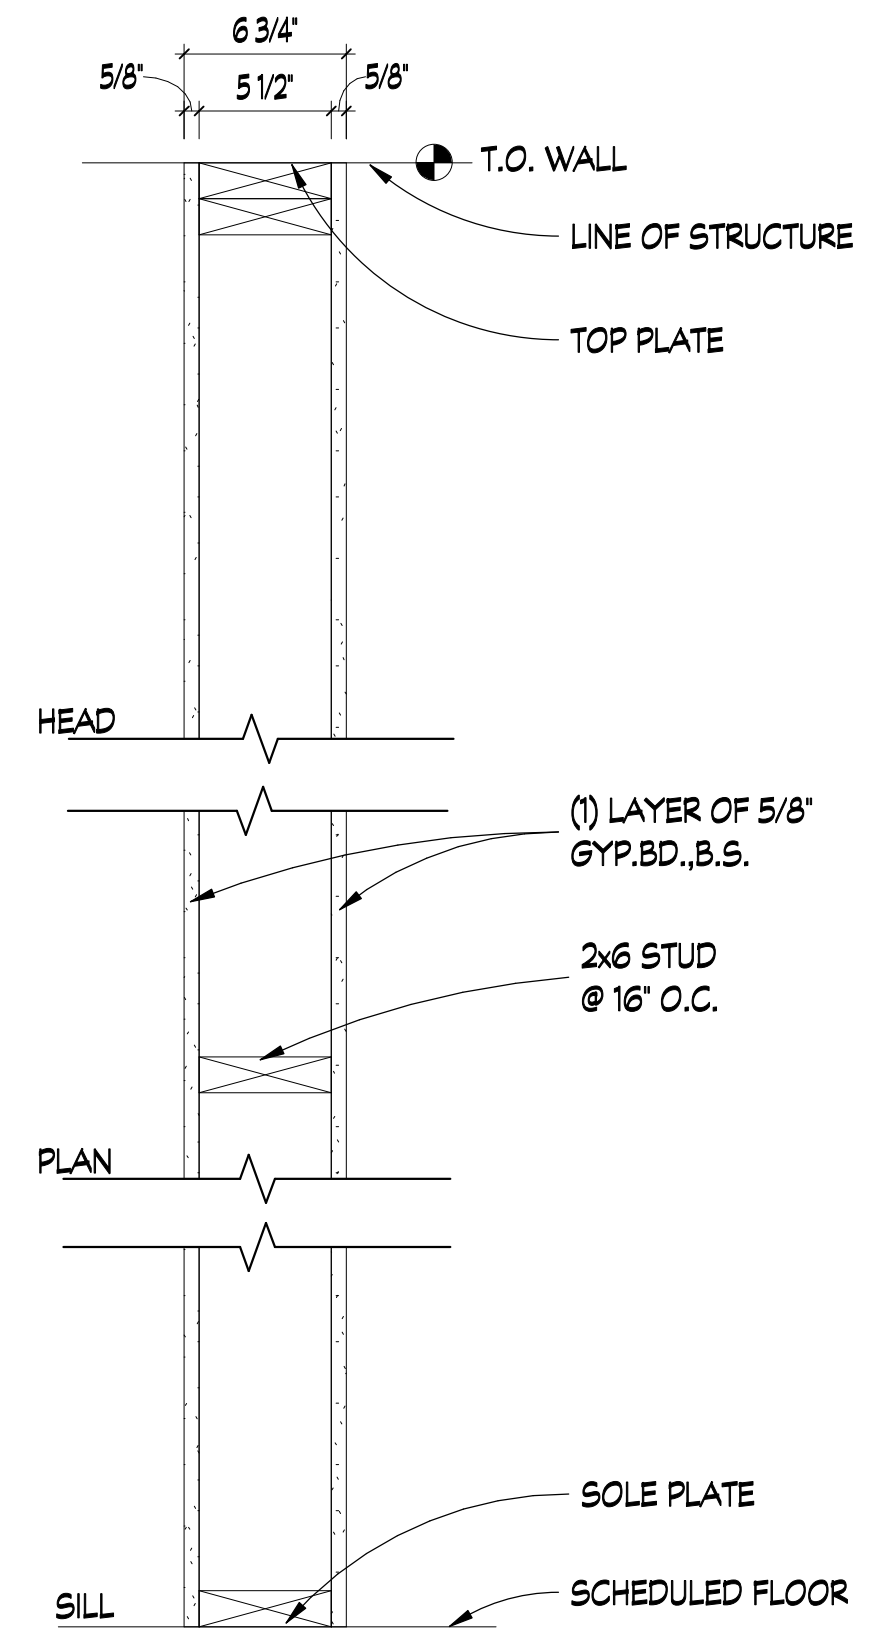

2 INTERIOR STUD WALL
SCALE: 1 1/2" = 1'-0"
FIRE RATING: [] S.T.C. RATING: []

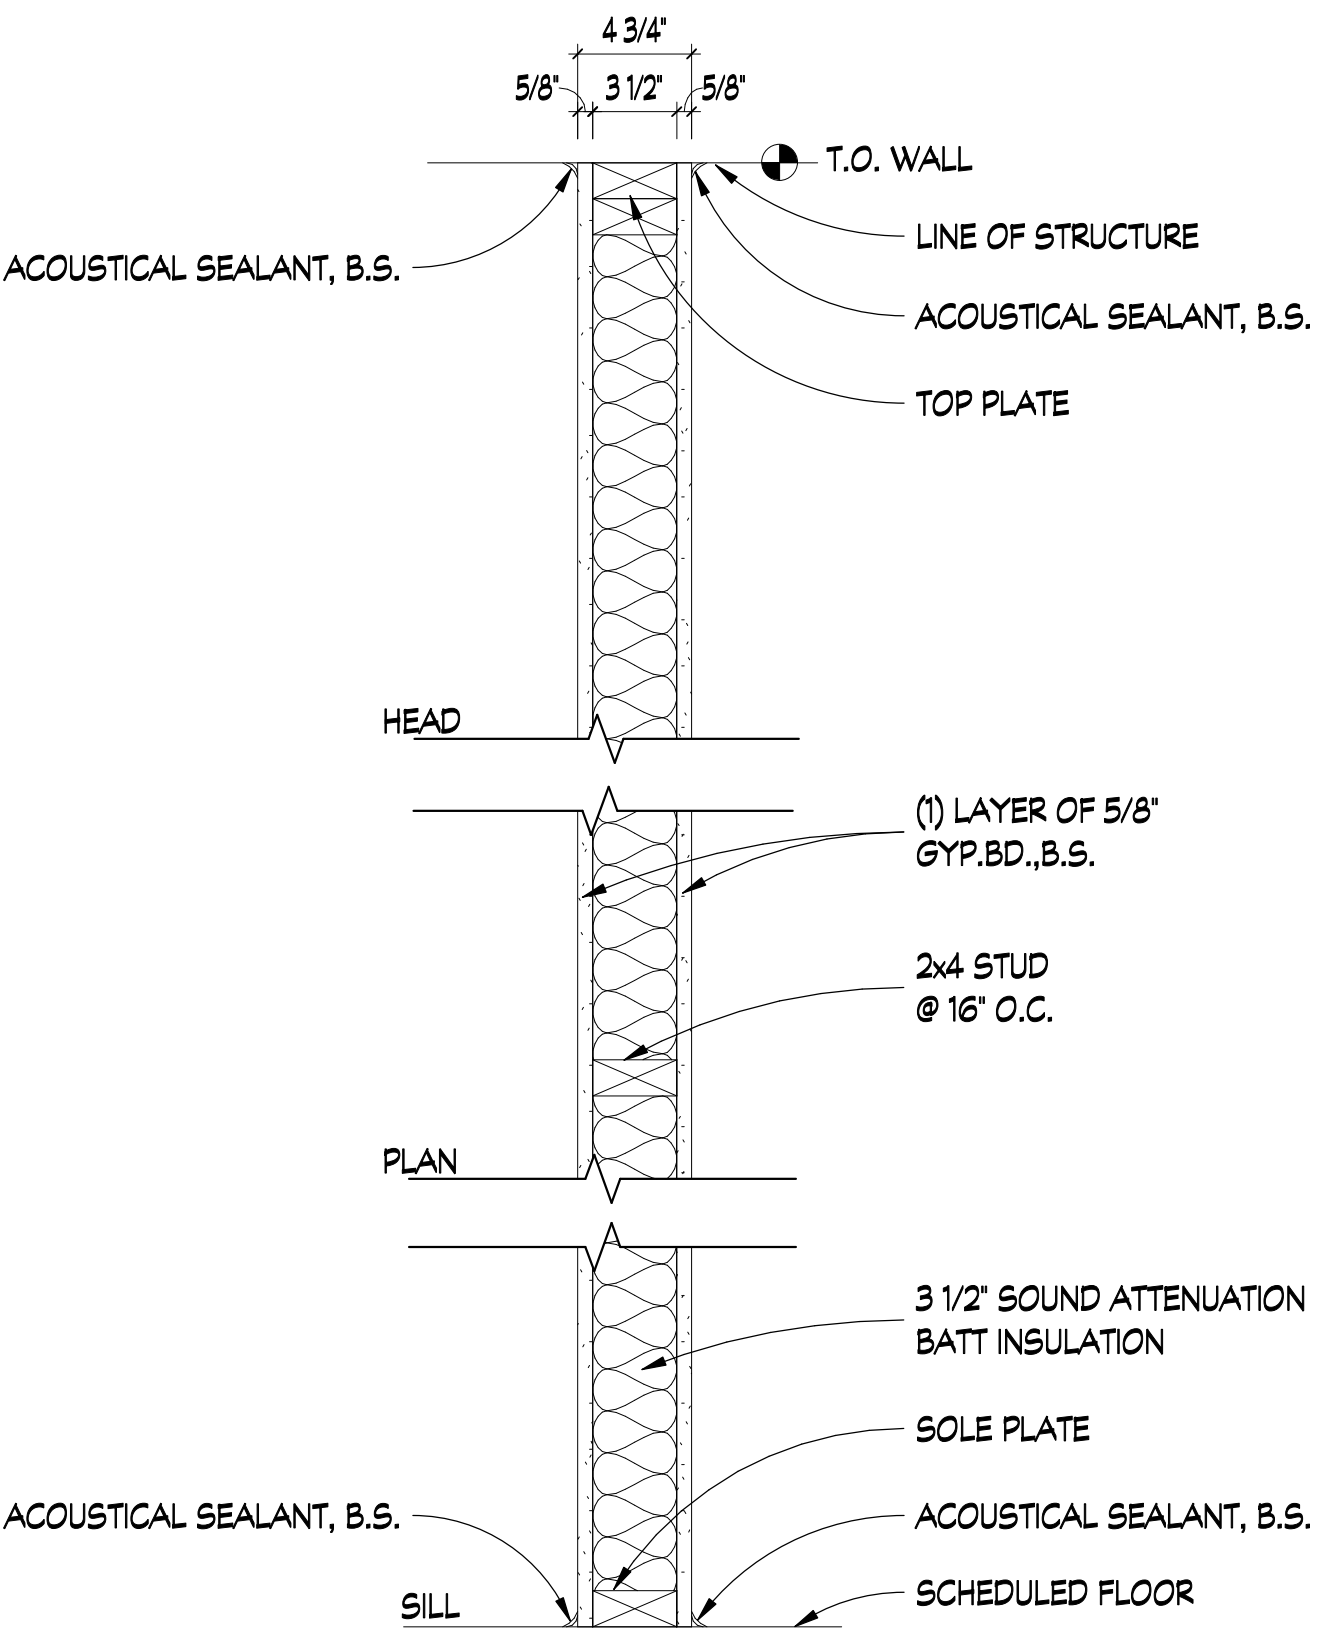


3 INTERIOR STUD WALL
SCALE: 1 1/2" = 1'-0"
FIRE RATING: [] S.T.C. RATING: []

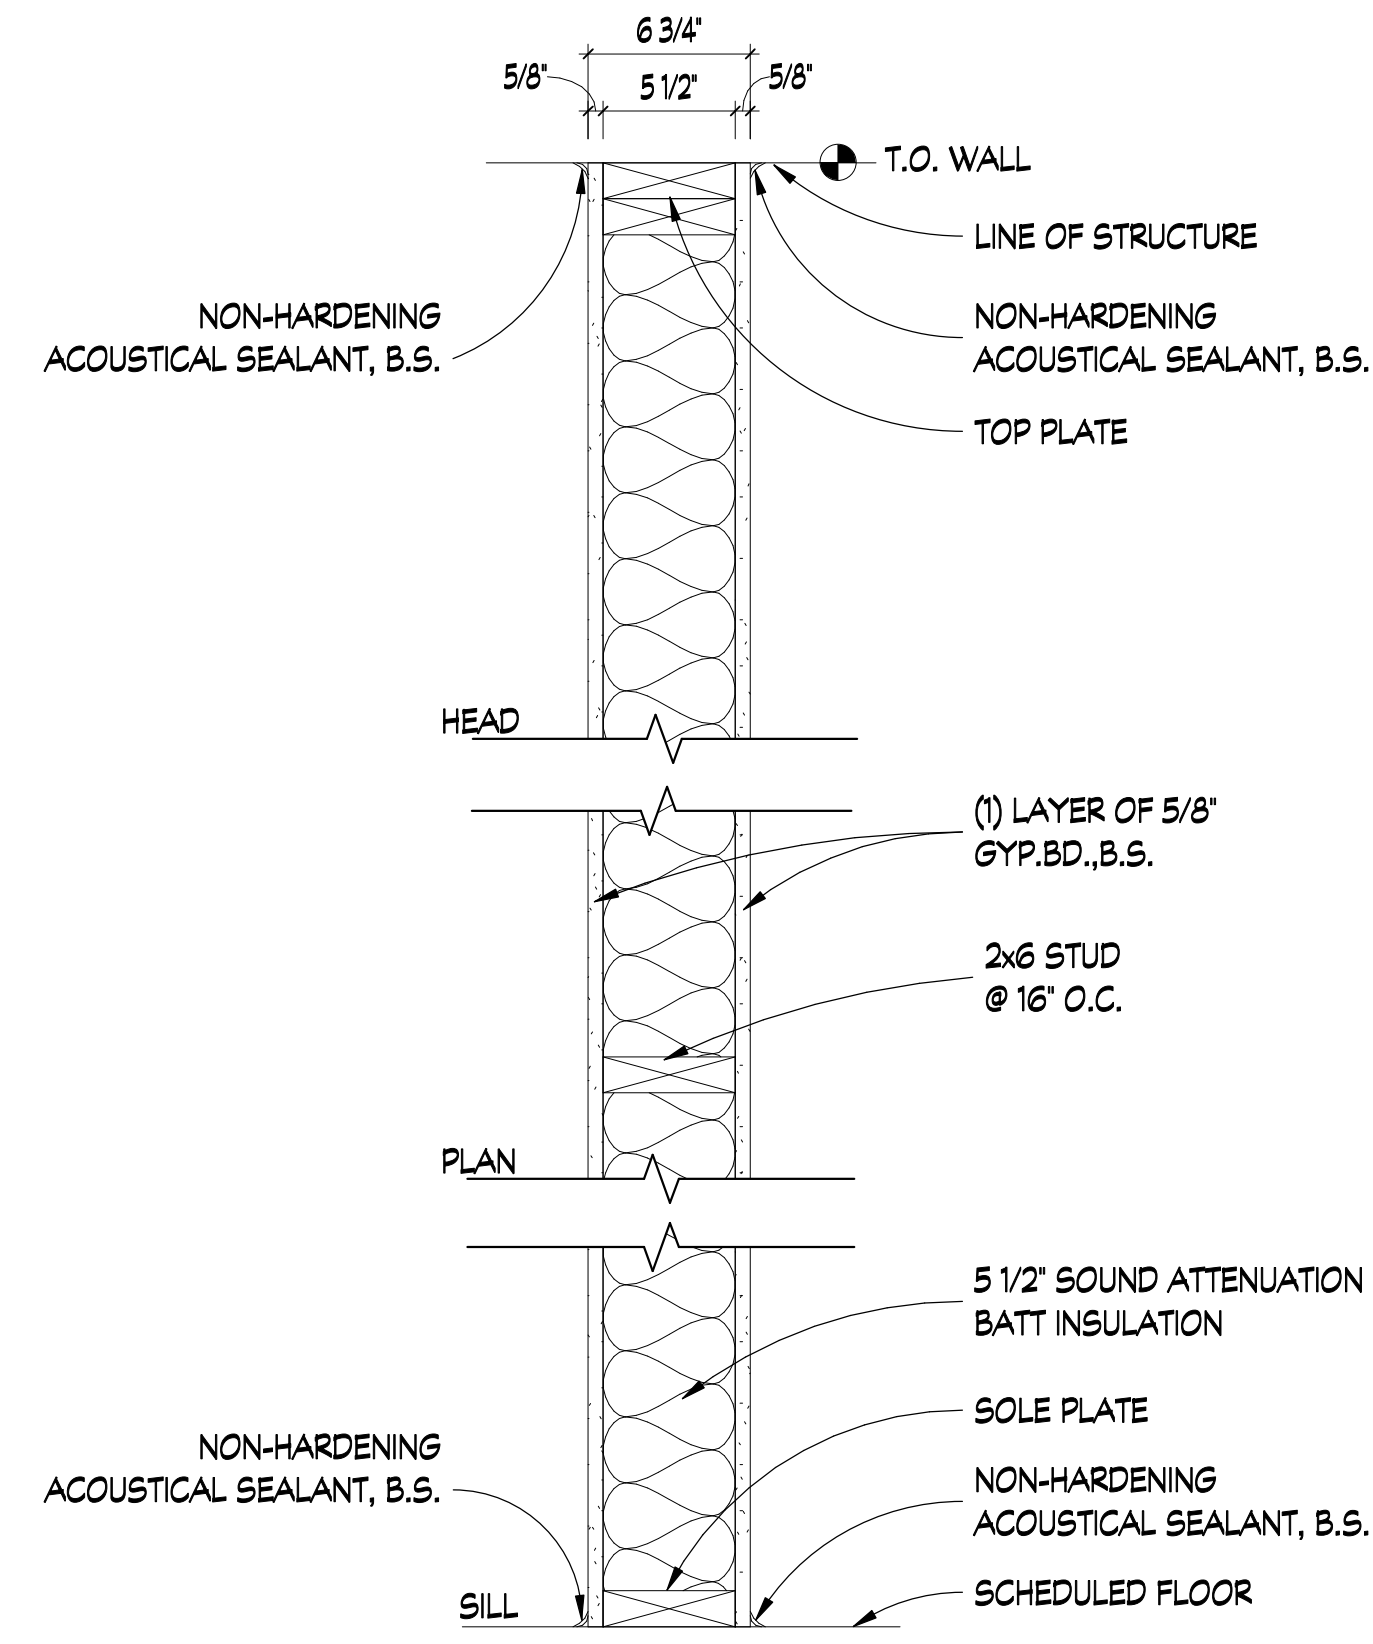


4 INTERIOR STUD WALL
SCALE: 1 1/2" = 1'-0"
FIRE RATING: [] S.T.C. RATING: [] U.L. U305 1 HR

NOTE: SEE LIFE SAFETY SHEET FOR RATED WALL LOCATIONS. IF NOT INDICATED AS RATED ON LIFE SAFETY SHEET, FIRE RATING IS NOT REQUIRED AT THAT LOCATION.

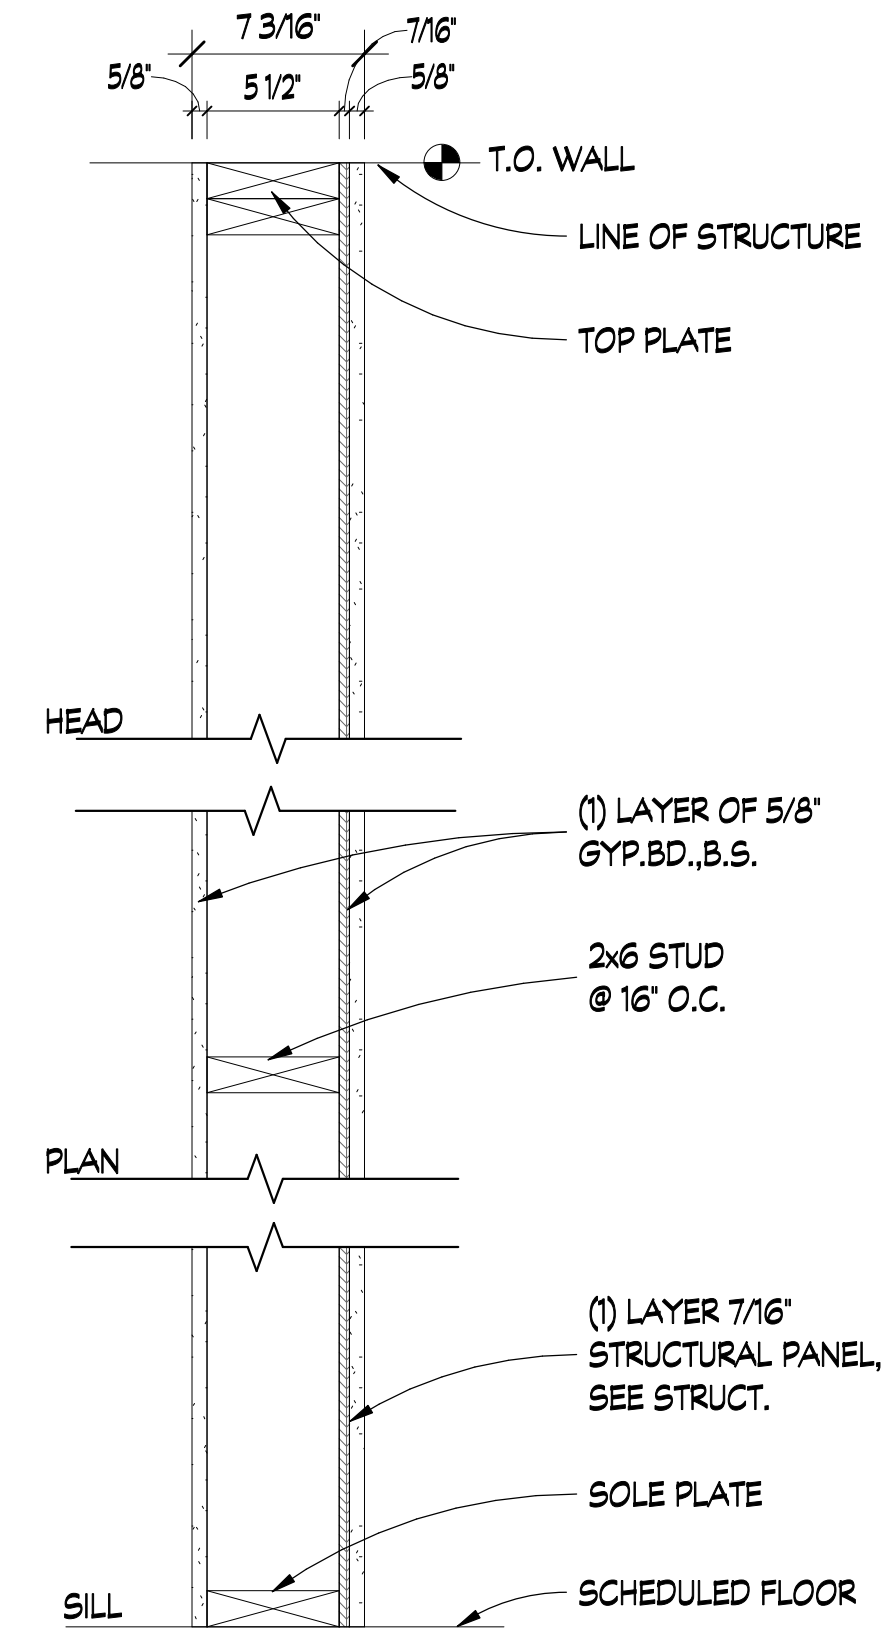


5 INTERIOR STUD WALL
SCALE: 1 1/2" = 1'-0"
FIRE RATING: [] S.T.C. RATING: []

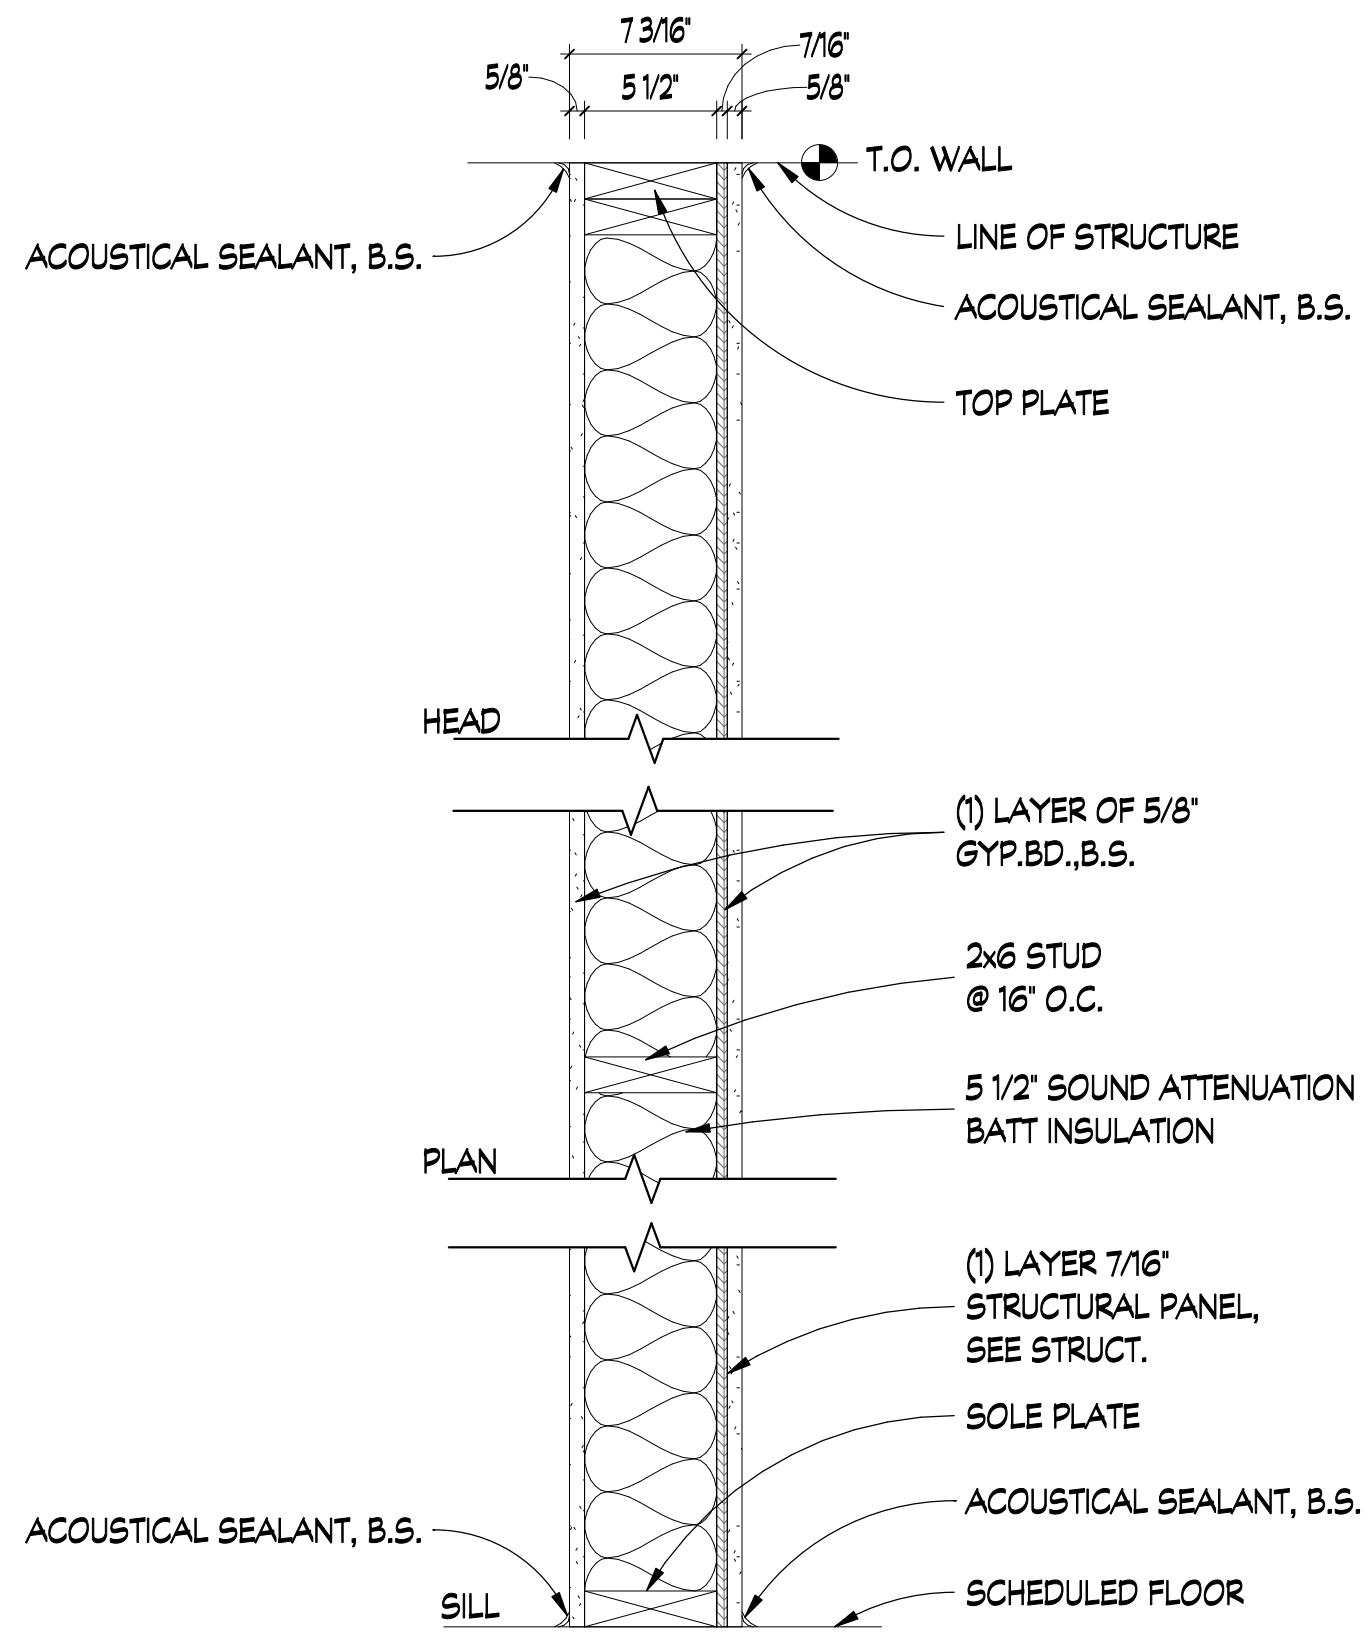

6 INTERIOR STUD WALL
SCALE: 1 1/2" = 1'-0"
FIRE RATING: [] S.T.C. RATING: [] U.L. U305 1 HR


NOTE: SEE LIFE SAFETY SHEET FOR RATED WALL LOCATIONS. IF NOT INDICATED AS RATED ON LIFE SAFETY SHEET, FIRE RATING IS NOT REQUIRED AT THAT LOCATION.

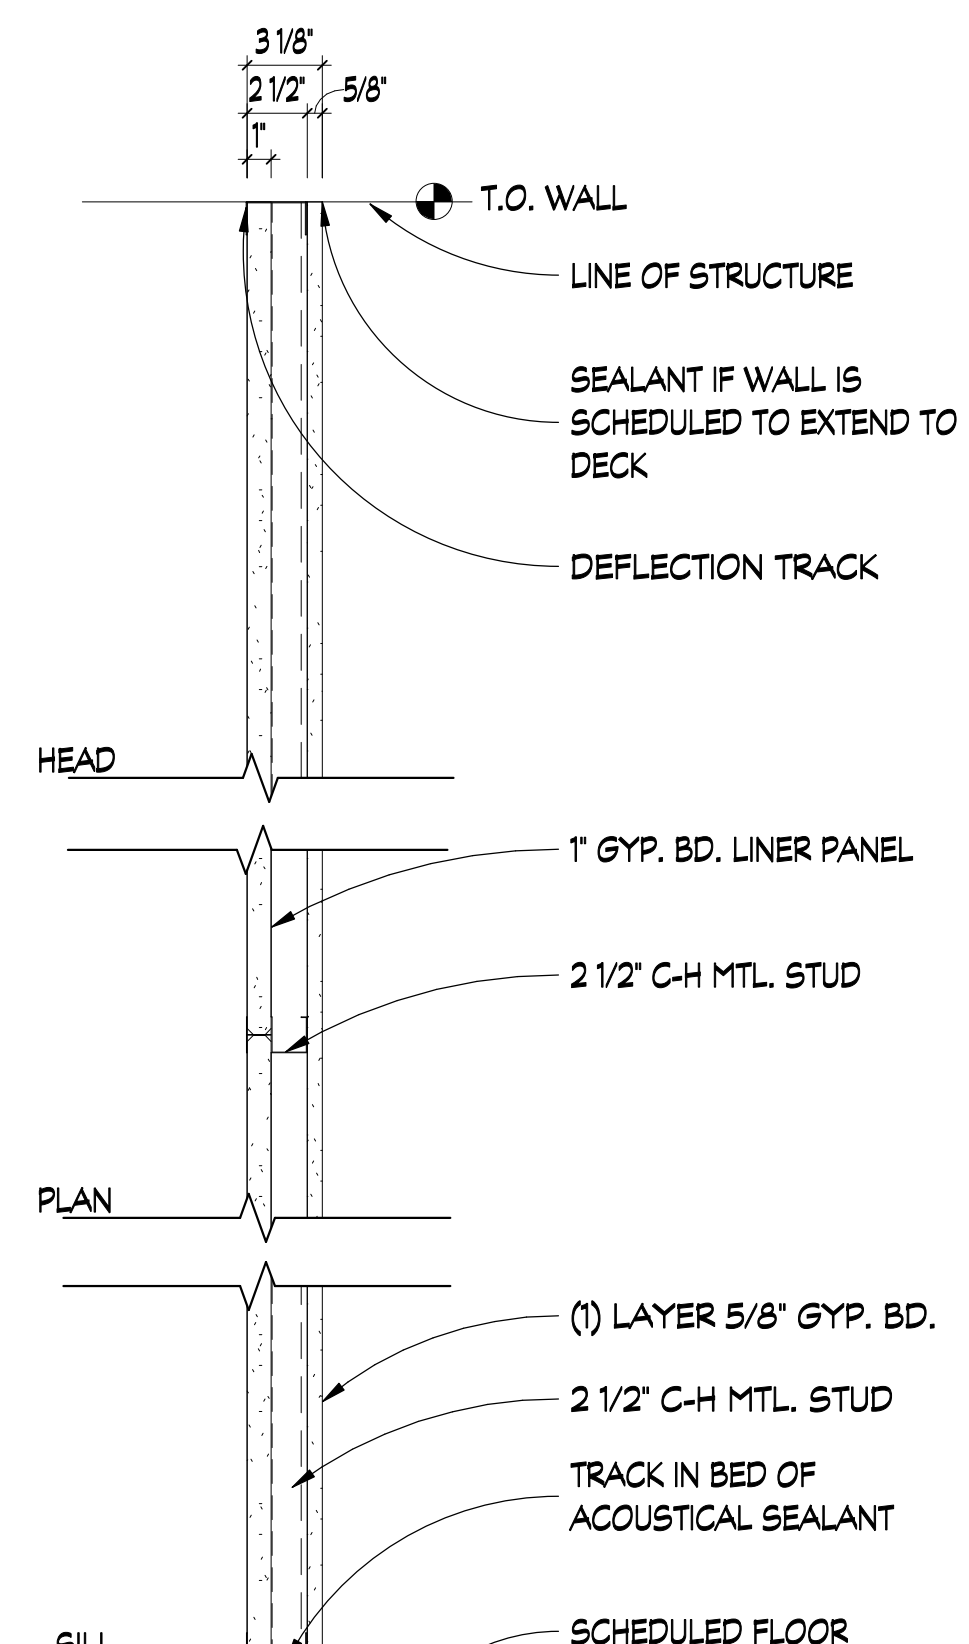

7 INTERIOR STUD WALL
SCALE: 1 1/2" = 1'-0"
FIRE RATING: [] S.T.C. RATING: [] U.L. 48 1 HR

GENERAL NOTES:

1. AT WALLS WHERE TILE IS USED AS THE FINISH MATERIAL, WATER RESISTANT GYP. BD. SHALL BE USED AS THE BASE LAYER UNLESS OTHERWISE NOTED. ALL WALLS TO RECEIVE CERAMIC TILE SHALL HAVE STUDS SPACED AT A MAXIMUM OF 16" O.C.
2. PROVIDE RATED WALLS ACCORDING TO THE REQUIREMENTS OF THE RESPECTIVE TEST NUMBER INDICATED.
3. APPLY SEALANT TO WALLS TO MEET THE INDICATED STC RATING.
4. WALL HEIGHT INDICATED 'TO STRUCTURE' SHALL BE CARRIED TO UNDERSIDE OF FLOOR/ROOF ASSEMBLY AND SEALED AT TOP.
5. WHERE NON RATED WALLS DO NOT EXTEND TO STRUCTURE, EXTEND STUDS TO STRUCTURE AND BRACE WALLS TO DECK ABOVE @ 48" O.C.
6. ALL MECHANICAL ROOM WALLS TO BE @ 60 STC.
7. INTERIOR FACE OF EXTERIOR WALLS SHALL RECEIVE 5/8" MOLD/MOISTURE RESISTANT GYP. BOARD.
8. COORDINATE WITH REFLECTED CEILING PLAN FOR PARTITIONS SCHEDULED TO EXTEND TO STRUCTURE.

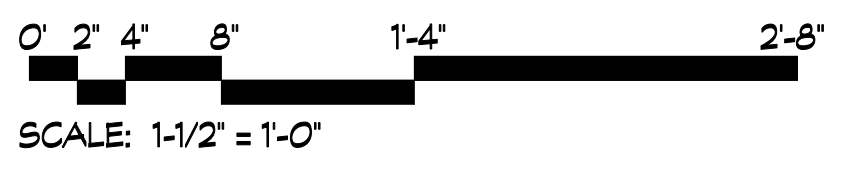


REVISIONS			
REV #	DATE	APPROV BY	REVISION
1	11/17/21	EA	65% SET
2	2/16/22	EA	ISSUE FOR PERMIT




DA PROJECT NUMBER & NAME:
1893

DRAWING TITLE:
WALL TYPES


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A601

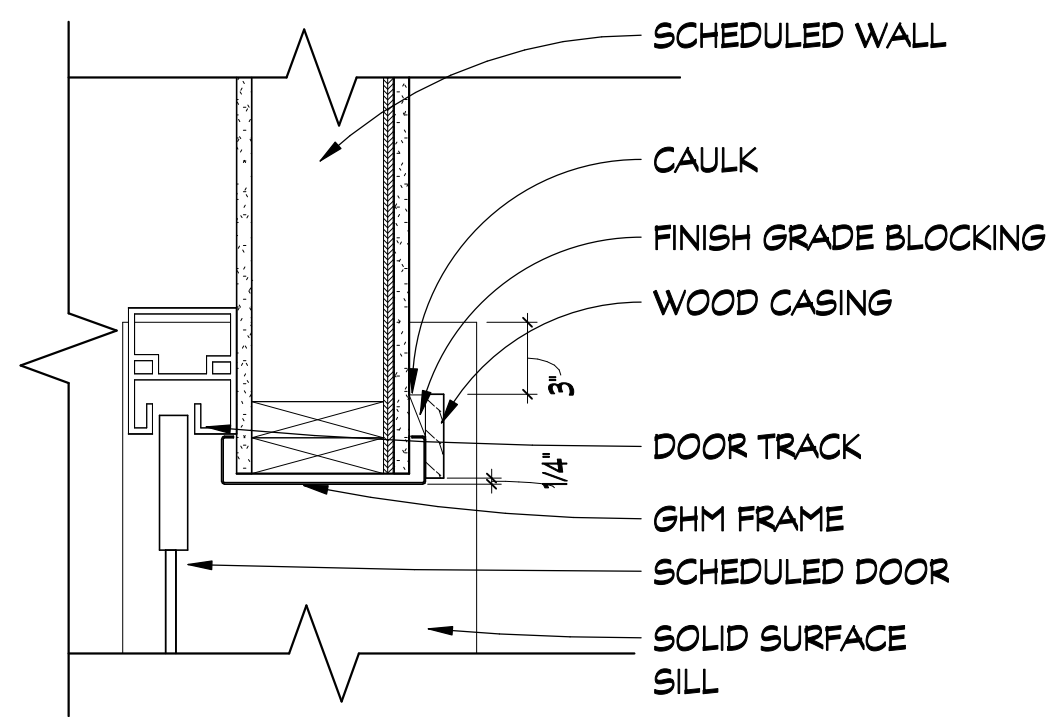


13 JAMB DETAIL
SCALE: 1 1/2" = 1'-0"

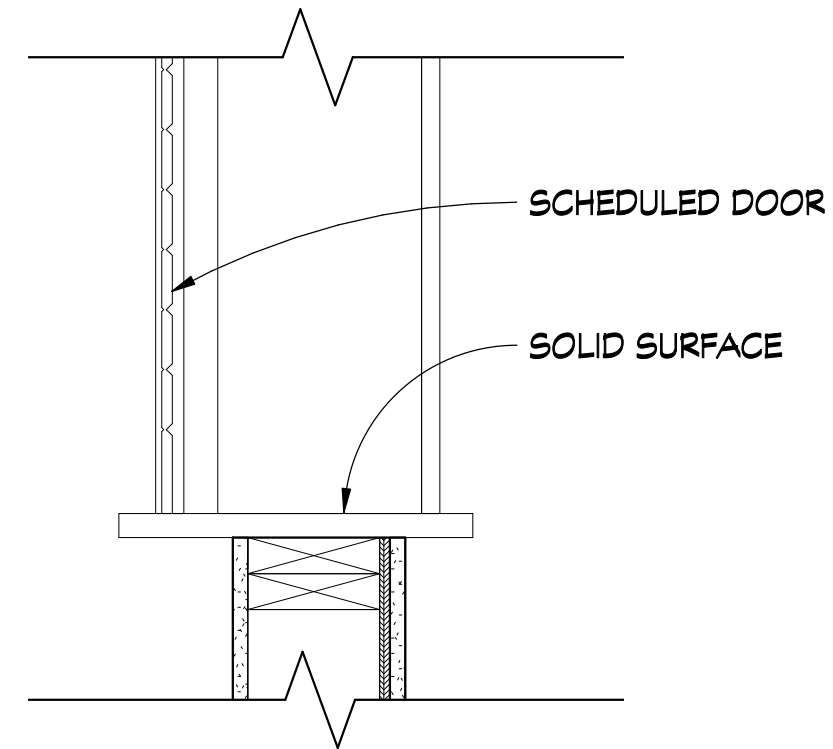


14 SILL DETAIL
SCALE: 1 1/2" = 1'-0"

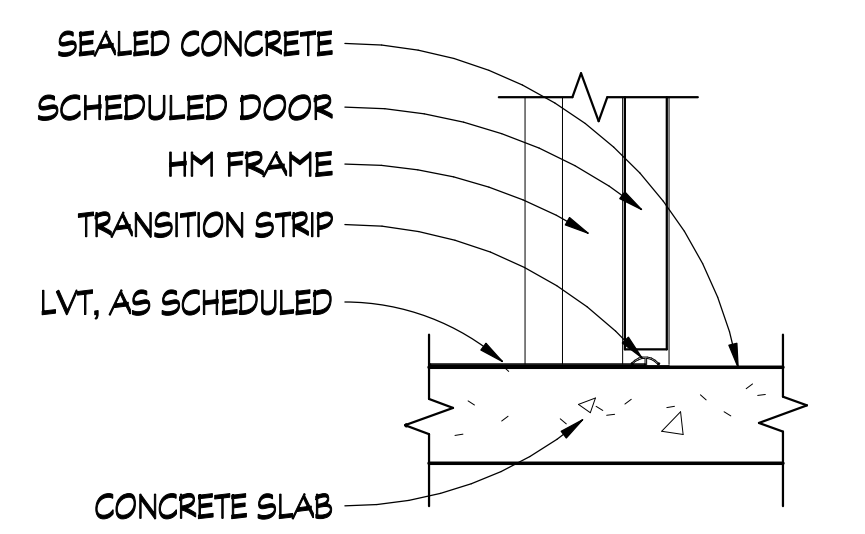


15 SILL DETAIL -LVT/SC
SCALE: 1 1/2" = 1'-0"

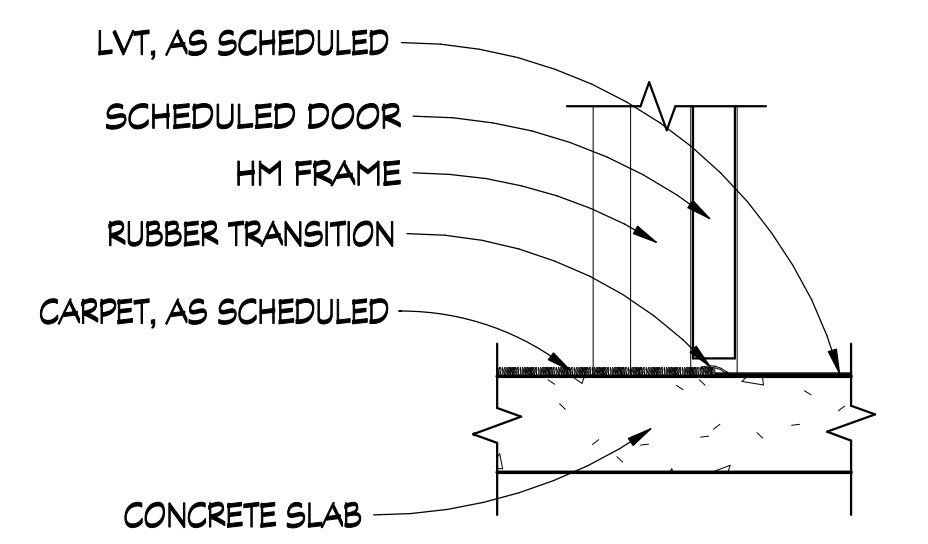

16 SILL DETAIL -CPT/LVT
SCALE: 1 1/2" = 1'-0"

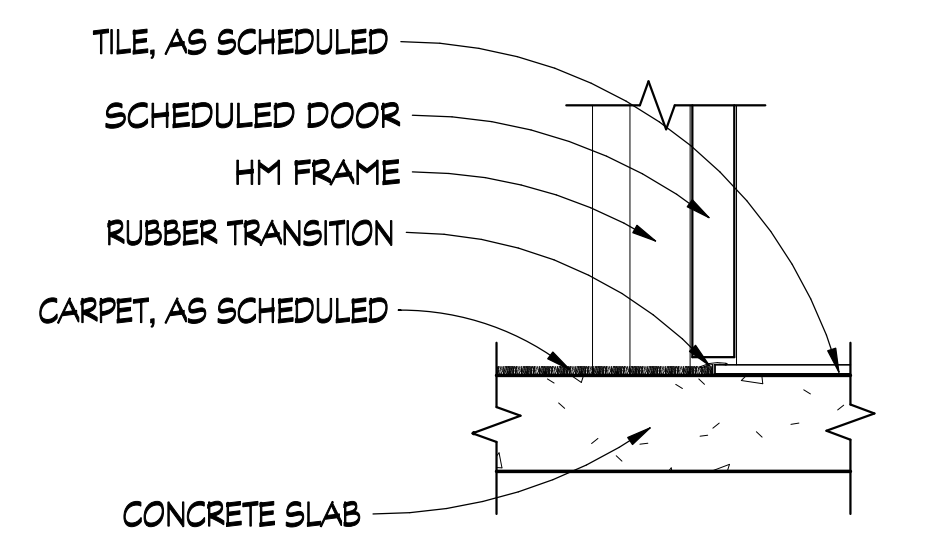

17 SILL DETAIL -CPT/TILE
SCALE: 1 1/2" = 1'-0"

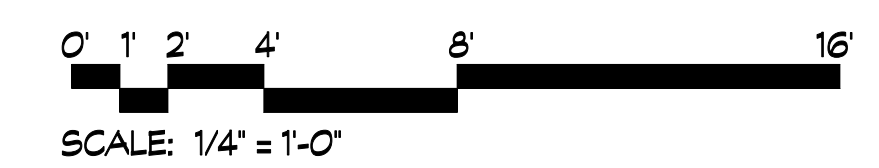


PROJECT TITLE:
**JUD C
HICKEY
CENTER**

REVISIONS			
REV #	DATE	APPROV BY	REVISION
	11/17/21	EA	65% SET
	2/16/22	EA	ISSUE FOR PERMIT



DA PROJECT NUMBER & NAME:
1893
DRAWING TITLE:
**DOOR
DETAILS**

DRAWING NO:
A702

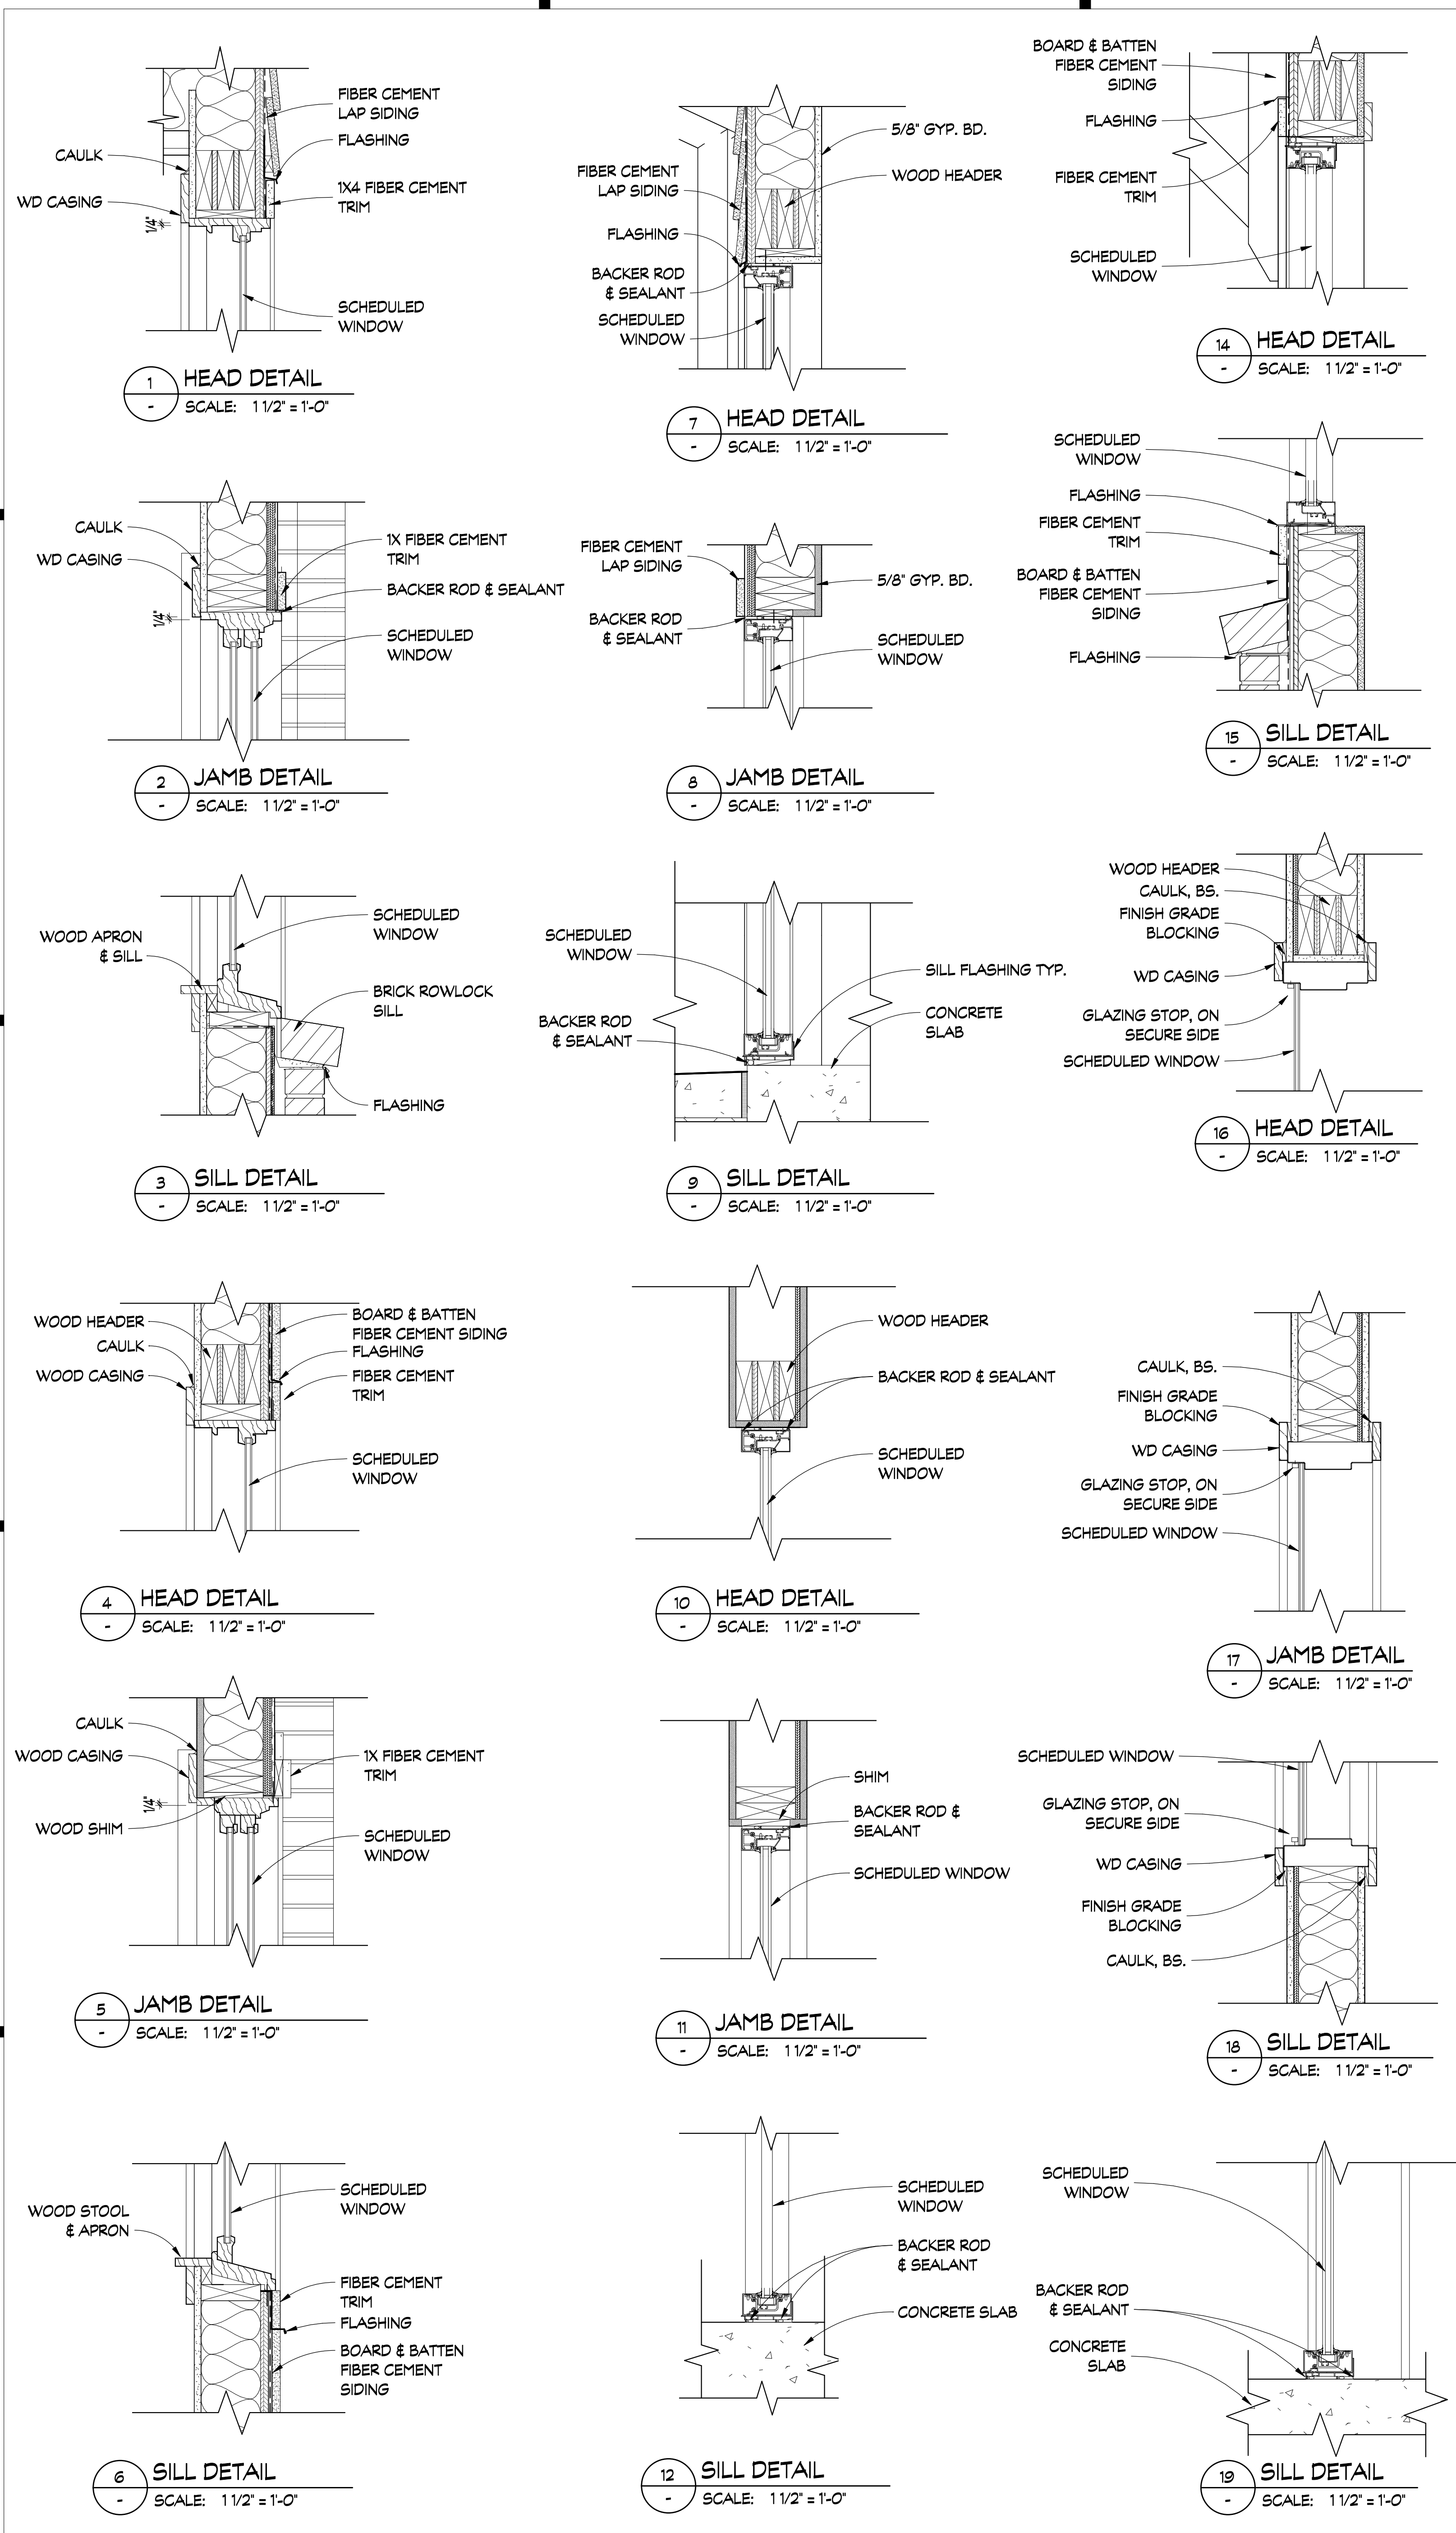


NO.	WINDOW SIZE (W X H)		FRAME		GLASS			OPERATION	DETAILS			REMARKS
	WIDTH	HEIGHT	MAT.	TH.	TYPE	THERM.	COLOR		HEAD	JAMB	SILL	
A	2-11 5/8"	5-0 7/8"	WD/AL	1"	IG-1	LOW-E	CLEAR	DBL HUNG	4	5	6	ANDERSEN E SERIES
B	2-11 5/8"	4-4 7/8"	WD/AL	1"	IG-1	LOW-E	CLEAR	DBL HUNG	1	2	3	ANDERSEN E SERIES
B2	2-11 5/8"	4-4 7/8"	WD/AL	1"	IG-1	LOW-E	CLEAR	DBL HUNG	1	2	3	ANDERSEN E SERIES
C	3'-6"	4'-0"	HM	1/4"	G-2	-	CLEAR	FIXED	16	17	18	HM BORROWED LITE
D	17'-4"	7'-2"	HM	1/4"	G-1/G-2	-	CLEAR	FIXED	16	17	19	HM BORROWED LITE
E	18'-5"	8'-2"	AL	1"	IG-1/G-2	LOW-E	CLEAR	FIXED	7	8	9	KAWNEER TRIFAB VG451
F	9'-7"	8'-0"	AL	1/4"	G-1/G-2	-	CLEAR	FIXED	10	11	12	KAWNEER TRIFAB VG451
G	8'-5"	7'-2"	AL	1"	IG-1/G-2	LOW-E	CLEAR	FIXED	7	8	9	KAWNEER TRIFAB VG451
H	18'-0 3/4"	7'-2"	AL	1"	IG-1/G-2	LOW-E	CLEAR	FIXED	7	8	9	KAWNEER TRIFAB VG451
J	9'-5 5/8"	7'-2"	AL	1"	IG-1/G-2	LOW-E	CLEAR	FIXED	7	8	9	KAWNEER TRIFAB VG451
K	14'-8 1/2"	7'-2"	AL	1"	IG-1/G-2	LOW-E	CLEAR	FIXED	7	8	9	KAWNEER TRIFAB VG451
L	8'-9 7/8"	7'-2"	AL	1"	IG-1/G-2	LOW-E	CLEAR	FIXED	7	8	9	KAWNEER TRIFAB VG451
M	10'-11"	7'-2"	AL	1"	IG-1/G-2	LOW-E	CLEAR	FIXED	7	8	9	KAWNEER TRIFAB VG451
N	17'-0"	7'-2"	AL	1"	IG-1/G-2	LOW-E	CLEAR	FIXED	7	8	9	KAWNEER TRIFAB VG451
P	12'-6"	7'-2"	AL	1"	IG-1/G-2	LOW-E	CLEAR	FIXED	7	8	9	KAWNEER TRIFAB VG451
Q	4'-10 1/4"	7'-2"	AL	1"	IG-1/G-2	LOW-E	CLEAR	FIXED	7	8	9	KAWNEER TRIFAB VG451
R	10'-0"	5'-0"	HM	1/4"	G-1/G-2	-	CLEAR	FIXED	16	17	18	HM BORROWED LITE
S	9'-9 13/16"	7'-2"	AL	1/4"	G-1	-	CLEAR	FIXED	10	11	12	KAWNEER TRIFAB VG451
T	3'-0"	3'-0"	WD/AL	1"	IG-1	LOW-E	CLEAR	FIXED	4 SIM	5 SIM	6 SIM	ANDERSEN E SERIES
V	11'-0"	3'-0"	AL	1"	IG-1/G-2	LOW-E	CLEAR	FIXED	7	8	15	KAWNEER TRIFAB VG451


GLAZING TYPES
 IG-1 INSULATED GLASS UNIT
 IG-2 INSULATED GLASS UNIT - TEMPERED
 IG-3 INSULATED TEMPERED GLASS UNIT - FROSTED
 G-1 MONOLITHIC SAFETY GLAZING
 G-2 MONOLITHIC GLAZING
 S SCREEN

ABBREV.:
 HM HOLLOW METAL
 WD WOOD
 AL ALUMINUM

REMARKS:
 1. CONTRACTOR TO FIELD VERIFY ALL OPENING DIMENSIONS
 2. SEE INT. ELEVATIONS FOR STOREFRONT SAFETY RAIL LOCATIONS.

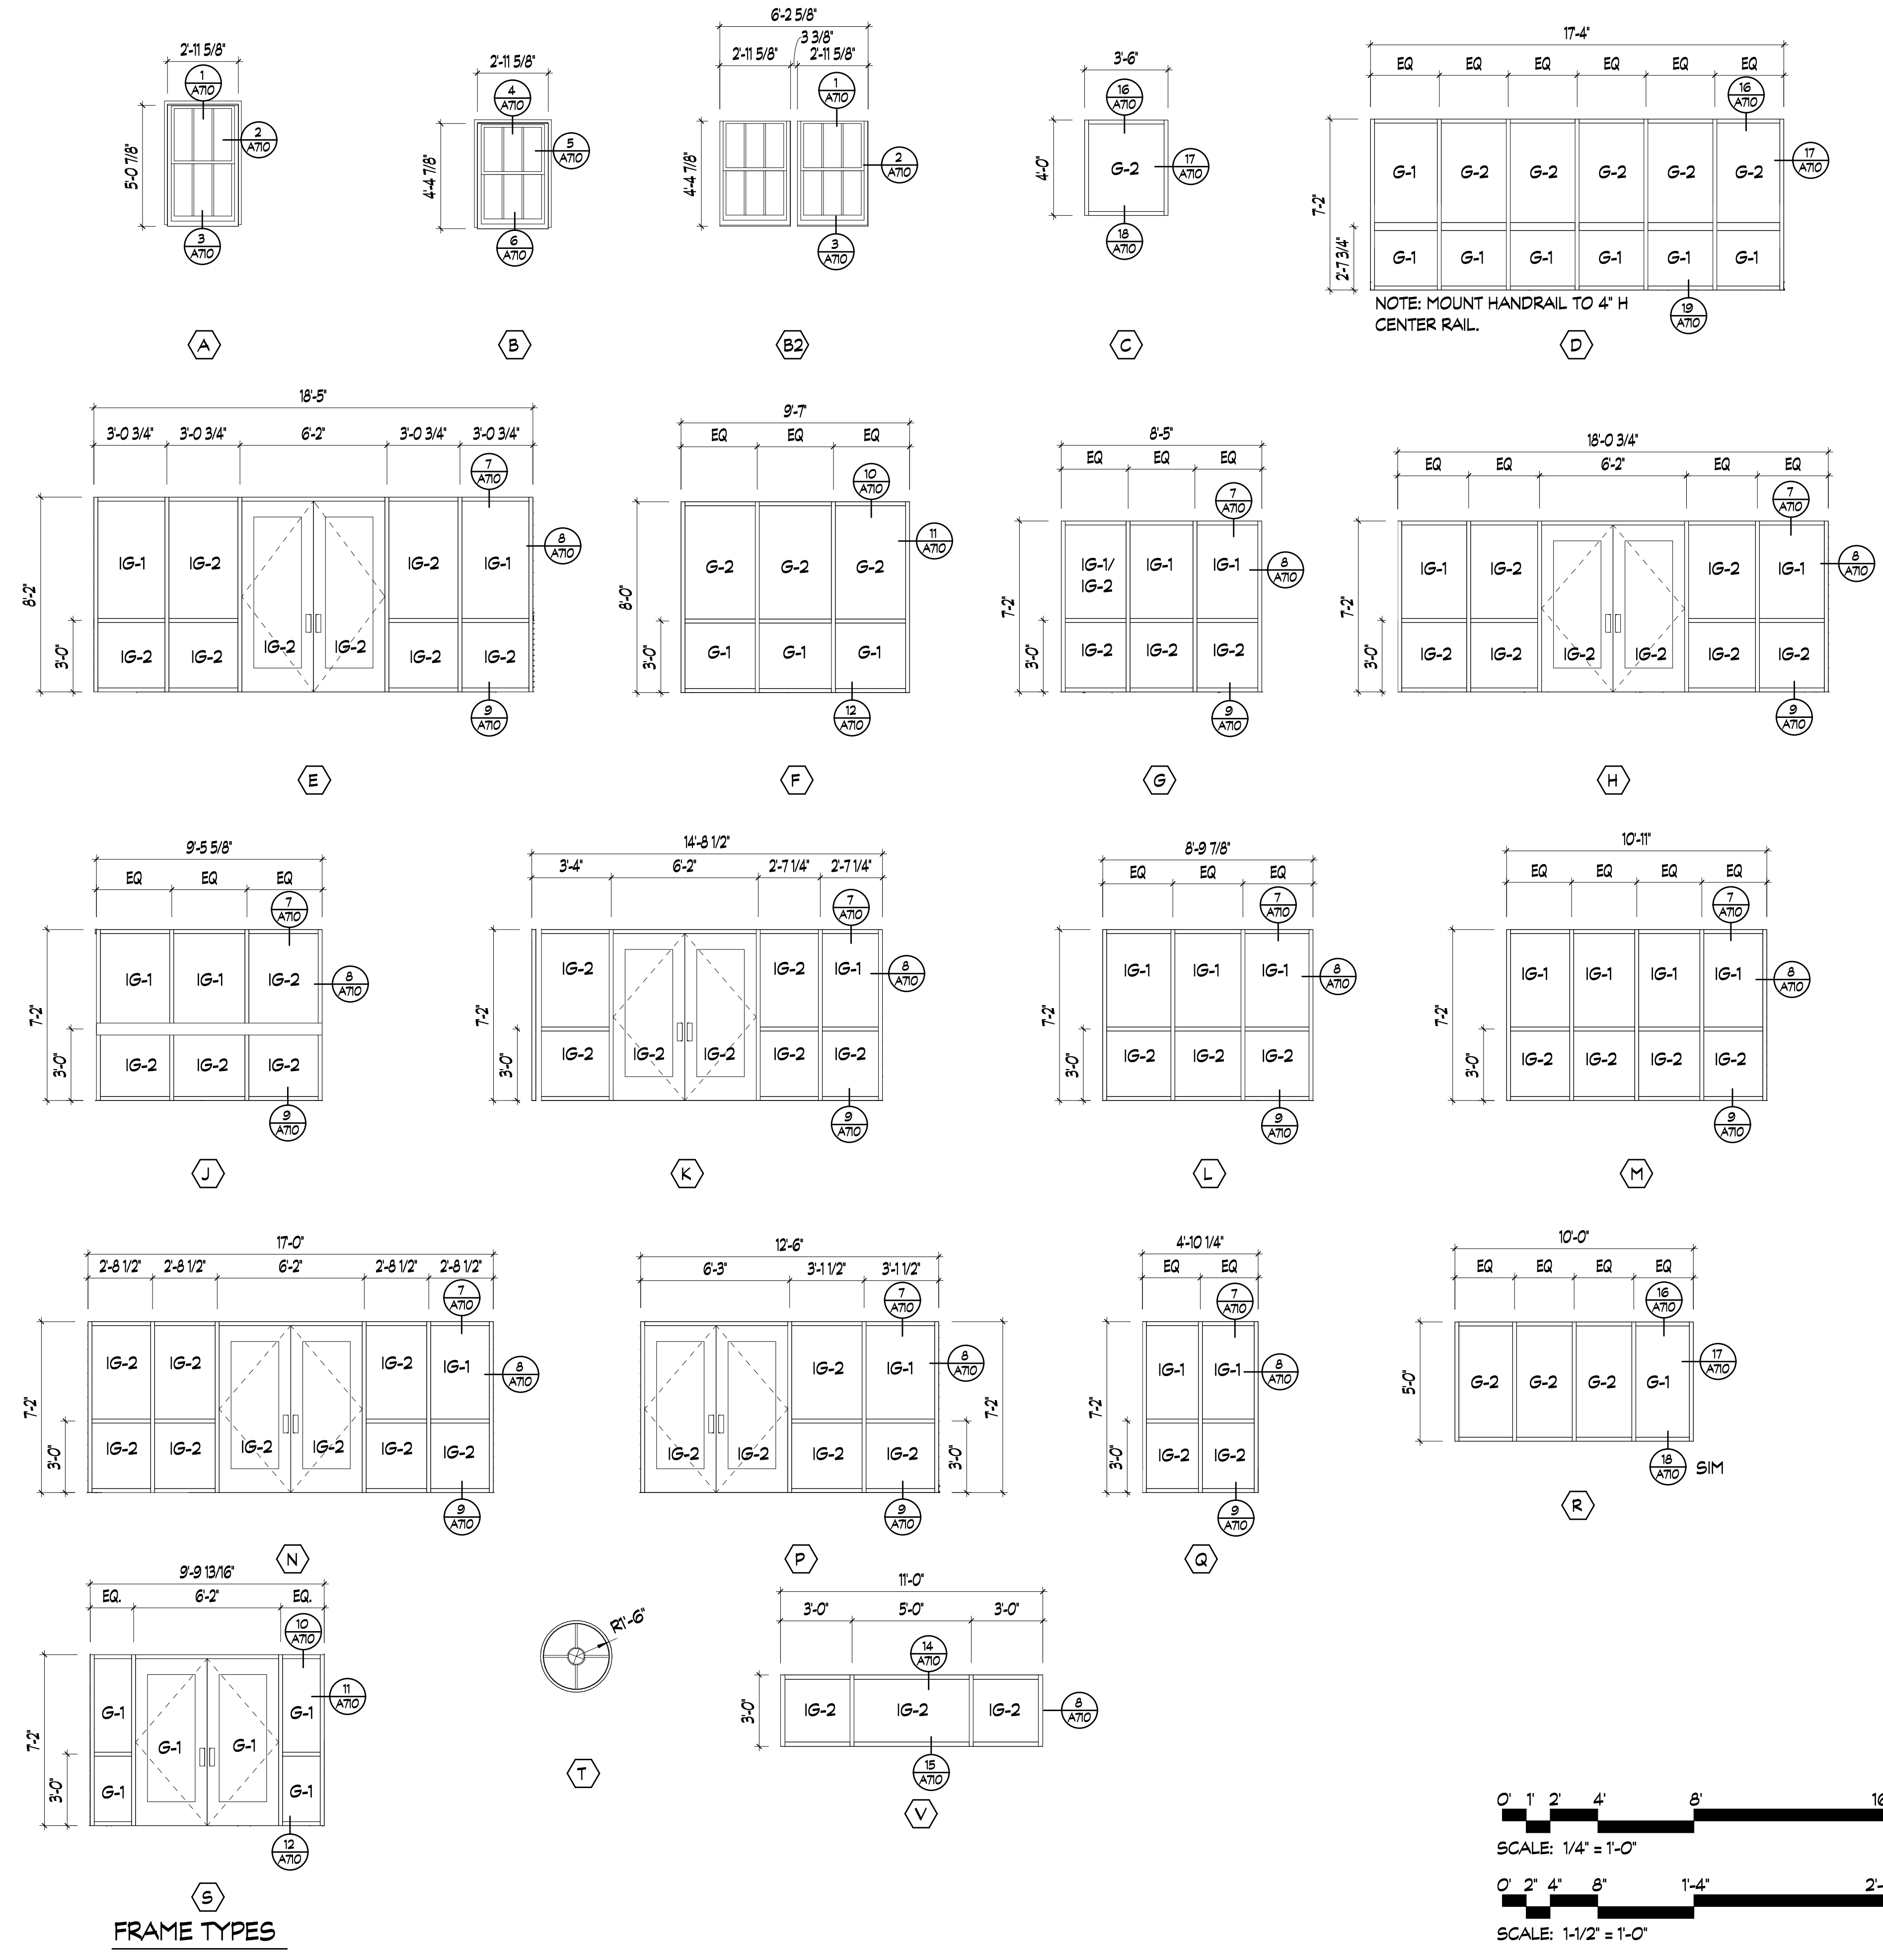

REV #	DATE	APPROV	REVISION
1	11/17/21	EA	65% SET
2	2/16/22	EA	ISSUE FOR PERMIT

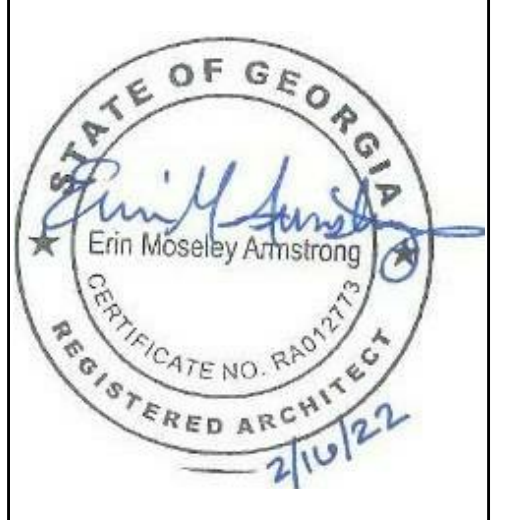

MATERIAL DESIGN BASIS

PAINT	
PNT-1	WALL PAINT - FIELD MANUF.: SHERWIN WILLIAMS COLOR: SW 7006 EXTRA WHITE TOP COAT: PROMAR 200 ZERO VOC FINISH: EGGSHELL LOCATIONS: SEE INT. ELEVATIONS
PNT-2	WALL PAINT - FIELD MANUF.: SHERWIN WILLIAMS COLOR: SW 7043 WORLDLY GRAY TOP COAT: PROMAR 200 ZERO VOC FINISH: EGGSHELL LOCATIONS: SEE INT. ELEVATIONS
PNT-3	WALL PAINT - ACCENT MANUF.: BENJAMIN MOORE COLOR: HC-154 HALE NAVY TOP COAT: ULTRA SPEC 500 INTERIOR FINISH: SATIN LOCATIONS: SEE INT. ELEVATIONS
PNT-4	WALL PAINT - ACCENT MANUF.: SHERWIN WILLIAMS COLOR: SW 6269 BEGUILING MAUVE TOP COAT: PROMAR 200 ZERO VOC FINISH: SATIN LOCATION: SEE INT. ELEVATIONS
PNT-5	WALL PAINT - ACCENT MANUF.: SHERWIN WILLIAMS COLOR: SW 6219 RAIN TOP COAT: PROMAR 200 ZERO VOC FINISH: EGGSHELL LOCATION: SEE INT. ELEVATIONS
PNT-6	MILLWORK PAINT MANUF.: SHERWIN WILLIAMS COLOR: SW 7006 EXTRA WHITE TOP COAT: PROMAR 200 ZERO VOC FINISH: SEMI-GLOSS LOCATION: SEE MILLWORK DETAILS & ELEVATIONS
PNT-7	MILLWORK PAINT MANUF.: BENJAMIN MOORE COLOR: HC-145 VAN COURTLAND BLUE TOP COAT: ULTRA SPEC 500 INTERIOR FINISH: SEMI-GLOSS LOCATION: SEE MILLWORK DETAILS & ELEVATIONS
PNT-8	CEILING PAINT MANUF.: SHERWIN WILLIAMS COLOR: SW 7006 EXTRA WHITE TOP COAT: PROMAR 200 ZERO VOC FINISH: FLAT LOCATION: CEILINGS ONLY
PNT-9	DOOR FRAME PAINT - TYPICAL MANUF.: SHERWIN WILLIAMS COLOR: SW 7006 EXTRA WHITE FINISH: SEMI-GLOSS LOCATION: DOOR FRAME NOTES: ONE COAT ALKYD PRIMER, TWO COATS ALKYD ENAMEL. FACTORY PRIMER IS ACCEPTABLE WITH NO VISUAL RUST.
STAIN	
ST-1	MANUF.: - COLOR: STAIN TO MATCH WILSONART 7992-38 PINNACLE WALNUT SHEEN: MATTE LOCATION: RECEPTION WOOD BEAMS
CARPET	
CPT-1	MANUFACTURER: TARKETT STYLE: TWILL COLOR: COTTON + IRON PRODUCT #: 11527 57202 SIZE: 18' X 36' INSTALL. PATTERN: ASHLAR
LUXURY VINYL TILE	
LVT-1	MANUFACTURER: COBALT SURFACES COLLECTION: KATANGA PRODUCT #: K12-821 COLOR: DOE SIZE: 25CM X 1M WEAR LAYER : 20 MIL THICKNESS: 5MM FINISH: COBALT GUARD INSTALLATION METHOD: GLUE DOWN INSTALL. PATTERN: SEE FINISH PLAN NOTE: TO BE INSTALLED WITH MANUFACTURERS RECOMMENDED ADHESIVE
SEALED CONCRETE	
SC-1	MANUF.: - PRODUCT: SEALED CONCRETE
WOOD BASE	
WB-1	MANUFACTURER: GARDEN STATE LUMBER ITEM #: G58412 COLOR: PNT-6, UNLESS NOTED OTHERWISE ON INT. ELEV.
WB-2	MANUFACTURER: GARDEN STATE LUMBER ITEM #: W1616 COLOR: PNT-6, UNLESS NOTED OTHERWISE ON INT. ELEV.
WOOD CROWN	
WC-1	MANUFACTURER: GARDEN STATE LUMBER ITEM #: G6C512 COLOR: SEE INT. ELEV.

RUBBER BASE	
RB-1	MANUFACTURER: JOHNSONITE PROFILE: PERCEPTIONS RECESS TOE HEIGHT: 4.25" COLOR: 80 FAWN NOTES: ROLLED GOODS
POLYURETHANE MODIFIED CEMENT	
PMC-1	MANUFACTURER: SHERWIN WILLIAMS PRODUCT: FASTOP 5 COLOR: LIGHT GRAY TOPCOAT: 3746 NOTES: INTEGRAL 4" FLASH COVE
RUBBER SPORTS FLOOR	
RSF-1	MANUFACTURER: ECORE PRODUCT: FOREST RX COLOR: 9822 TOASTED OAK
RSF-2	MANUFACTURER: ECORE PRODUCT: FOREST RX COLOR: 9825 SUN BLEACHED OAK
FIBERGLASS REINFORCED PLASTIC (FRP) PANELS	
FRP-1	MANUFACTURER: CRANE COMPOSITES PRODUCT: SEQUENTIA .075" CLASS C BEADED COLOR: WHITE NOTES: APPLY TO 2 WALLS SURROUNDING MOP SINKS
WALL PROTECTION	
WP-1	MANUFACTURER: ALTRO PRODUCT: PURAGUARD COLOR: WHITE ITEM #: W199 SIZE: 4 X 9' PANELS MATERIAL: EXTRUDED SEMI-RIGID PVCU PANEL THICKNESS: .08" INSTALLATION: WELDED
VINYL WALLCOVERING	
VWC-1	MANUFACTURER: MDC INTERIOR SOLUTIONS PATTERN #: MCO296/4142 PATTERN NAME: EDEN MURAL WEIGHT/TYPE: TYPE II 20 OZ. VINYL BACKING: NON-WOVEN DIMENSIONS: 12H X 54"W PANELS PATTERN MATCH: NON-REVERSIBLE, STRAIGHT MATCH NOTE: TO BE INSTALLED WITH MANUFACTURERS RECOMMENDED ADHESIVE
VWC-2	MANUFACTURER: MDC INTERIOR SOLUTIONS PATTERN: HORIZON LINE COLOR: INFINITE BLUE ITEM #: W2HL02/4142 WEIGHT/TYPE: TYPE II 20 OZ. VINYL BACKING: OSNABURG WIDTH: 54" PATTERN MATCH: RANDOM REVERSIBLE NOTE: TO BE INSTALLED WITH MANUFACTURERS RECOMMENDED ADHESIVE; GLASS INSTALLED ON TOP OF WALLCOVERING
VWC-3	MANUFACTURER: MDC INTERIOR SOLUTIONS PATTERN: ARTFUL PLAID COLOR: HEATHER ITEM #: MCO2279 WEIGHT/TYPE: TYPE II 20 OZ. VINYL BACKING: NON-WOVEN WIDTH: 54" PATTERN MATCH: NON-REVERSIBLE STRAIGHT ACROSS MATCH NOTE: TO BE INSTALLED WITH MANUFACTURERS RECOMMENDED ADHESIVE
VWC-4	MANUFACTURER: MOMENTUM PATTERN: ALEGRE COLOR: DA CAPO ITEM #: A203-194 WEIGHT/TYPE: TYPE II 20 OZ. VINYL BACKING: OSNABURG WIDTH: 54" PATTERN MATCH: REVERSE HANG, RANDOM MATCH NOTE: TO BE INSTALLED WITH MANUFACTURERS RECOMMENDED ADHESIVE
VWC-5	MANUFACTURER: MOMENTUM PATTERN: HERRINGBONE ROW COLOR: FROST ITEM #: T2-HR-04 WEIGHT/TYPE: TYPE II 20 OZ. VINYL BACKING: OSNABURG WIDTH: 54" PATTERN MATCH: REVERSE, RANDOM MATCH NOTE: TO BE INSTALLED WITH MANUFACTURERS RECOMMENDED ADHESIVE
QUARTZ	
QTZ-1	MANUFACTURER: WILSONART COLOR: LORRAINE ITEM #: Q1012 THICKNESS: 3CM
WOOD COUNTERTOP	
WCT-1	MANUFACTURER: - WOOD COUNTER COLOR: STAIN TO MATCH FORMICA 5887-58 MILLENNIUM OAK
PLASTIC LAMINATE	
PLAM-1	MANUFACTURER: WILSONART COLOR: MANGALORE MANGO ITEM #: 7984-38 FINISH: FINE VELVET FINISH

HAND RAILS	
HR-1	MANUFACTURER: INPRO SERIES: 900 W/ STAINLESS STEEL END CAPS AND BRACKETS COLOR: 0278 SAND DUNE
CERAMIC TILE	
CT-1	WALL TILE MANUFACTURER: TRINITY TILE SERIES: DAHLIA SIZE: 3' X 10' COLOR: CLOUD FINISH: GLOSS GROUT FOR CT-1 MANUFACTURER: MAPEI PRODUCT: KERAPOXY CQ COLOR: 93 WARM GRAY INSTALLATION: VERTICAL RUNNING BOND
PORCELAIN TILE	
PT-1	FLOOR TILE MANUFACTURER: GARDEN STATE TILE PRODUCT: ARDOSIA SIZE: 12' X 24" TEXTURE: MATTE COLOR: OXFORD WHITE GROUT FOR PT-1 MANUFACTURER: MAPEI PRODUCT: KERAPOXY CQ COLOR: 93 WARM GRAY INSTALLATION: HORIZONTAL RUNNING BOND
PT-2	FLOOR TILE MANUFACTURER: GARDEN STATE TILE PRODUCT: ARDOSIA SIZE: 2' X 2' MOSAIC TEXTURE: MATTE COLOR: OXFORD WHITE GROUT FOR PT-2 MANUFACTURER: MAPEI PRODUCT: KERAPOXY CQ COLOR: 93 WARM GRAY
ACOUSTICAL CEILING PANELS	
ACP-1	MANUFACTURER: USG PRODUCT: MARS CLIMAPLUS PERFORMANCE ITEM NO.: 86185 SIZE: 2' X 2' X 3/4" NRC: .70 COLOR: FLAT WHITE 050 GRID: DONN DV/DXL SUSPENSION SYSTEM GRID COLOR: FLAT WHITE 050
ACP-2	MANUFACTURER: USG PRODUCT: SHEETROCK BRAND LAY-IN CEILING ITEM NO.: 3260 SIZE: 2' X 2' X 1/2" EDGE: SQUARE COLOR: FLAT WHITE 050 GRID: DONN DV/DXL SUSPENSION SYSTEM GRID COLOR: FLAT WHITE 050
ACP-3	MANUFACTURER: MBI PRODUCTS PRODUCT: CLOUDLITE BAFFLES SIZE: 2' X 10' X 2" EDGE: SQUARE MATERIAL: PVC COLOR: WHITE INSTALLATION: INSTALL ON HANGERS W/ GROMMETS IN FLAP, COORD. FINAL LAYOUT WITH MECHANICAL. BOTTOM OF PANELS SHOULD NOT HANG BELOW TRUSSES.
TRANSITION STRIP	
TS-1	TRANSITION FROM WALL TO WALL TILE MANUFACTURER: SCHLUTER PRODUCT PROFILE: JOLLY FINISH: SATIN ANODIZED ALUMINUM
TS-2	EDGE TRANSITION FROM TILE TO TILE MANUFACTURER: SCHLUTER PRODUCT PROFILE: QUADREC COLOR: SATIN ANODIZED ALUMINUM
TS-3	TRANSITION FROM LVT TO PT/SC/PMC MANUFACTURER: SCHLUTER PRODUCT PROFILE: RENO-U COLOR: SATIN ANODIZED ALUMINUM
TS-4	TRANSITION FROM LVT TO CPT MANUFACTURER: TARKETT PRODUCT: CD-XX COLOR: 80 FAWN
TS-5	TRANSITION FROM CPT TO PT MANUFACTURER: SCHLUTER PRODUCT: RENO-TK COLOR: SATIN ANODIZED ALUMINUM
CABINETRY HARDWARE	
HDW-1	MANUFACTURER: EMTEK PRODUCT NAME: TRIBECA PULL SIZE: 4" CENTER FINISH: POLISHED CHROME ITEM #: 86429

HDW-2	MANUFACTURER: EMTEK PRODUCT NAME: BAR PULL SIZE: 4" CENTER FINISH: SATIN NICKEL ITEM #: 86360
HDW-3	MANUFACTURER: EMTEK PRODUCT NAME: BAR PULL SIZE: 4" CENTER FINISH: MATTE BLACK ITEM #: 86360
HDW-4	MANUFACTURER: REJUVENATION PRODUCT NAME: ARCHED SHELF BRACKETS SIZE: 10" CENTER FINISH: POLISHED NICKEL ITEM #: C2958 NOTES: RECEPTION ADA COUNTER BRACKETS
SPECIALTY FINISH	
SF-1	WALL MURAL @ CORRIDOR PAINTED MURAL BY LOCAL ARTIST ARTIST AND DESIGNER TO WORK TOGETHER ON FINAL DESIGN CONTRACTOR NOTES: PRIME WALL ONLY; ARTWORK PROVIDED BY OWNER
SF-2	WALL MURAL @ PAC VINYL WALL MURAL OR VINYL GRAPHICS APPLIED TO WALL. ARTIST/DESIGNER TO WORK TOGETHER ON FINAL DESIGN. CONTRACTOR NOTES: PRIME & PAINT WALL PNT-1; ARTWORK PROVIDED BY OWNER
SF-3	SPECIAL WALL FINISH PLYWOOD
SF-4	PEGBOARD @ WORKSHOP MANUF.: DIAMOND LIFE GEAR PRODUCT: PEGBOARD HB SIZE: 4' X 8' PANELS FINISH: PAINTABLE FINISH, PNT-1 NOTES: INSTALL PER MANUFACTURERS INSTRUCTIONS. PROVIDE BLOCKING AS REQUIRED BY MANUF.
SF-5	SLAT WALL @ MARKETPLACE / HOME HUB MANUF.: DIAMOND LIFE GEAR PRODUCT: SLATWALL 1X SIZE: 4' X 8' PANELS FINISH: WHITE NOTES: INSTALL PER MANUFACTURERS INSTRUCTIONS. PROVIDE BLOCKING AS REQUIRED BY MANUF.
SF-6	MIRROR @ FITNESS EQUIPMENT MANUF.: - PRODUCT: MIRROR, TEMPERED HEIGHT: 7 AFF
SF-7	WINDOW FILM MANUF.: 3M PRODUCT #: 700126667 PATTERN: STRAIGHT WASHI COLOR: WHITE NOTES: INSTALL ON WINDOWS IN OFFICES 146, 147, 148, 149 AND ON DOORS 101.1, 113.1, 113.2, 127, 127.1, & 134

CURTAINS	
CURT-1	PRIVACY CURTAIN MANUF.: INPRO PRODUCT: PRIVACY CURTAIN TRACK: FORMTRAC FABRIC TYPE: PLATINUM FABRIC PATTERN: BLISSFUL FABRIC COLOR: ASTER MESH: 12" SNOW
CURT-2	SHOWER CURTAIN MANUF.: INPRO PRODUCT: SHOWER CURTAIN TRACK: NANOTRAC FABRIC TYPE: SHIELD BY PANAZ FABRIC PATTERN: ABLOOM FABRIC COLOR: EUCALYPTUS
CURT-3	ROOM DIVIDER CURTAIN MANUF.: INPRO PRODUCT: ROOM DIVIDER TRACK: ARCHITECTURAL DRAPERY ROD W/ BATON AND CORD DRAW FABRIC TYPE: DRAPERY FABRIC FABRIC PATTERN: WHIMSY FABRIC COLOR: HOP

INTERIOR ABBREVIATIONS


ACP	ACOUSTICAL CEILING PANEL
BR	BRICK
BP	BRICK PAVER
CT	CERAMIC TILE
CB	CERAMIC BASE
CMU	CONCRETE MASONRY UNIT
CPT	CARPET
CPT-W	CARPET WALK OFF
EP	EPOXY
EXP	EXPOSED
FCB	FIBER CEMENT BOARD
GYP	GYPSUM BOARD
GL	GLASS
GT	GLASS TILE
GRT	GROUT
HDW	HARDWARE
LVT	LUXURY VINYL TILE
LMC	LINEAR METAL CEILING
MRGB	MOISTURE RESISTANT GYPSUM BOARD
MB	MILLWORK BASE
MV	MASONRY VENEER
PMC	POLYURETHANE MODIFIED CEMENT
PT	PORCELAIN TILE
PB	PORCELAIN BASE
PLAM	PLASTIC LAMINATE
PC	POURED CONCRETE
PNT	PAINT
RB	RUBBER BASE
RSF	RUBBER SPORTS FLOOR
RUB	RUBBER FLOOR
SC	SEALED CONCRETE
SS	SOLID SURFACE
STS	STAINLESS STEEL
ST	STAIN
SF	SPECIALTY FINISH
TBR	THIN BRICK
TS	TRANSITION STRIP
VWC	VINYL WALL COVERING
WCT	WOOD COUNTERTOP
WSCT	WAINSCOT PANELING
WV	WOOD VENEER
WB	WOOD BASE
WC	WOOD CROWN
VCG	VINYL CORNER GUARDS



PROJECT TITLE:
**JUD C
HICKEY
CENTER**

REVISIONS			
REV #	DATE	APPROV	REVISION
1	2/16/22	EA	ISSUE FOR PERMIT

CURT-1	PRIVACY CURTAIN MANUF.: INPRO PRODUCT: PRIVACY CURTAIN TRACK: FORMTRAC FABRIC TYPE: PLATINUM FABRIC PATTERN: BLISSFUL FABRIC COLOR: ASTER MESH: 12" SNOW
CURT-2	SHOWER CURTAIN MANUF.: INPRO PRODUCT: SHOWER CURTAIN TRACK: NANOTRAC FABRIC TYPE: SHIELD BY PANAZ FABRIC PATTERN: ABLOOM FABRIC COLOR: EUCALYPTUS
CURT-3	ROOM DIVIDER CURTAIN MANUF.: INPRO PRODUCT: ROOM DIVIDER TRACK: ARCHITECTURAL DRAPERY ROD W/ BATON AND CORD DRAW FABRIC TYPE: DRAPERY FABRIC FABRIC PATTERN: WHIMSY FABRIC COLOR: HOP

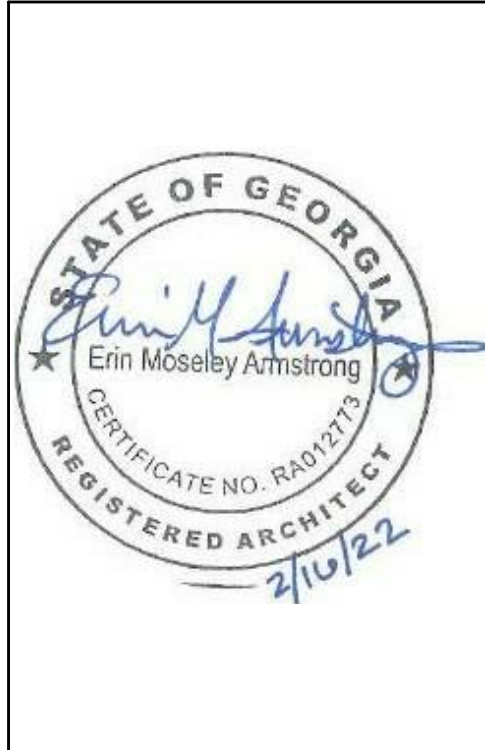

DA PROJECT NUMBER & NAME:
1893

DRAWING TITLE:
**INTERIOR
FINISH
SCHEDULE**

DRAWING NO:
A801



INTERIOR ABBREVIATIONS

ACP	ACOUSTICAL CEILING PANEL
BR	BRICK
BP	BRICK PAVER
CT	CERAMIC TILE
CB	CERAMIC BASE
CMU	CONCRETE MASONRY UNIT
CPT	CARPET
CPT-W	CARPET WALK OFF
EP	EPOXY
EXP	EXPOSED
FCB	FIBER CEMENT BOARD
GYP	GYPSUM BOARD
GL	GLASS
GT	GLASS TILE
GRT	GROUT
HDW	HARDWARE
LVT	LUXURY VINYL TILE
LMC	LINER METAL CEILING
MIRGB	MOISTURE RESISTANT GYPSUM BOARD
MB	MILLWORK BASE
MV	MASONRY VENEER
PMC	POLYURETHANE MODIFIED CEMENT
PT	PORCELAIN TILE
PB	PORCELAIN BASE
PLAM	PLASTIC LAMINATE
PC	POURED CONCRETE
PNT	PAINT
RB	RUBBER BASE
RSF	RUBBER SPORTS FLOOR
RUB	RUBBER FLOOR
SC	SEALED CONCRETE
SS	SOLID SURFACE
STS	STAINLESS STEEL
ST	STAIN
SF	SPECIALTY FINISH
TBR	THIN BRICK
TS	TRANSITION STRIP
VWC	VINYL WALL COVERING
WCT	WOOD COUNTERTOP
WSCOT	WAINSCOT PANELING
WV	WOOD VENEER
WB	WOOD BASE
WC	WOOD CROWN
VCG	VINYL CORNER GUARDS

FINISH SYMBOL LEGEND

[Symbol]	LVT-1
[Symbol]	PT-1
[Symbol]	RSF-1
[Symbol]	RSF-2
[Symbol]	PMC-1
[Symbol]	SC-1
[Symbol]	CPT-1

CURT-1: PRIVACY CURTAIN & TRACK, PROVIDE BLOCKING ASV CLG

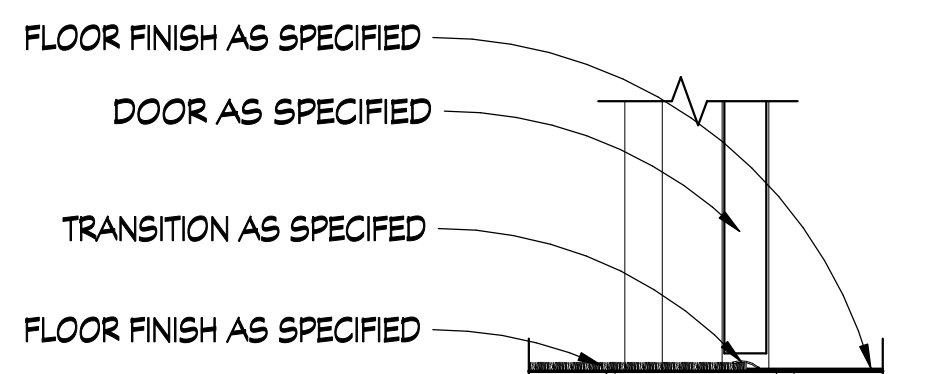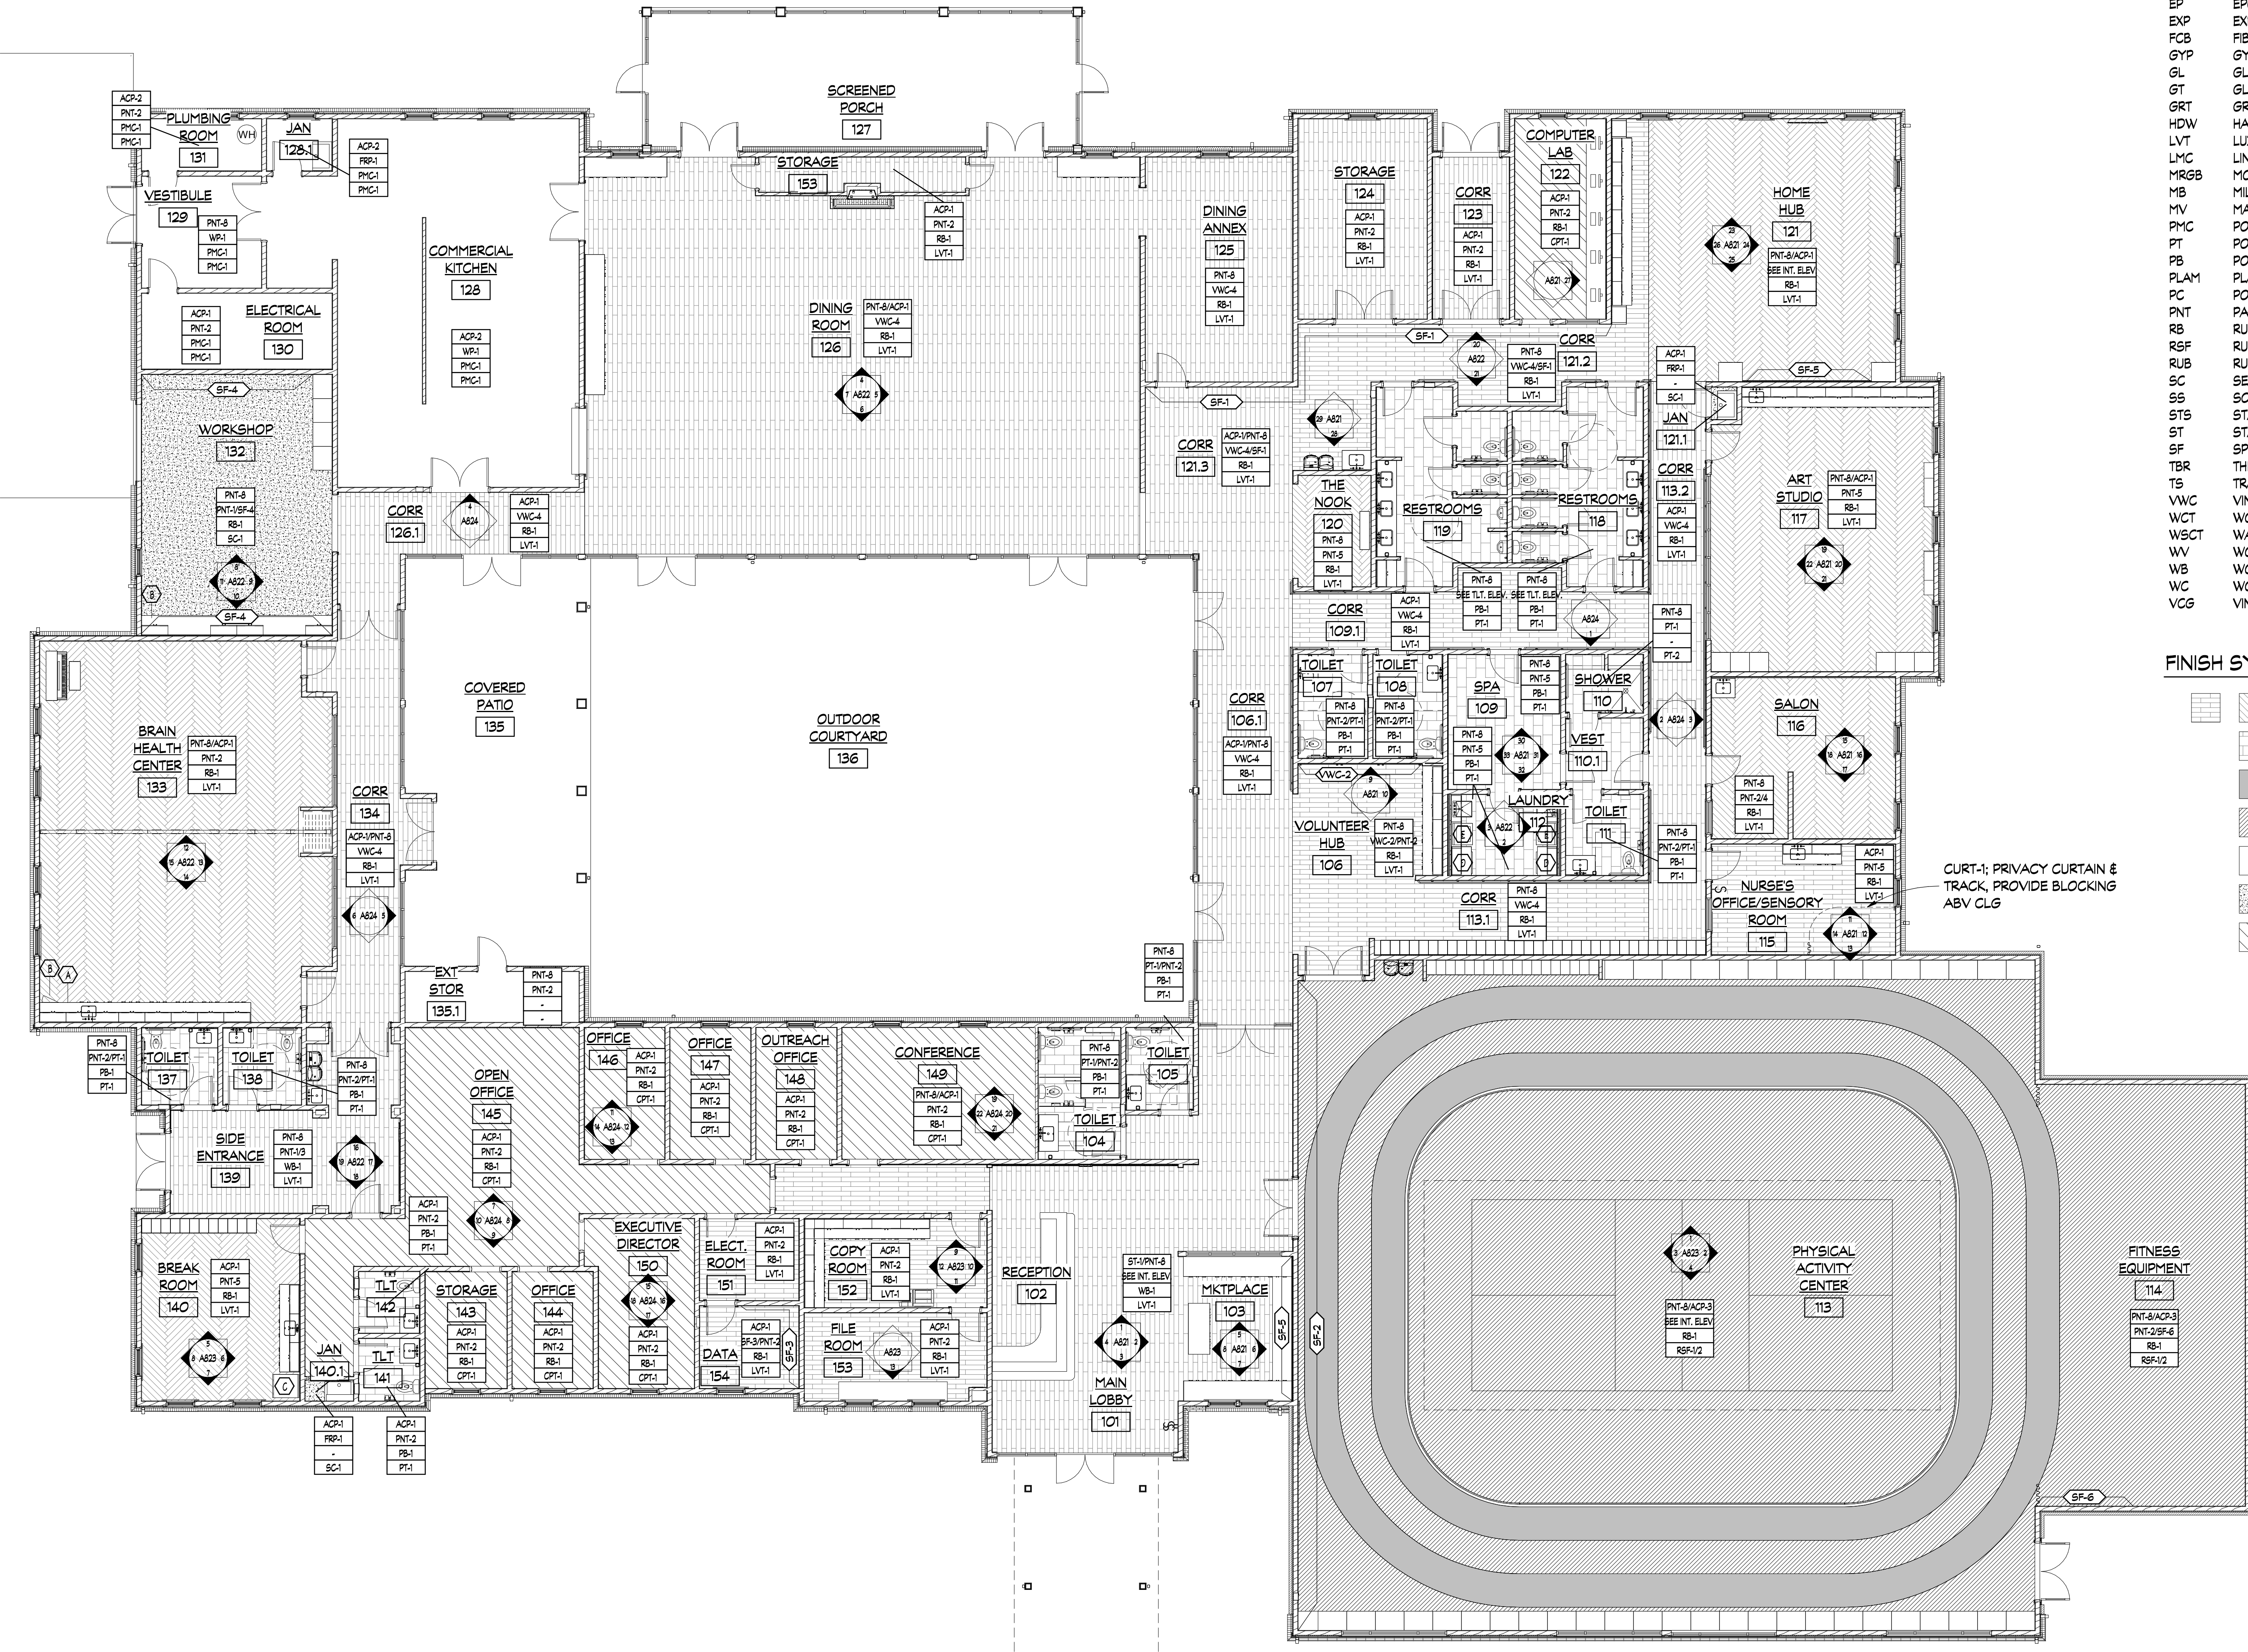


NOTE: ALL FLOORING TRANSITIONS TO BE CENTERED UNDER DOOR IN THE CLOSED POSITION, UNLESS NOTED OTHERWISE.

1 FINISH FLOOR PLAN
SCALE: 1/8" = 1'-0"

2 SILL DETAIL - TYP.
SCALE: 1 1/2" = 1'-0"


FINISH SYMBOL LEGEND

[Symbol]	CEILING FINISH
[Symbol]	WALL FINISH
[Symbol]	BASE FINISH
[Symbol]	FLOOR FINISH

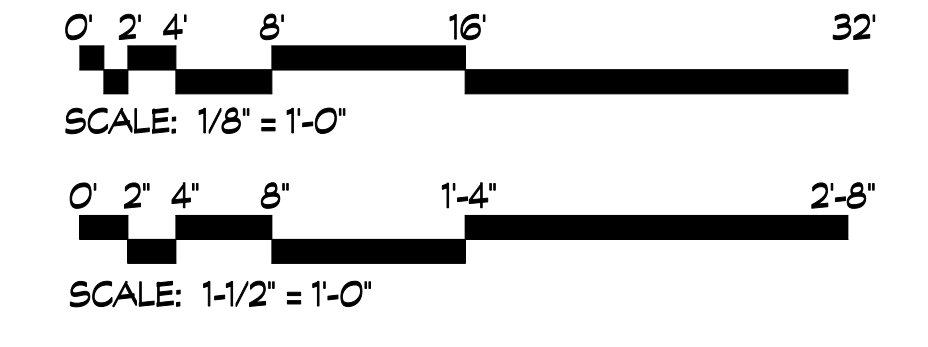


APPLIANCE SCHEDULE		
-	DESCRIPTION	REMARK
A	UNDERCOUNTER ICE MAKER	FBO/BC
B	UNDERCOUNTER REFRIGERATOR	FBO/BC
C	REFRIGERATOR	FBO/BC
D	DRYER	FBO/BC
E	WASHER	FBO/BC

REVISIONS				
REV #	DATE	APPROV	BY	REVISION
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2	11/17/21	EA		65% SET
3	2/16/22	EA		ISSUE FOR PERMIT

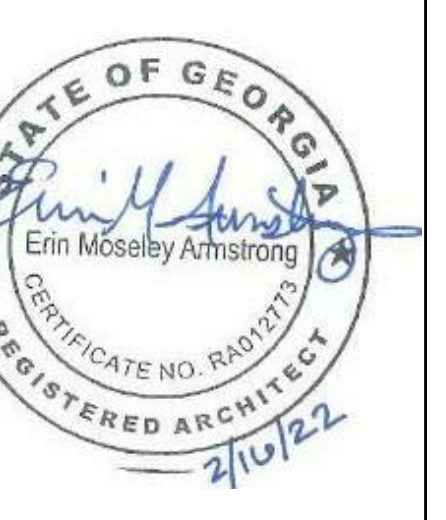


DA PROJECT NUMBER & NAME:
1893
DRAWING TITLE:
**FIRST FLOOR
FINISH PLAN**


DRAWING NO:
A810

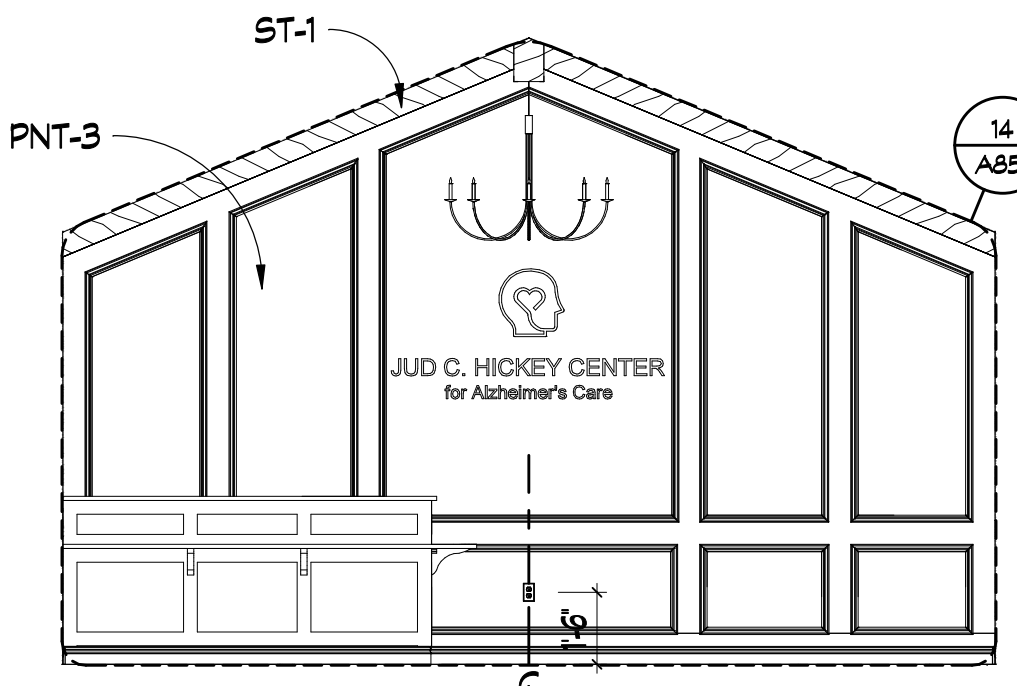


1 LOBBY
SCALE: 1/4" = 1'-0"

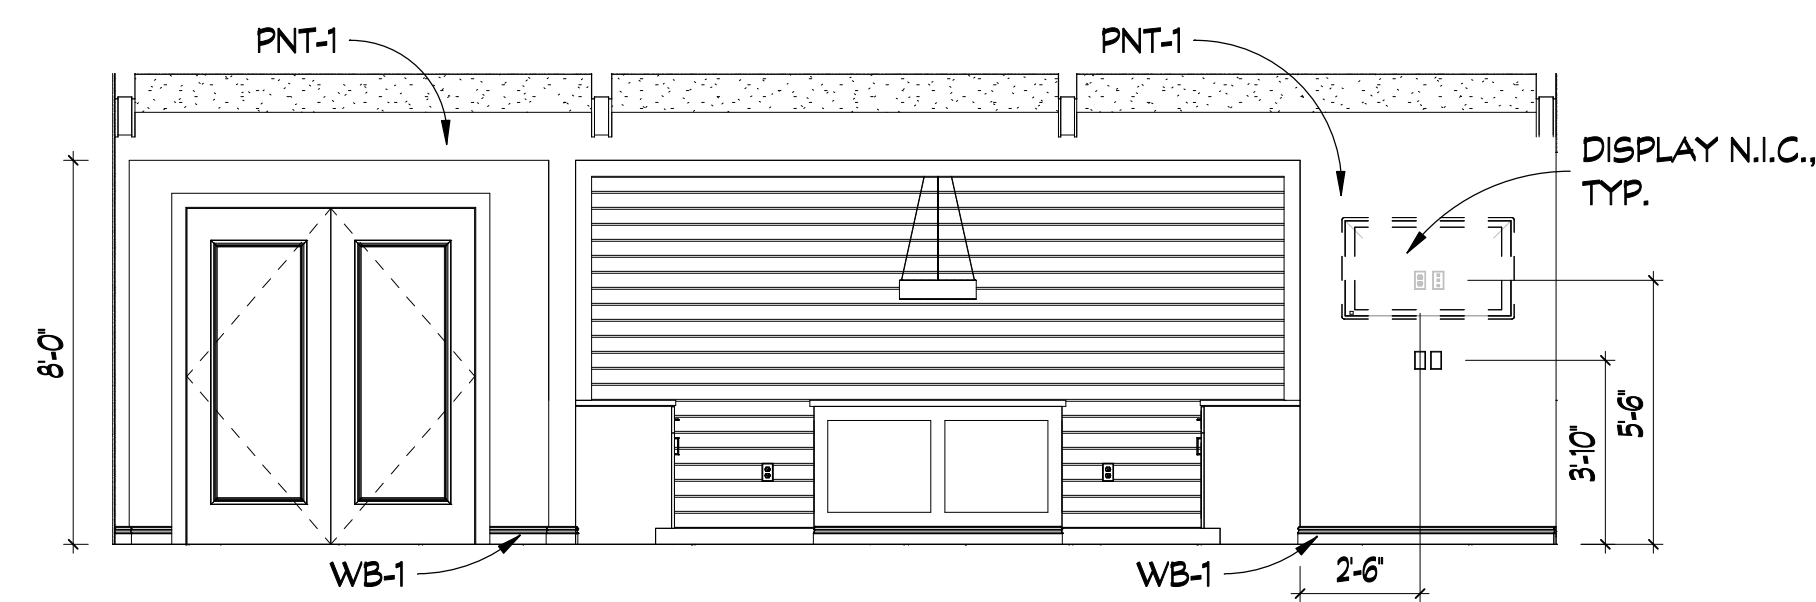


2 LOBBY
SCALE: 1/4" = 1'-0"

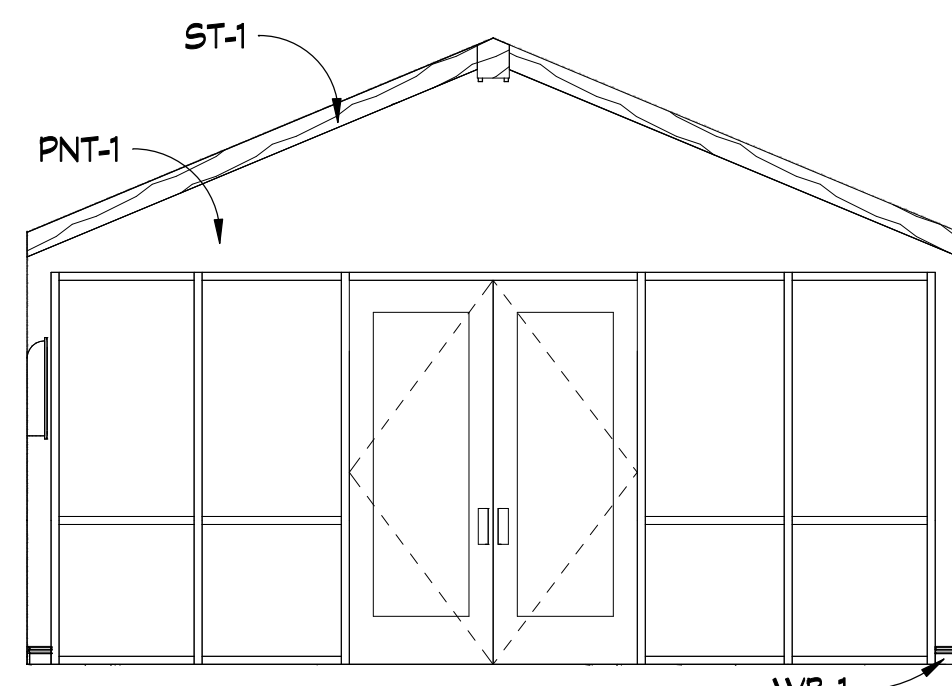


3 LOBBY
SCALE: 1/4" = 1'-0"

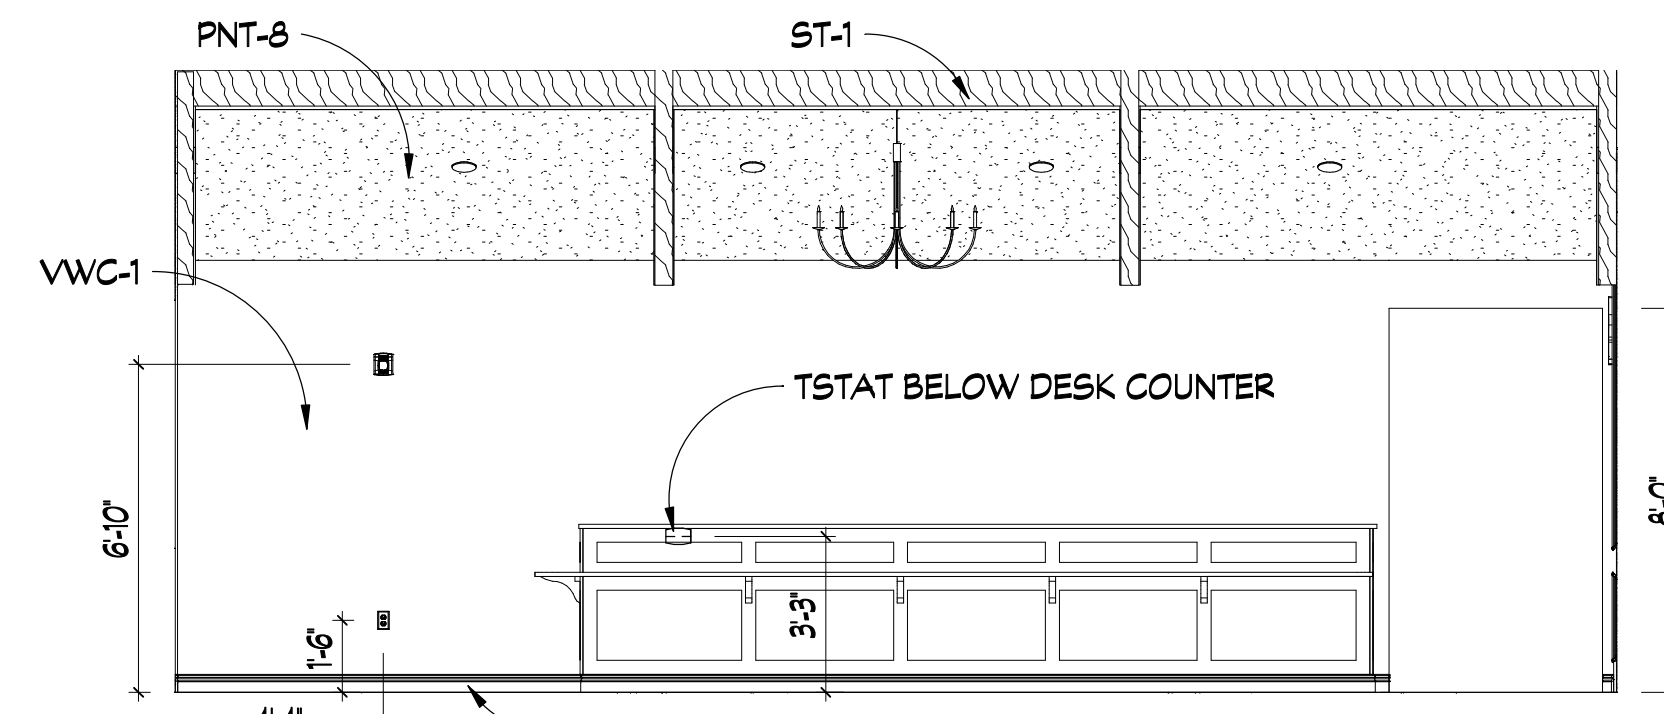


4 LOBBY
SCALE: 1/4" = 1'-0"

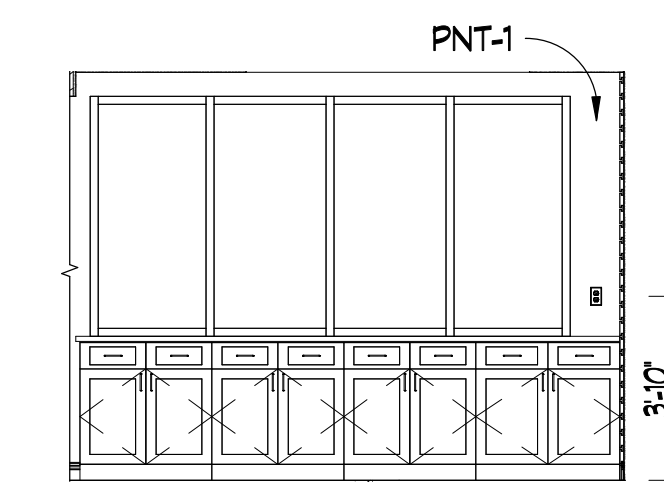


5 MARKETPLACE
SCALE: 1/4" = 1'-0"

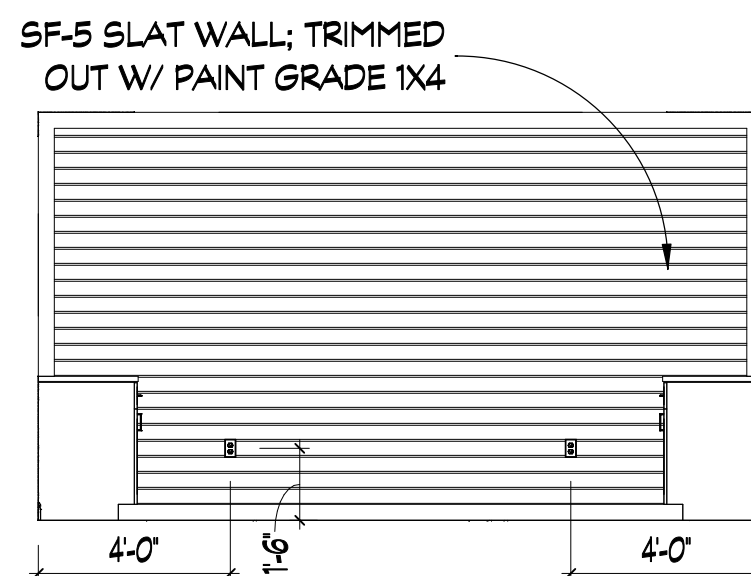

6 MARKETPLACE
SCALE: 1/4" = 1'-0"

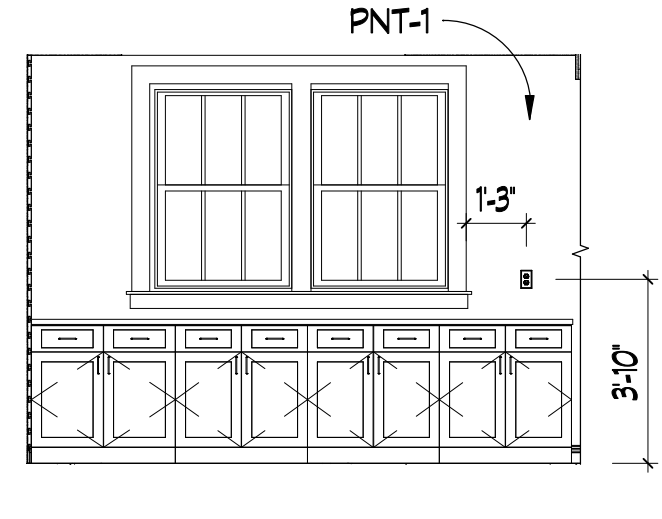


7 MARKETPLACE
SCALE: 1/4" = 1'-0"

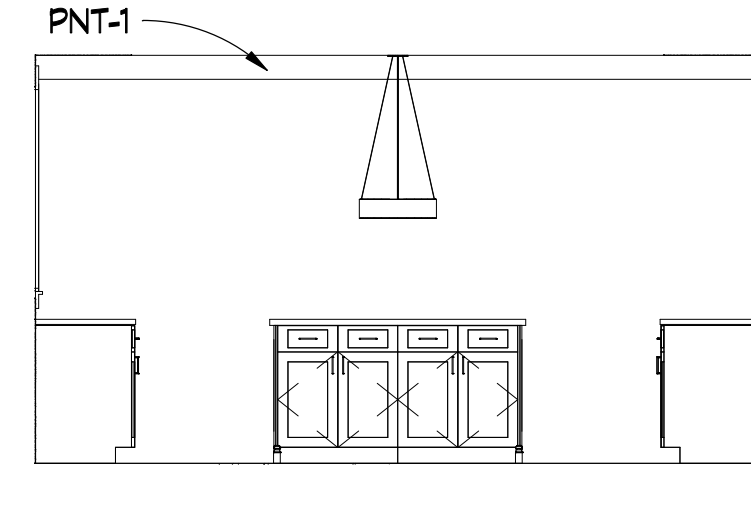


8 MARKETPLACE
SCALE: 1/4" = 1'-0"


VWC-2 BEHIND GLASS ON STANDOFFS ON TOP TO CREATE WRITING SURFACE. PROVIDE SUPPORT & STANDOFFS AS REQ'D.

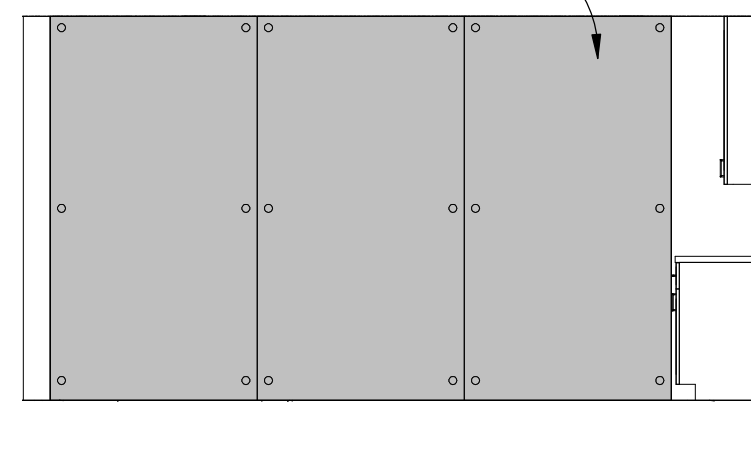


9 VOLUNTEER HUB
SCALE: 1/4" = 1'-0"

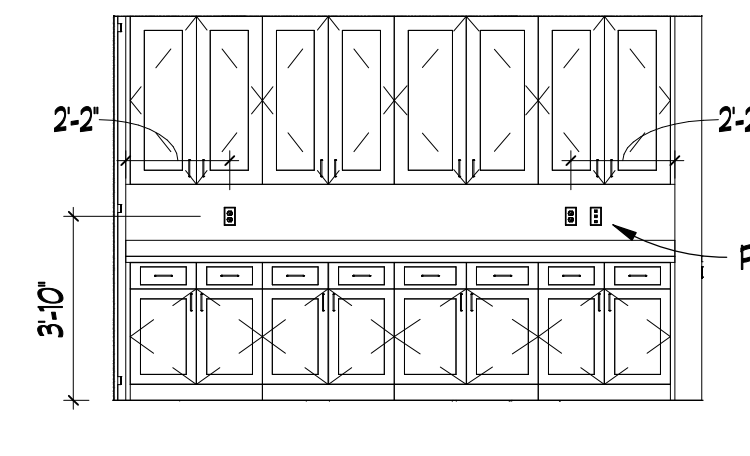


10 VOLUNTEER HUB
SCALE: 1/4" = 1'-0"

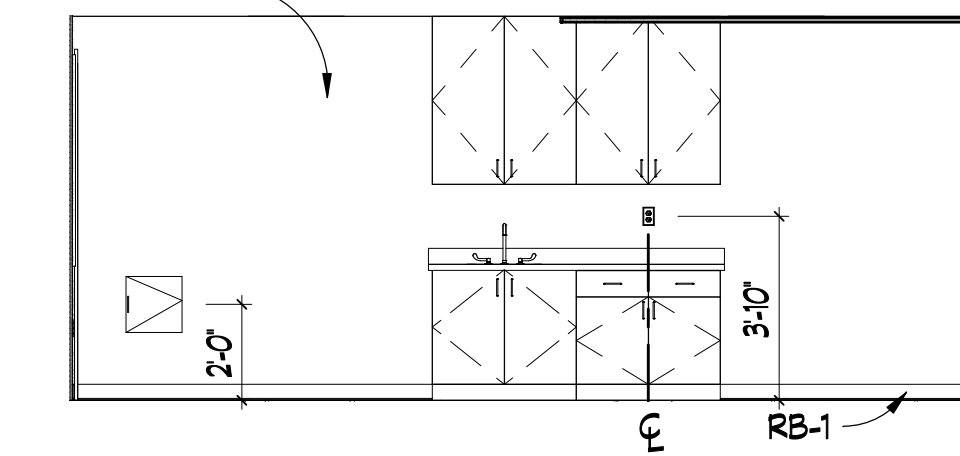


11 NURSES OFFICE/SENSORY ROOM
SCALE: 1/4" = 1'-0"

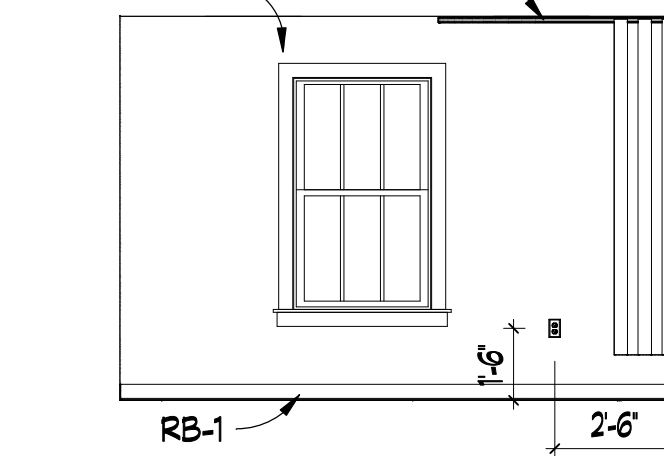


12 NURSES OFFICE/SENSORY ROOM
SCALE: 1/4" = 1'-0"

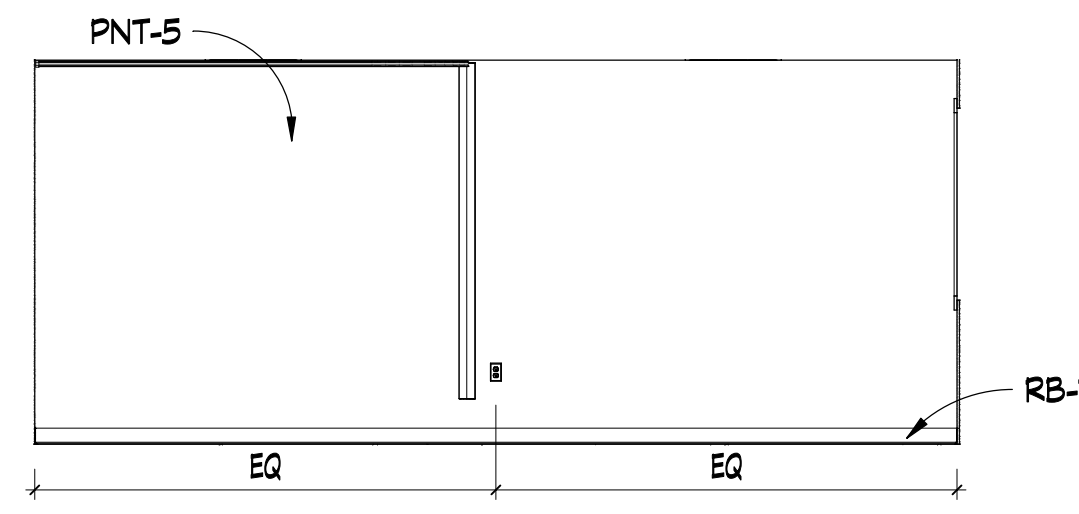


13 NURSES OFFICE/SENSORY ROOM
SCALE: 1/4" = 1'-0"

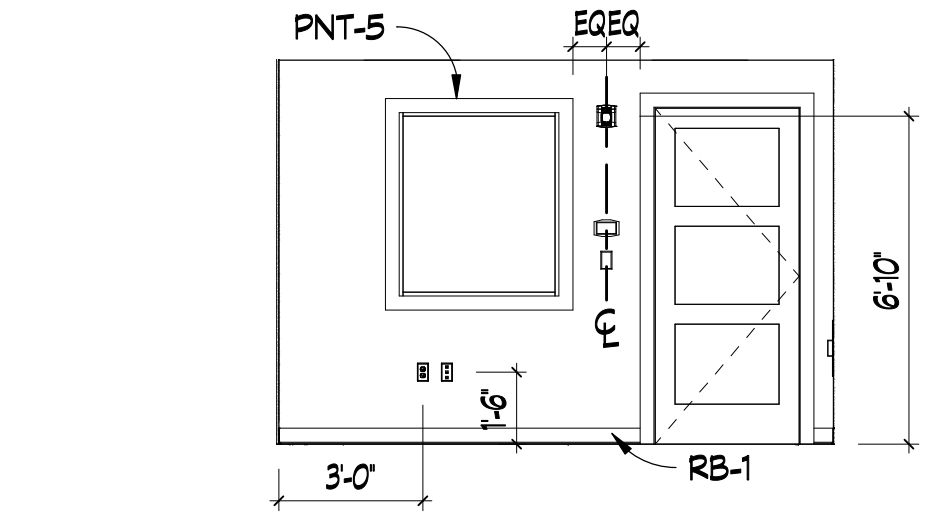


14 NURSES OFFICE/SENSORY ROOM
SCALE: 1/4" = 1'-0"

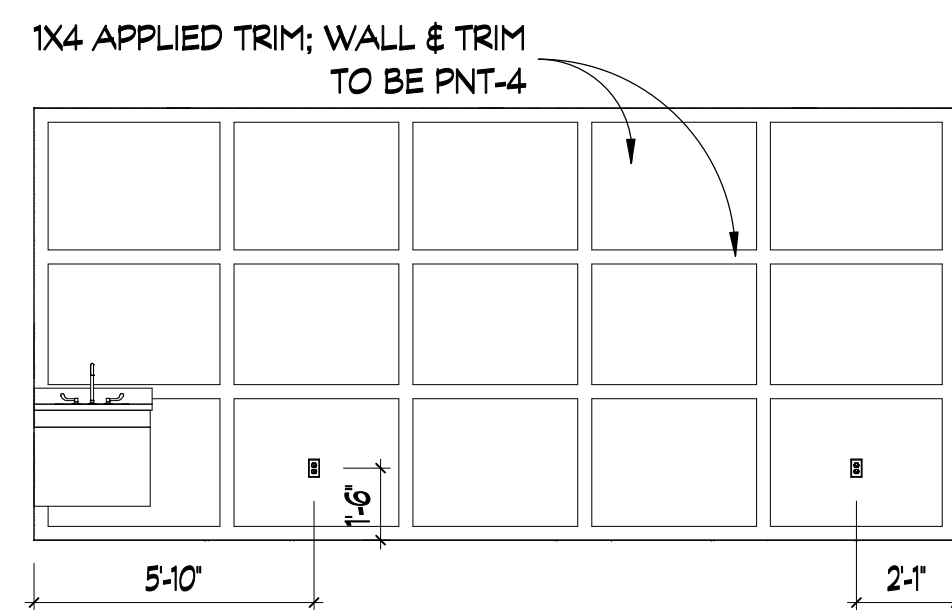


15 SALON
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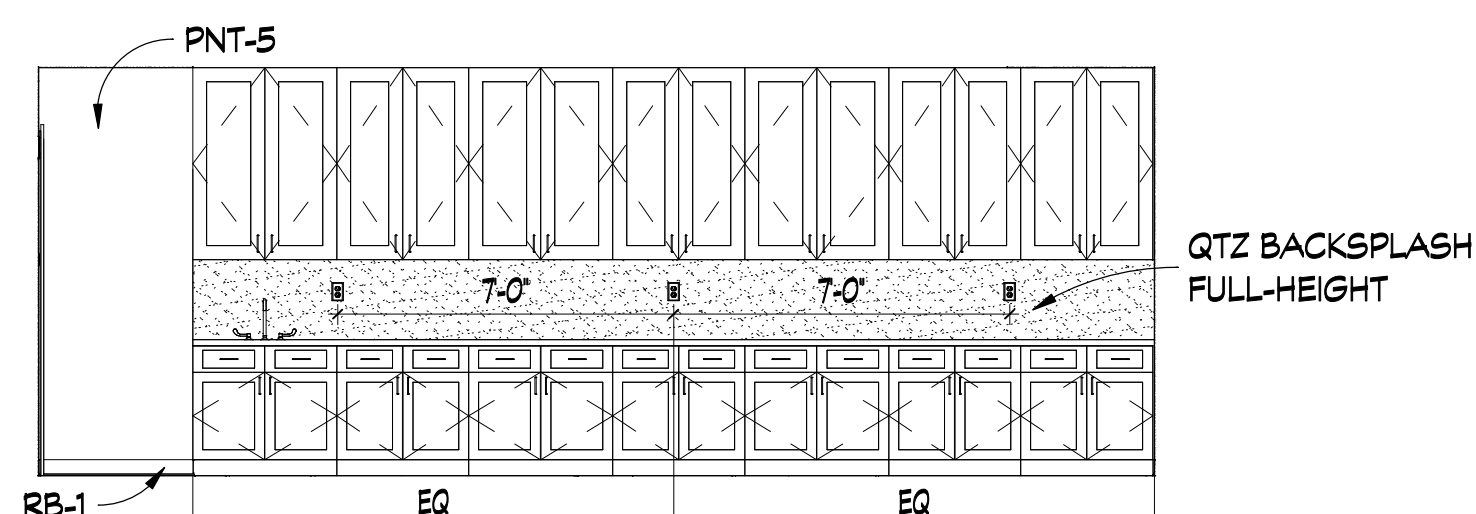
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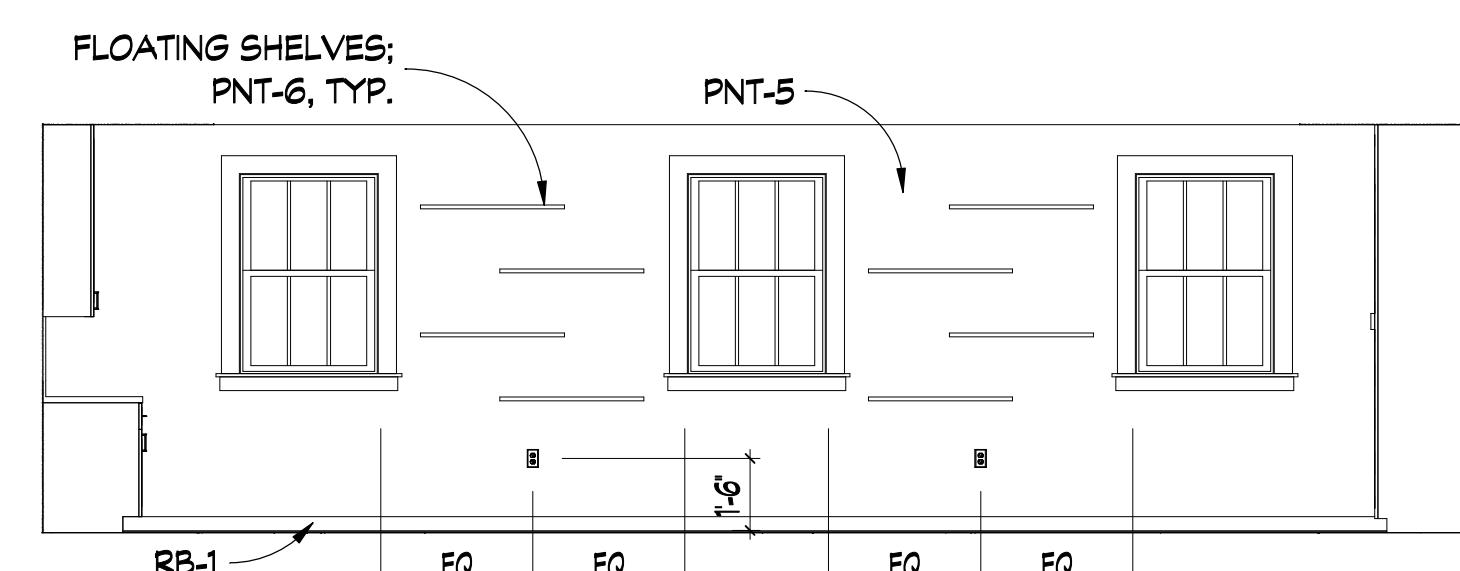
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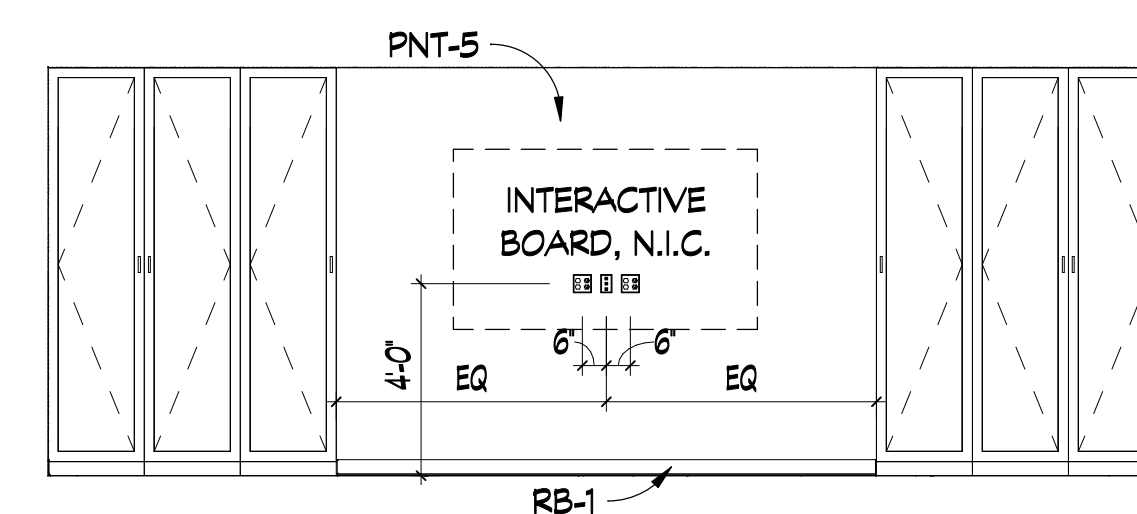
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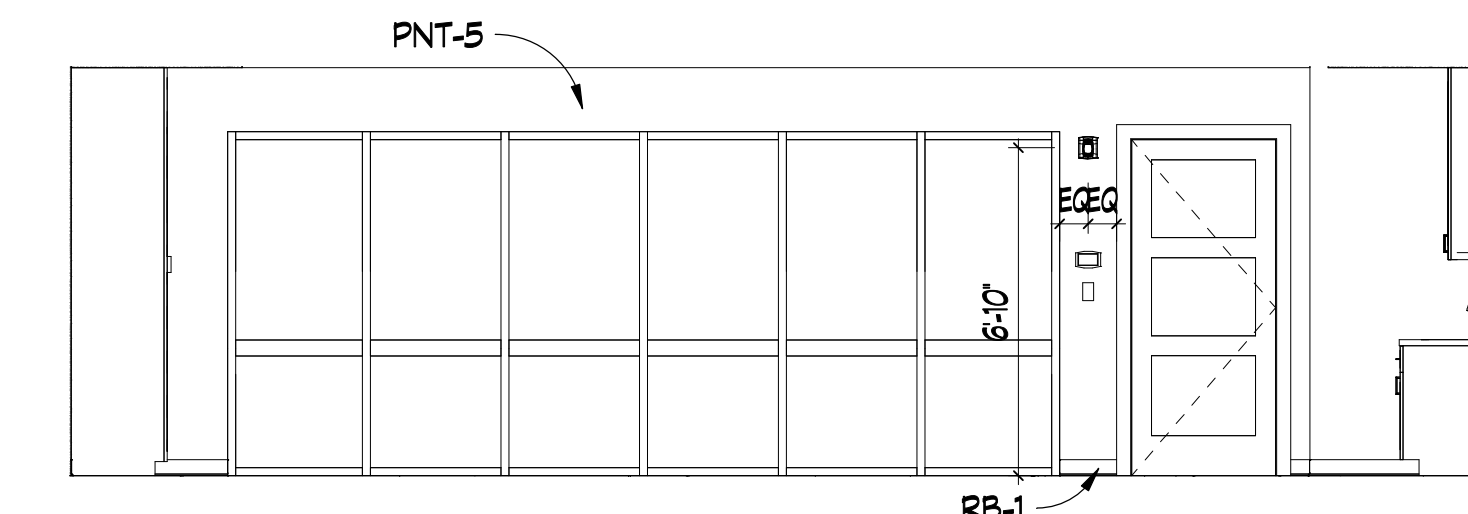
19 ART STUDIO
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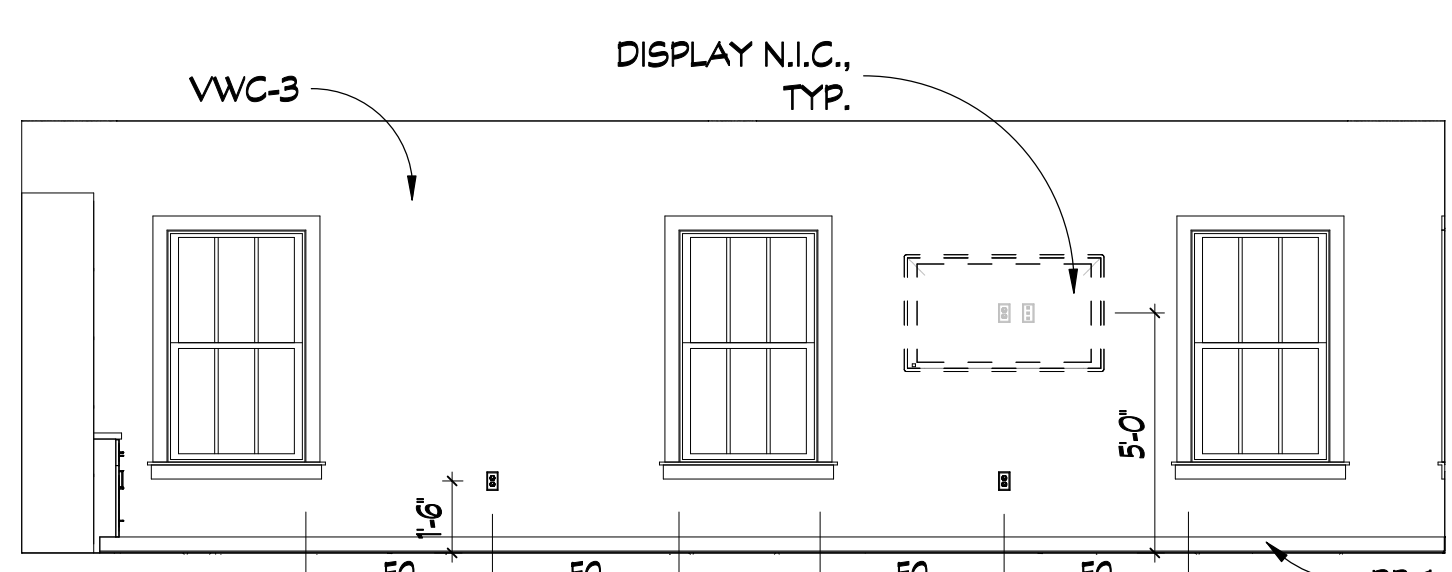
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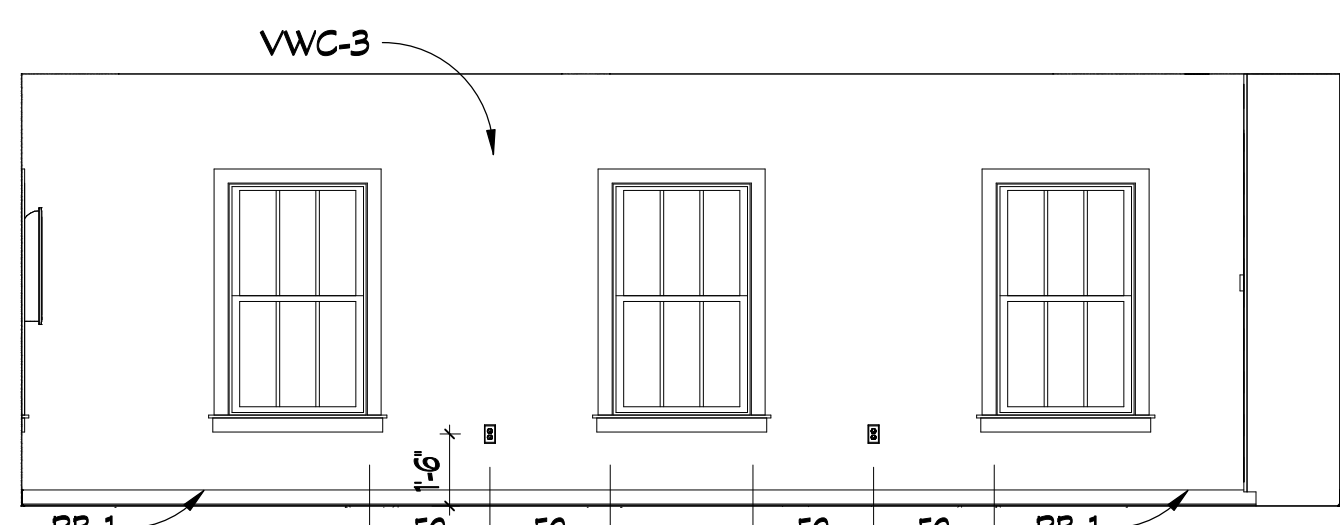
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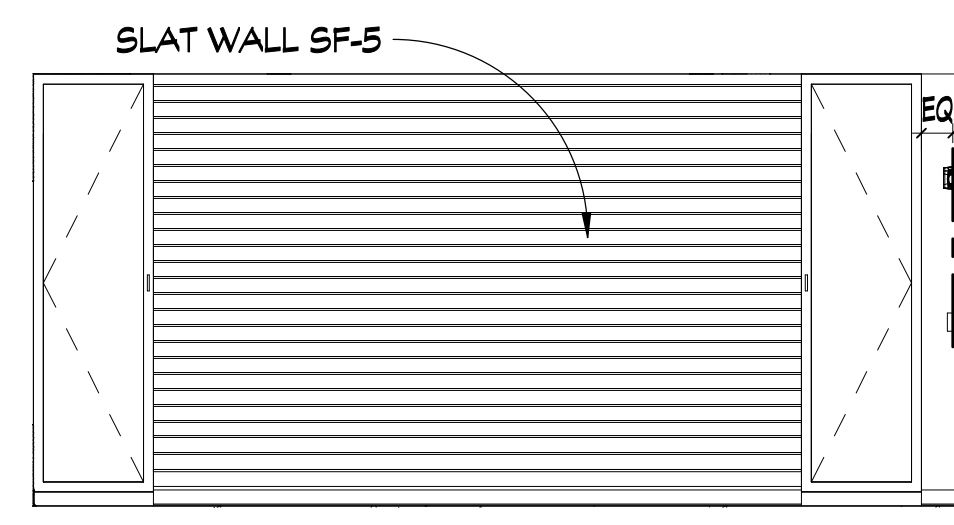
22 ART STUDIO
SCALE: 1/4" = 1'-0"

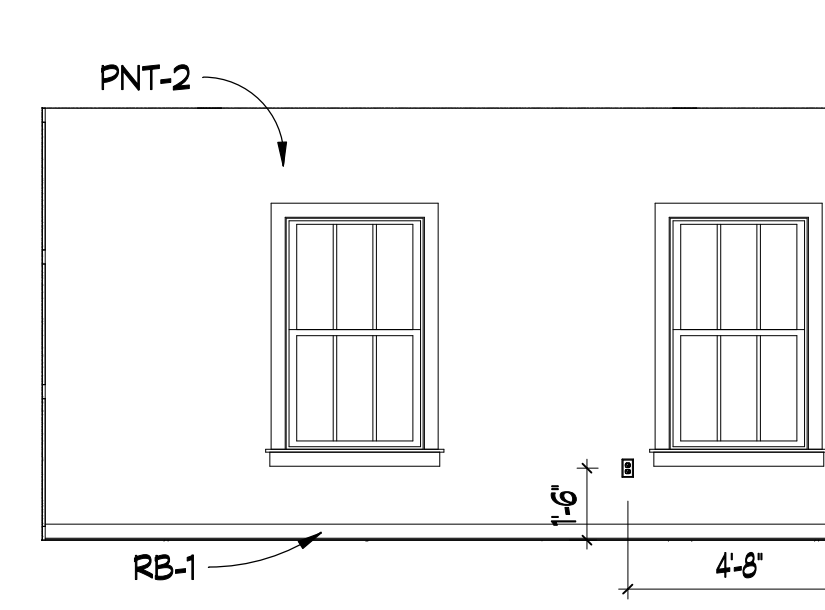


23 HOME HUB
SCALE: 1/4" = 1'-0"

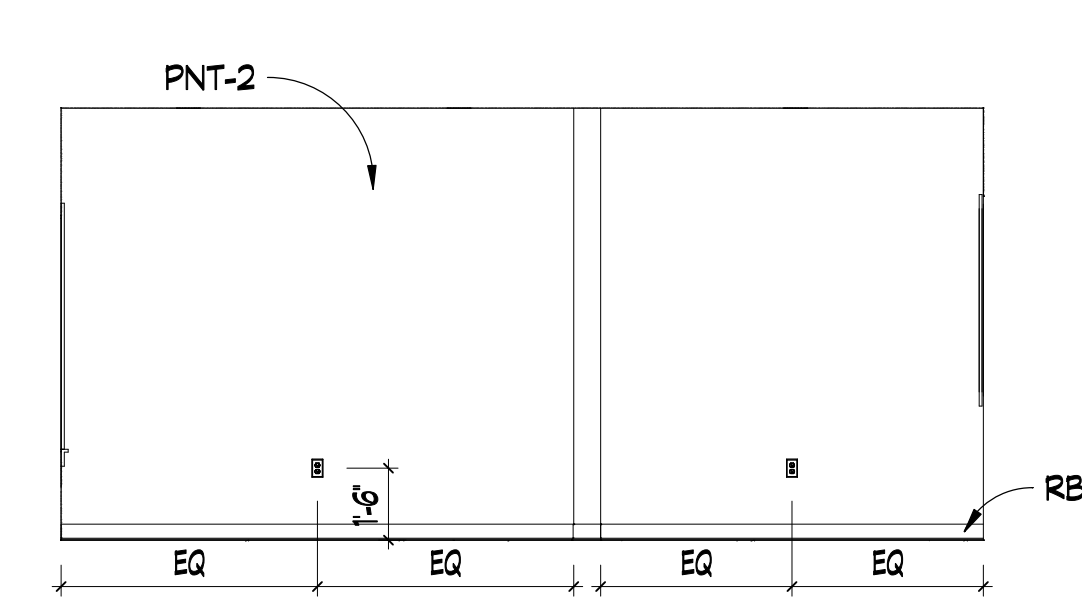


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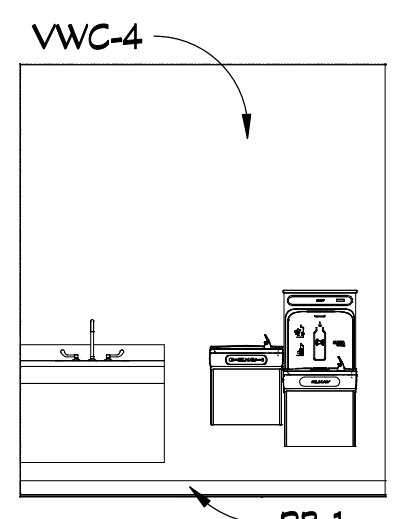
25 HOME HUB
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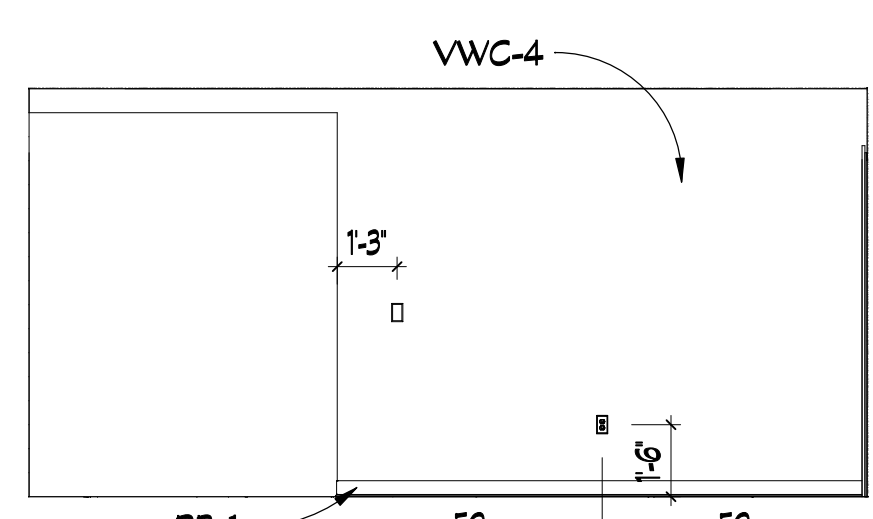
26 HOME HUB
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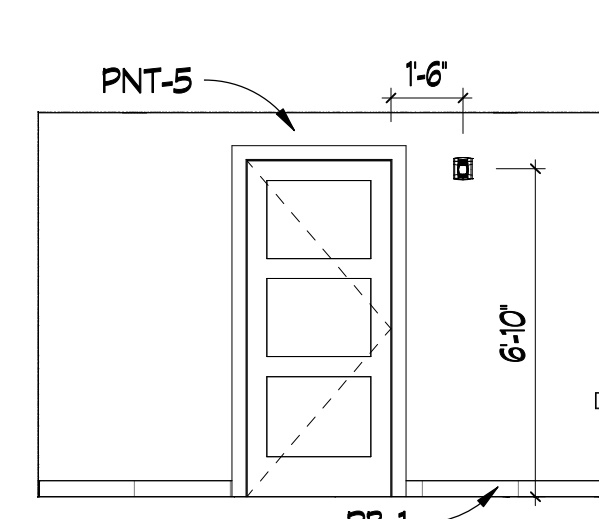
27 COMPUTER LAB
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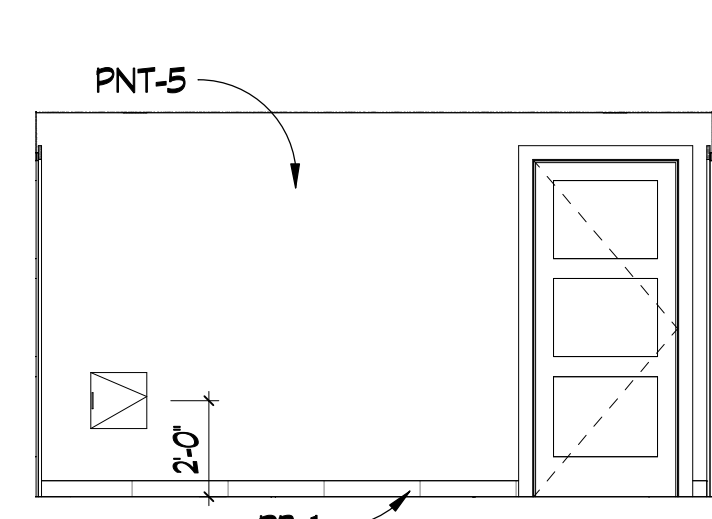
28 CORR. 121.3
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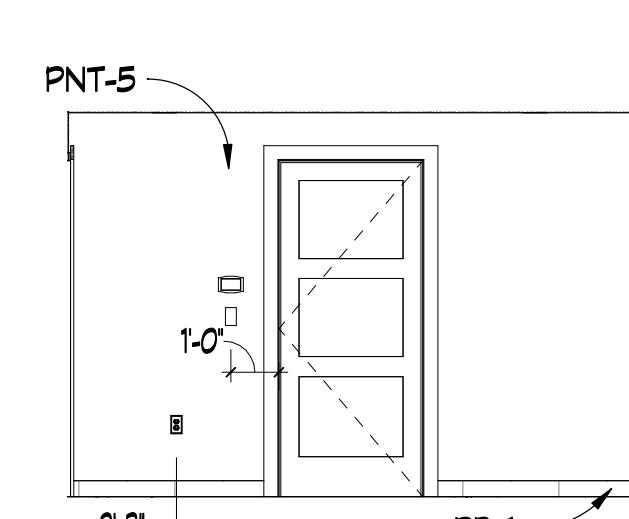
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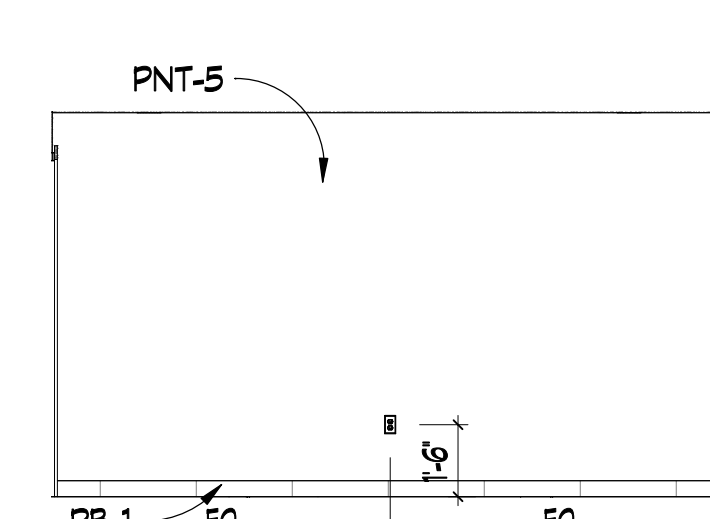
30 SPA
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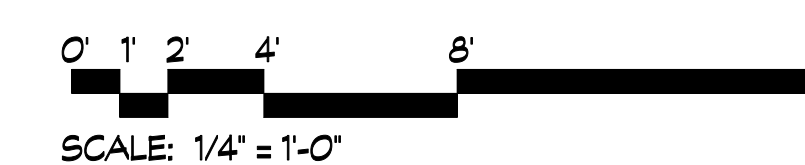
31 SPA
SCALE: 1/4" = 1'-0"

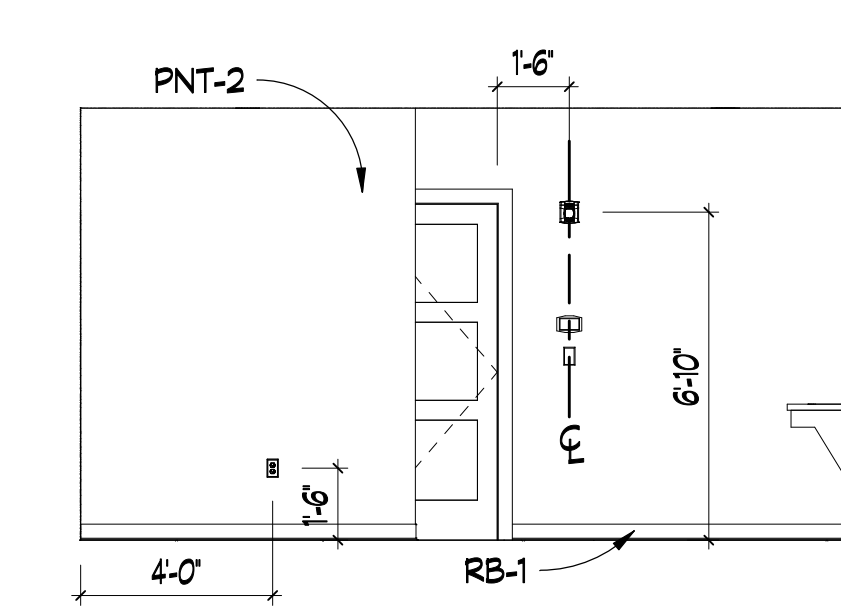

32 SPA
SCALE: 1/4" = 1'-0"

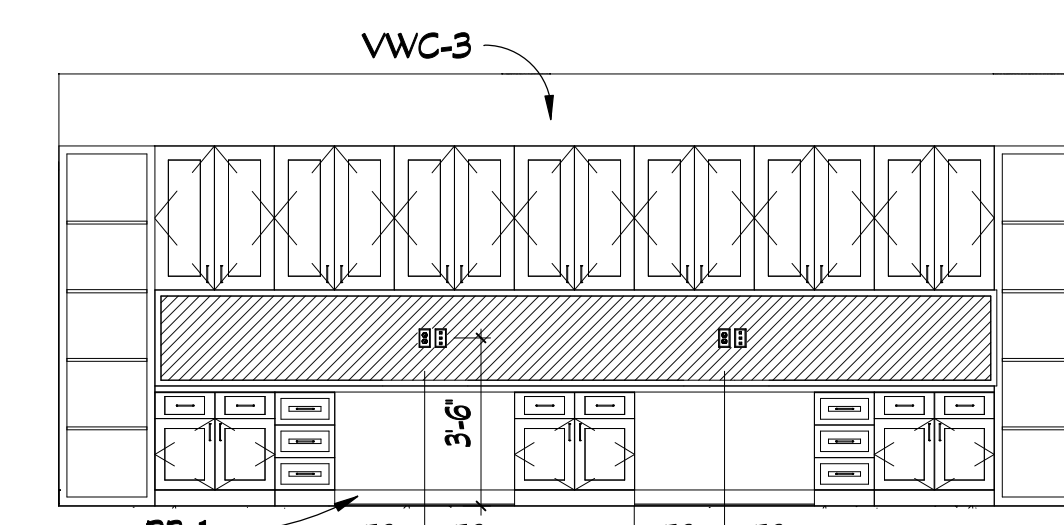

33 SPA
SCALE: 1/4" = 1'-0"

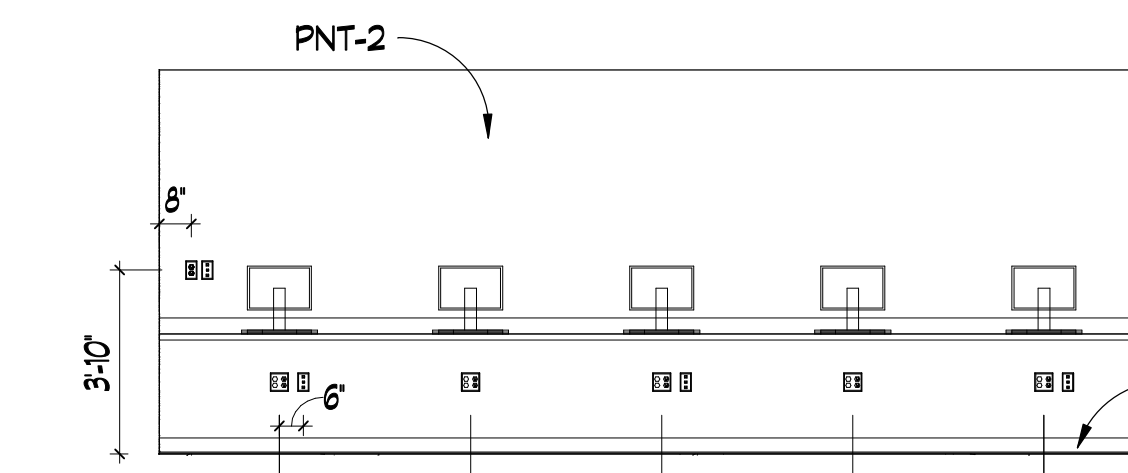

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ARCHITECTS
Architecture/Interior Design/Planning
771 Broad Street Suite 200
Augusta, Georgia 30901
(706) 722-7488
mail@dickinsonarchitects.com
www.dickinsonarchitects.com

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American Institute of
Architects

PROJECT TITLE:
**JUD C
HICKEY
CENTER**


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2/16/22		EA		ISSUE FOR PERMIT

STATE OF GEORGIA
Erin McIsley Atkinson
REGISTERED ARCHITECT
4/10/22

DA PROJECT NUMBER & NAME:
1893
DRAWING TITLE:
**INTERIOR
ELEVATIONS**



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A821

REVISIONS			
REV #	DATE	APPROV BY	REVISION
1	11/17/21	EA	65% SET
2	2/16/22	EA	ISSUE FOR PERMIT


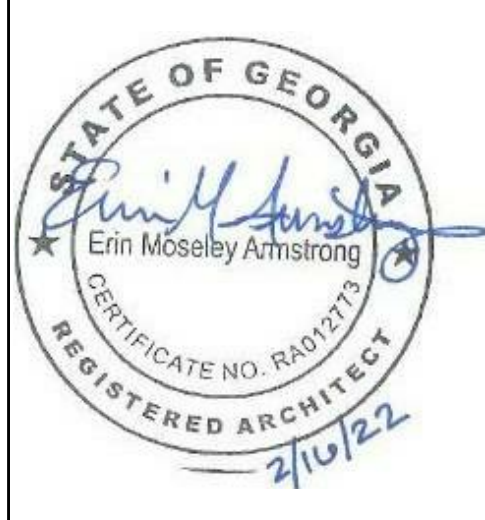



DA PROJECT NUMBER & NAME:
1893
DRAWING TITLE:
**INTERIOR
ELEVATIONS**

DRAWING NO:
A822

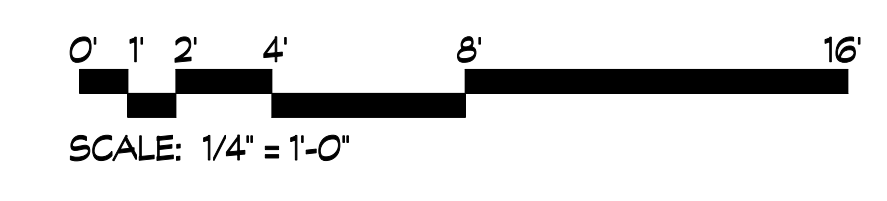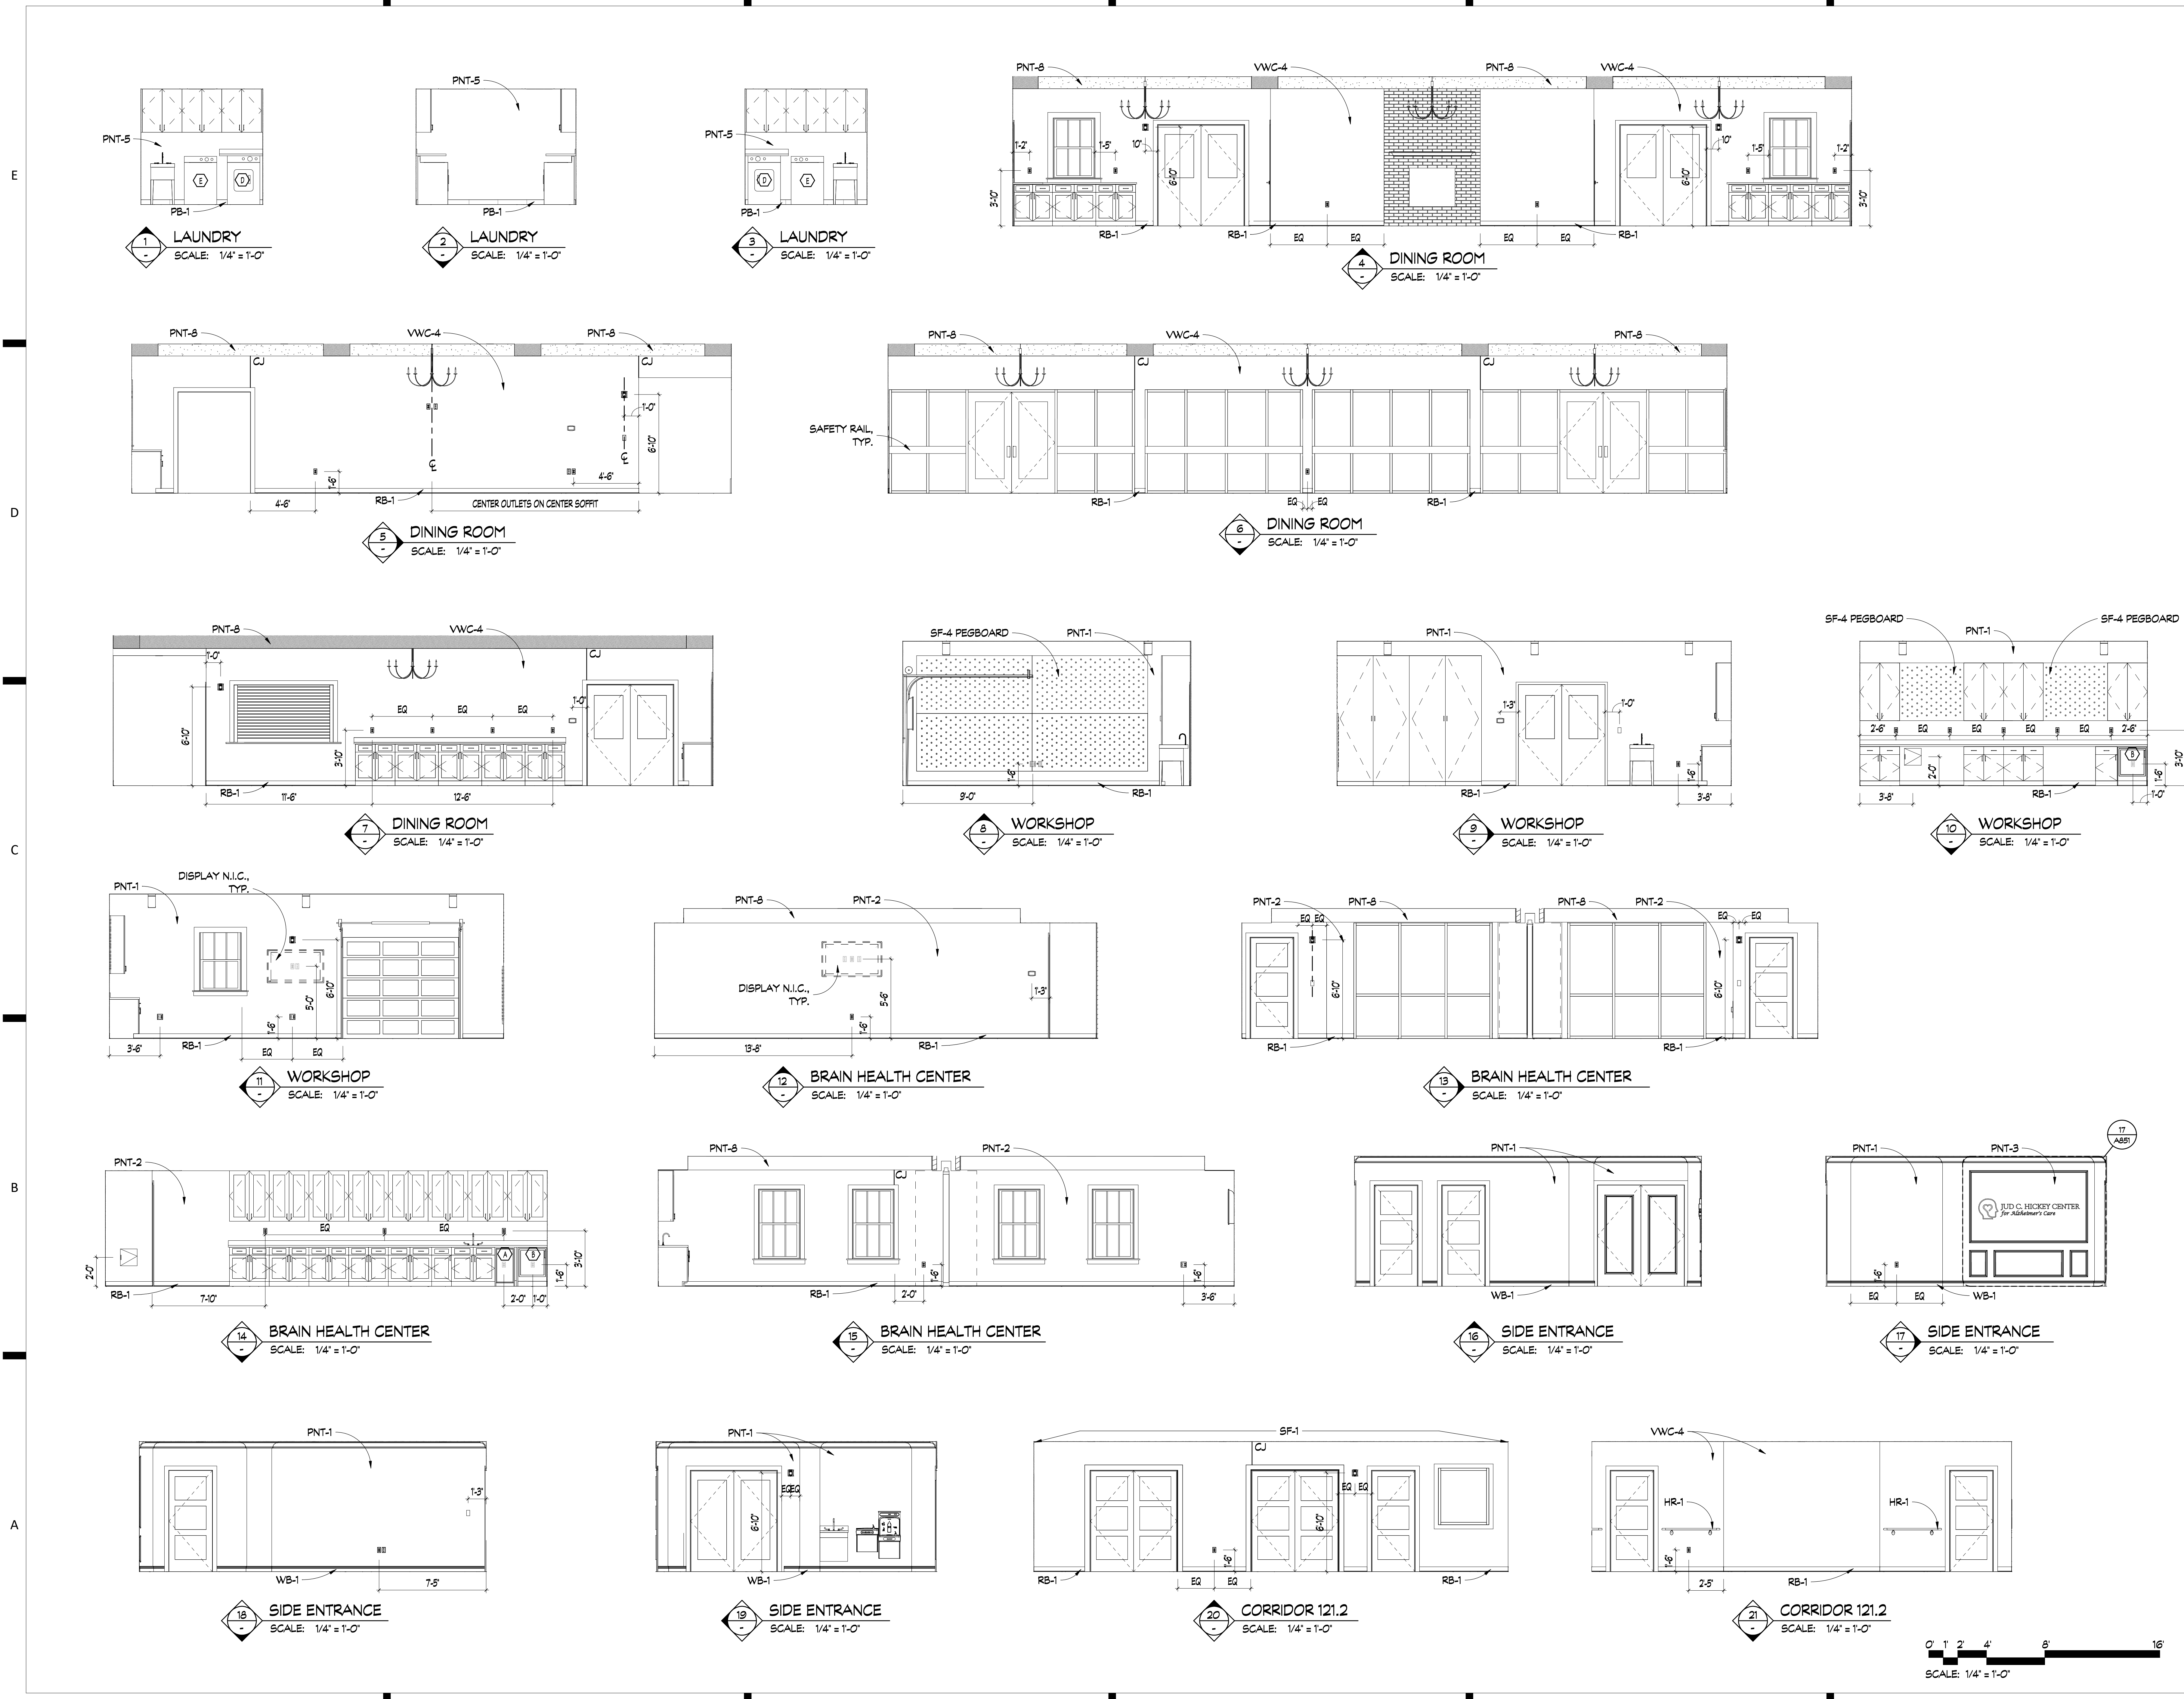


REVISIONS				
REV #	DATE	APPROV	BY	REVISION
1	11/17/21	EA		65% SET
2	2/16/22	EA		ISSUE FOR PERMIT

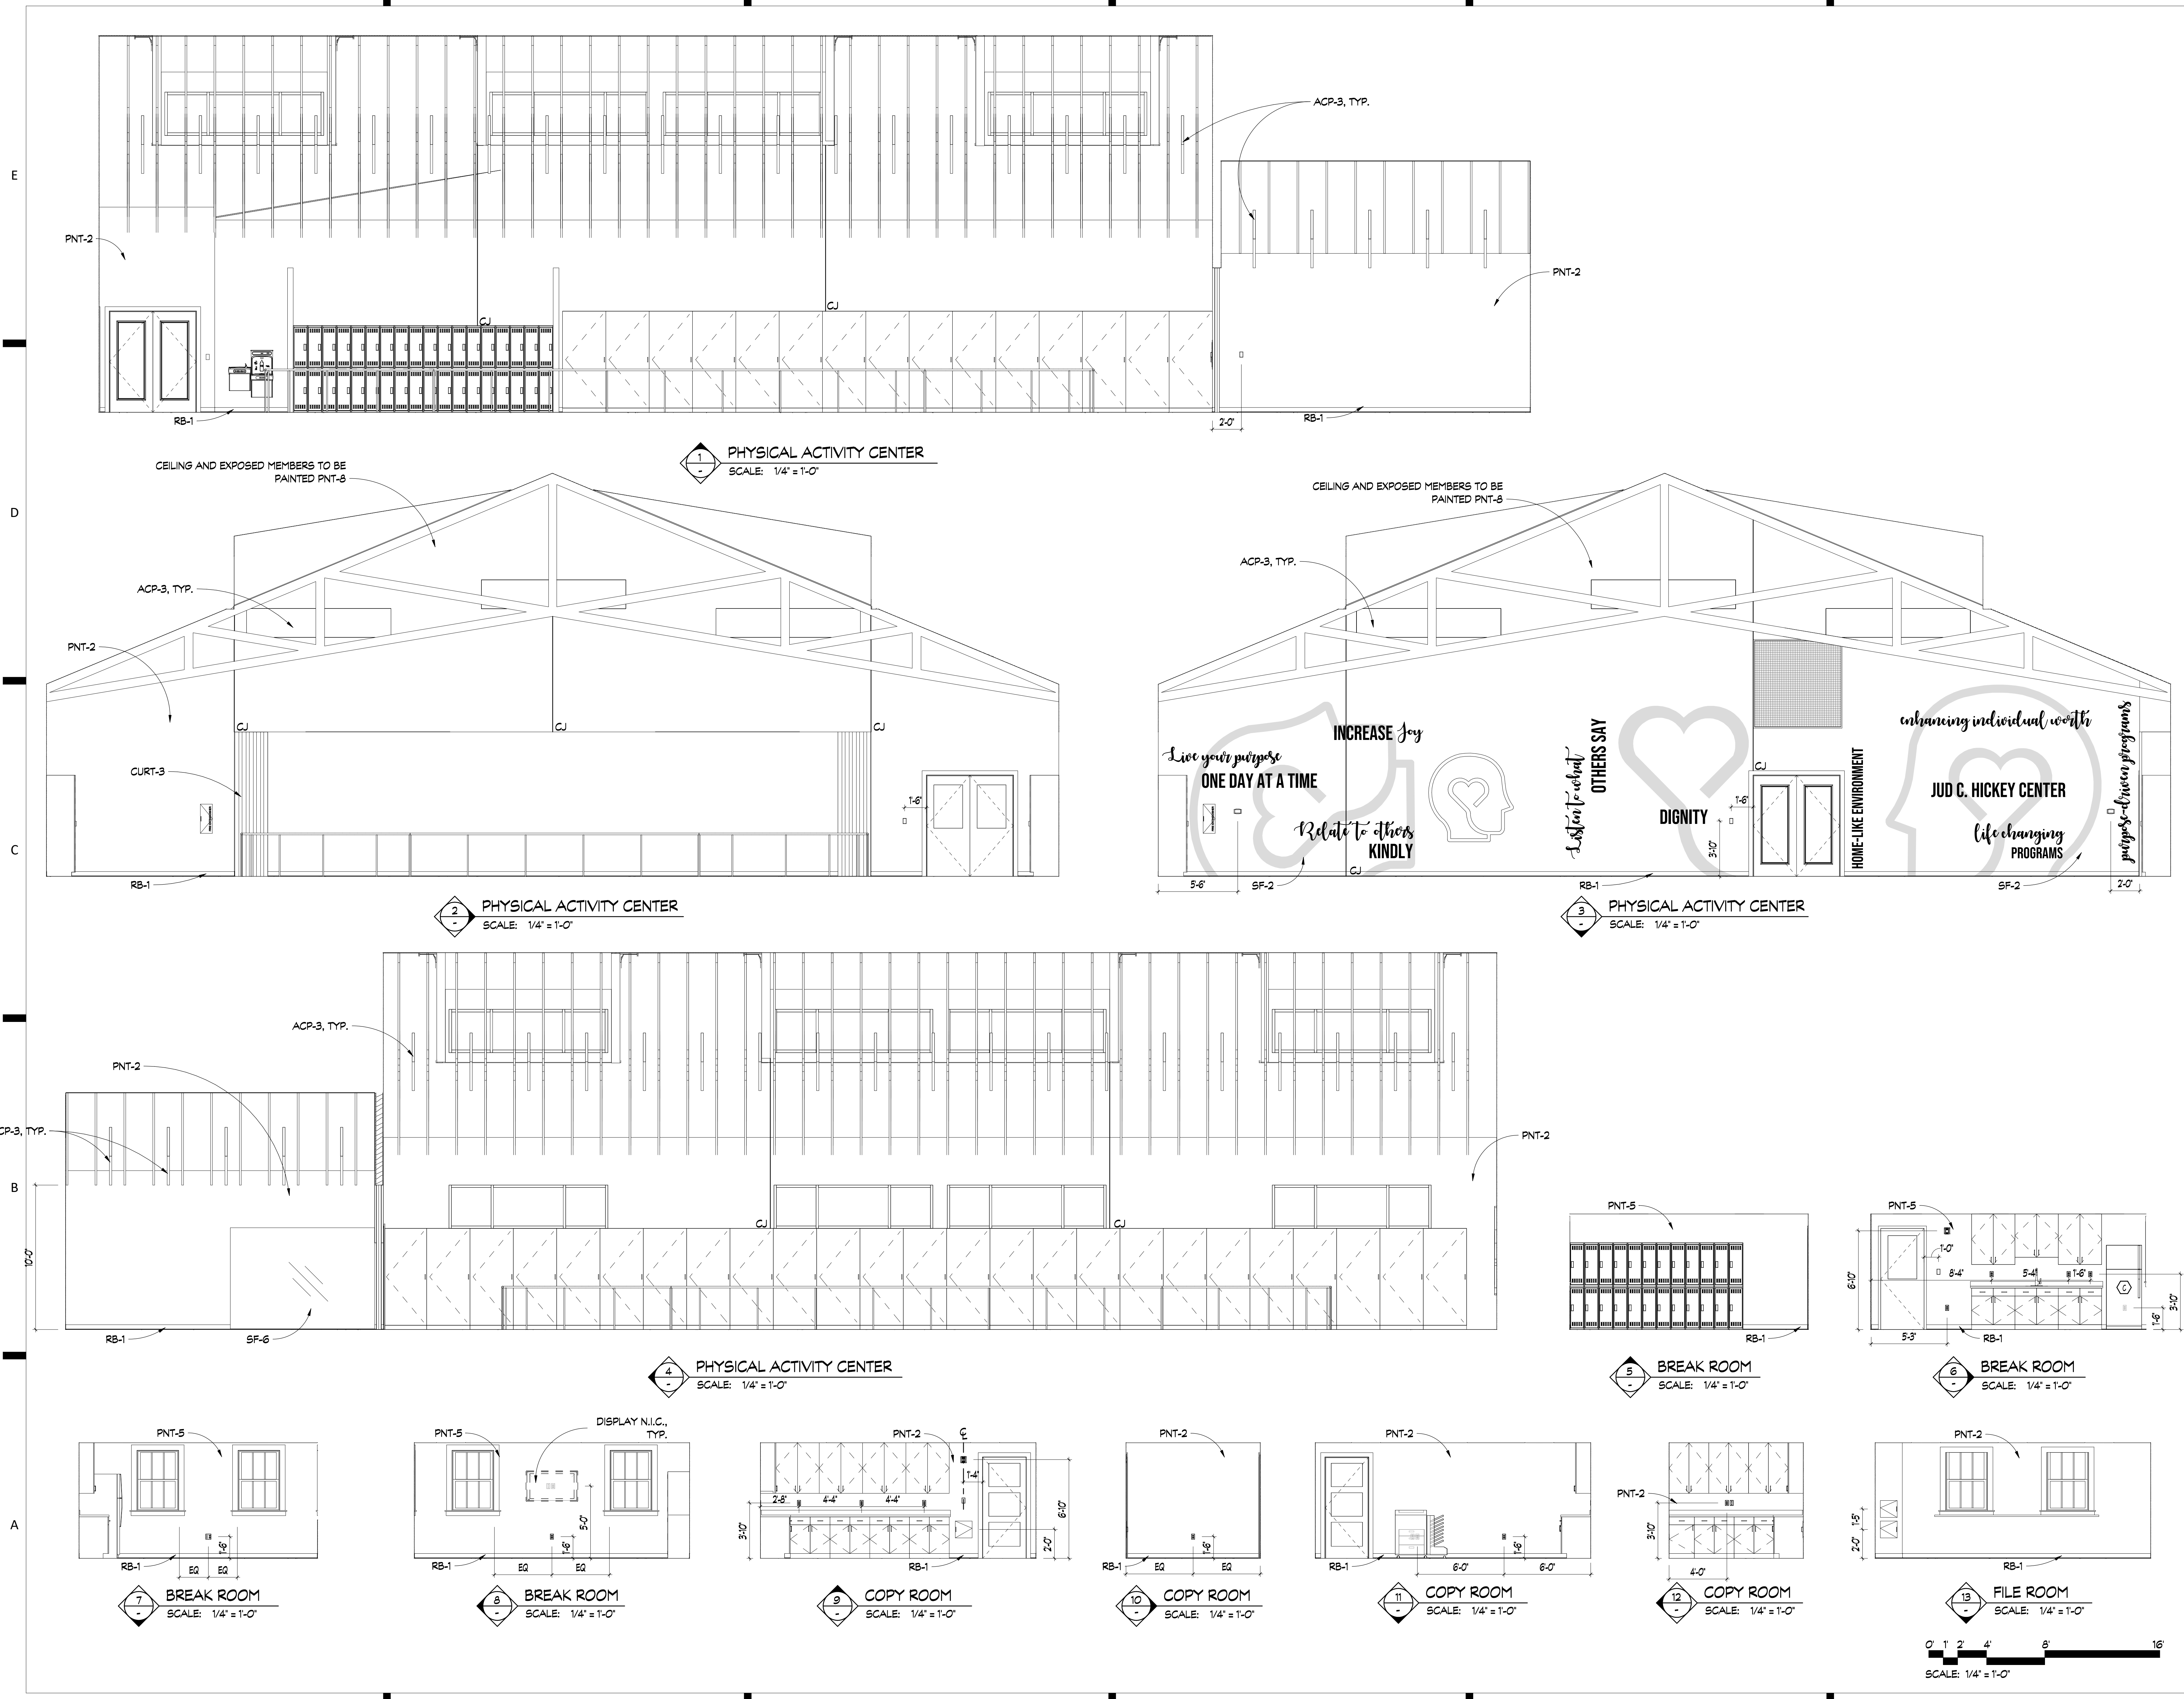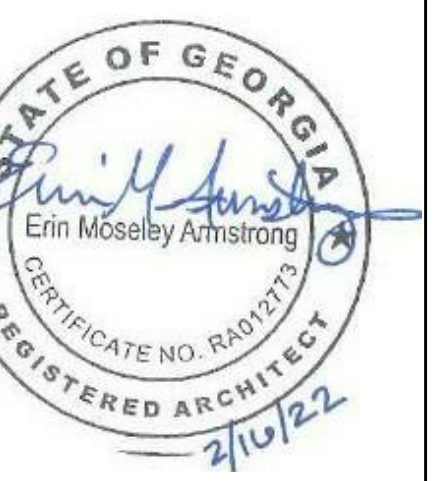


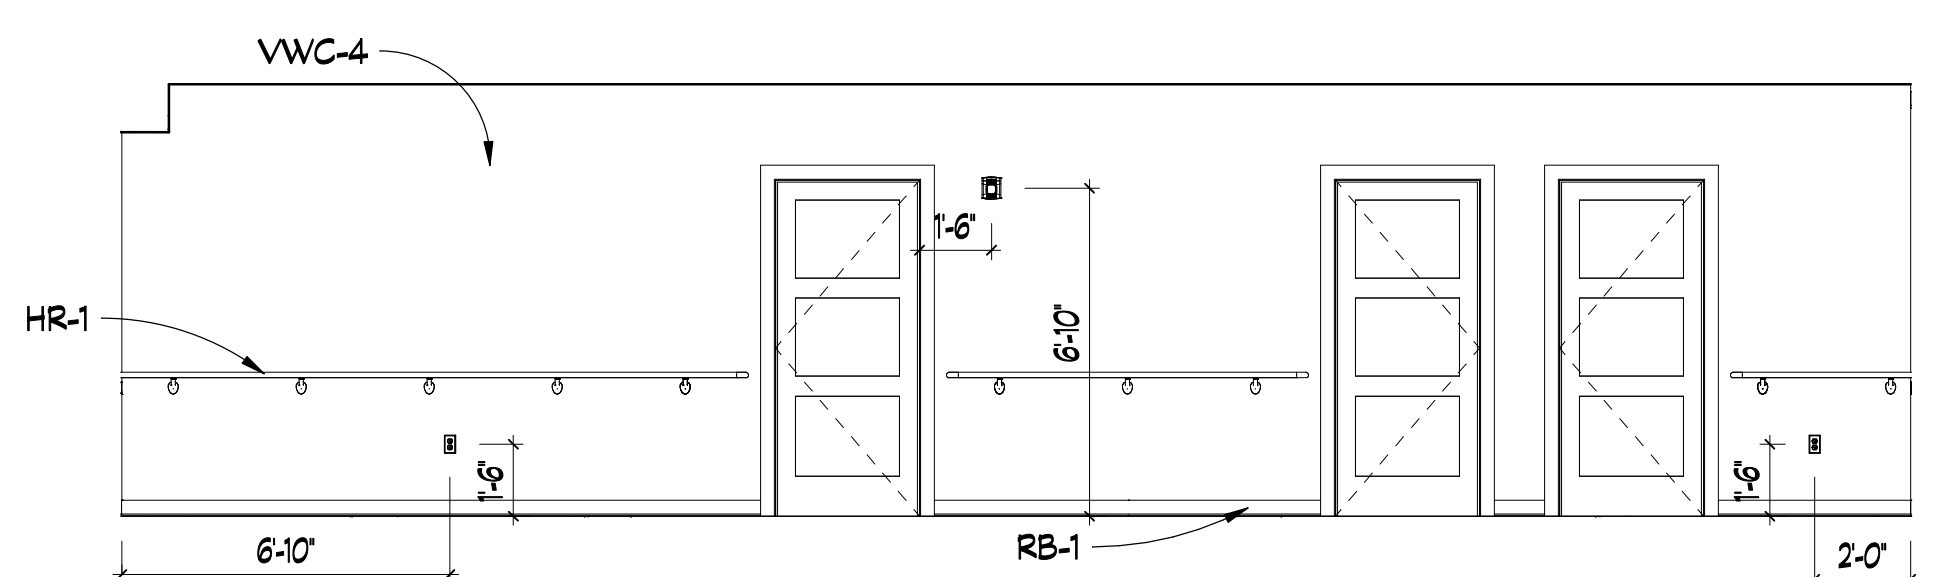


1 CORR. 109.1
SCALE: 1/4" = 1'-0"

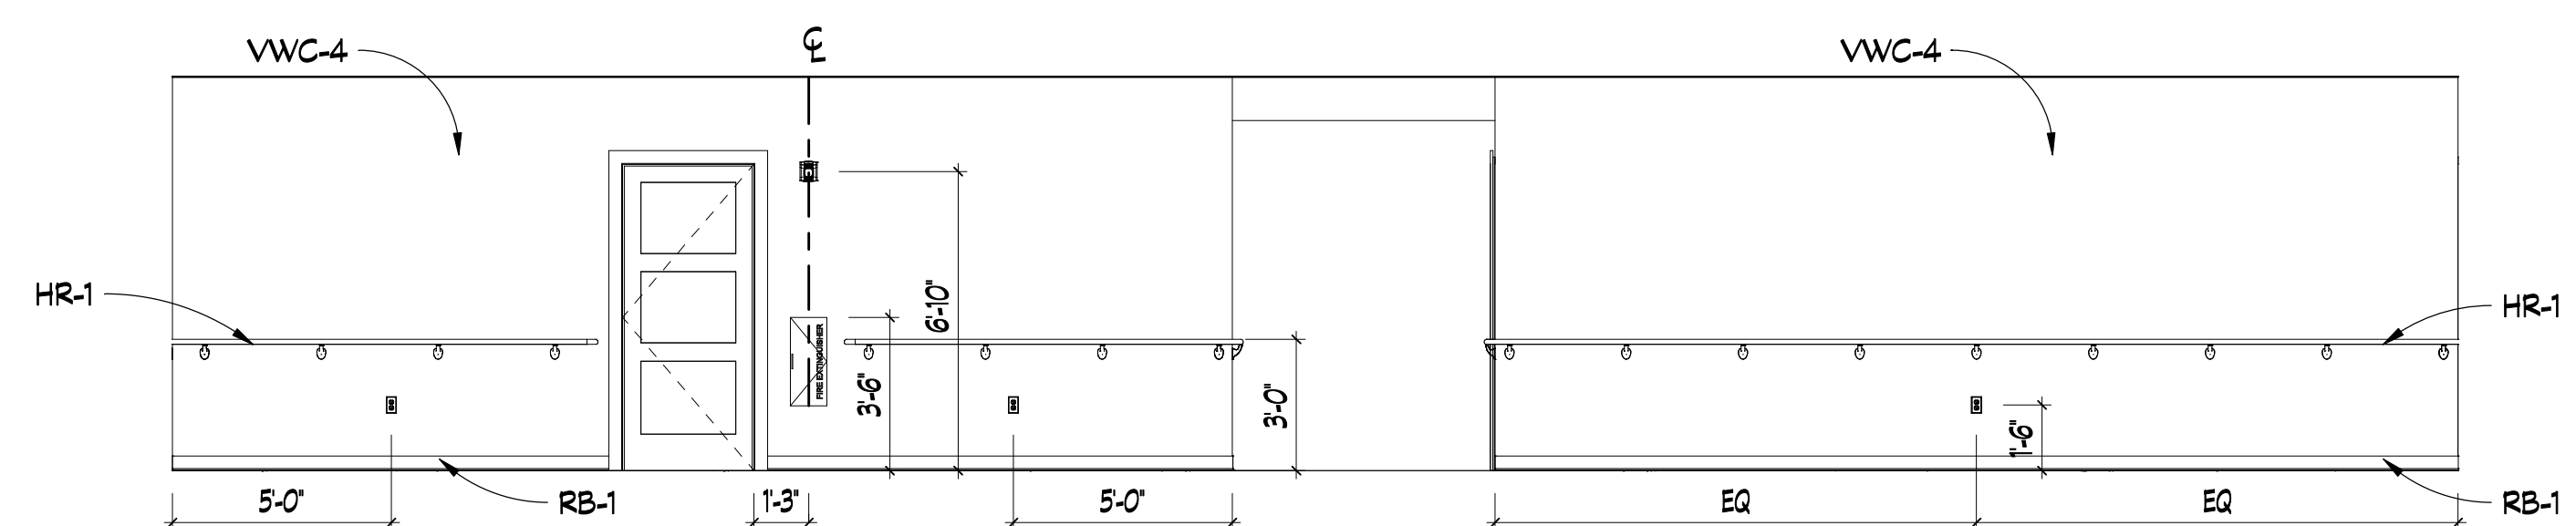


2 CORR. 113.2
SCALE: 1/4" = 1'-0"

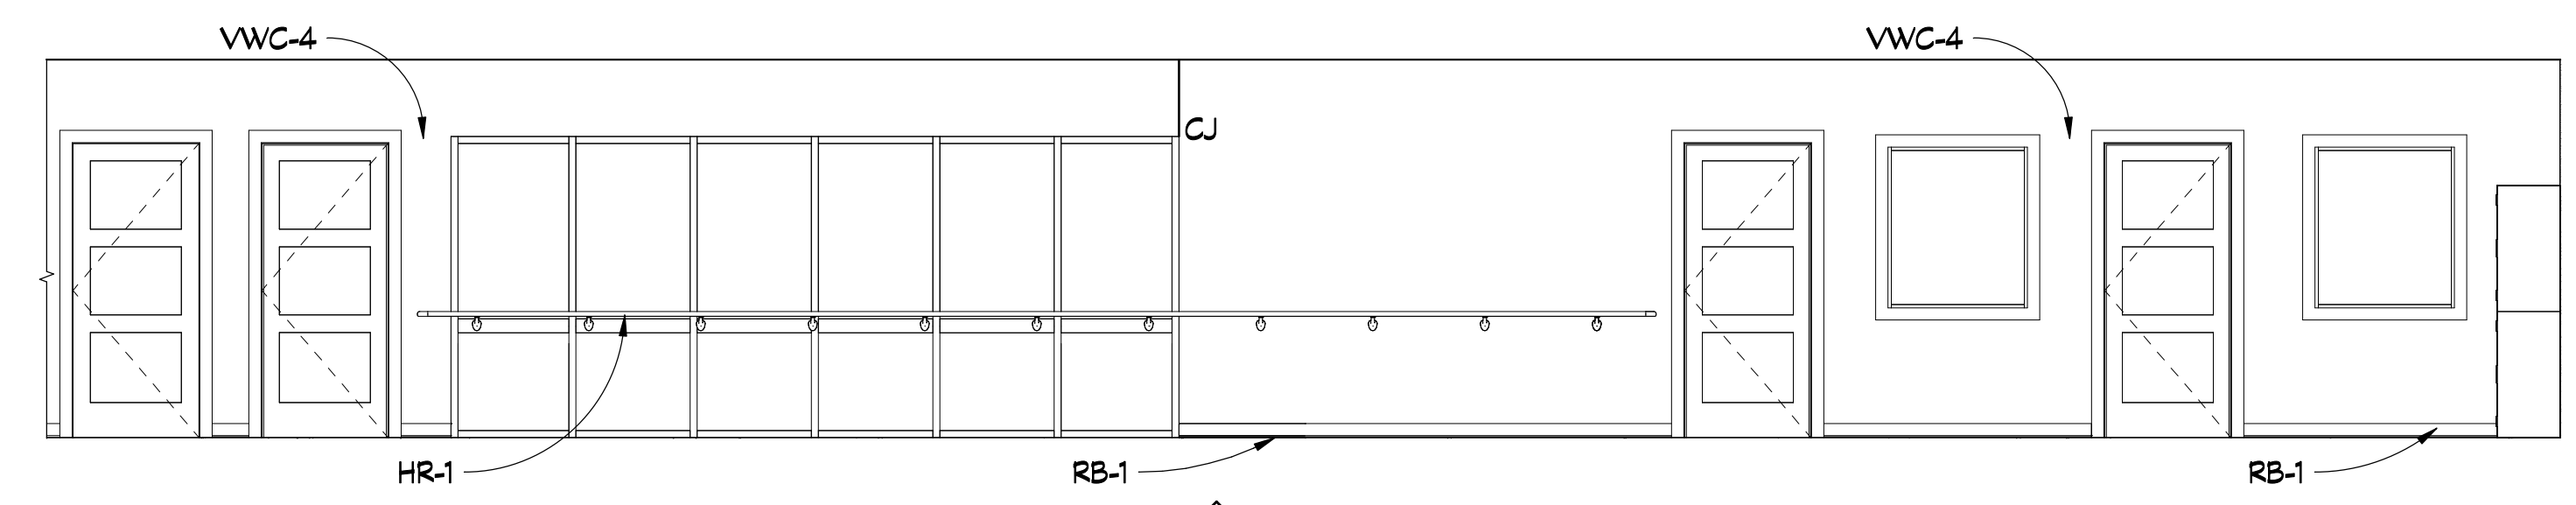


3 CORR. 113.2
SCALE: 1/4" = 1'-0"

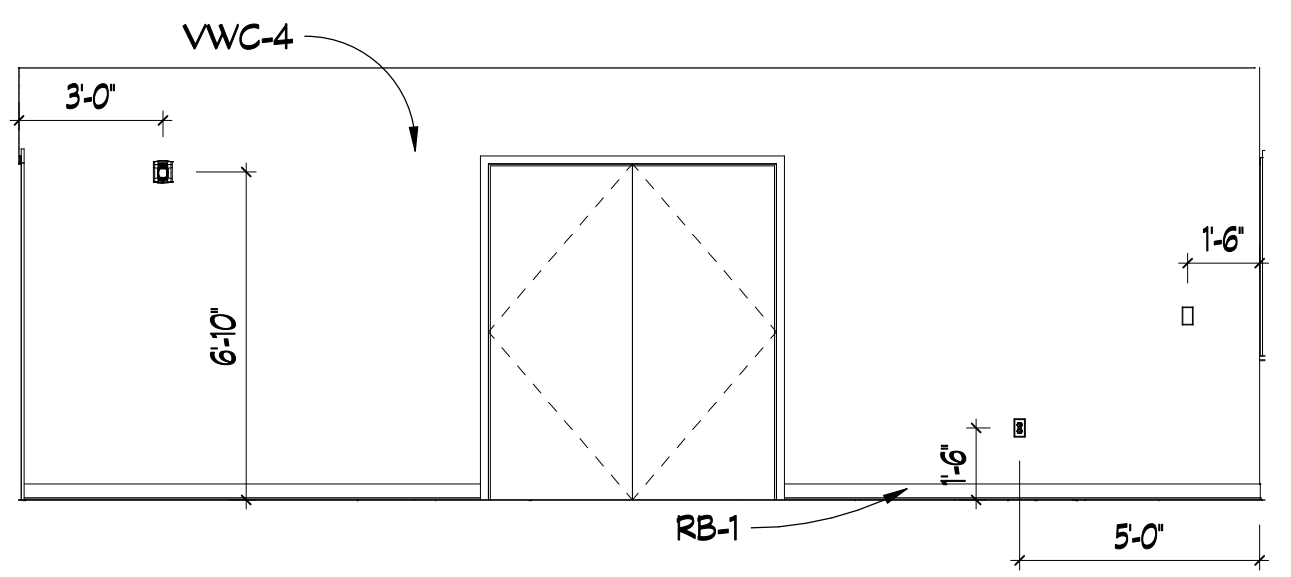


4 CORR. 126.1
SCALE: 1/4" = 1'-0"

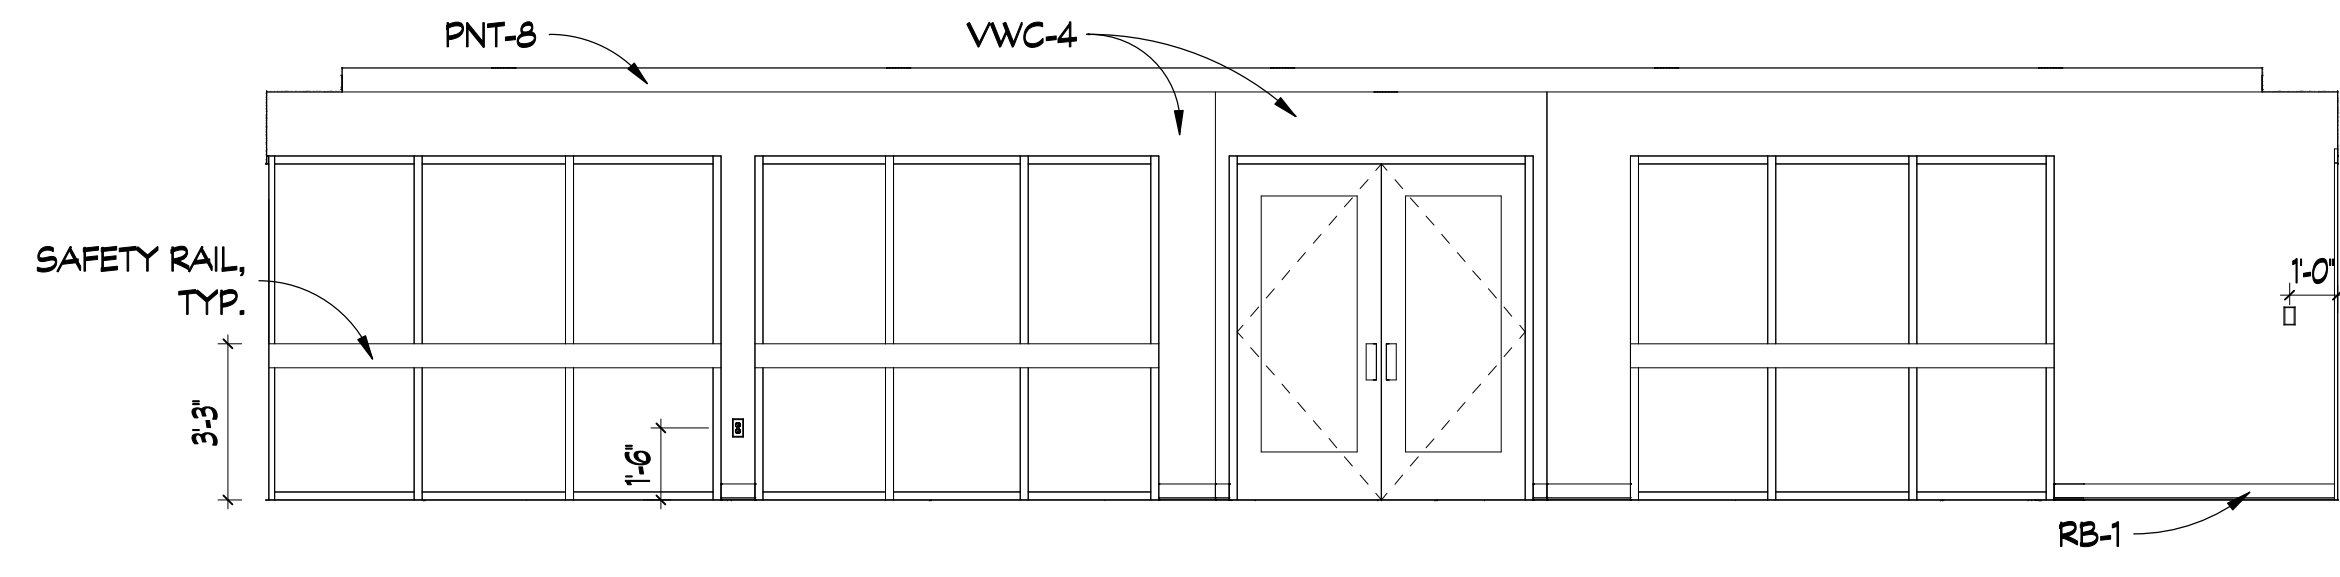


5 CORR. 134
SCALE: 1/4" = 1'-0"

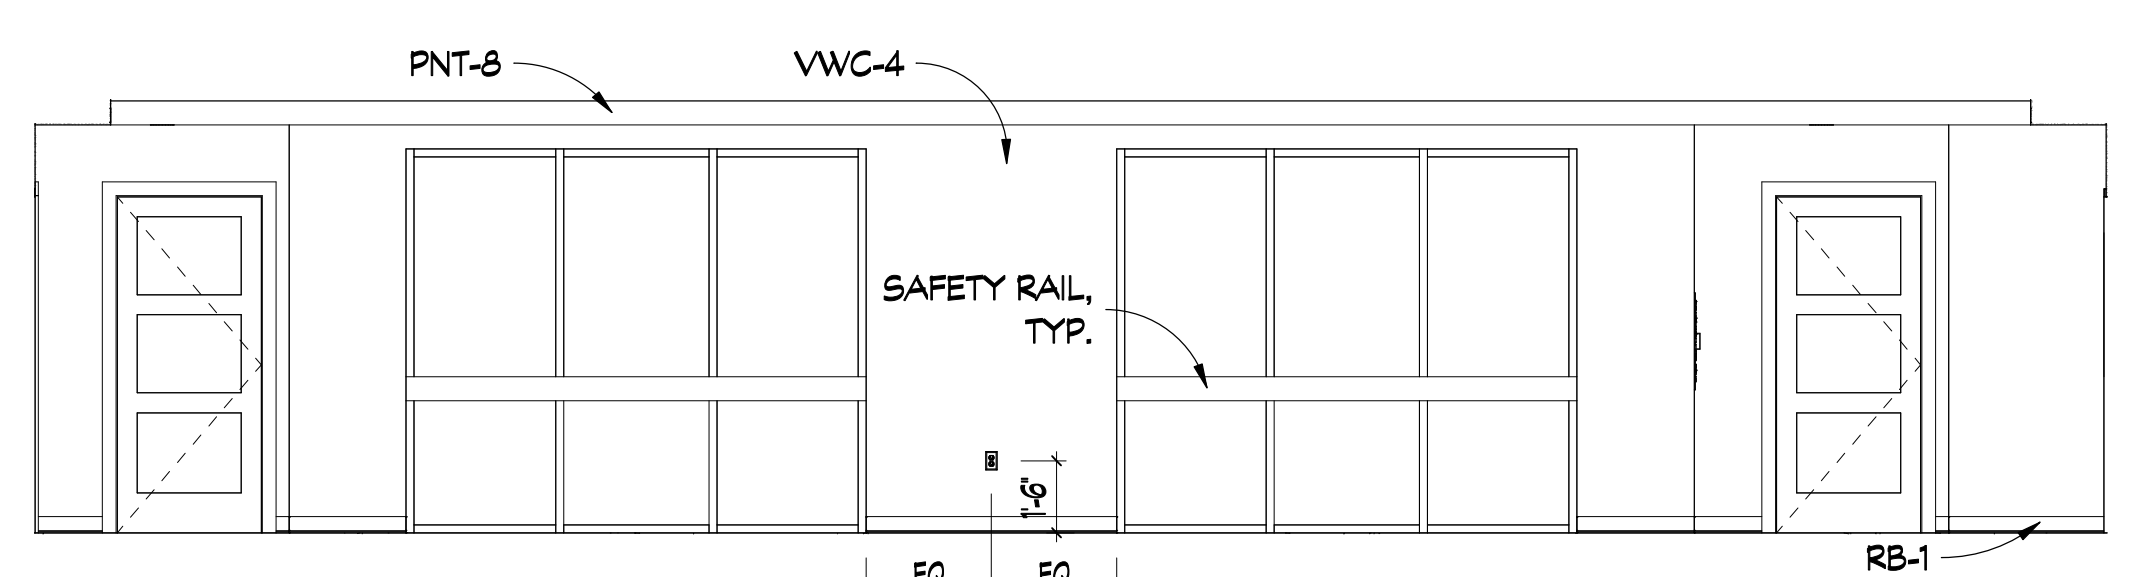


6 CORR. 134
SCALE: 1/4" = 1'-0"

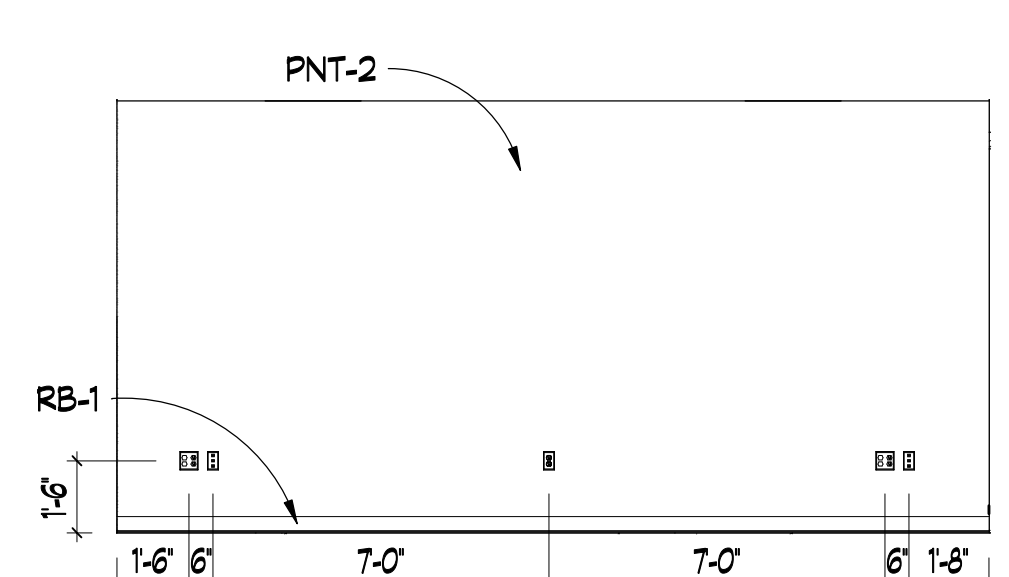


7 OPEN OFFICE
SCALE: 1/4" = 1'-0"

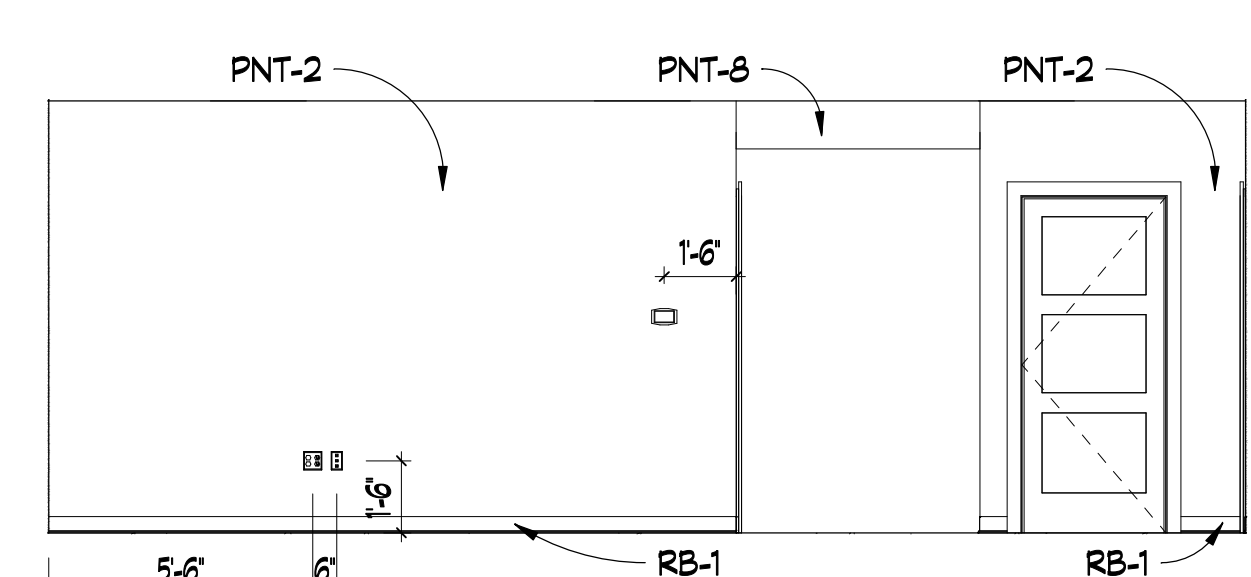


8 OPEN OFFICE
SCALE: 1/4" = 1'-0"

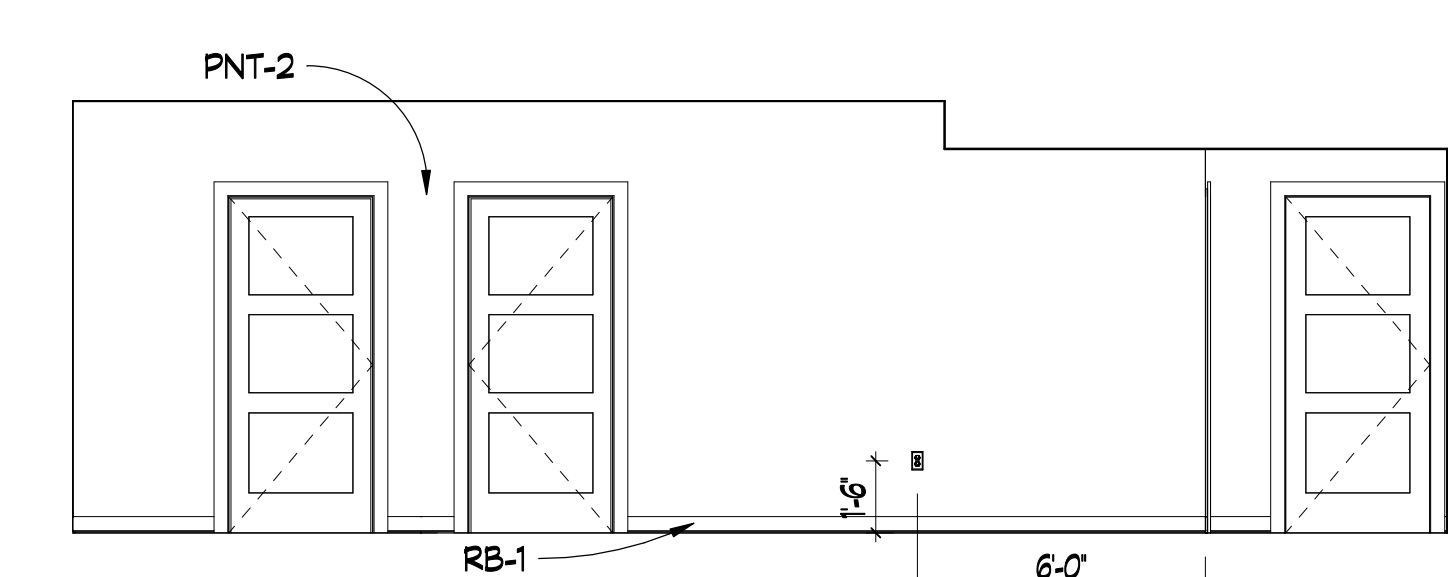


9 OPEN OFFICE
SCALE: 1/4" = 1'-0"

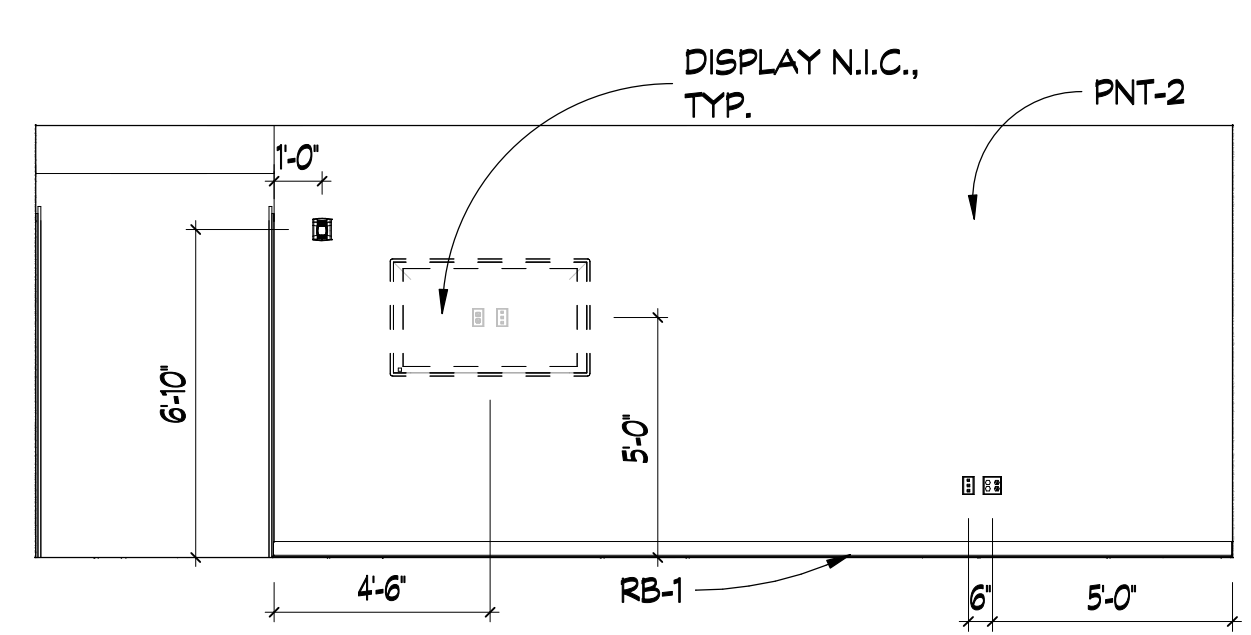


10 OPEN OFFICE
SCALE: 1/4" = 1'-0"

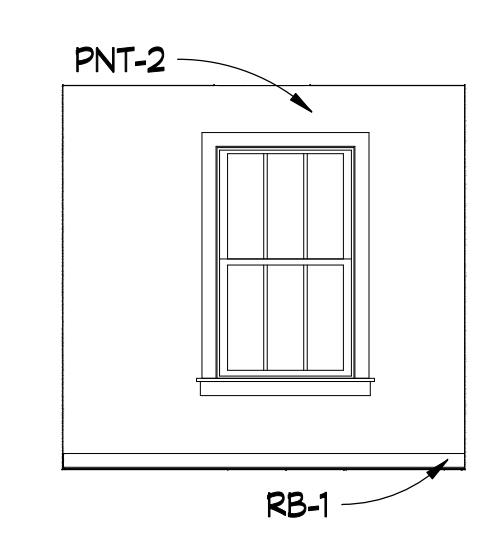


11 OFFICE, TYP.
SCALE: 1/4" = 1'-0"

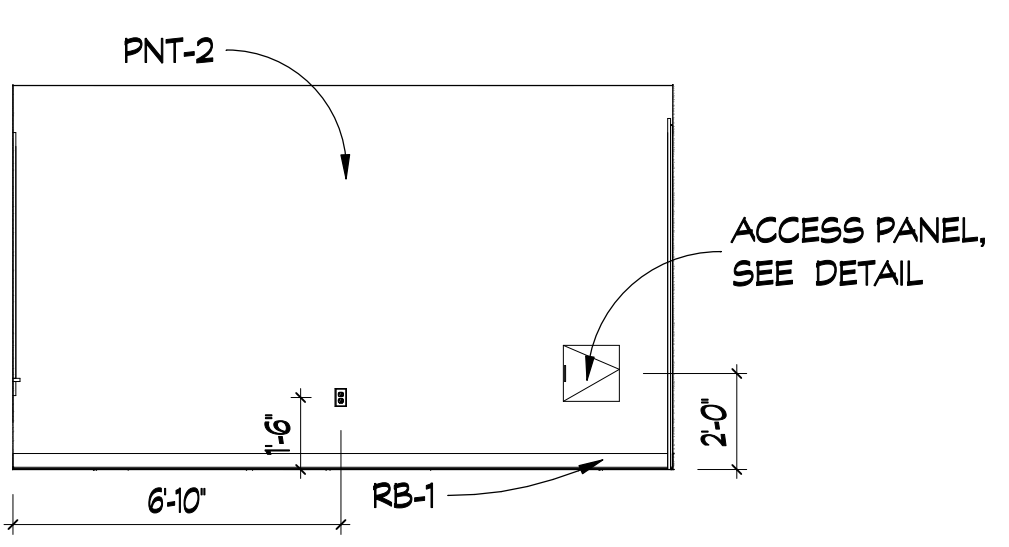


12 OFFICE, TYP.
SCALE: 1/4" = 1'-0"

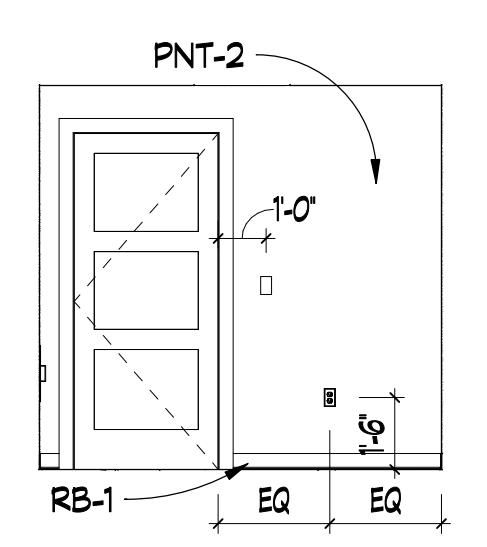


13 OFFICE, TYP.
SCALE: 1/4" = 1'-0"

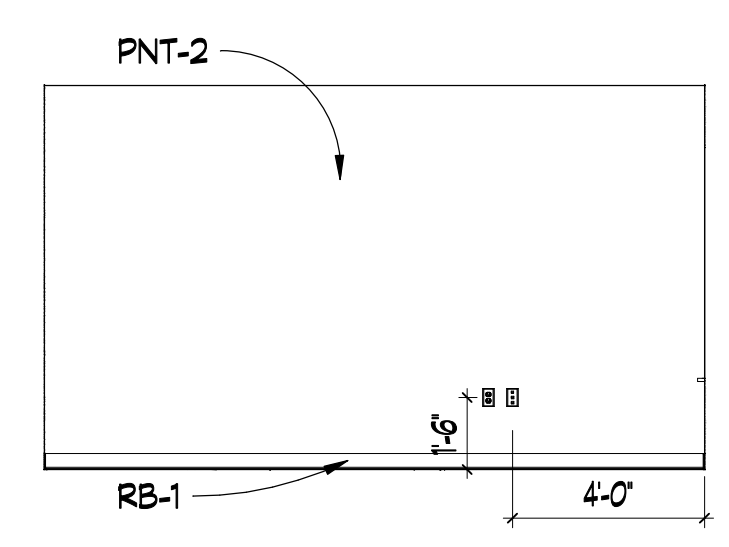


14 OFFICE, TYP.
SCALE: 1/4" = 1'-0"

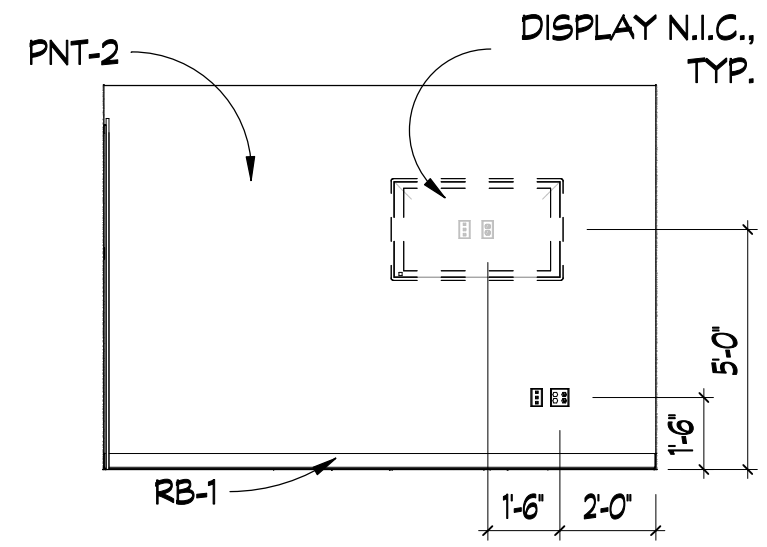


15 EXECUTIVE DIRECTOR
SCALE: 1/4" = 1'-0"

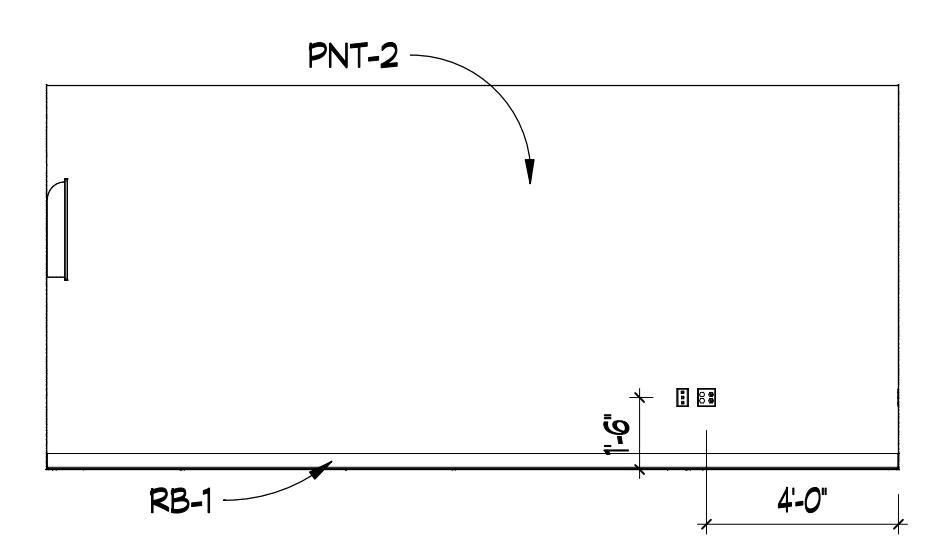


16 EXECUTIVE DIRECTOR
SCALE: 1/4" = 1'-0"

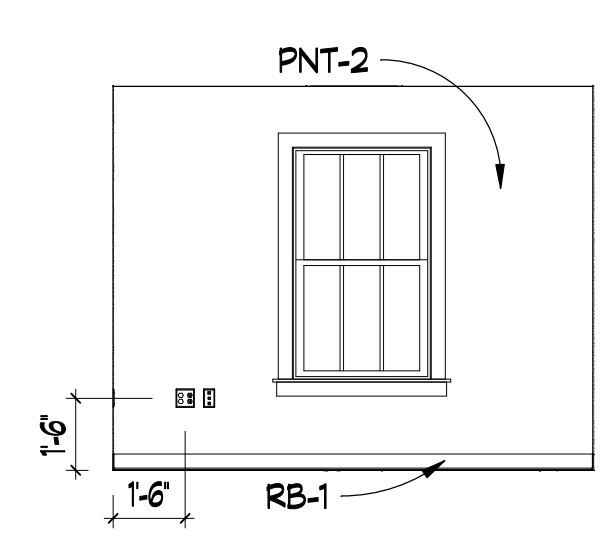


17 EXECUTIVE DIRECTOR
SCALE: 1/4" = 1'-0"

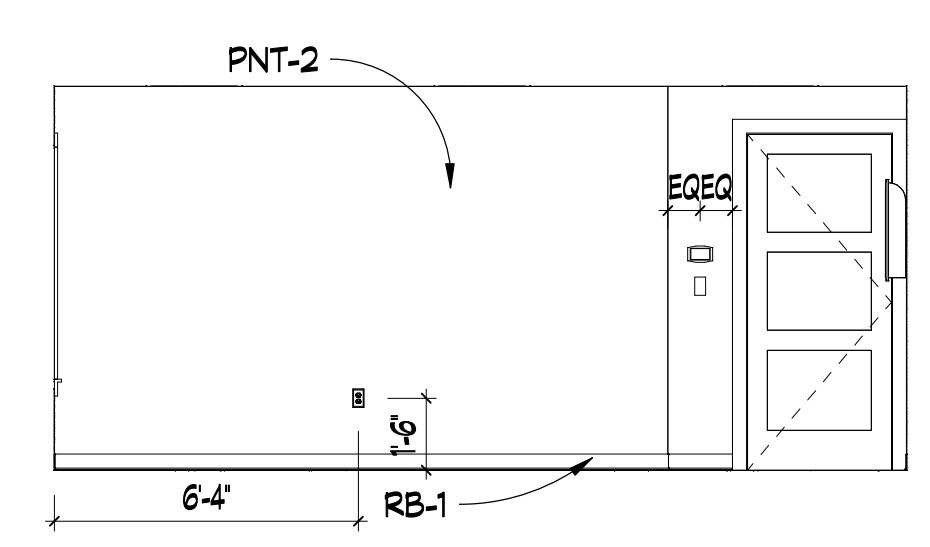


18 EXECUTIVE DIRECTOR
SCALE: 1/4" = 1'-0"

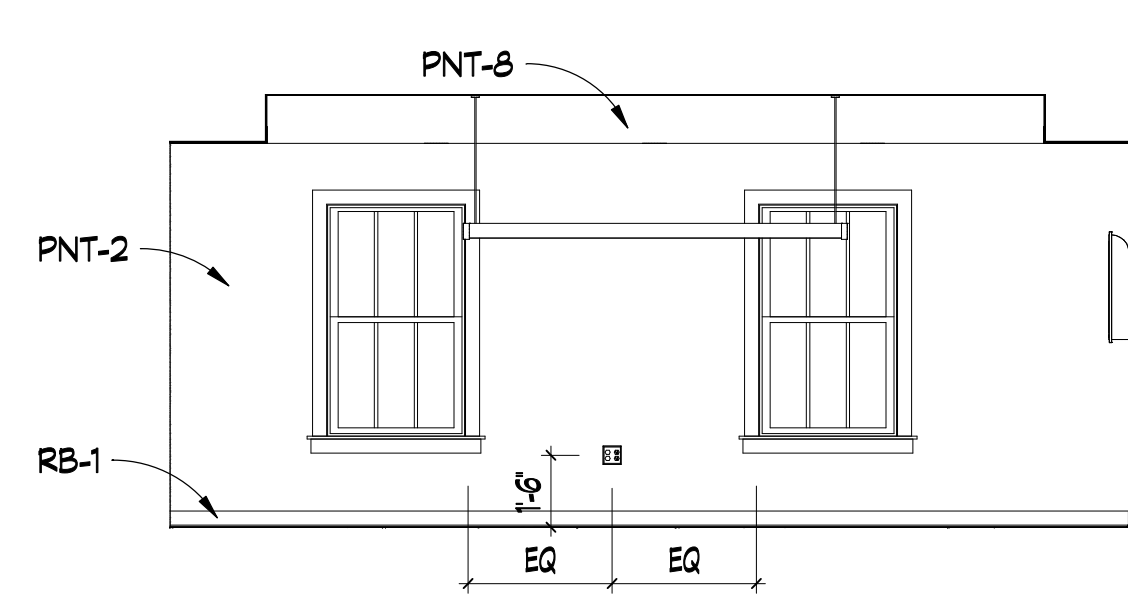


19 CONFERENCE ROOM
SCALE: 1/4" = 1'-0"

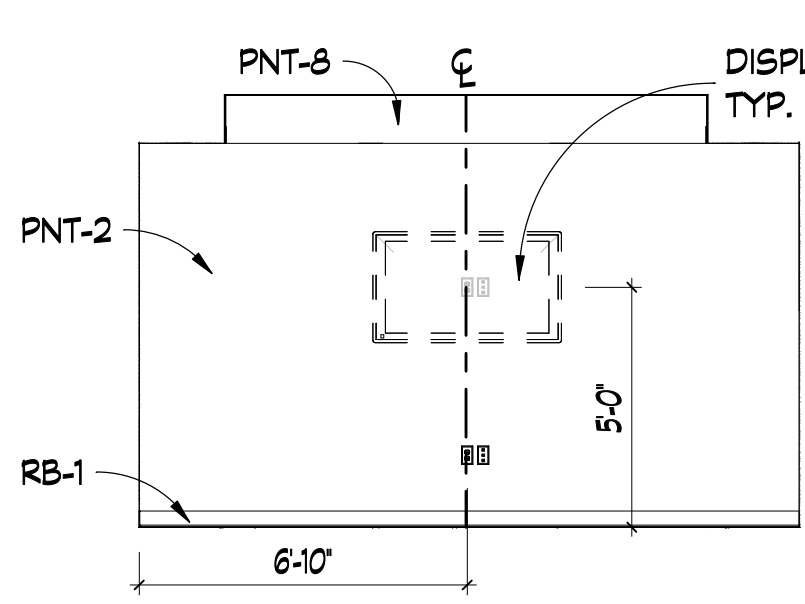

20 CONFERENCE ROOM
SCALE: 1/4" = 1'-0"


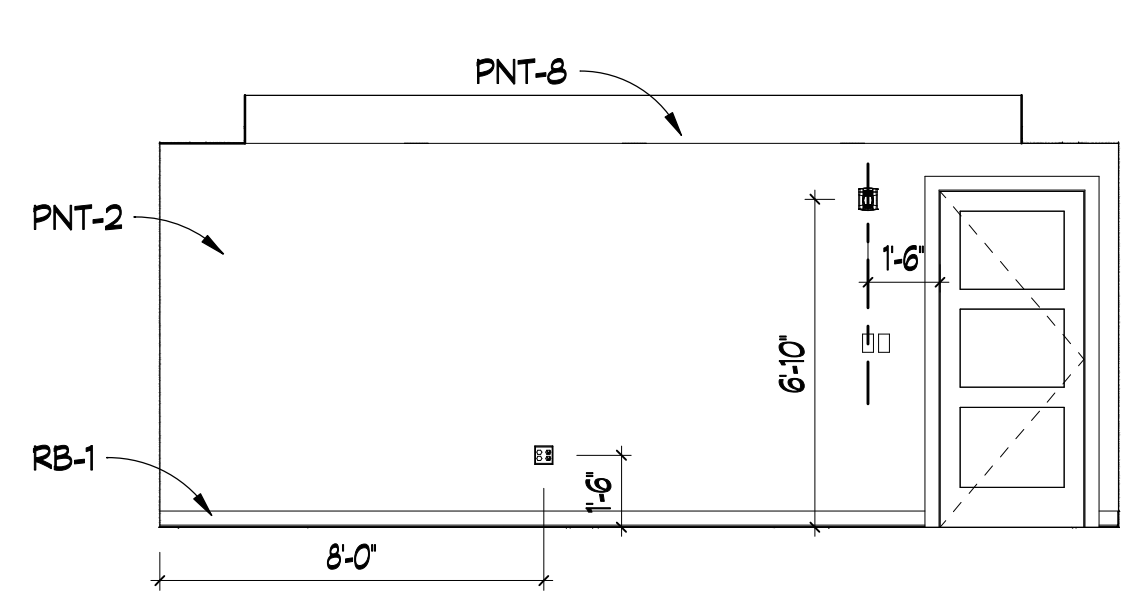


21 CONFERENCE ROOM
SCALE: 1/4" = 1'-0"

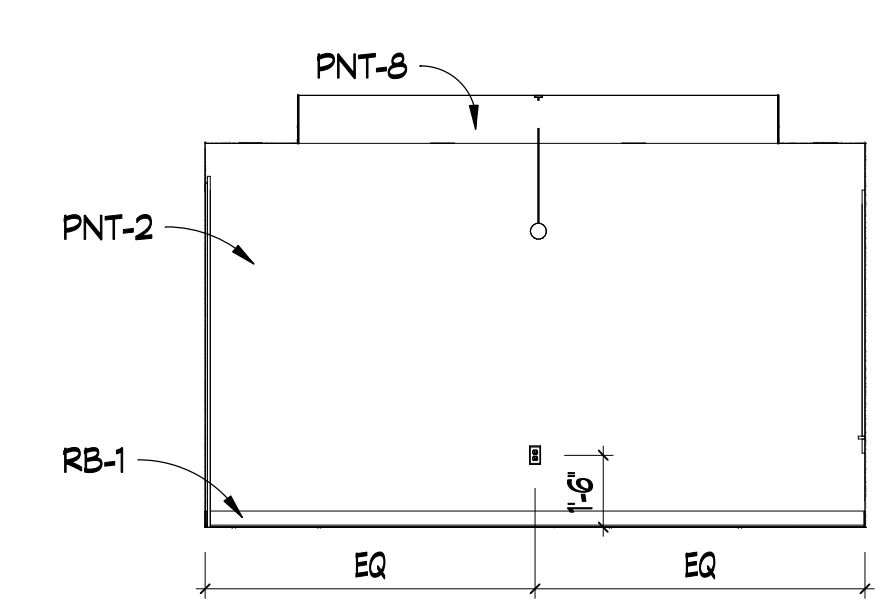

22 CONFERENCE ROOM
SCALE: 1/4" = 1'-0"

REVISIONS			
REV #	DATE	APPROV	REVISION
1	2/16/22	EA	ISSUE FOR PERMIT

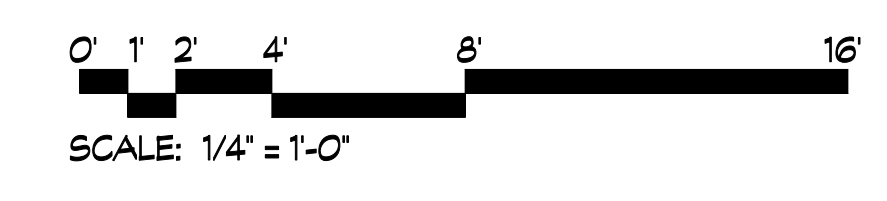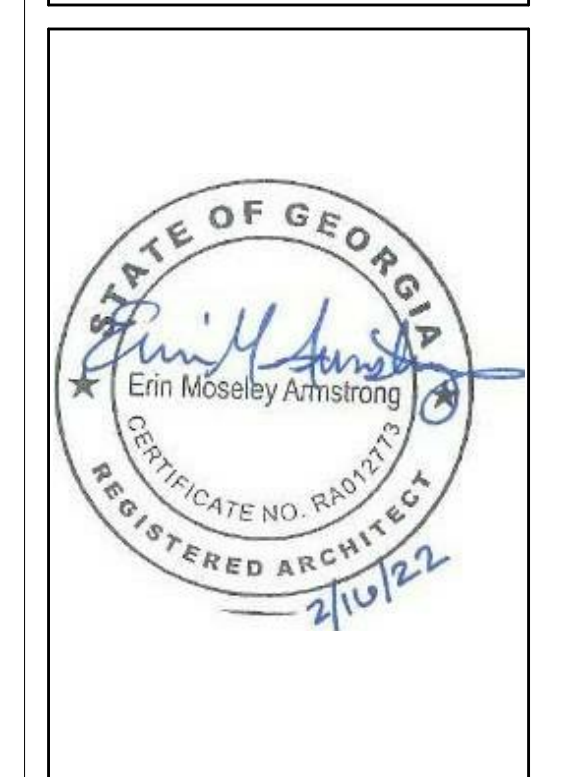


PROJECT TITLE:
**JUD C
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CENTER**

REVISIONS			
REV #	DATE	APPROVED BY	REVISION
1	2/16/22	EA	ISSUE FOR PERMIT





DA PROJECT NUMBER & NAME:
1893
DRAWING TITLE:
**MILLWORK
PLAN**

DRAWING NO:
A850

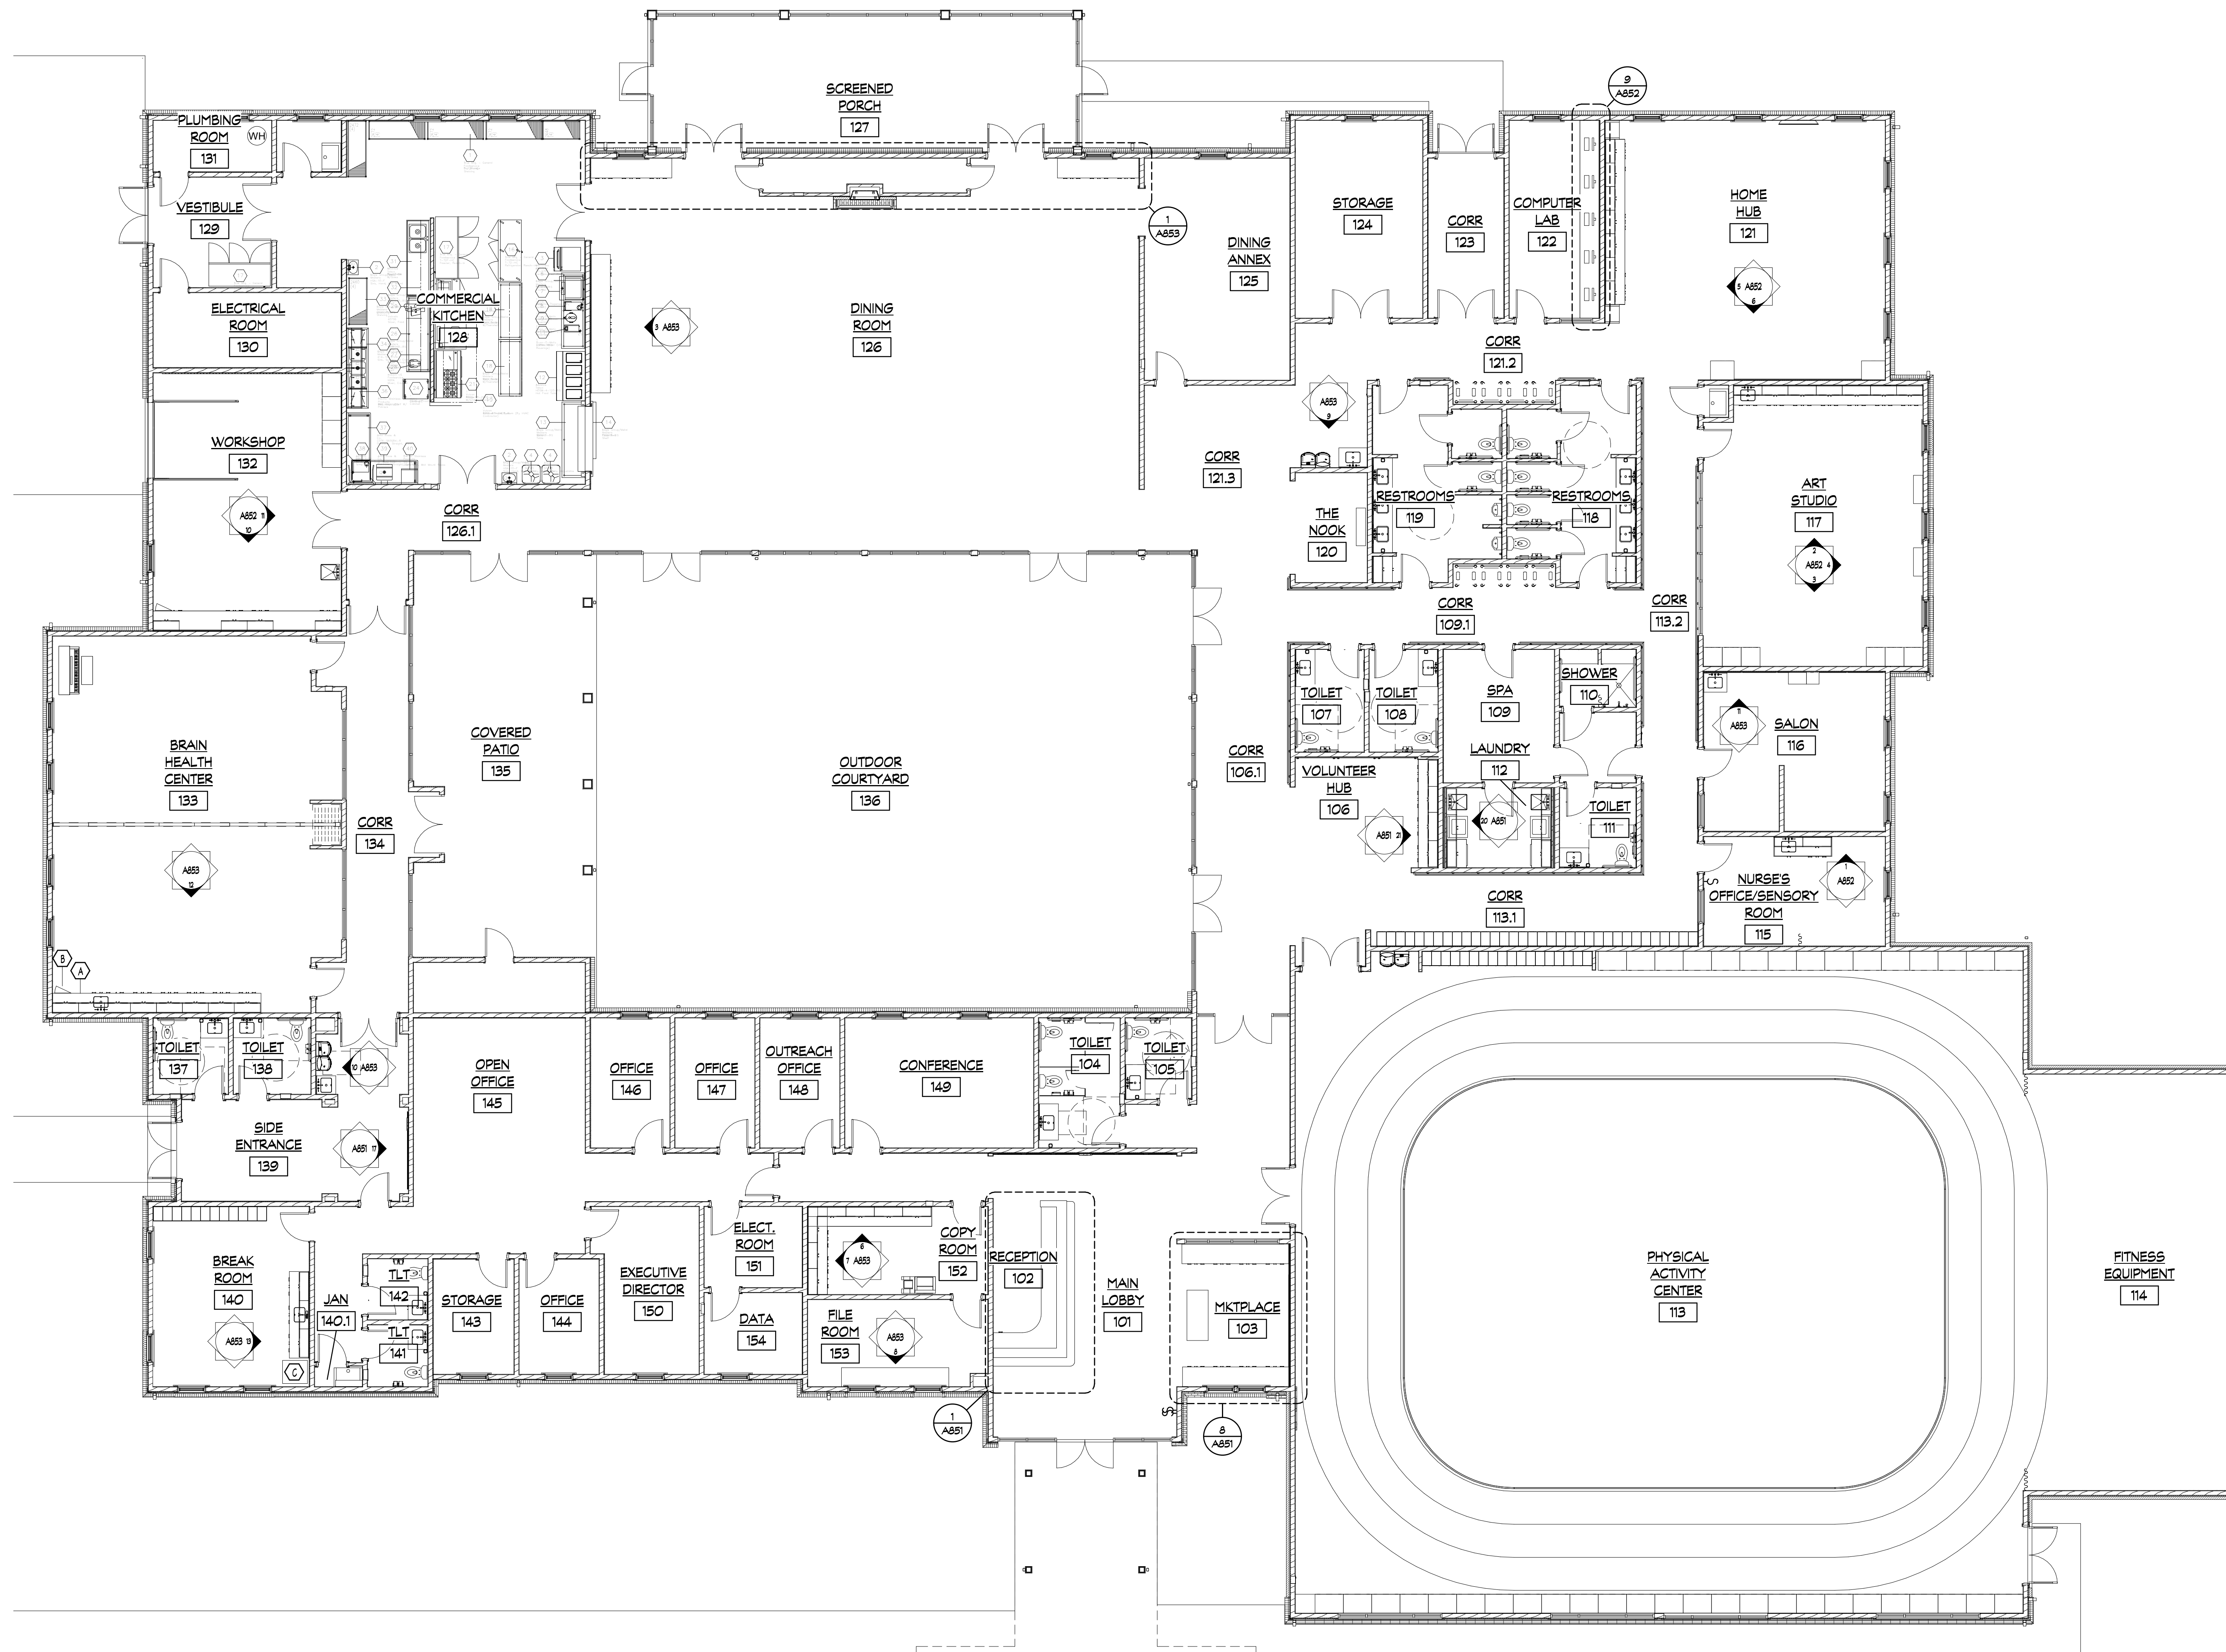


1 MILLWORK PLAN
SCALE: 1/8" = 1'-0"

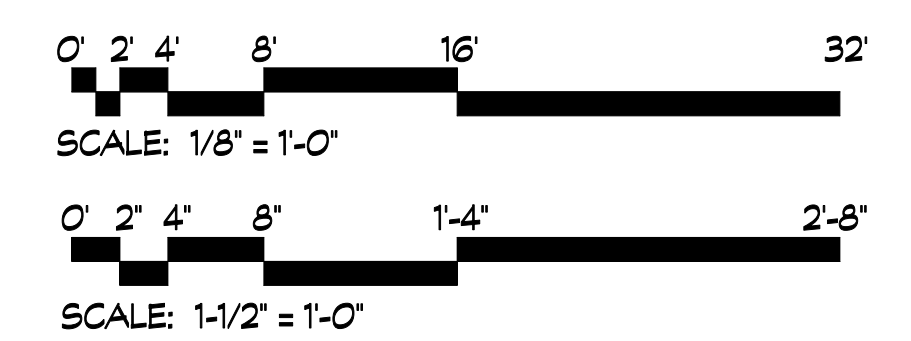

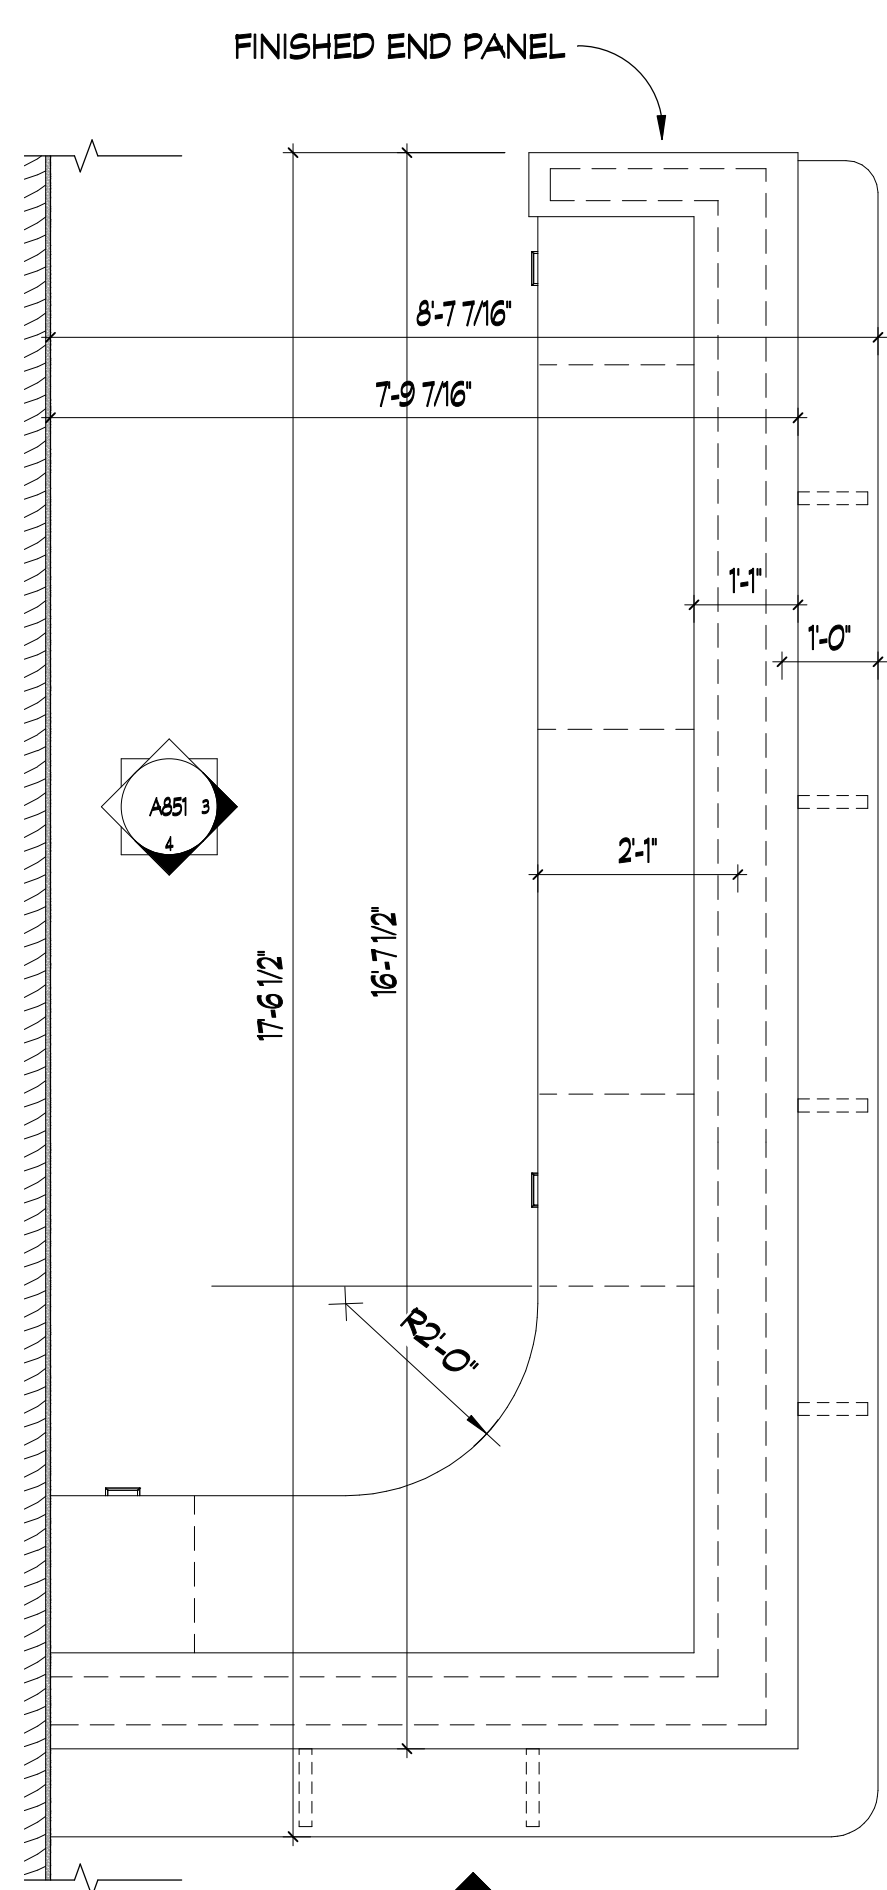


1 RECEPTION DESK PLAN
SCALE: 1/2" = 1'-0"

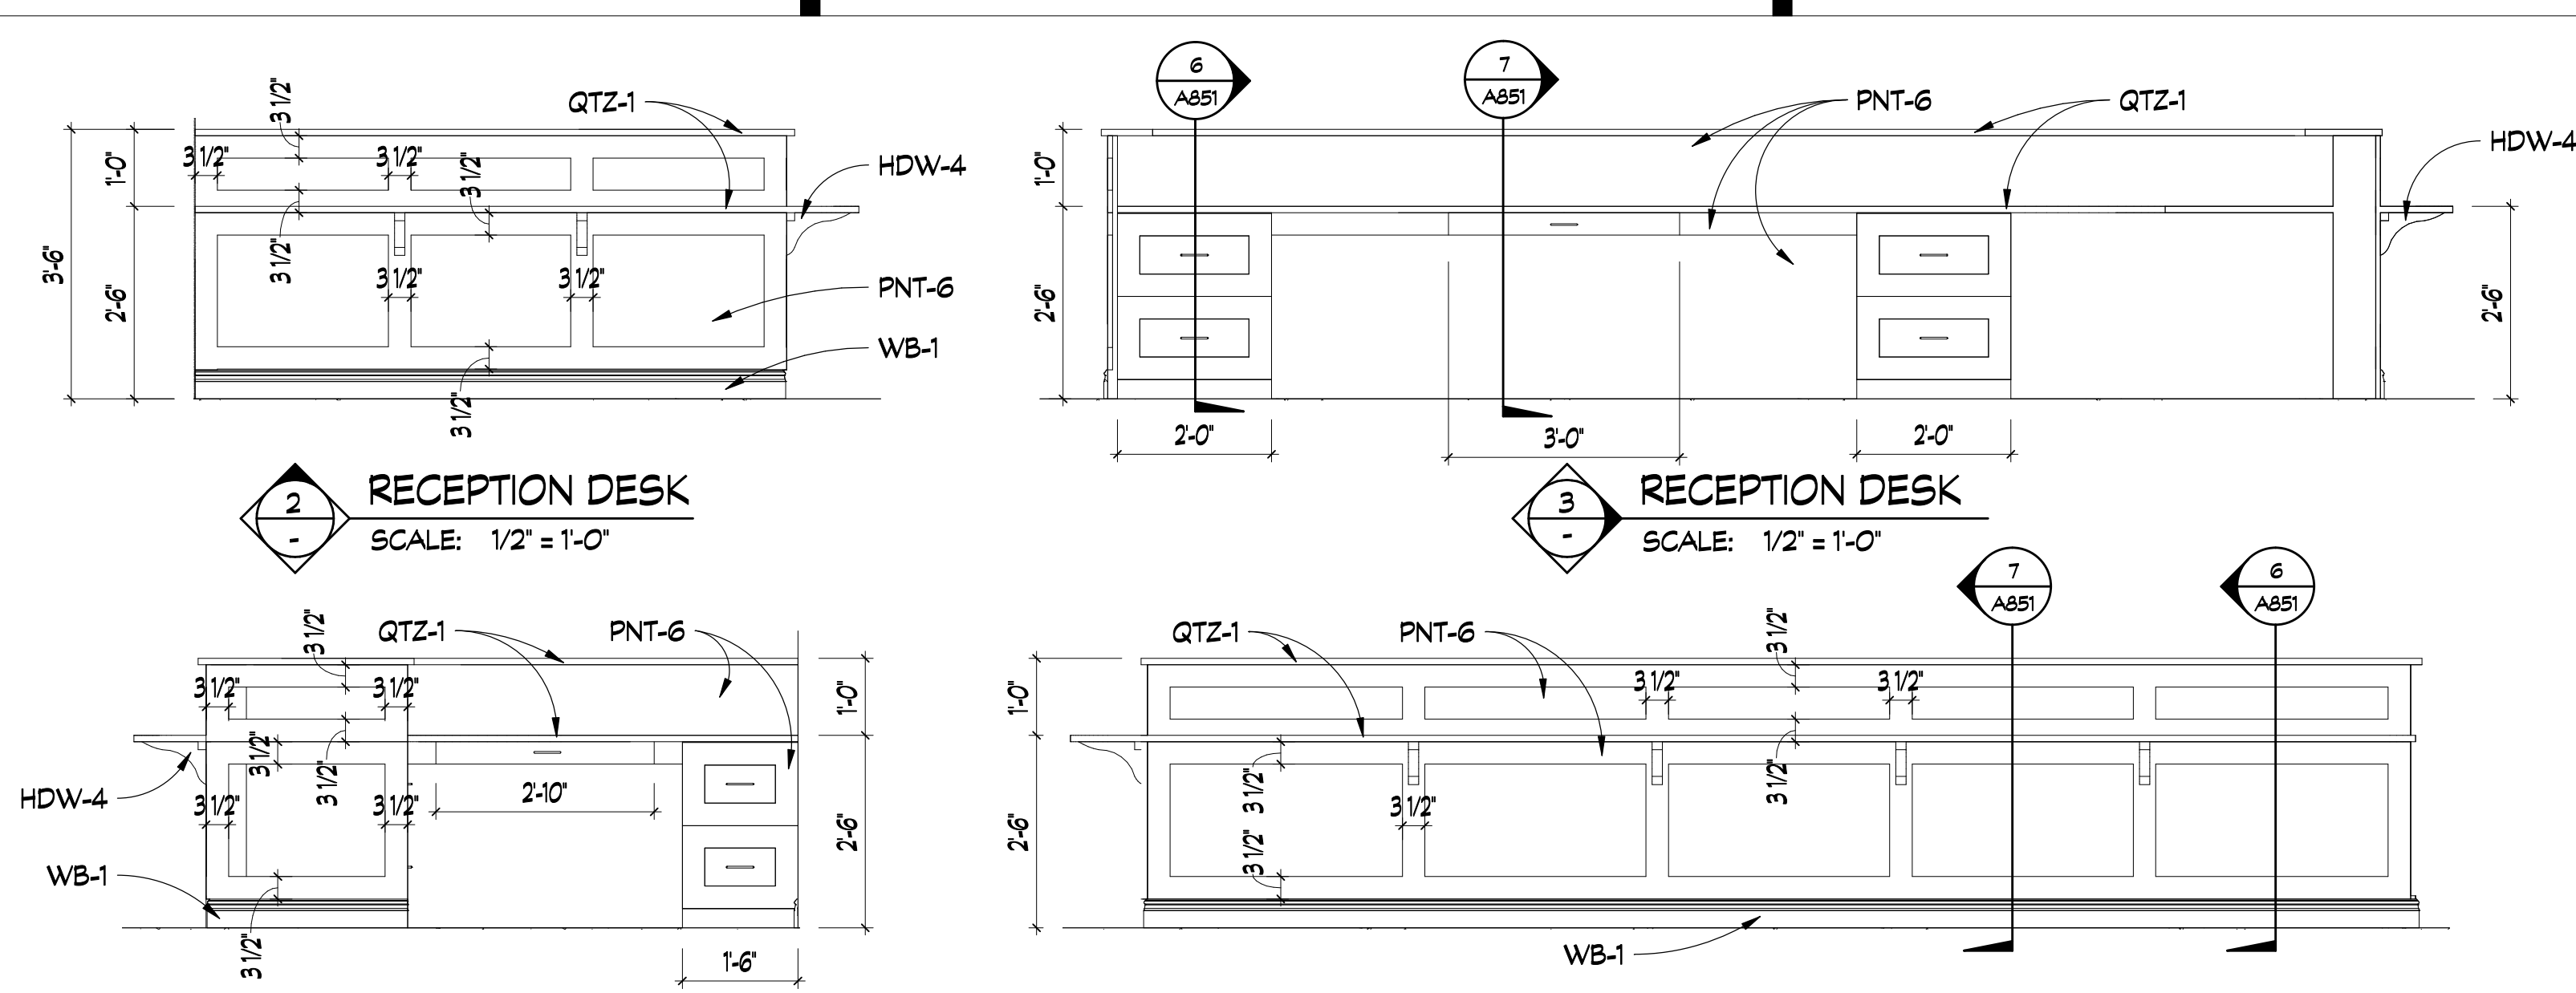


2 RECEPTION DESK
SCALE: 1/2" = 1'-0"


3 RECEPTION DESK
SCALE: 1/2" = 1'-0"

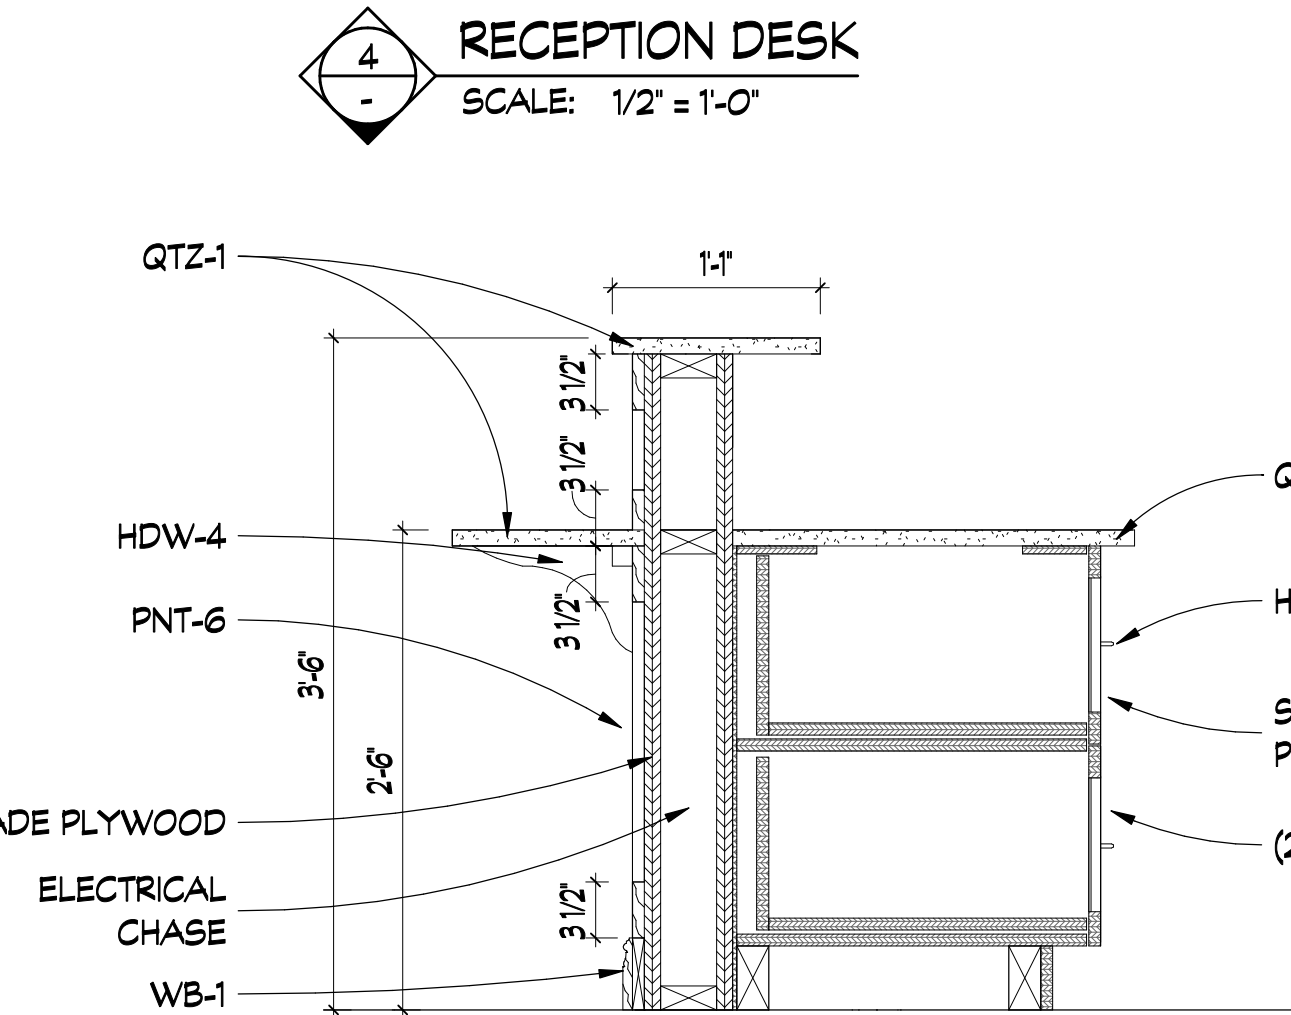


4 RECEPTION DESK
SCALE: 1/2" = 1'-0"

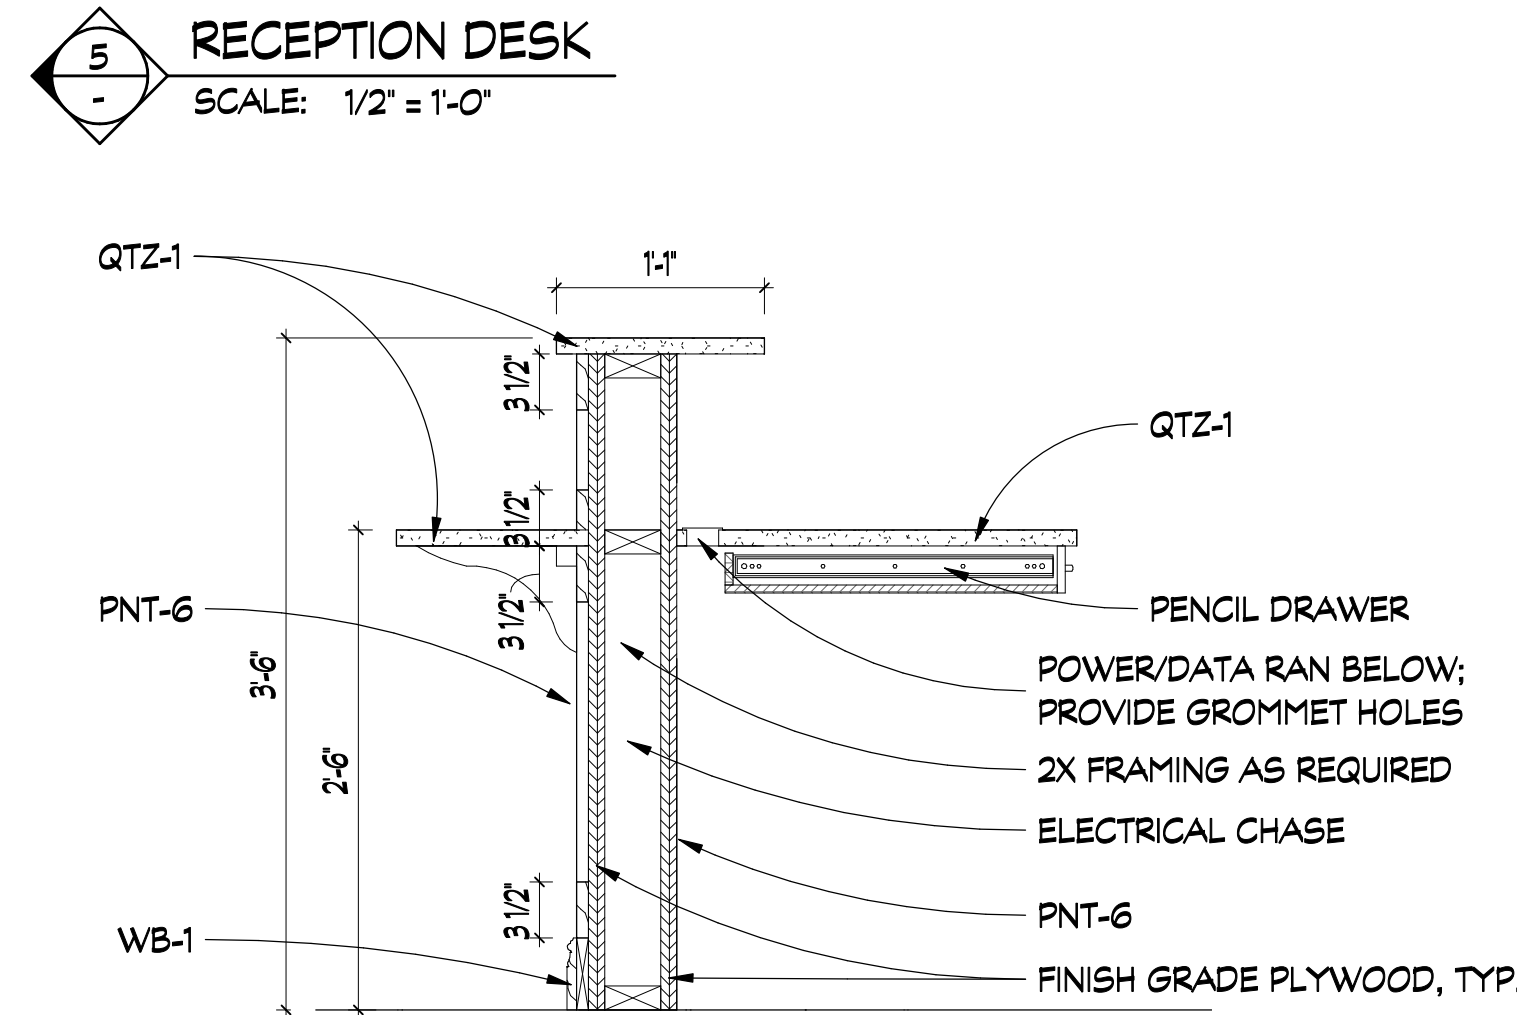


5 RECEPTION DESK
SCALE: 1/2" = 1'-0"

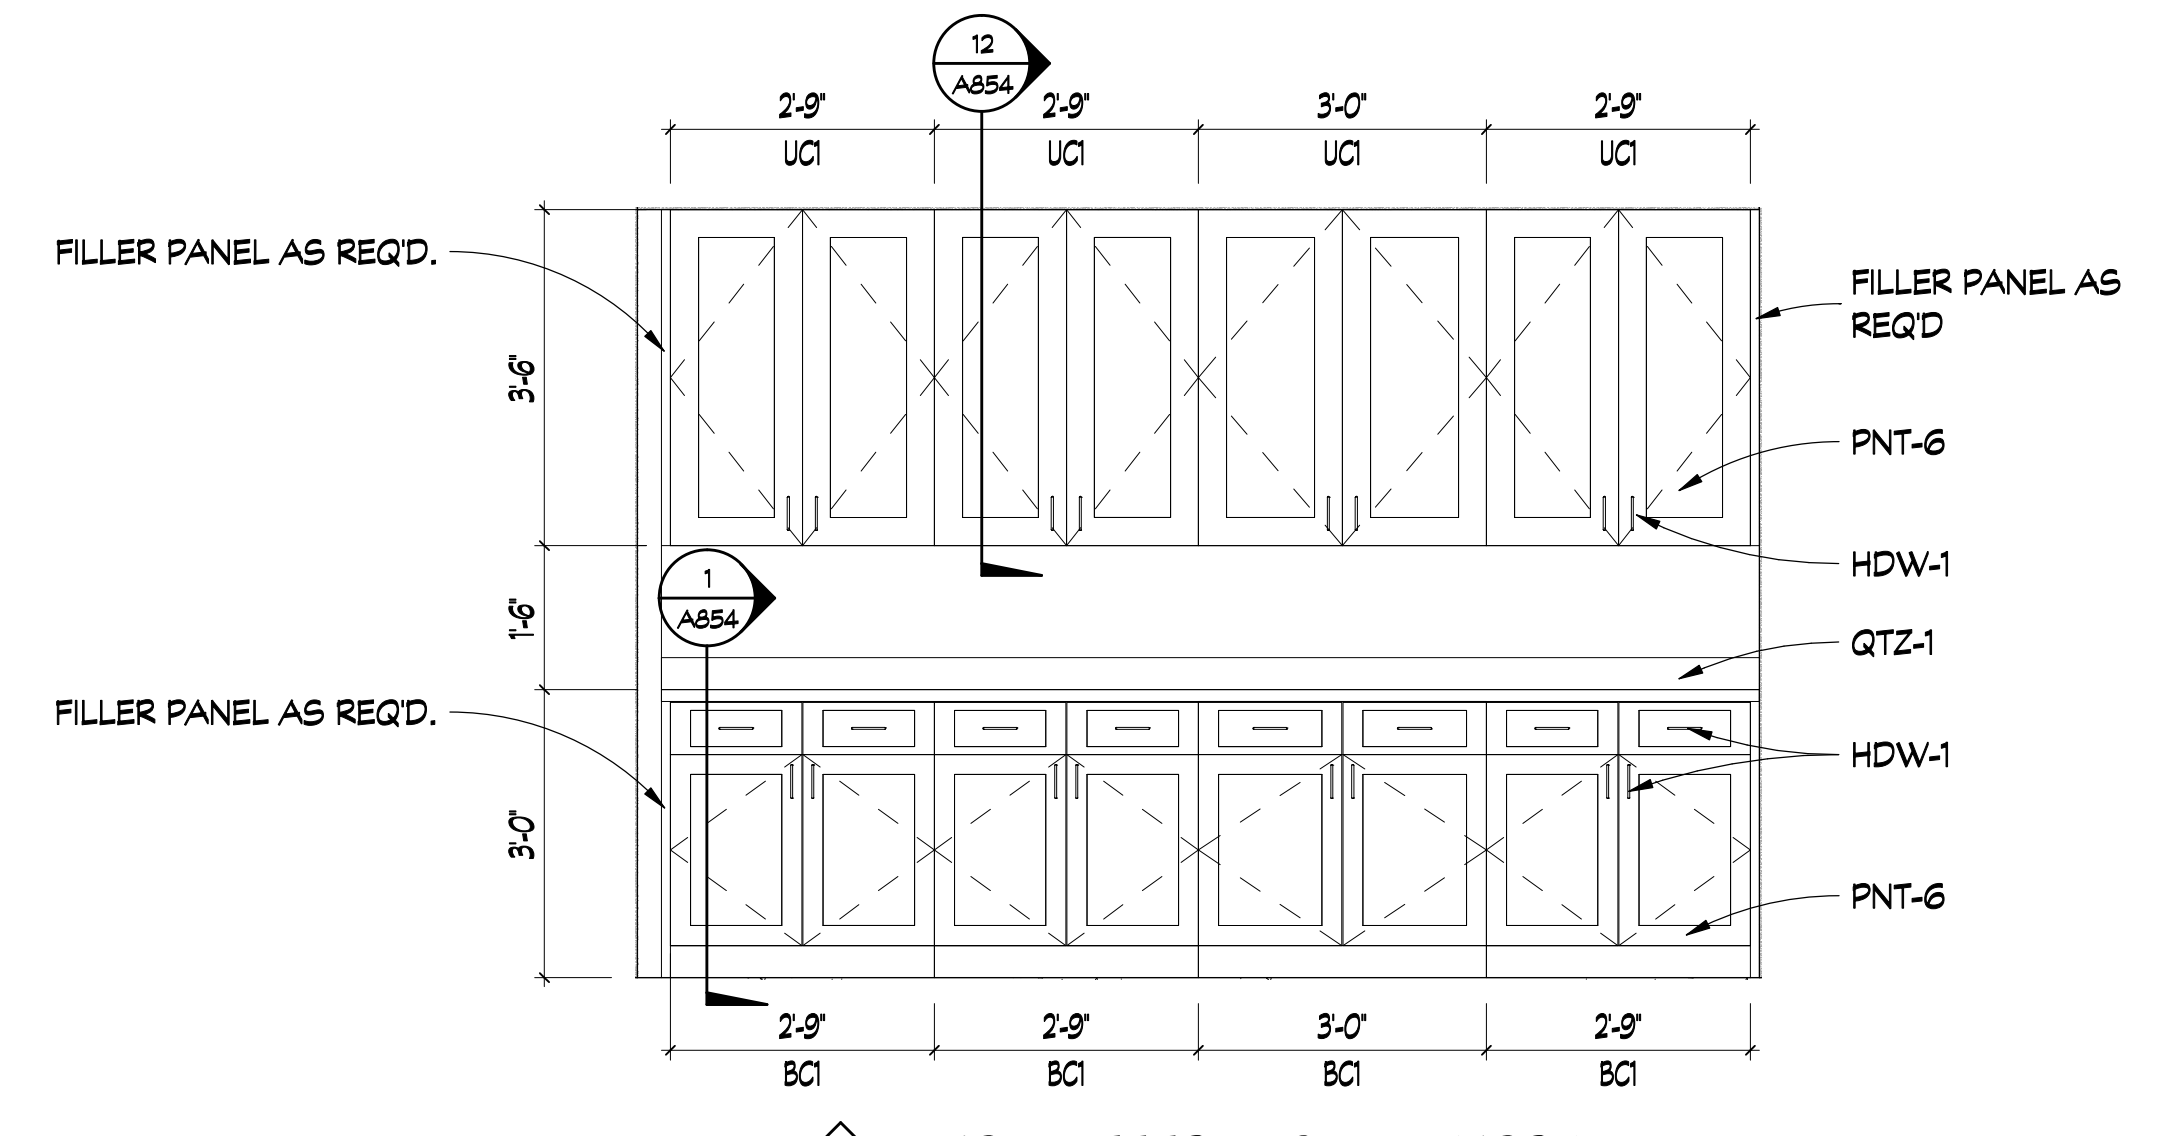


21 VOLUNTEER HUB MILLWORK
SCALE: 1/2" = 1'-0"

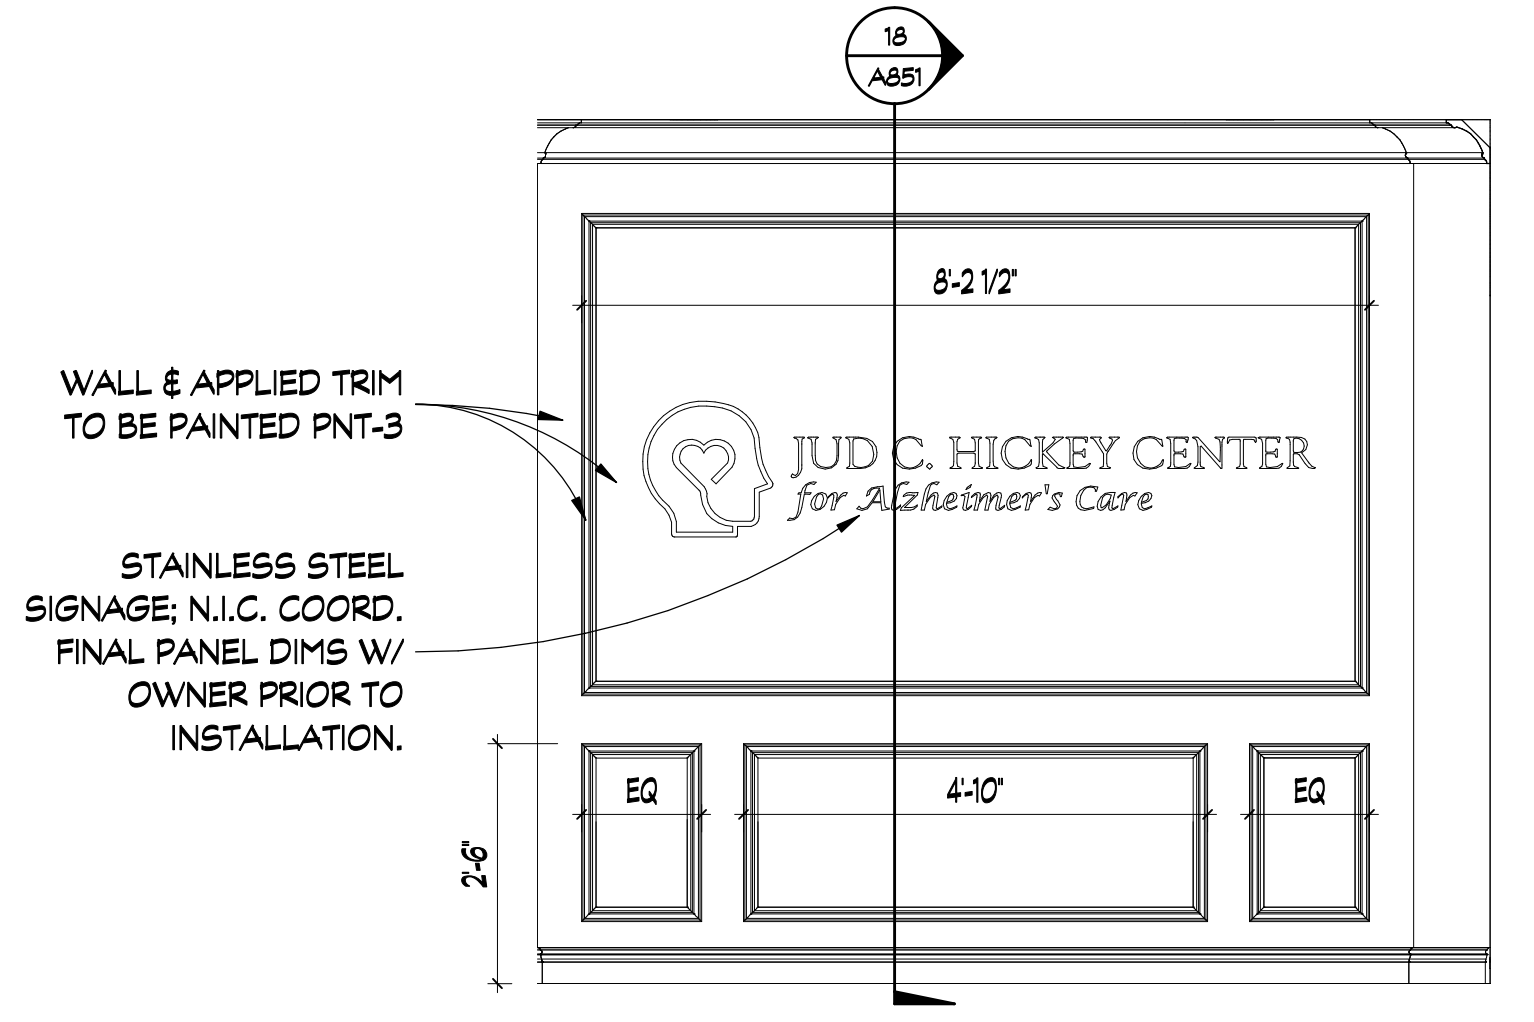


17 SIDE ENTRANCE PANELING
SCALE: 1/2" = 1'-0"

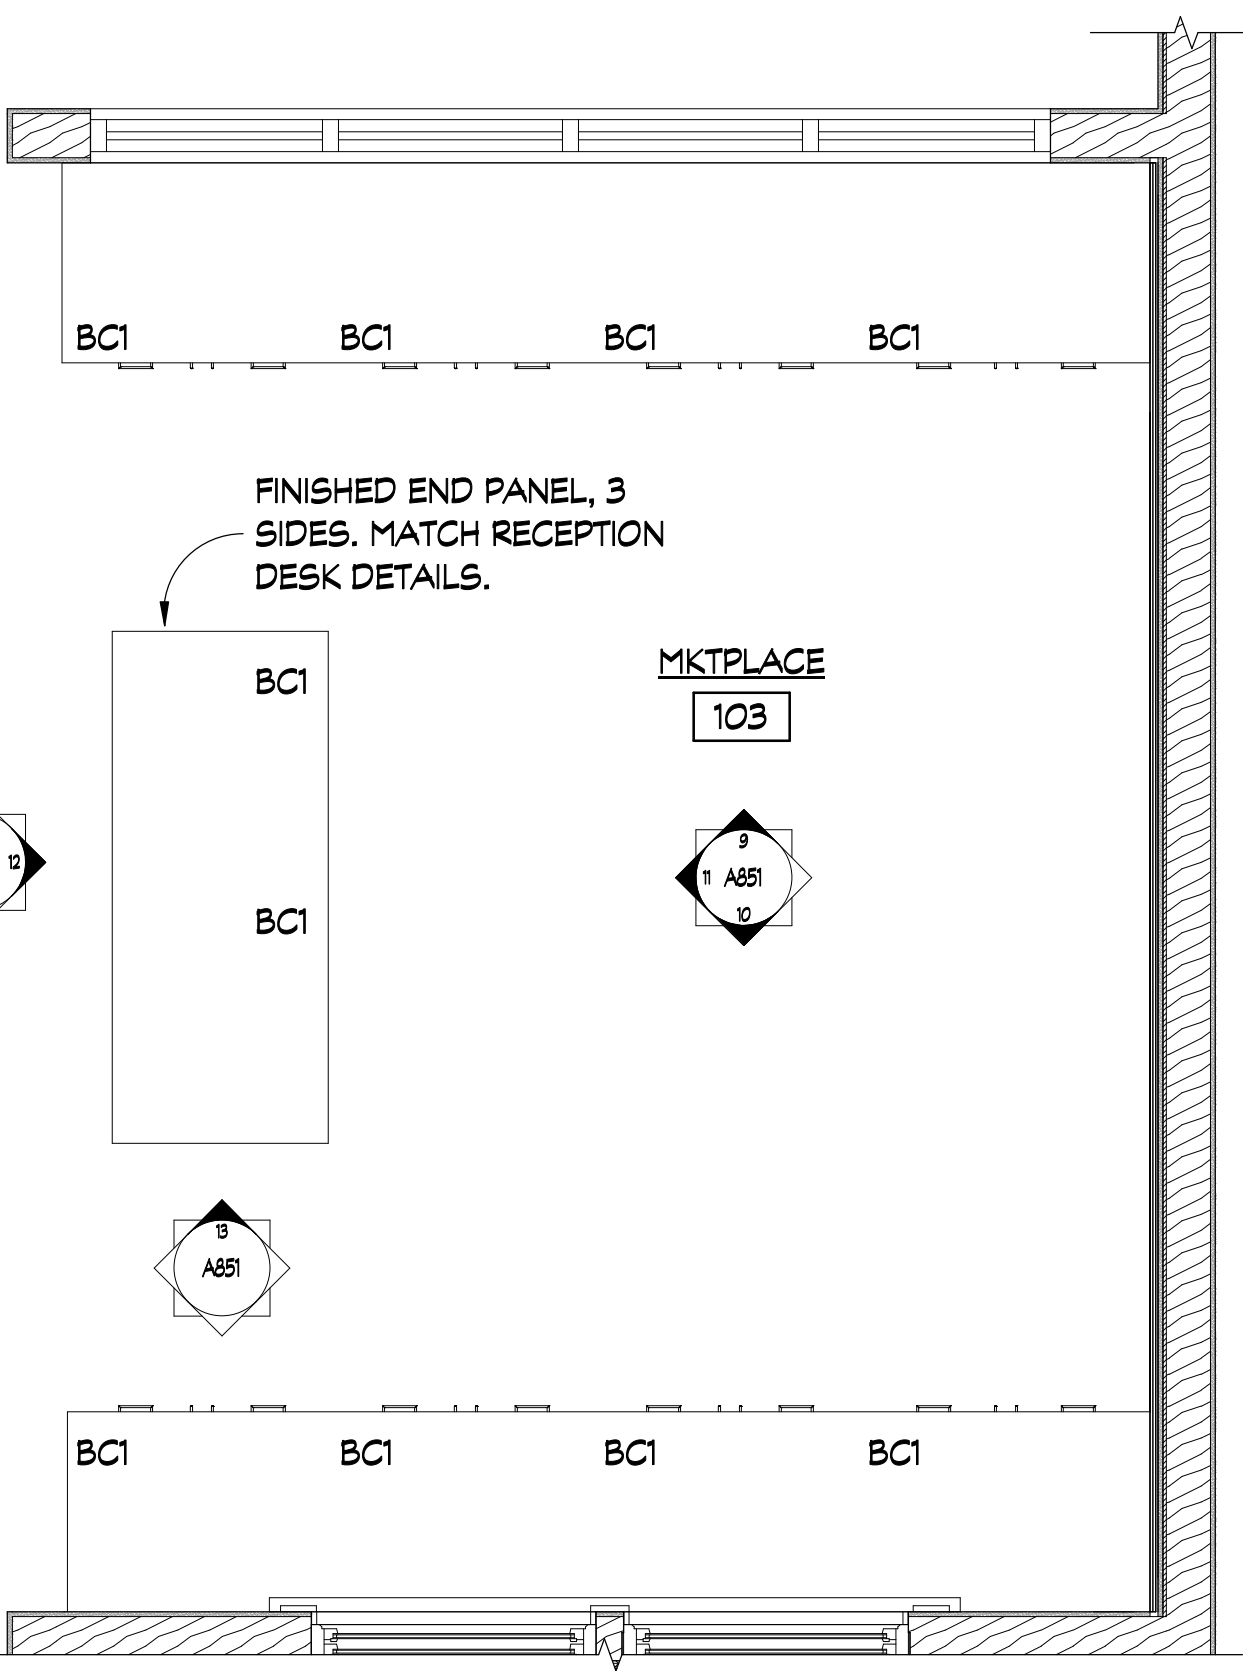


8 MARKETPLACE MILLWORK PLAN
SCALE: 1/2" = 1'-0"

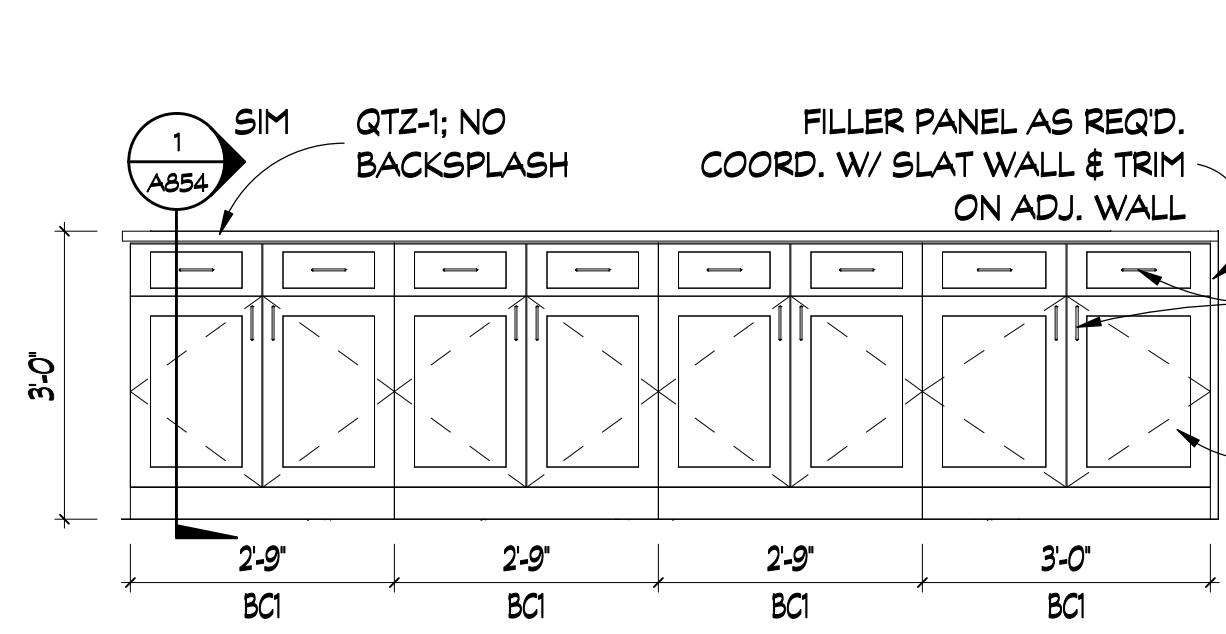


9 MARKETPLACE MILLWORK
SCALE: 1/2" = 1'-0"

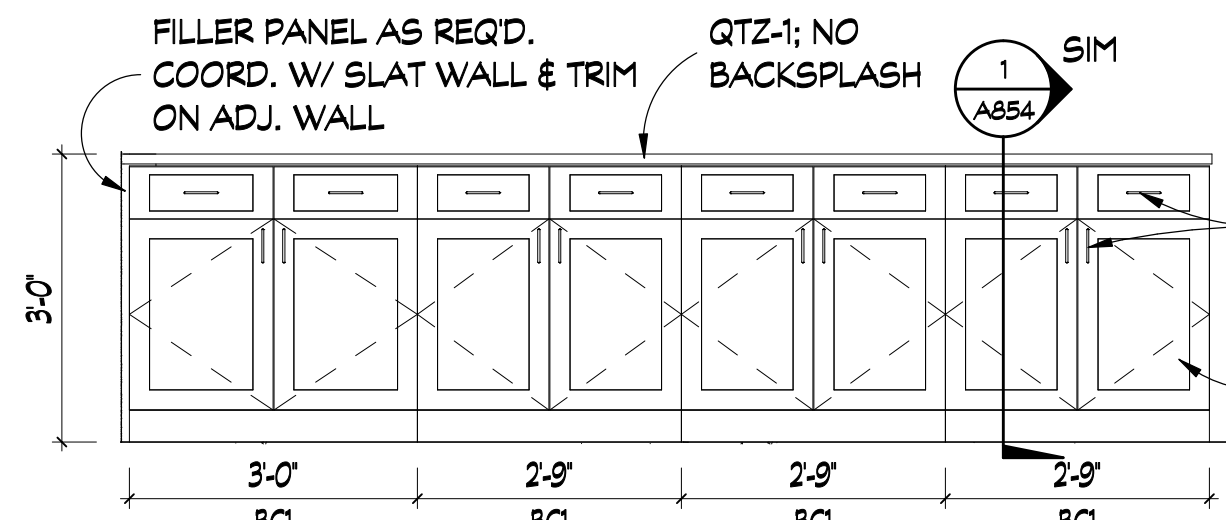


10 MARKETPLACE MILLWORK
SCALE: 1/2" = 1'-0"

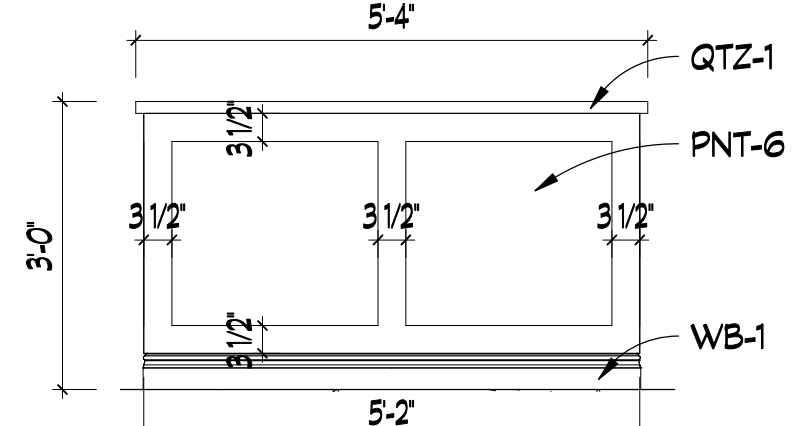


12 MARKETPLACE ISLAND
SCALE: 1/2" = 1'-0"

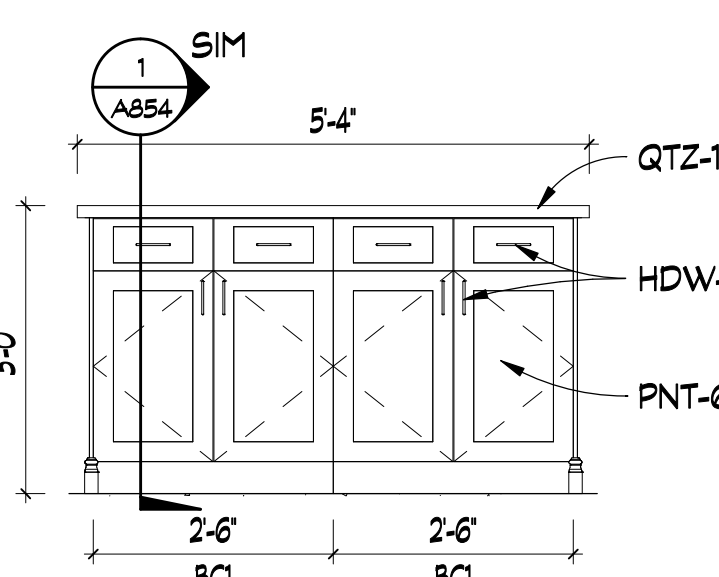


11 MARKETPLACE ISLAND
SCALE: 1/2" = 1'-0"

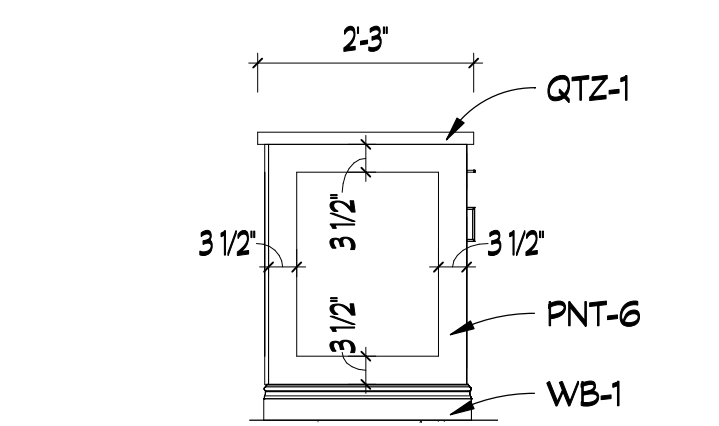


13 MARKETPLACE ISLAND
SCALE: 1/2" = 1'-0"

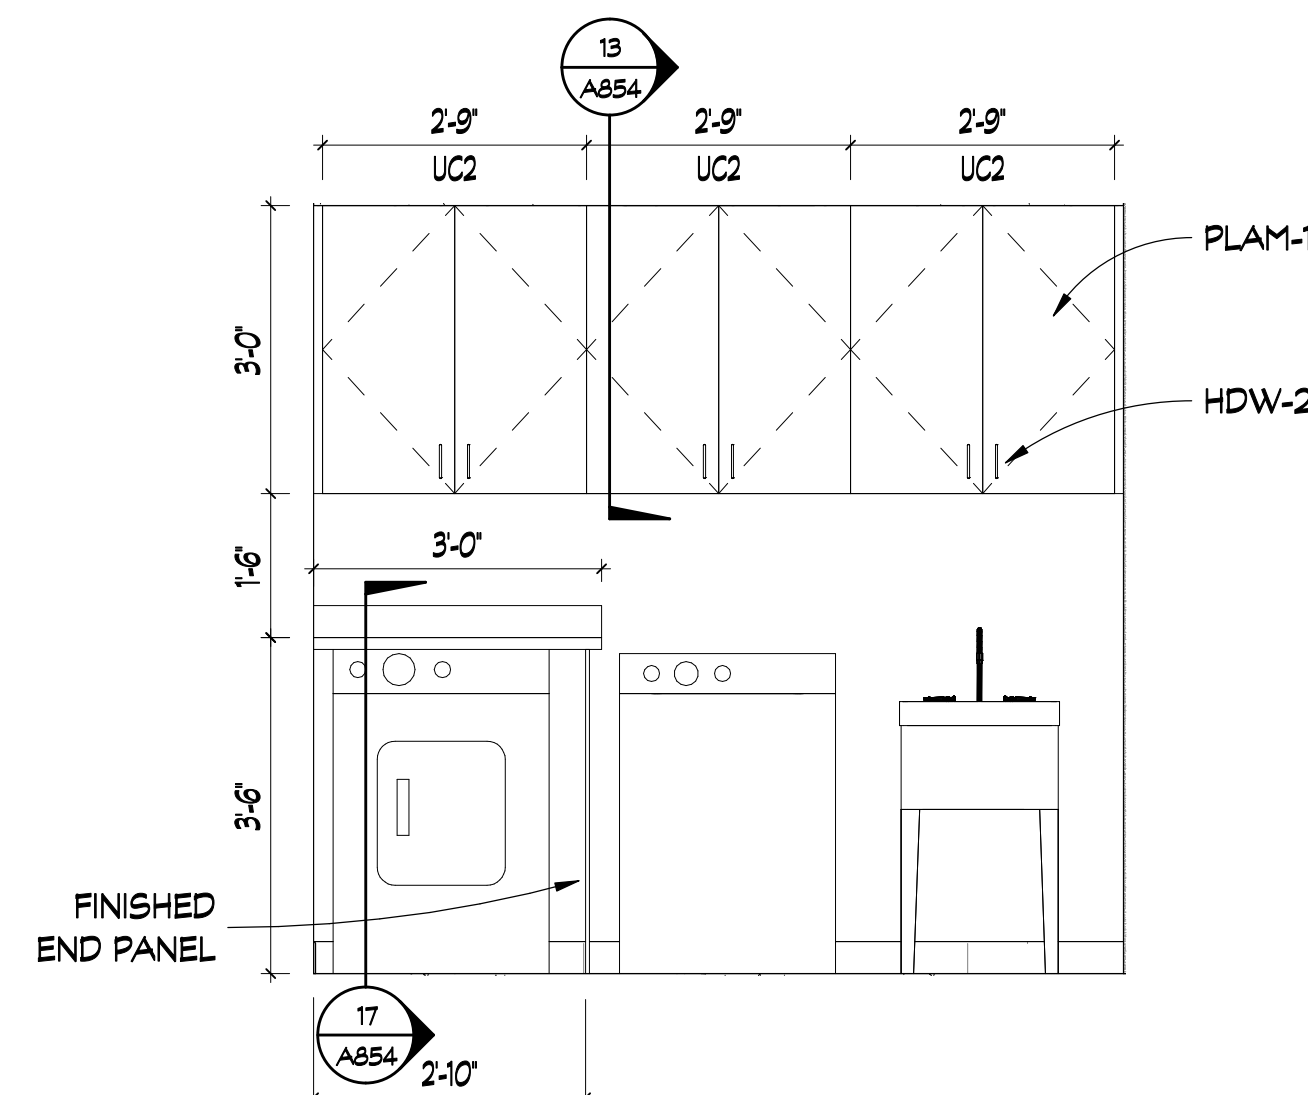


20 LAUNDRY MILLWORK
SCALE: 1/2" = 1'-0"

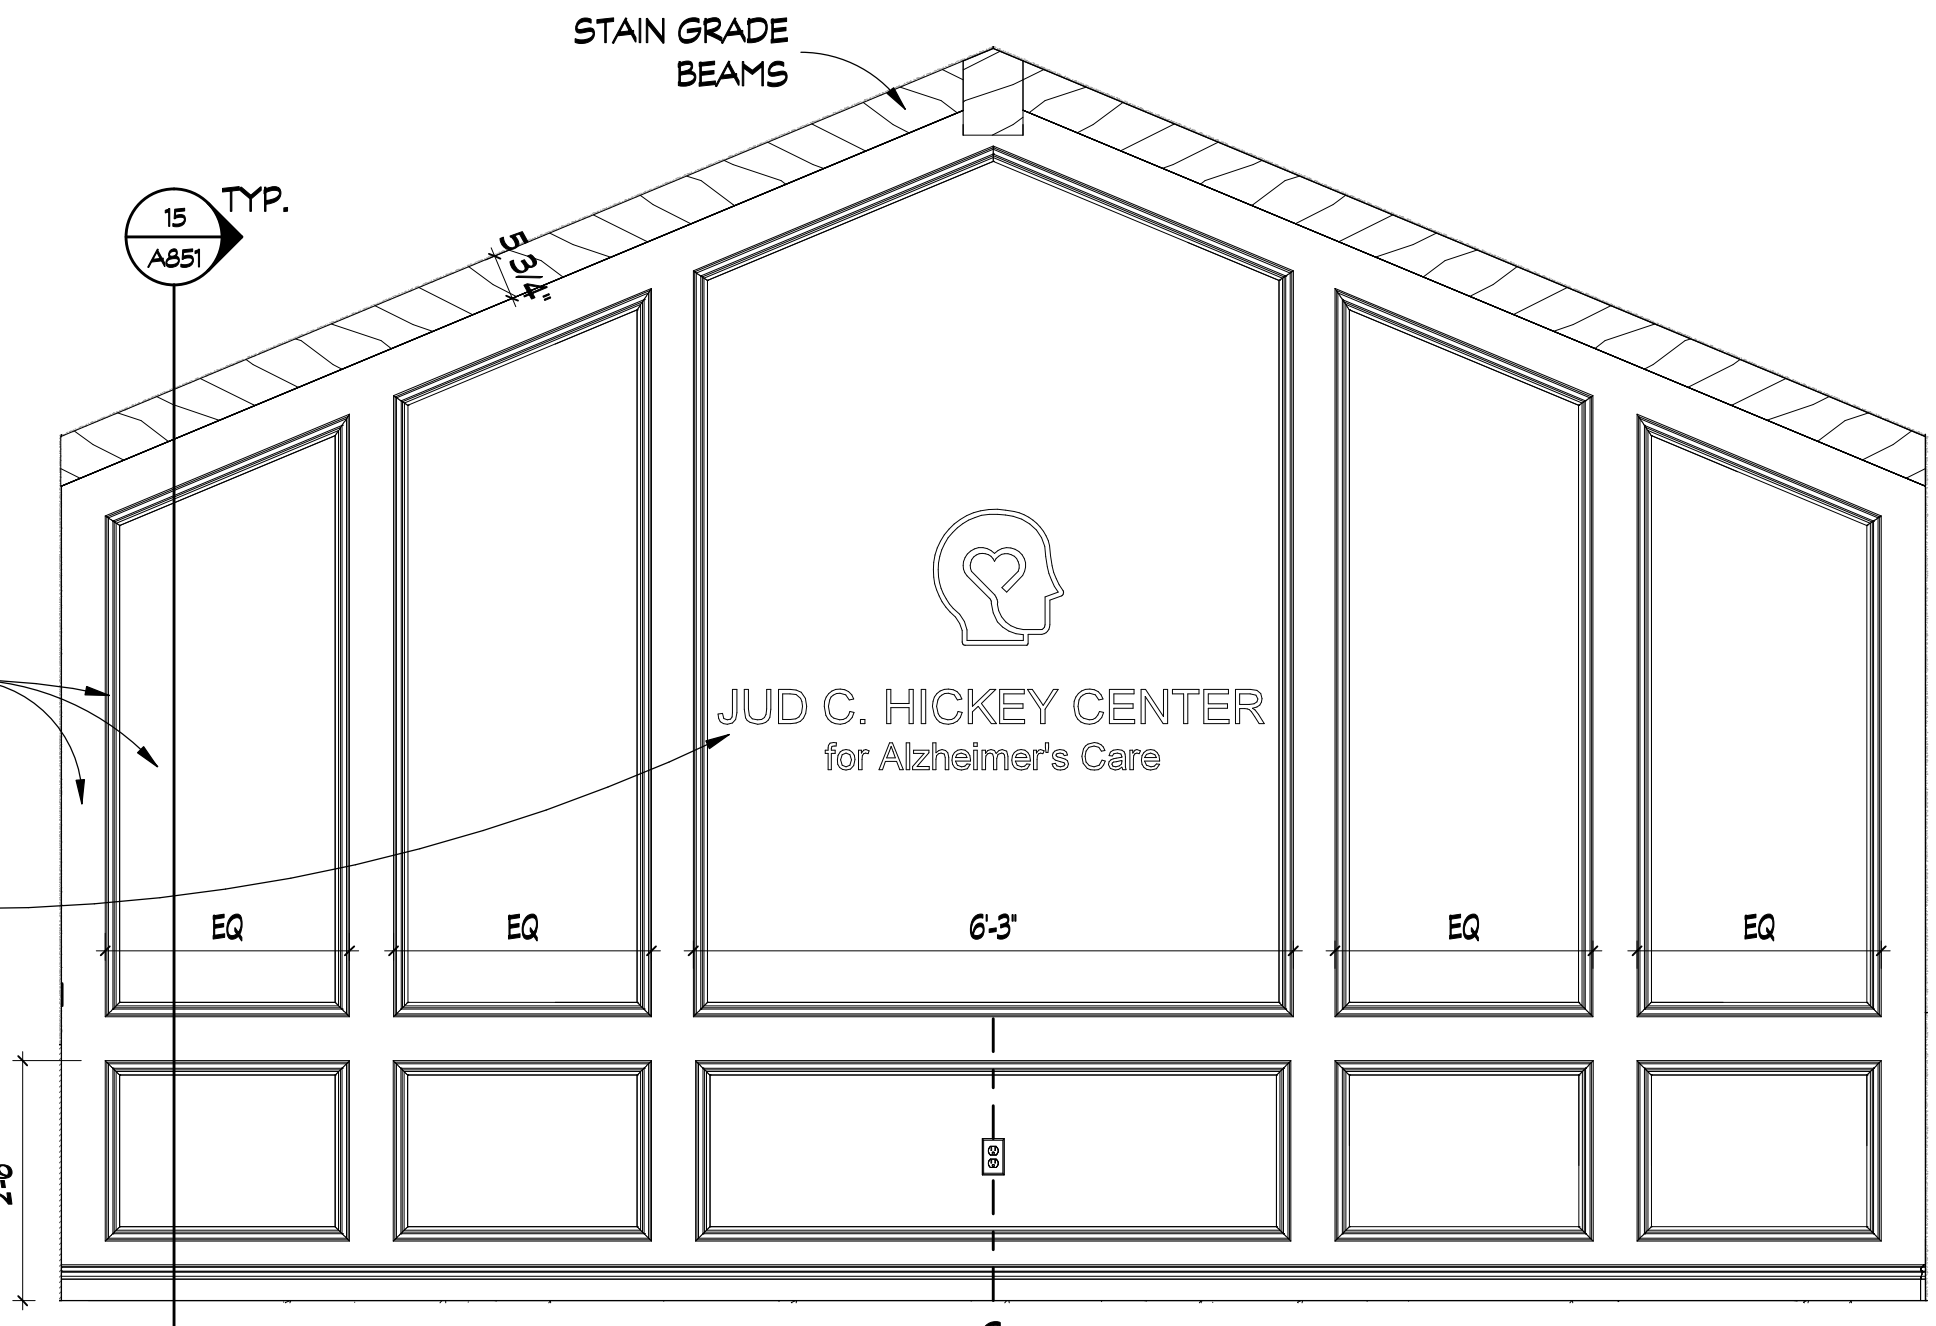

14 RECEPTION WALL PANELING
SCALE: 1/2" = 1'-0"

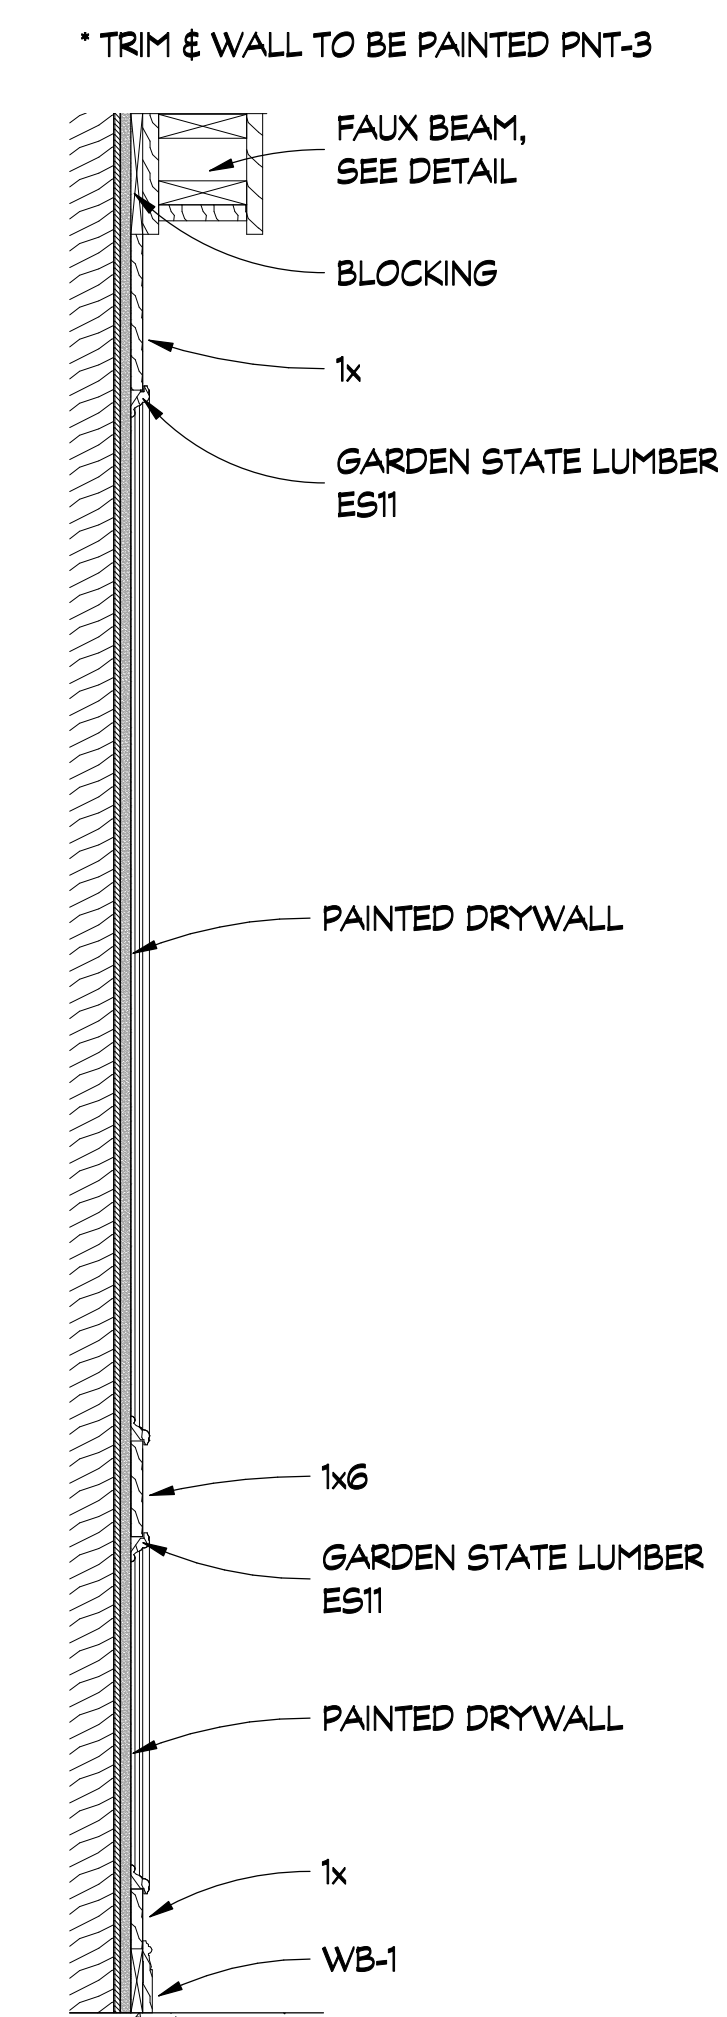

15 RECEPTION WALL PANELING DETAIL
SCALE: 1" = 1'-0"

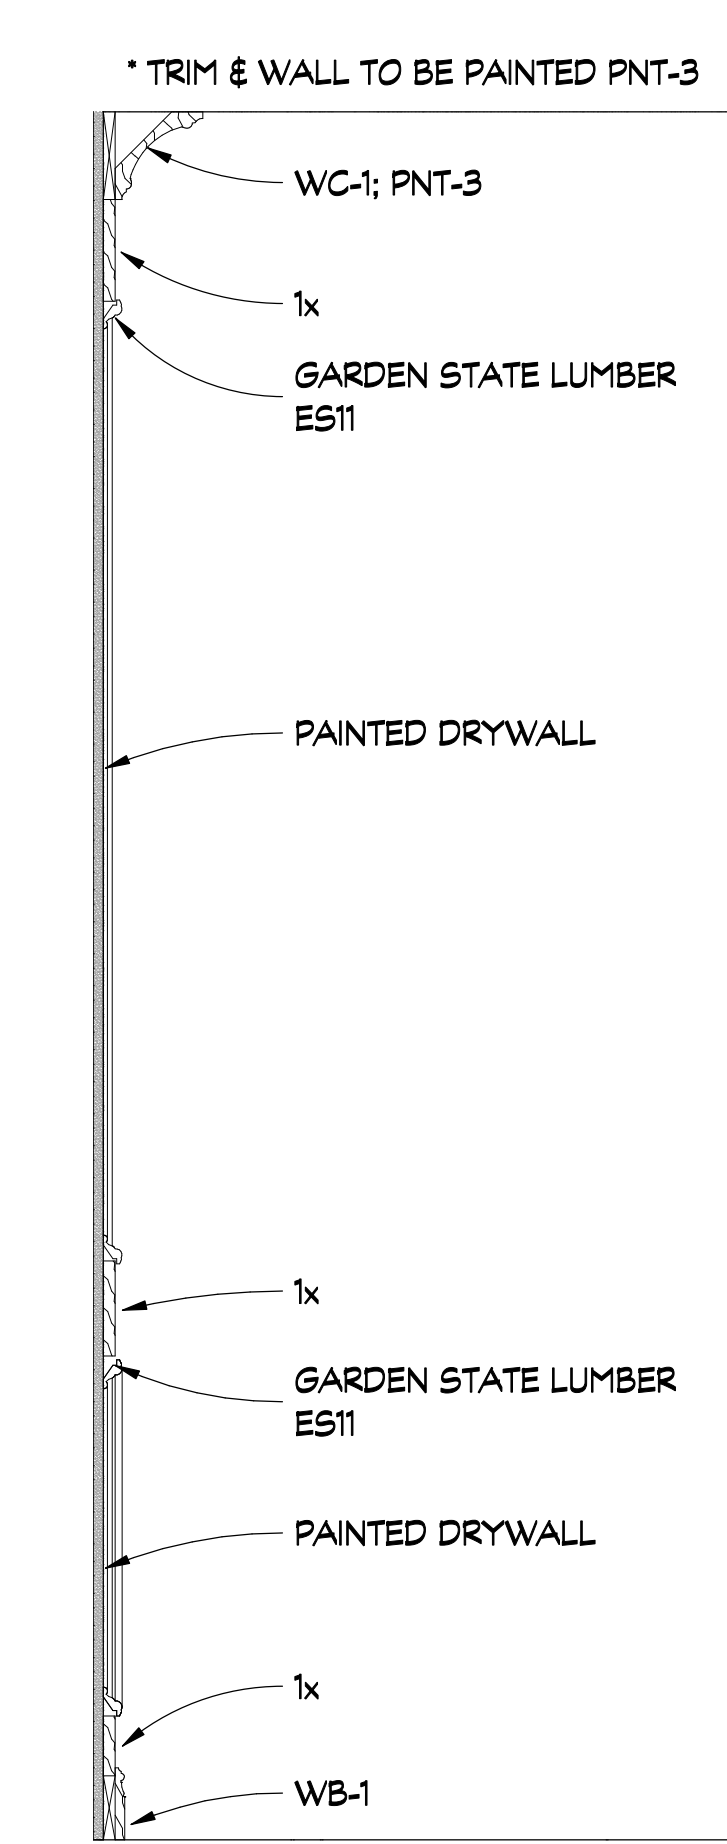



18 PANELING DETAIL @ SIDE ENTRANCE
SCALE: 1" = 1'-0"

MILLWORK KEY

- BC# - BASE CABINET
- UC# - UPPER CABINET
- TCH# - TALL CABINET

MILLWORK NOTES

- SEE ELEVATIONS FOR BACKSPASH HEIGHTS
- COORDINATE ALL APPLIANCES WITH OWNER PRIOR TO MILLWORK FABRICATION

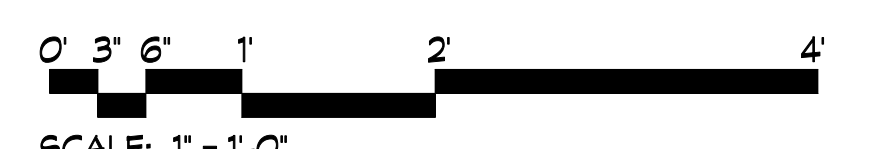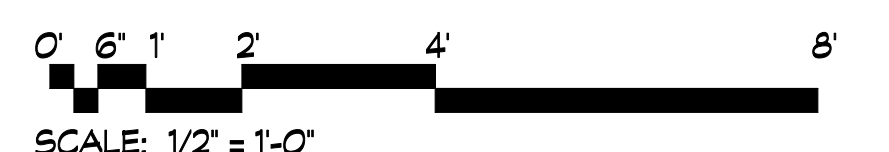

REVISIONS				
REV #	DATE	APPROV	BY	REVISION
1	2/16/22	EA		ISSUE FOR PERMIT




DA PROJECT NUMBER & NAME:
1893


DRAWING TITLE:
**MILLWORK
DETAILS**

DRAWING NO:
A851


E
D
C
B
A

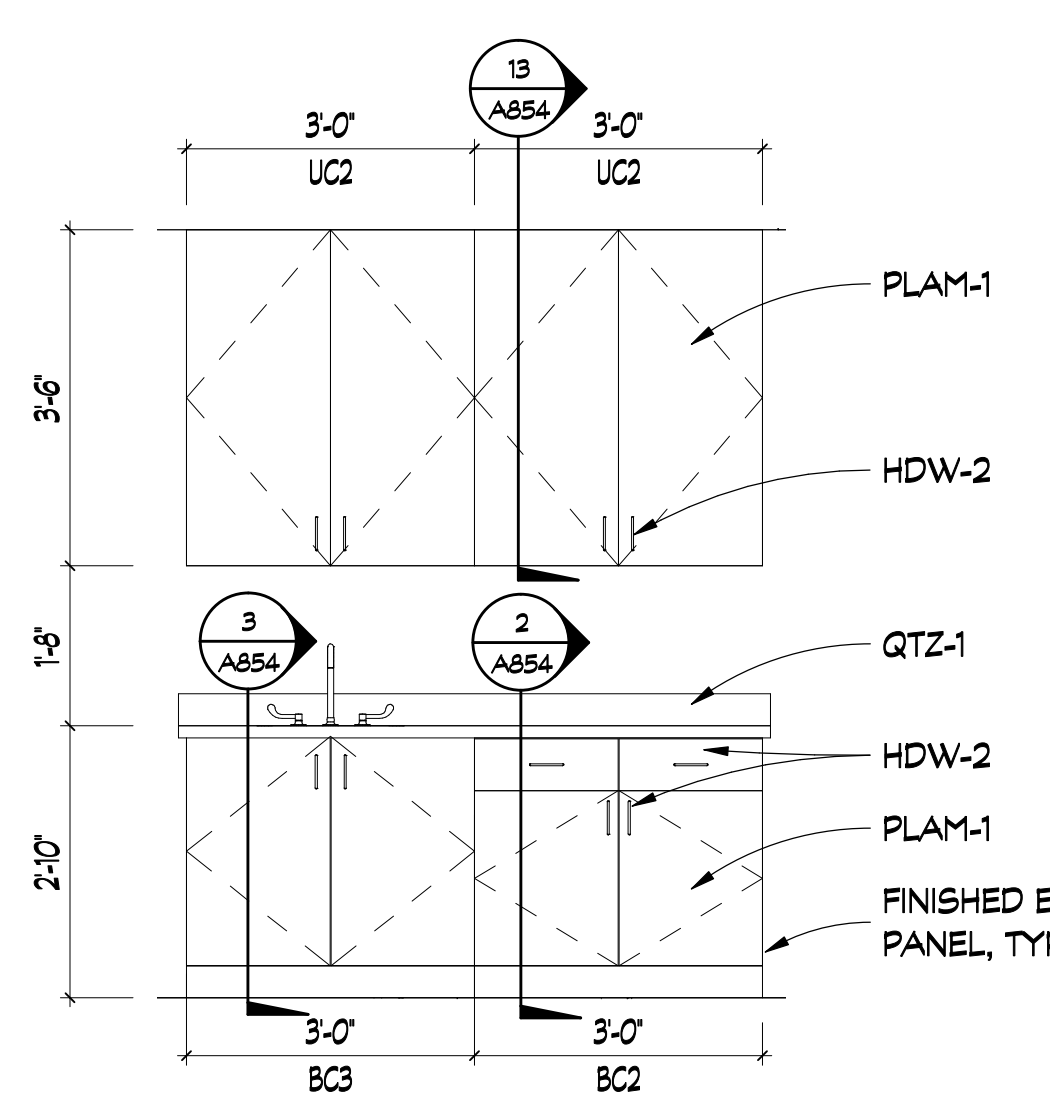


1 NURSES OFFICE MILLWORK
SCALE: 1/2" = 1'-0"

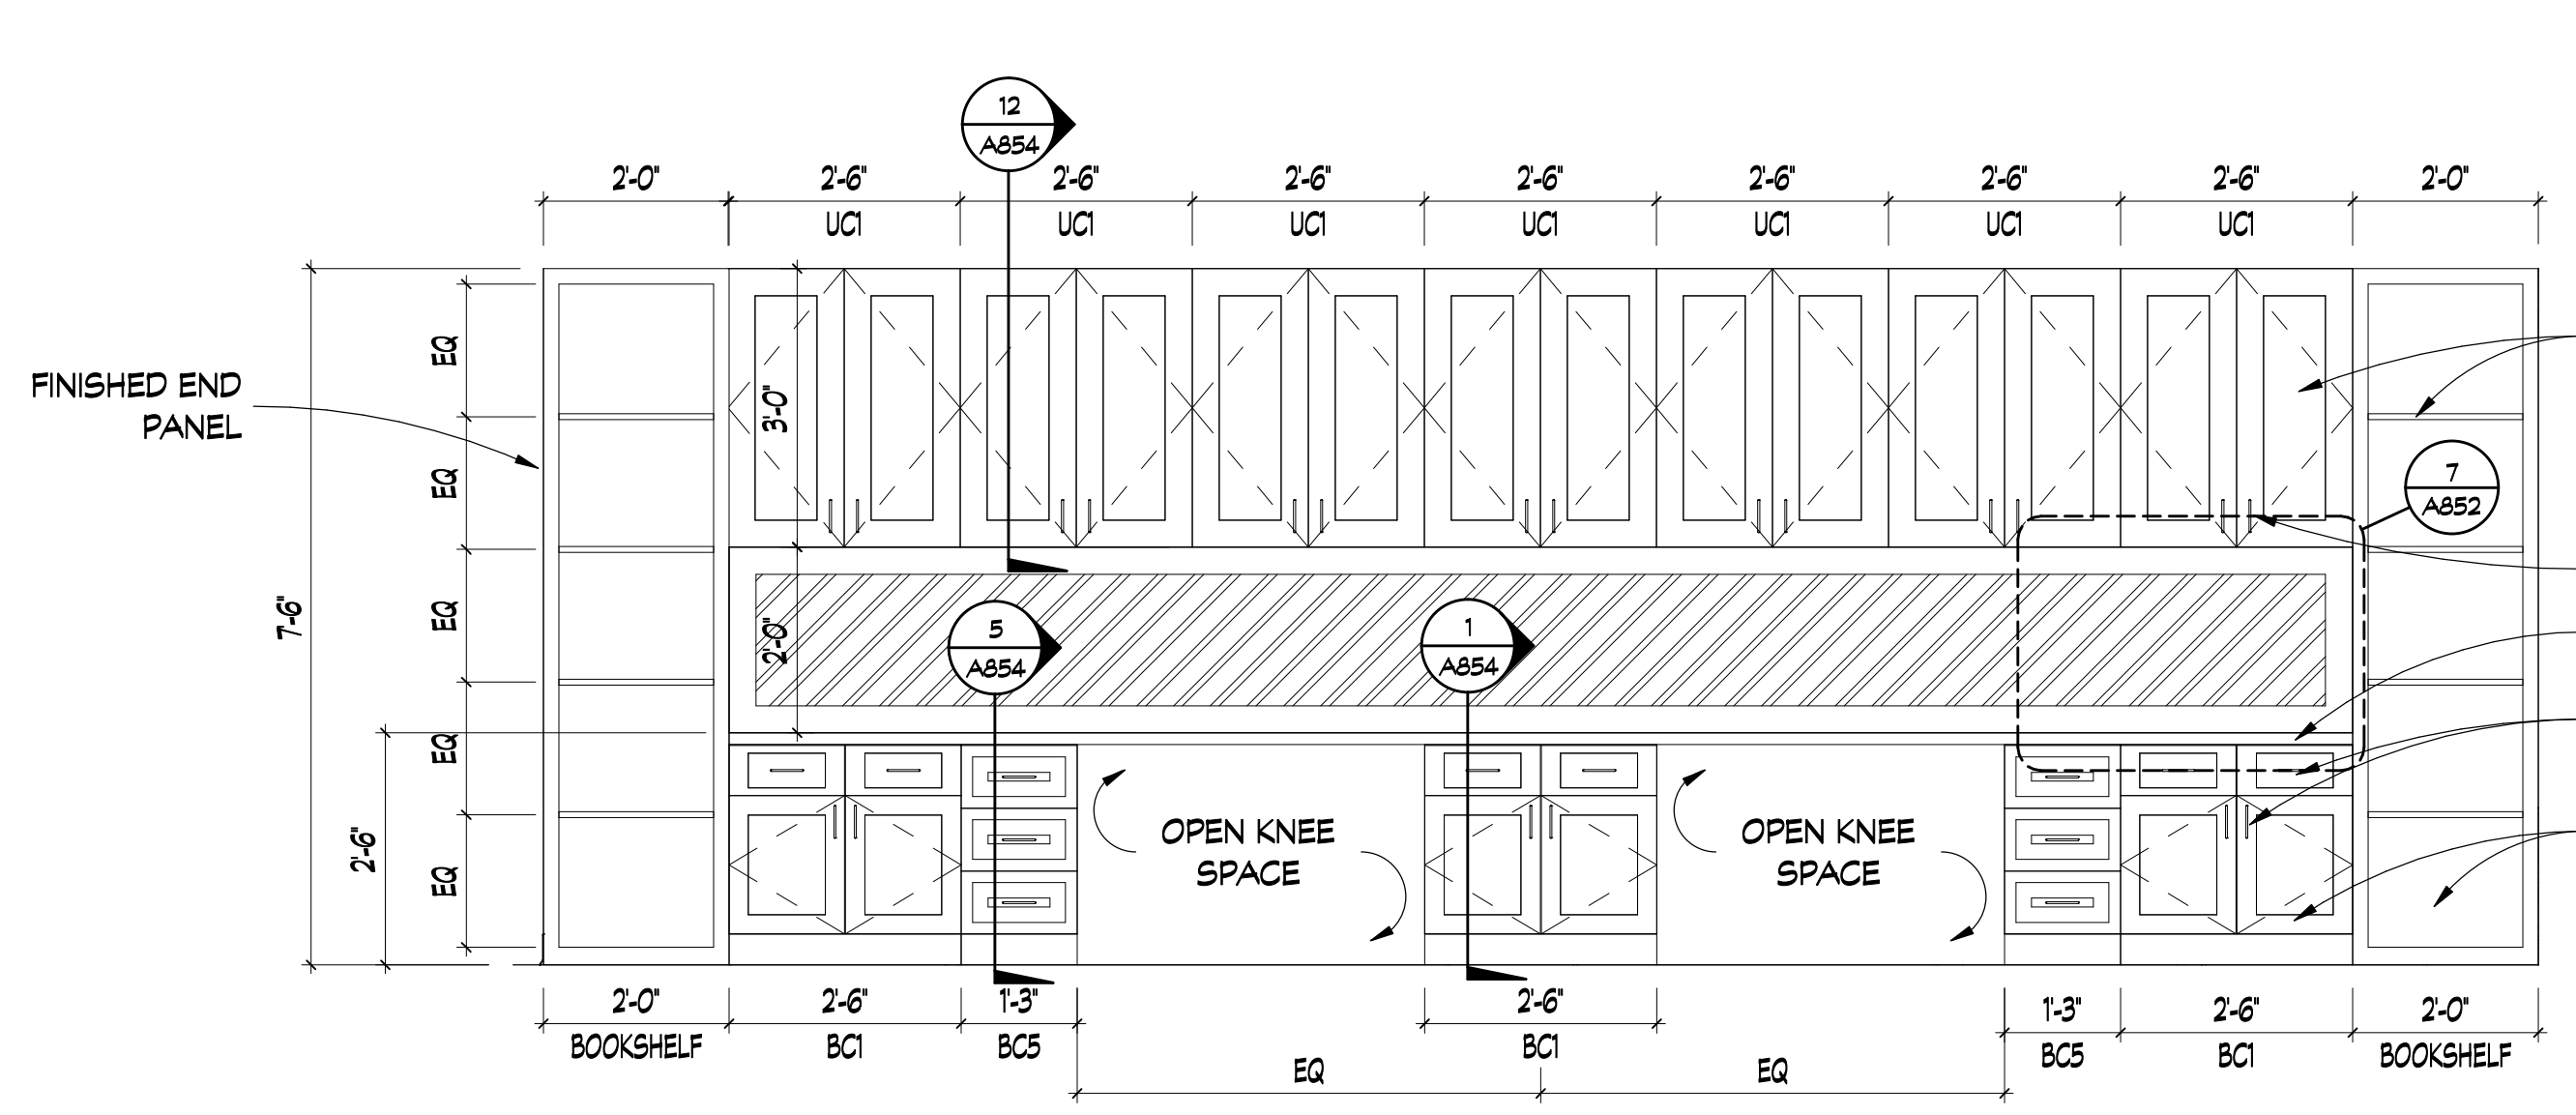


5 HOME HUB MILLWORK
SCALE: 1/2" = 1'-0"

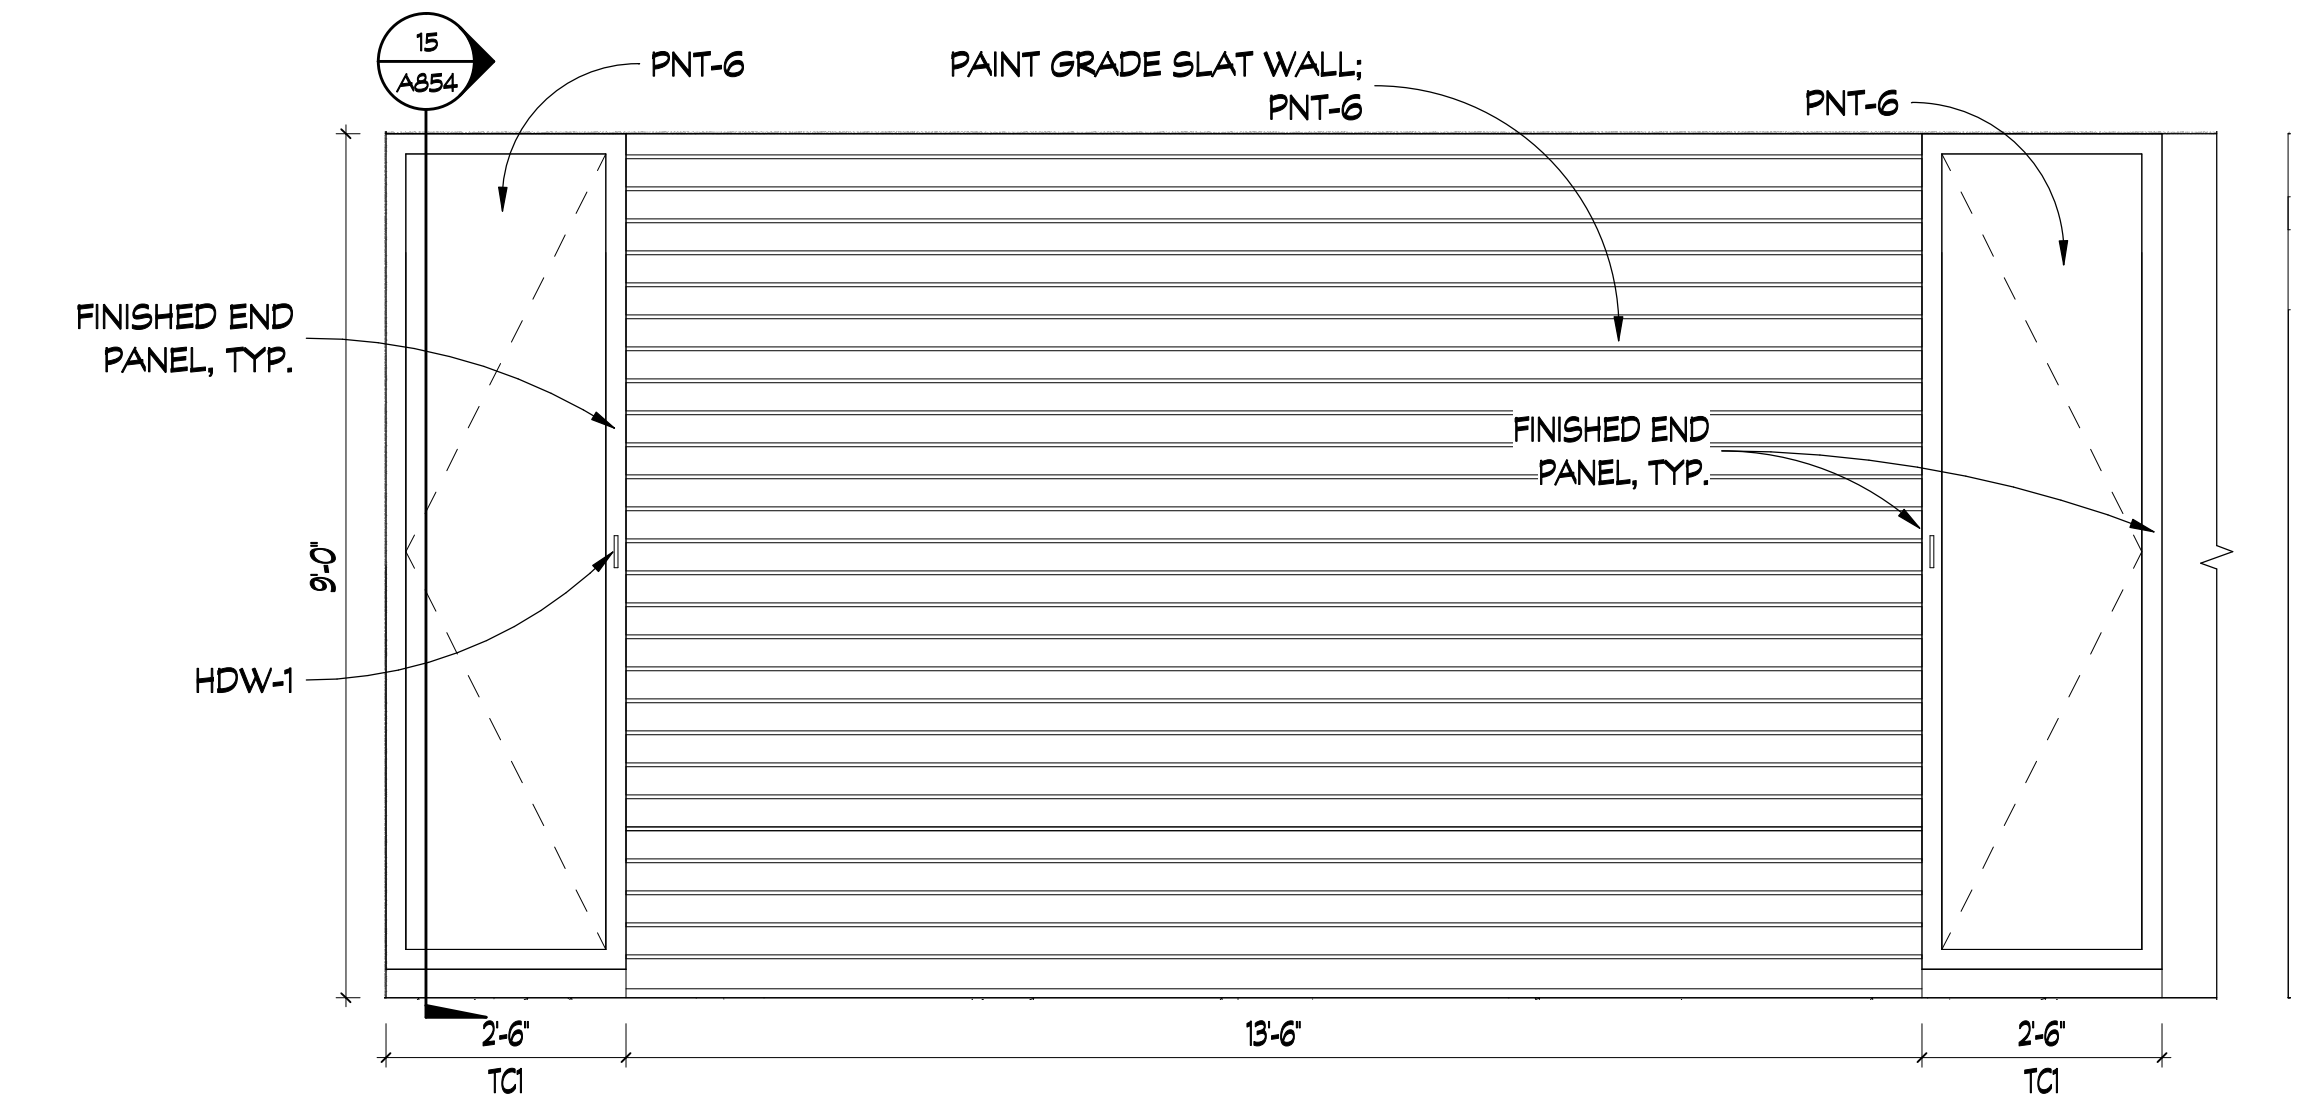


6 HOME HUB STORAGE CABINETS / SLAT WALL
SCALE: 1/2" = 1'-0"

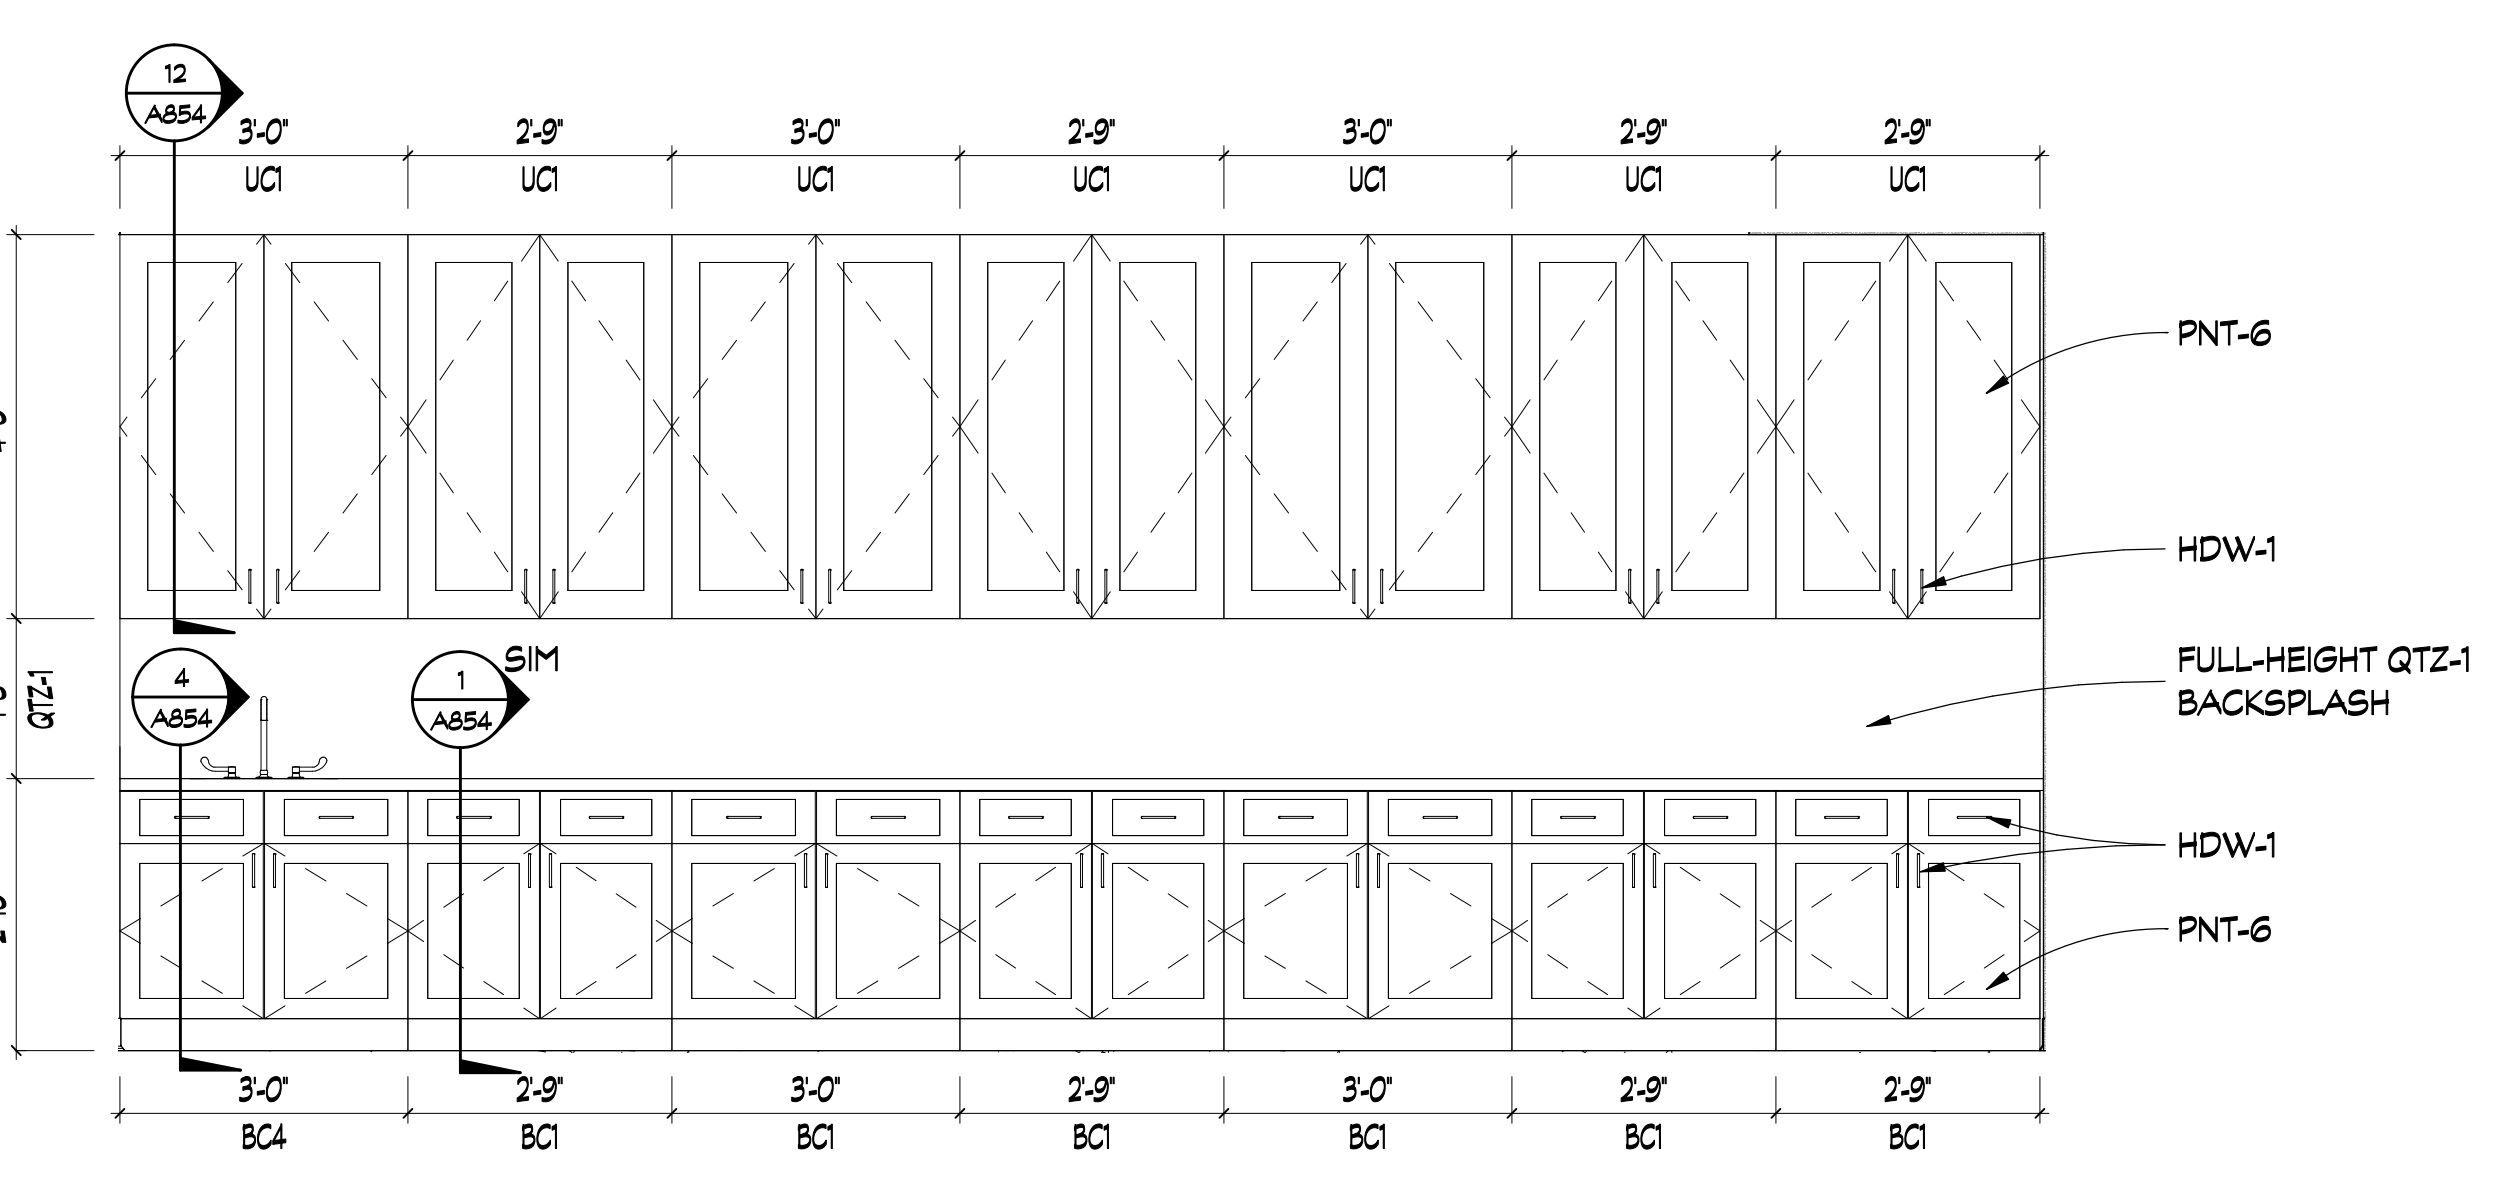


2 ART STUDIO MILLWORK
SCALE: 1/2" = 1'-0"

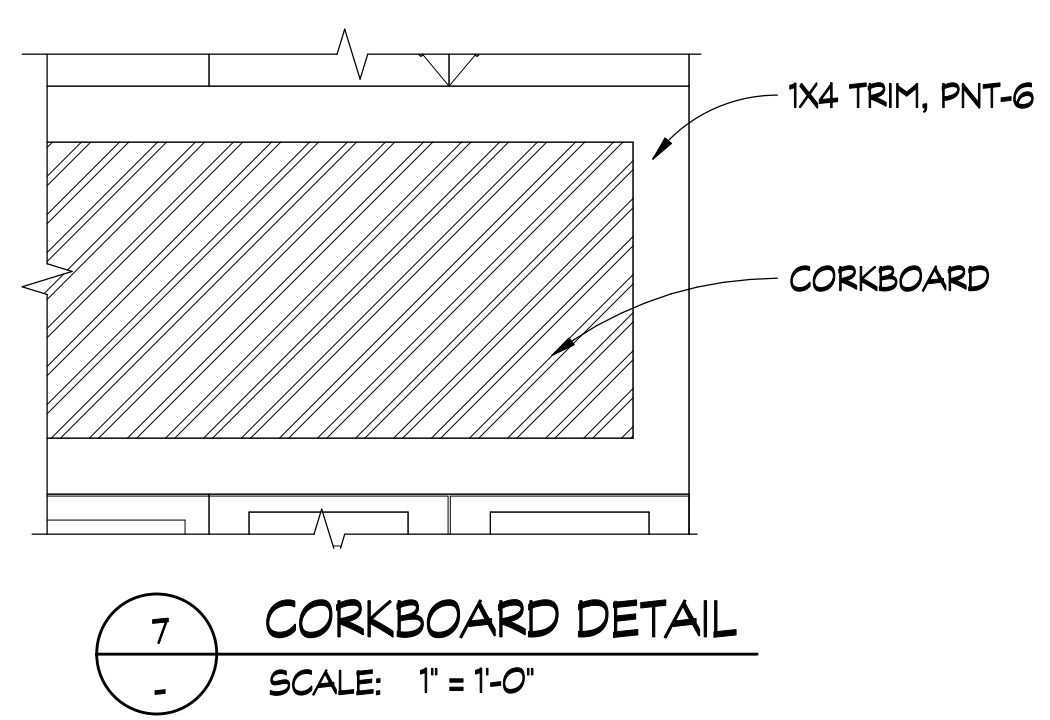


7 CORKBOARD DETAIL
SCALE: 1" = 1'-0"

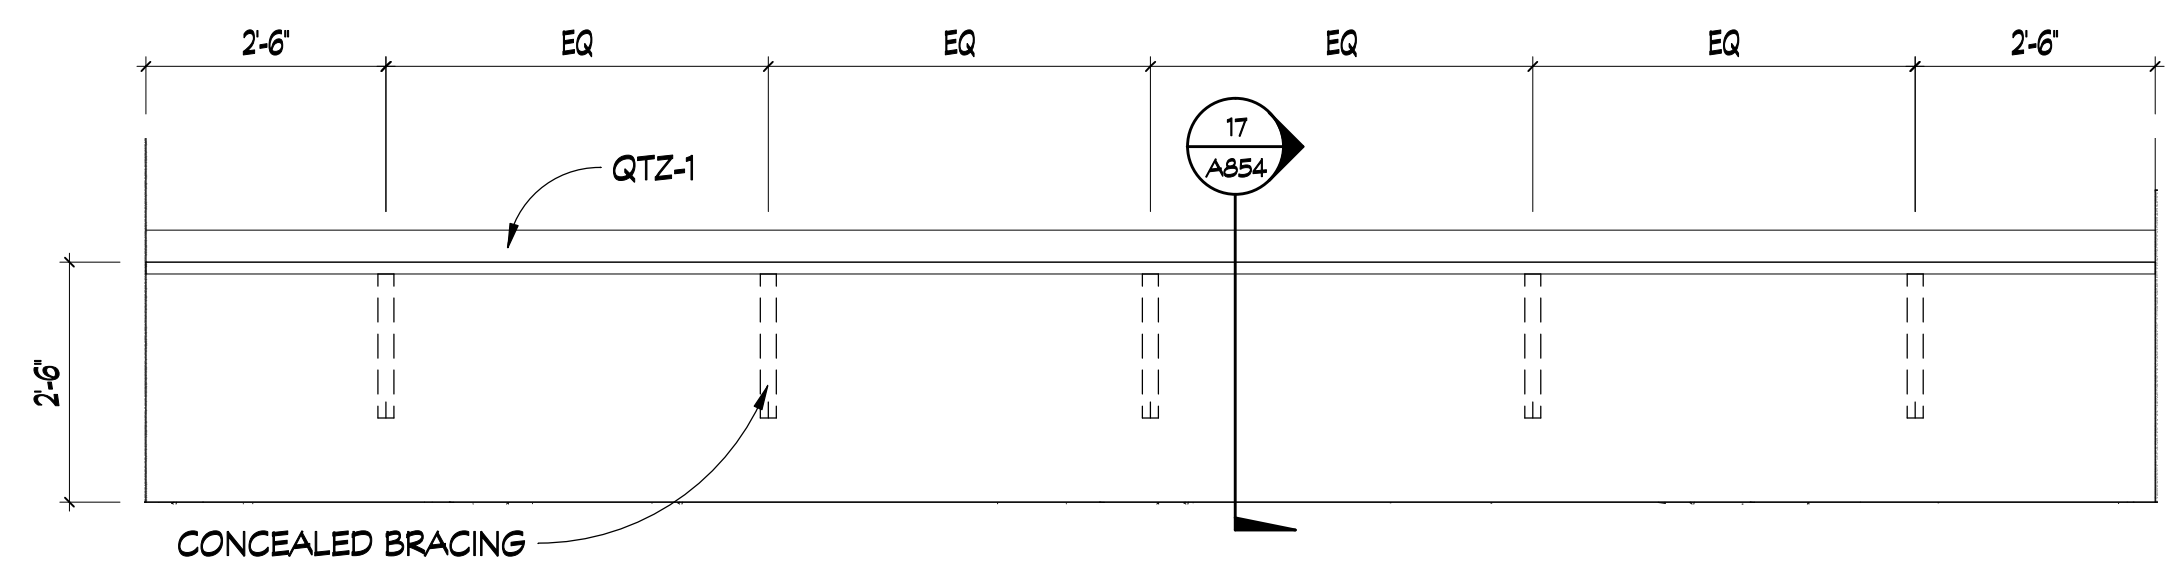


8 COMPUTER LAB COUNTER
SCALE: 1/2" = 1'-0"

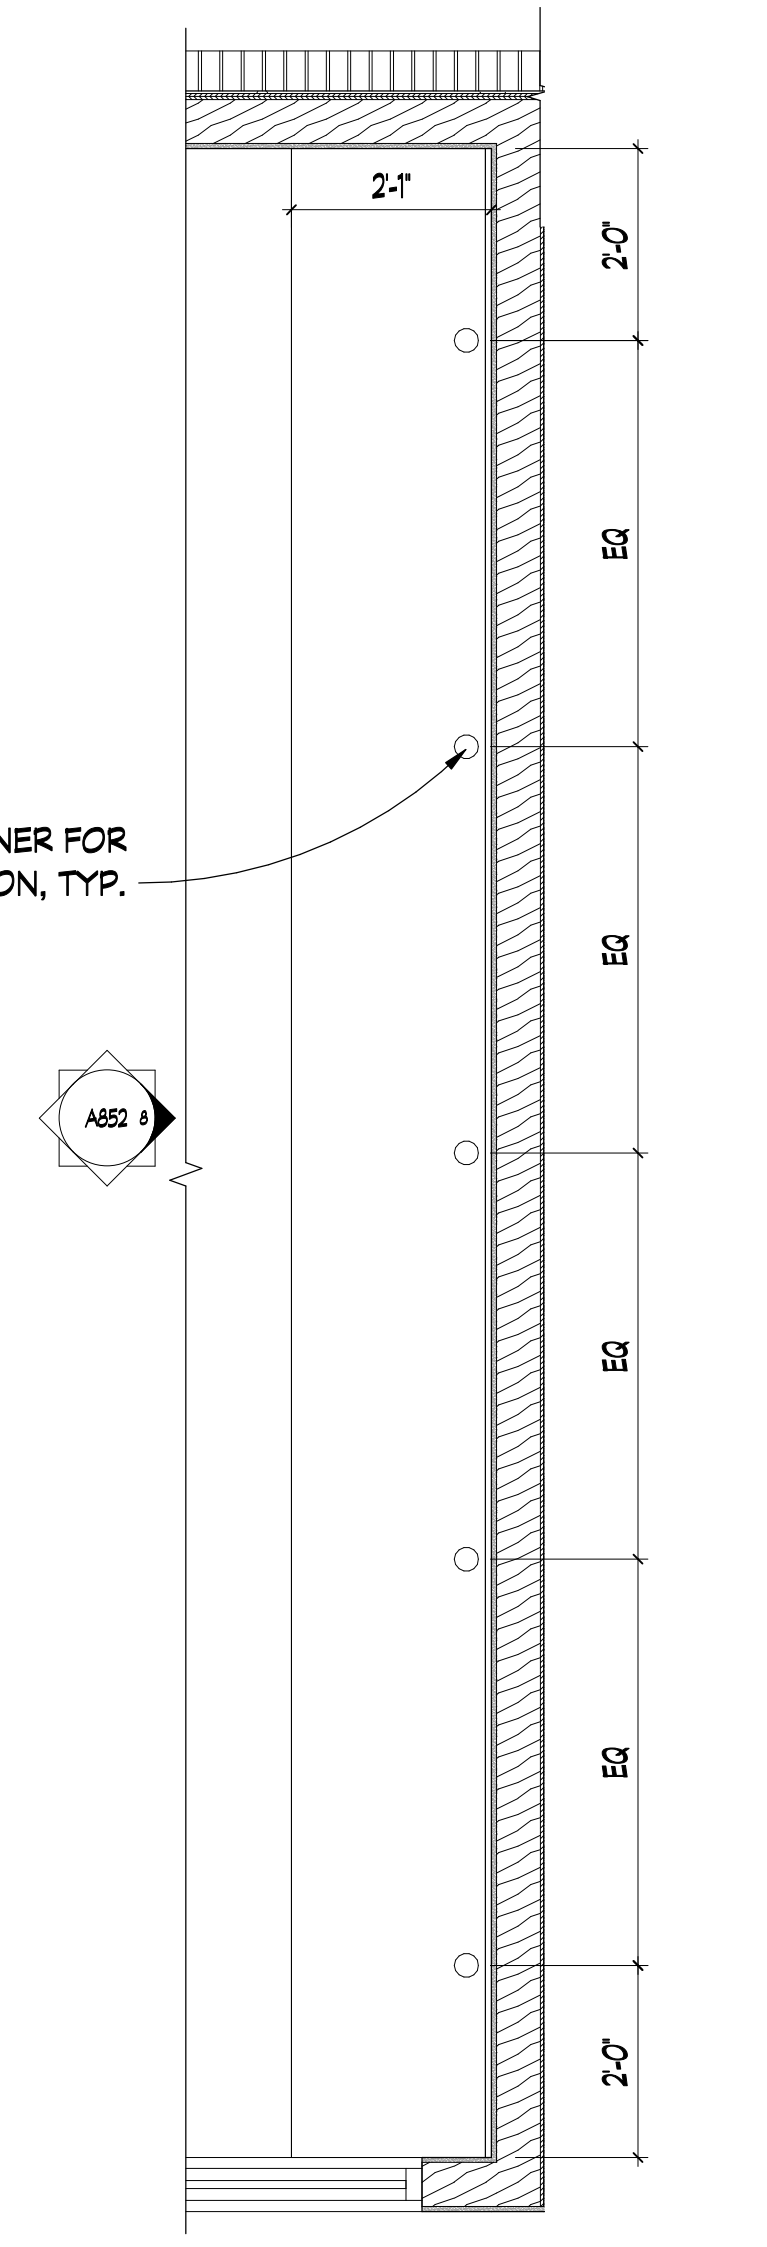


9 COMPUTER LAB MILLWORK
SCALE: 1/2" = 1'-0"

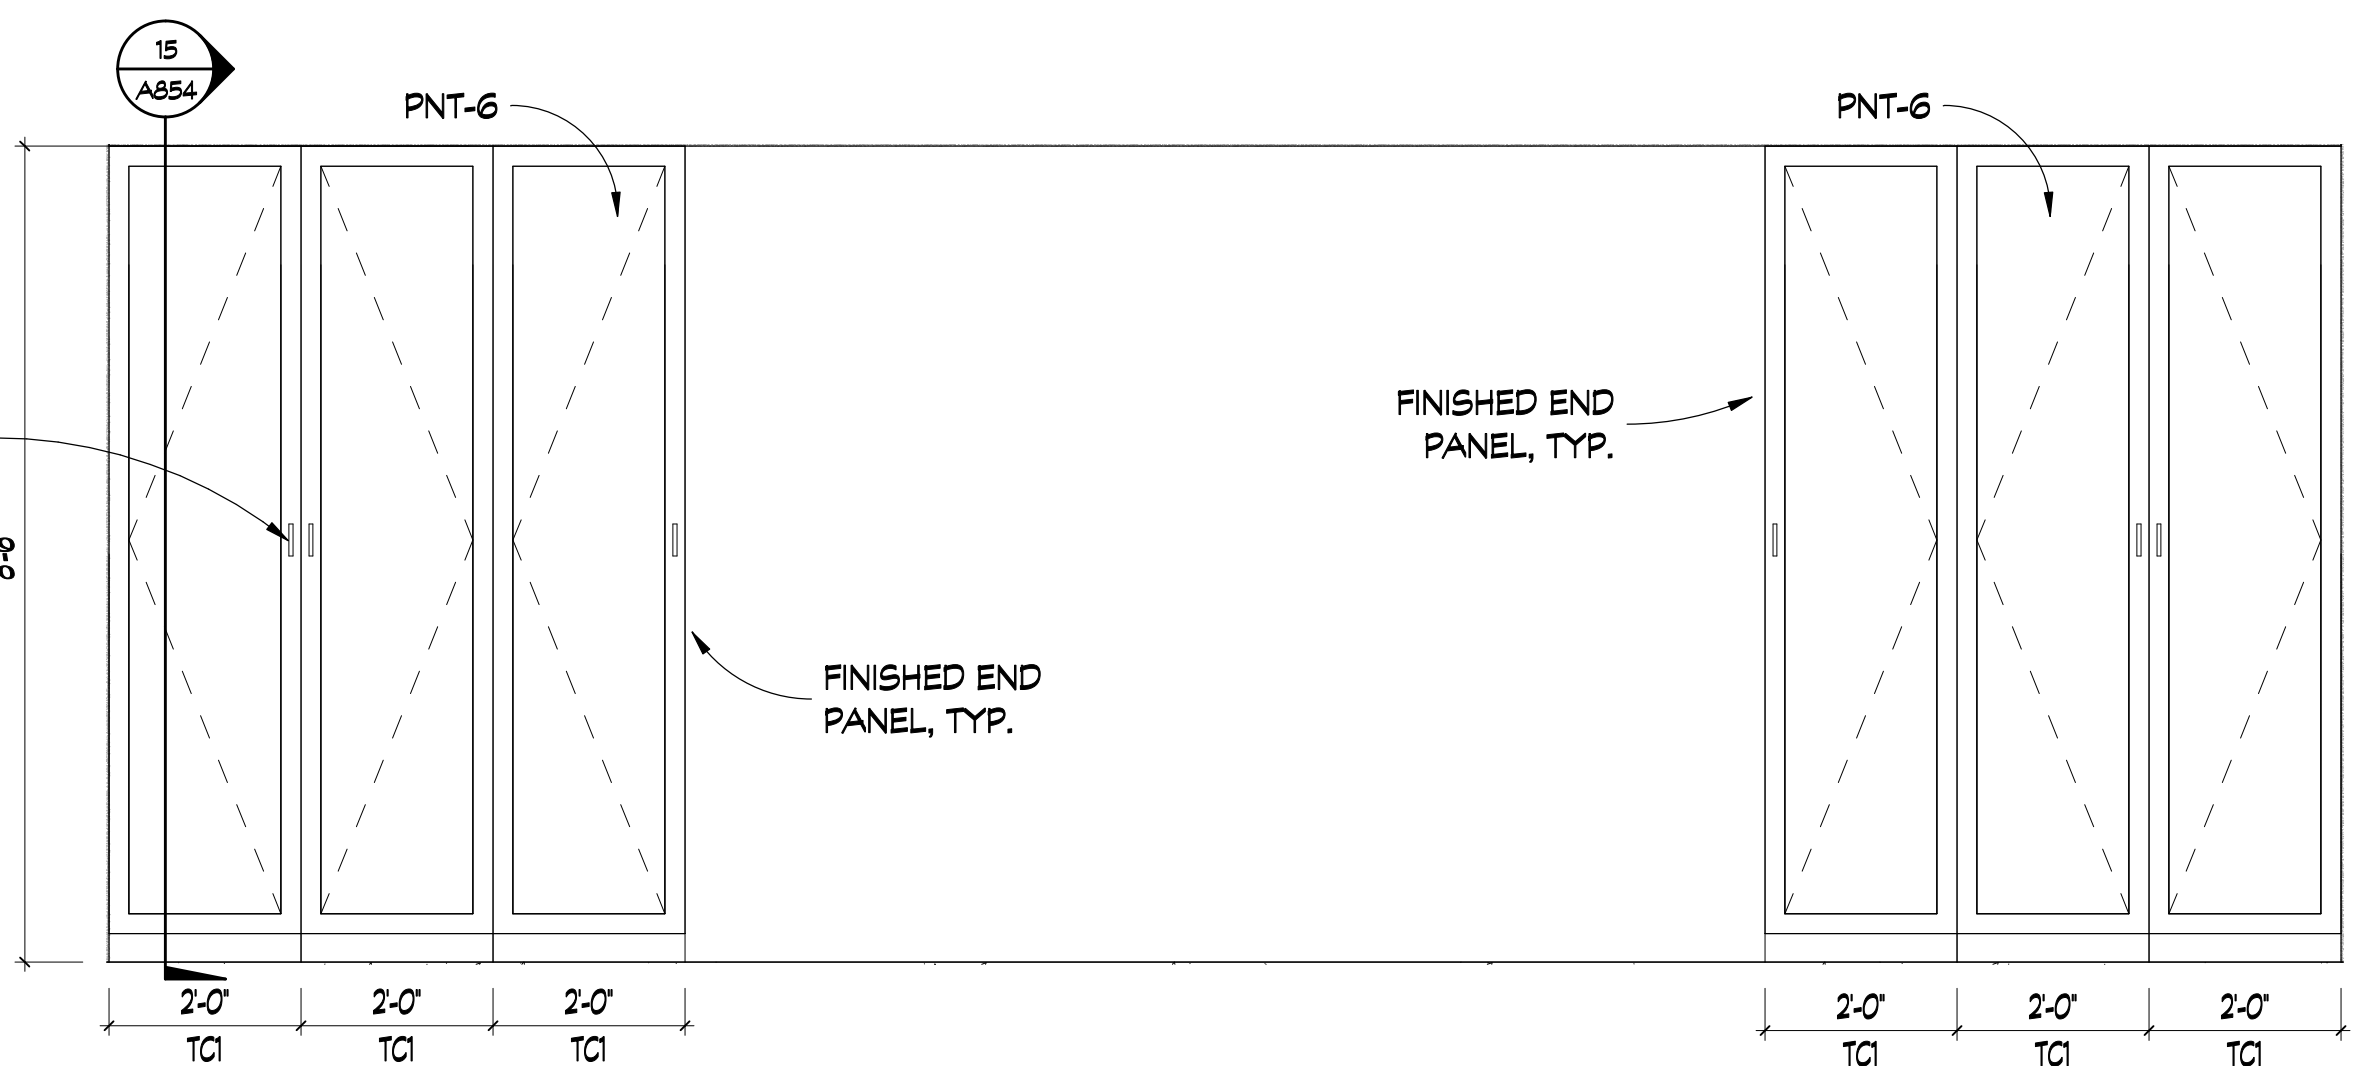


3 ART STUDIO MILLWORK
SCALE: 1/2" = 1'-0"

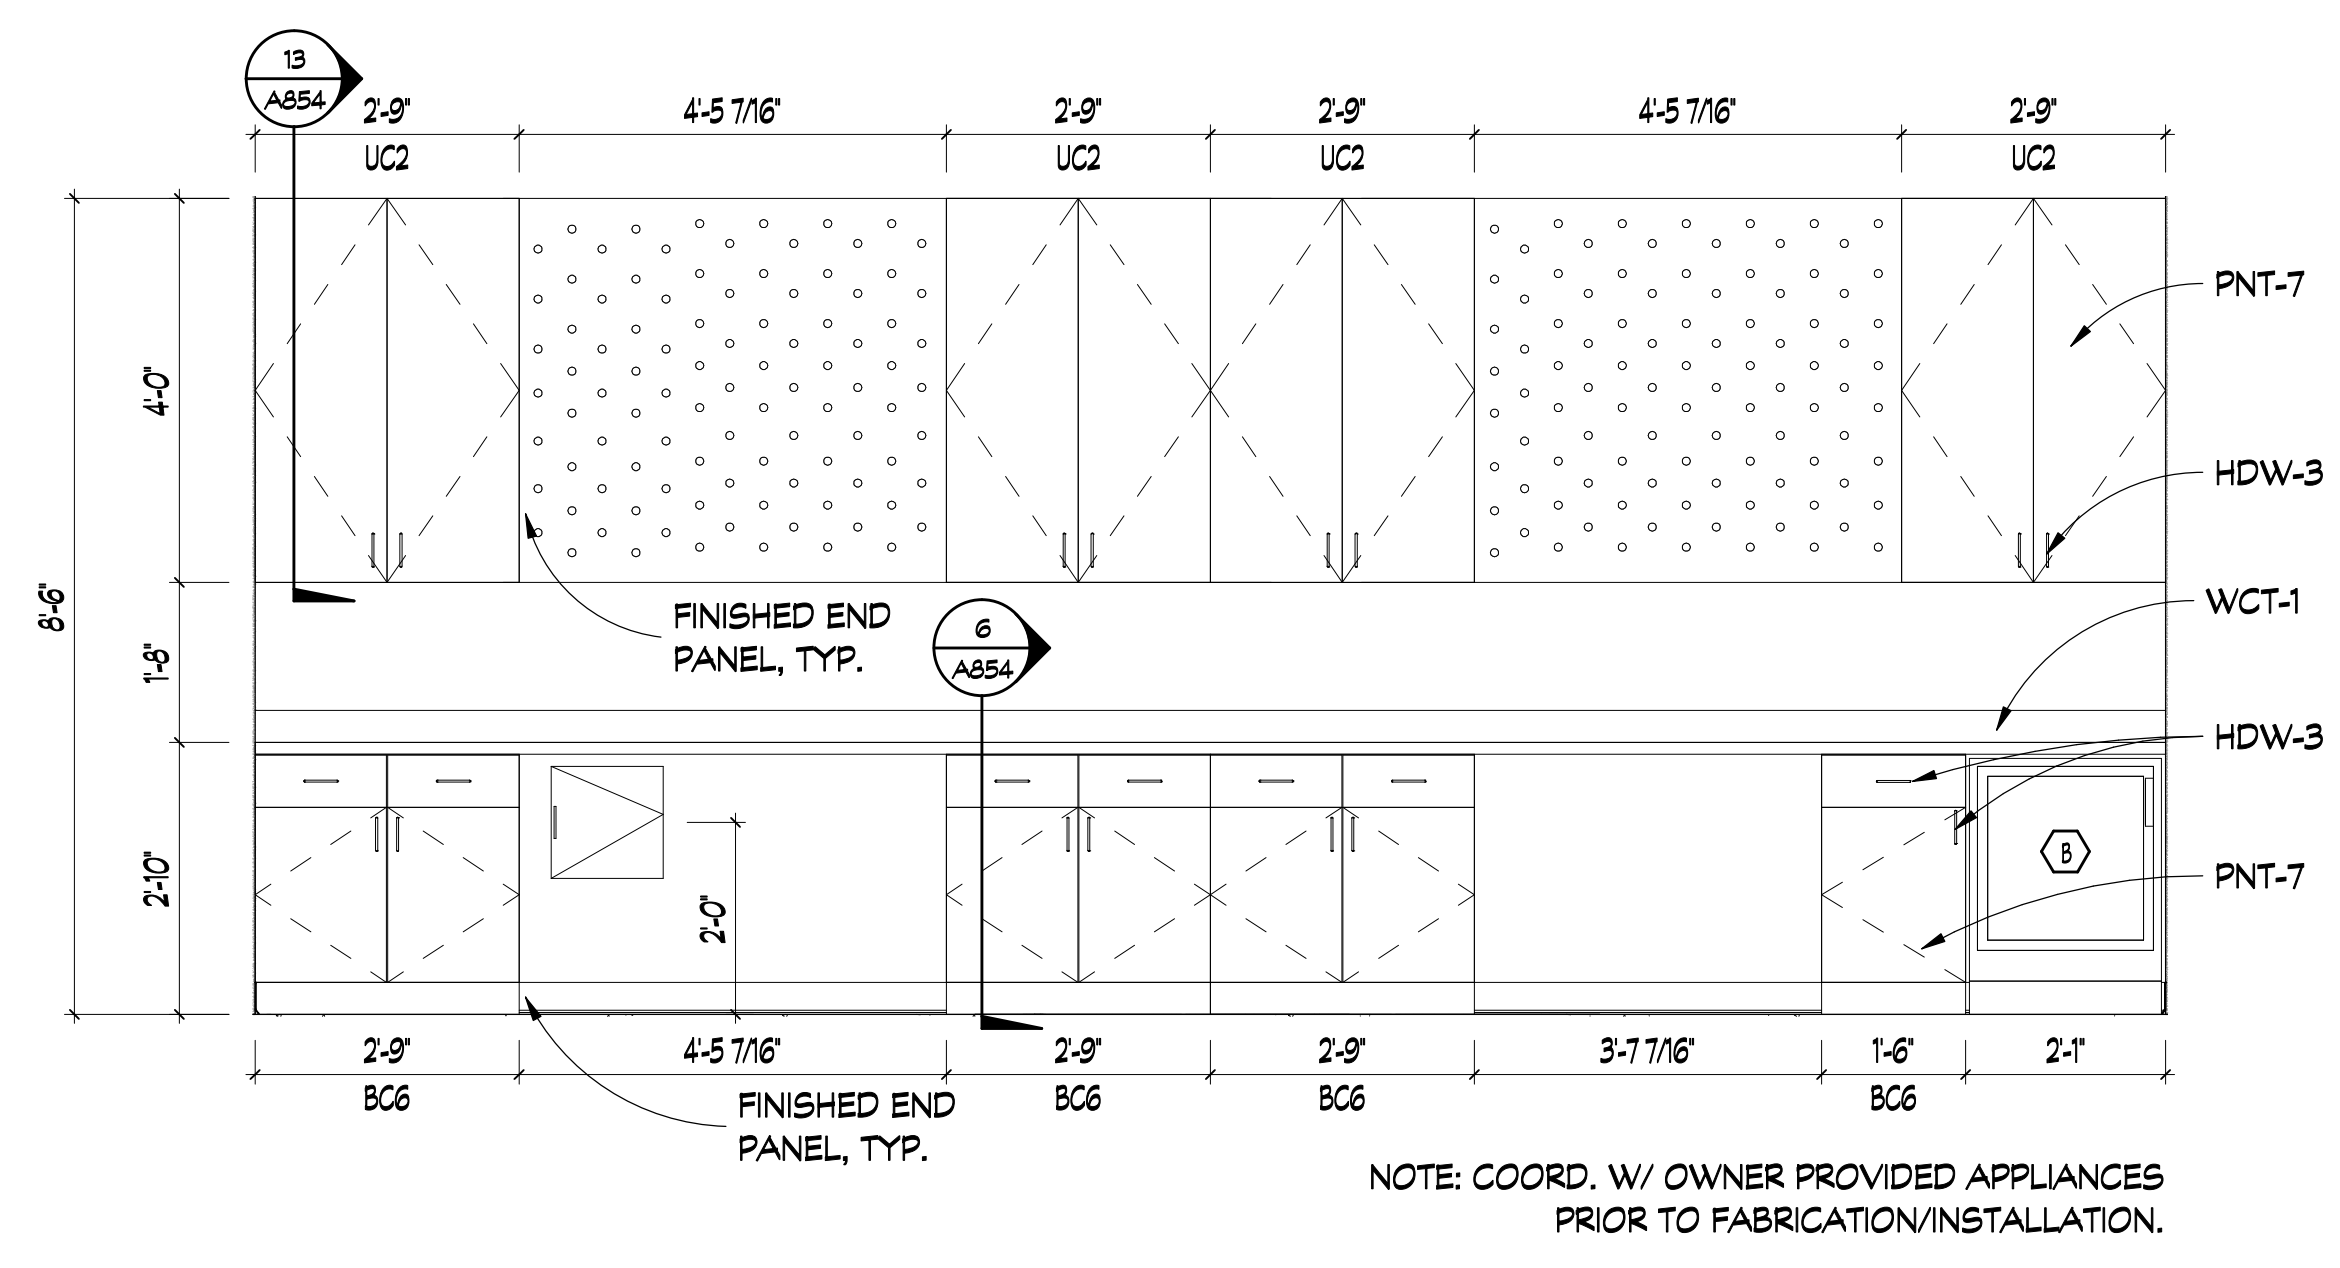


10 WORKSHOP MILLWORK
SCALE: 1/2" = 1'-0"

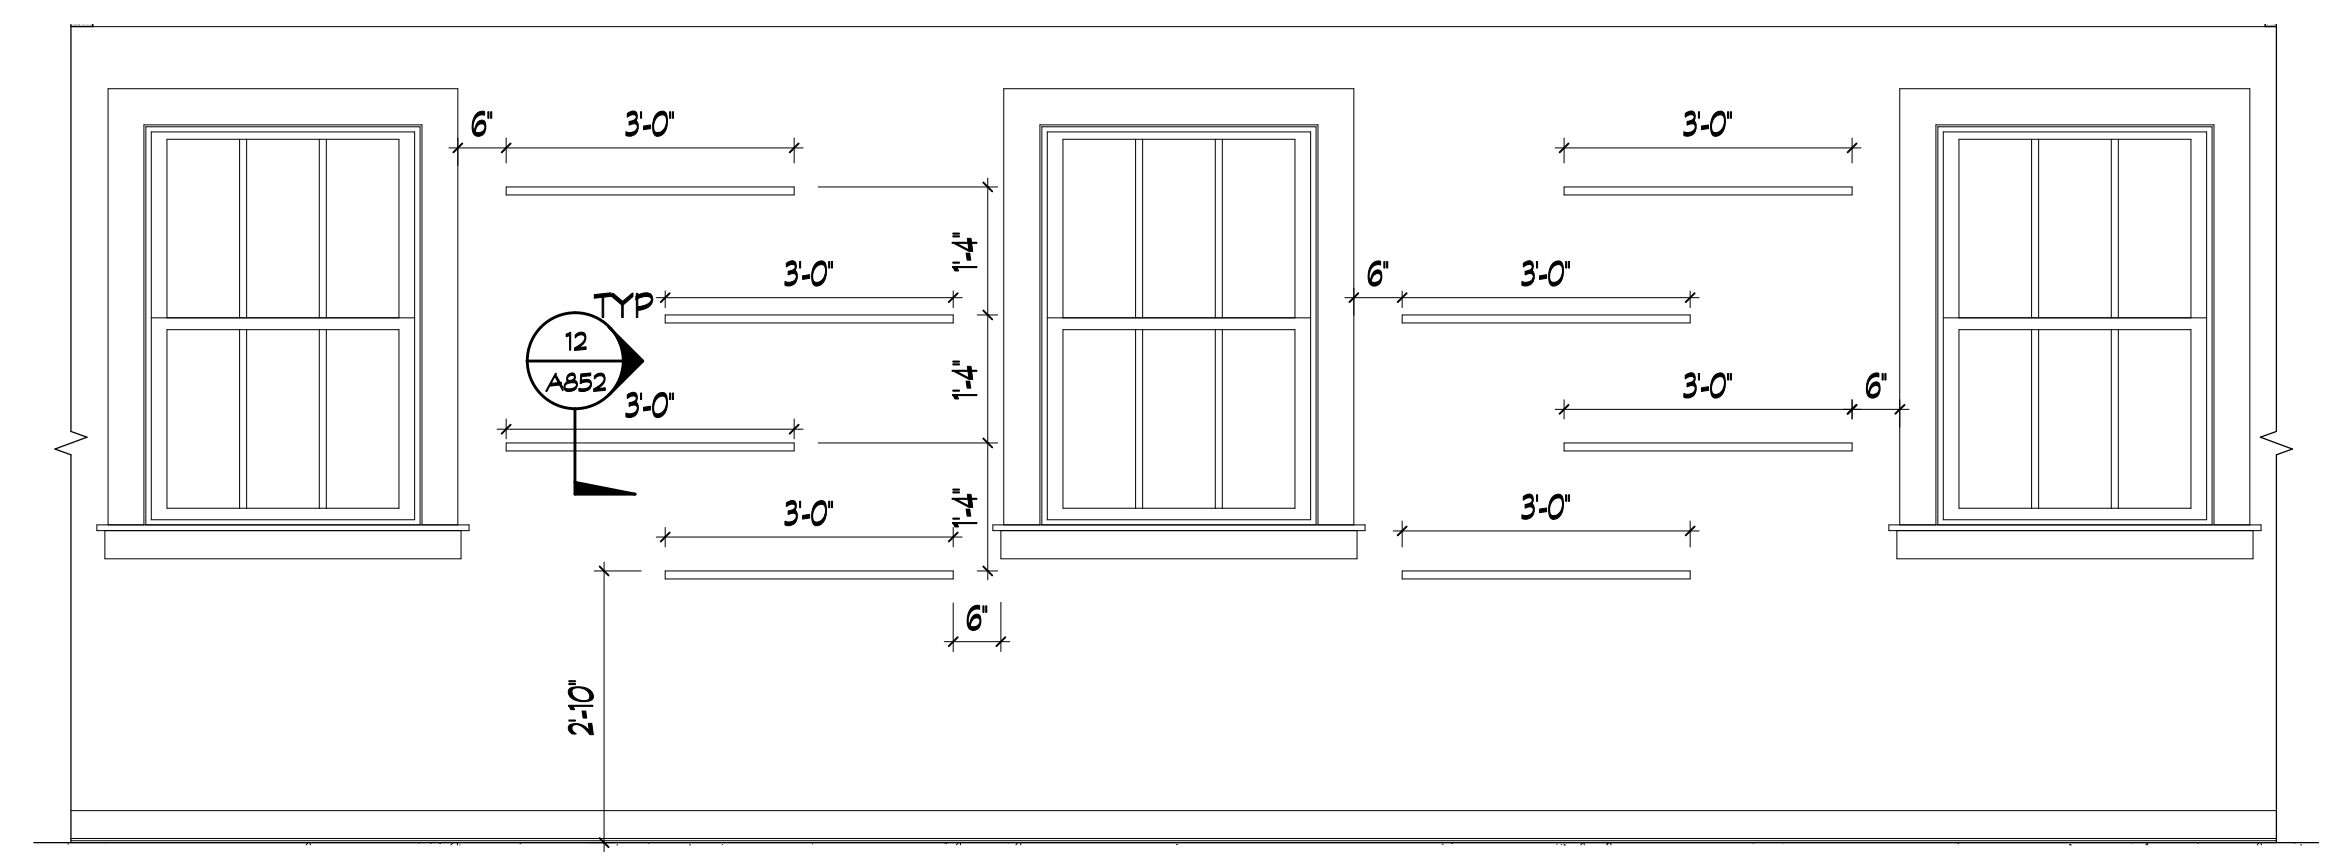

4 ART STUDIO SHELVING
SCALE: 1/2" = 1'-0"

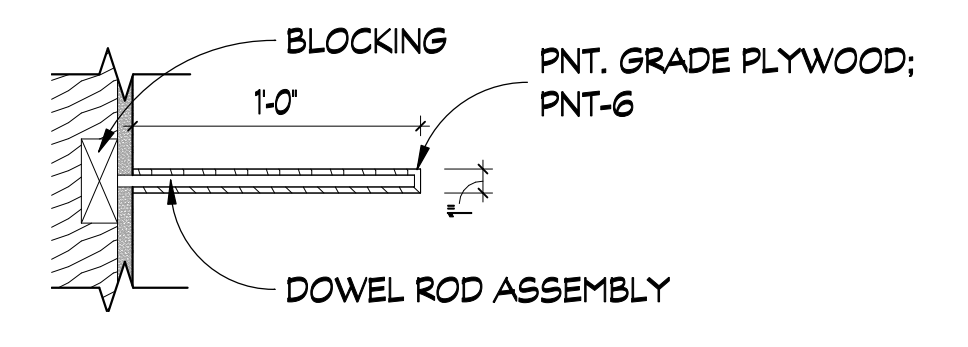


12 FLOATING SHELF DETAIL
SCALE: 1 1/2" = 1'-0"

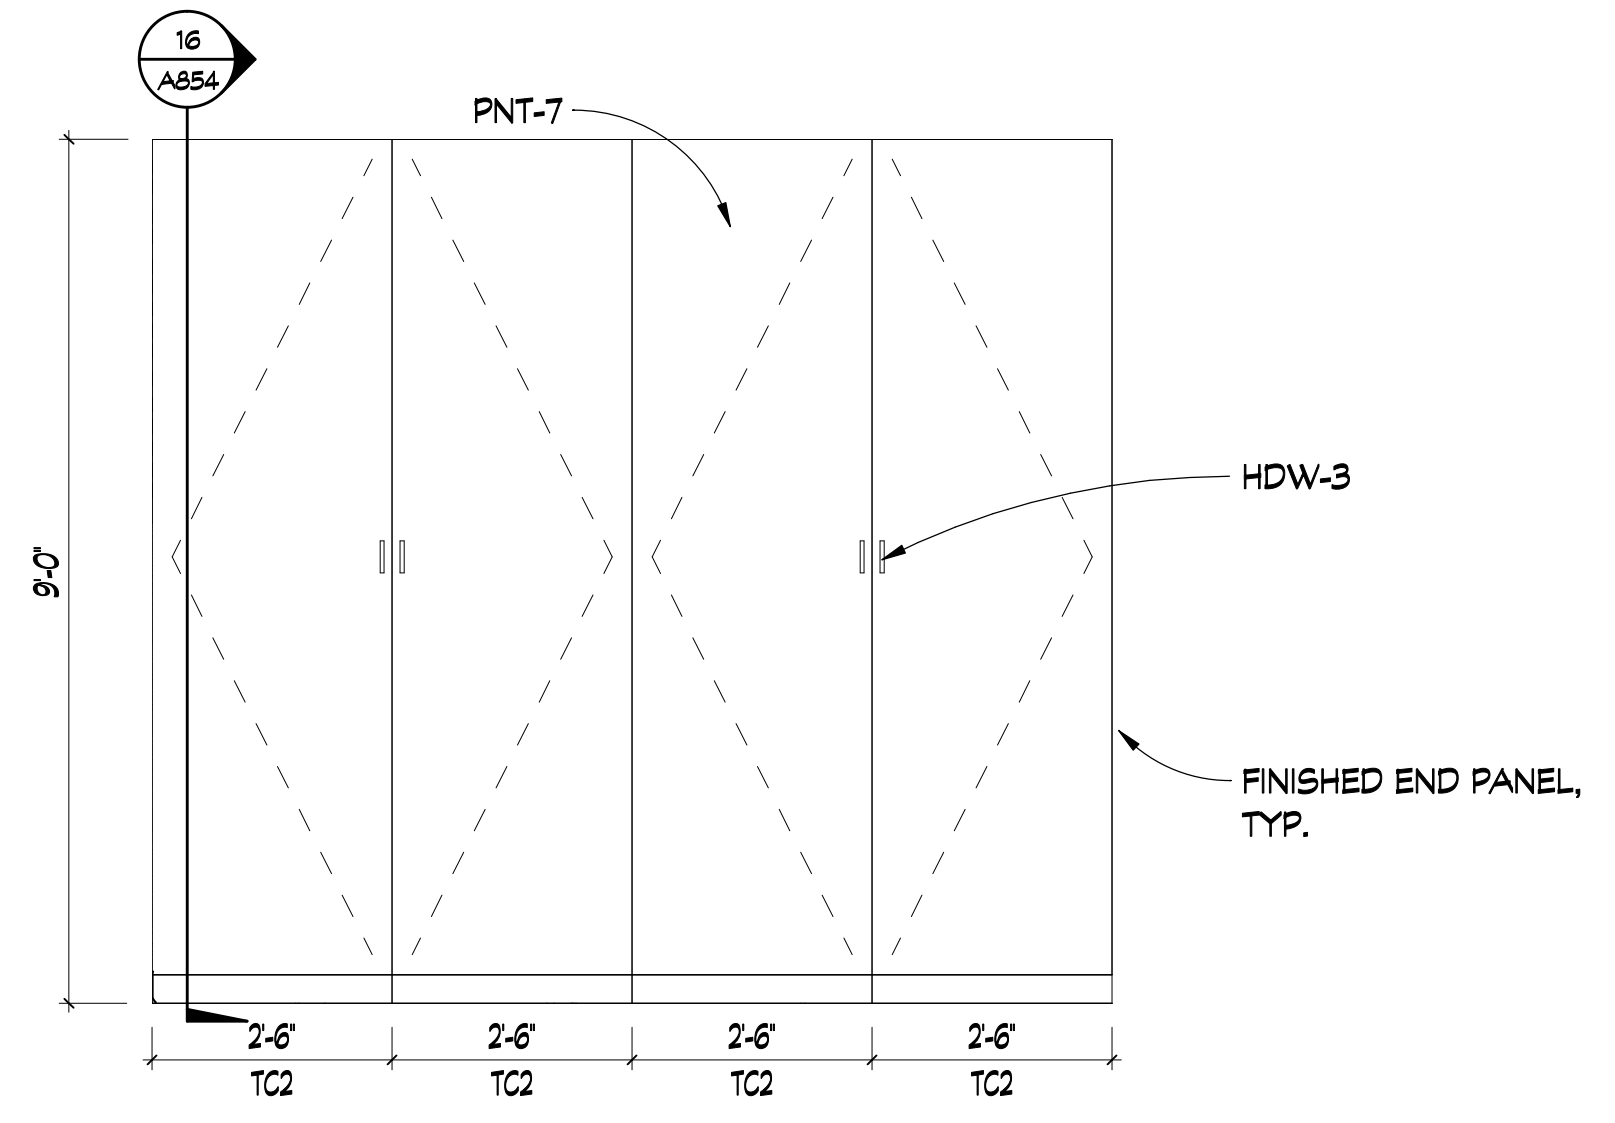


11 WORKSHOP STORAGE
SCALE: 1/2" = 1'-0"


MILLWORK KEY
BC# - BASE CABINET
UC# - UPPER CABINET
TC# - TALL CABINET

MILLWORK NOTES
1. " SEE ELEVATIONS FOR BACKSLASH HEIGHTS
2. COORDINATE ALL APPLIANCES WITH OWNER PRIOR TO MILLWORK FABRICATION

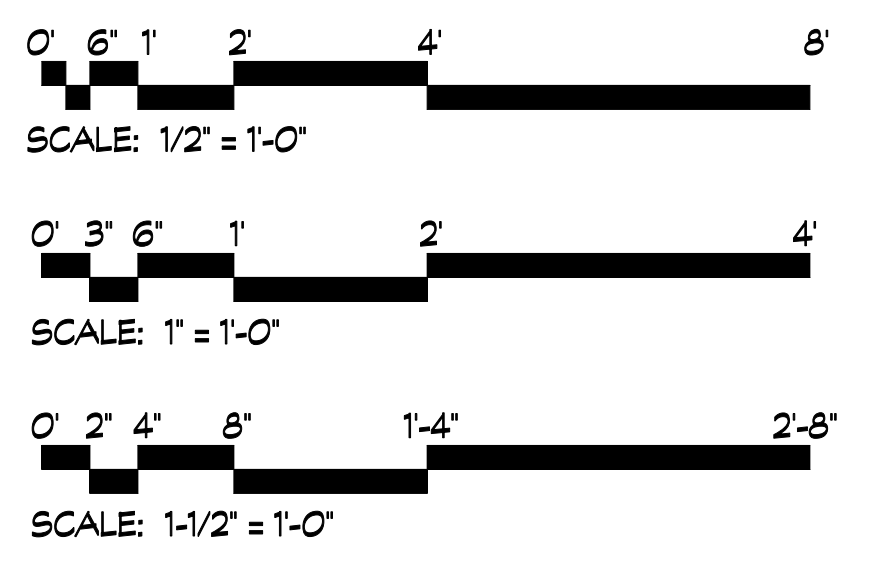


REVISIONS			
REV #	DATE	APPROV BY	REVISION
1	2/16/22	EA	ISSUE FOR PERMIT

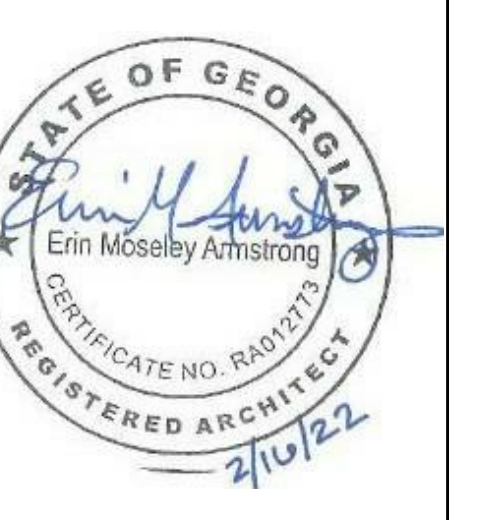


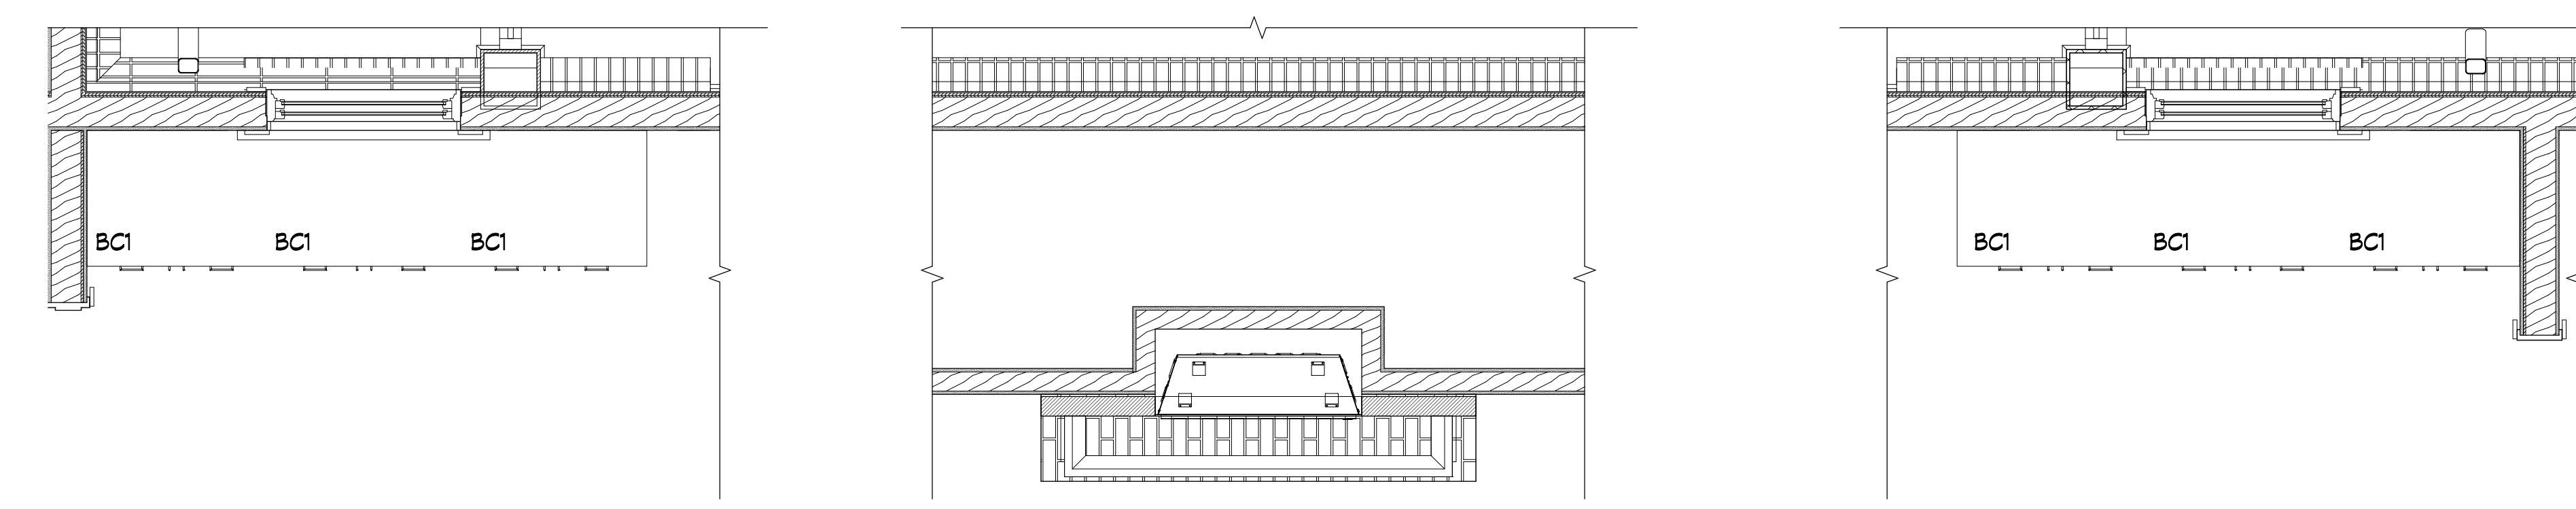


1 DINING ROOM MILLWORK
SCALE: 1/2" = 1'-0"

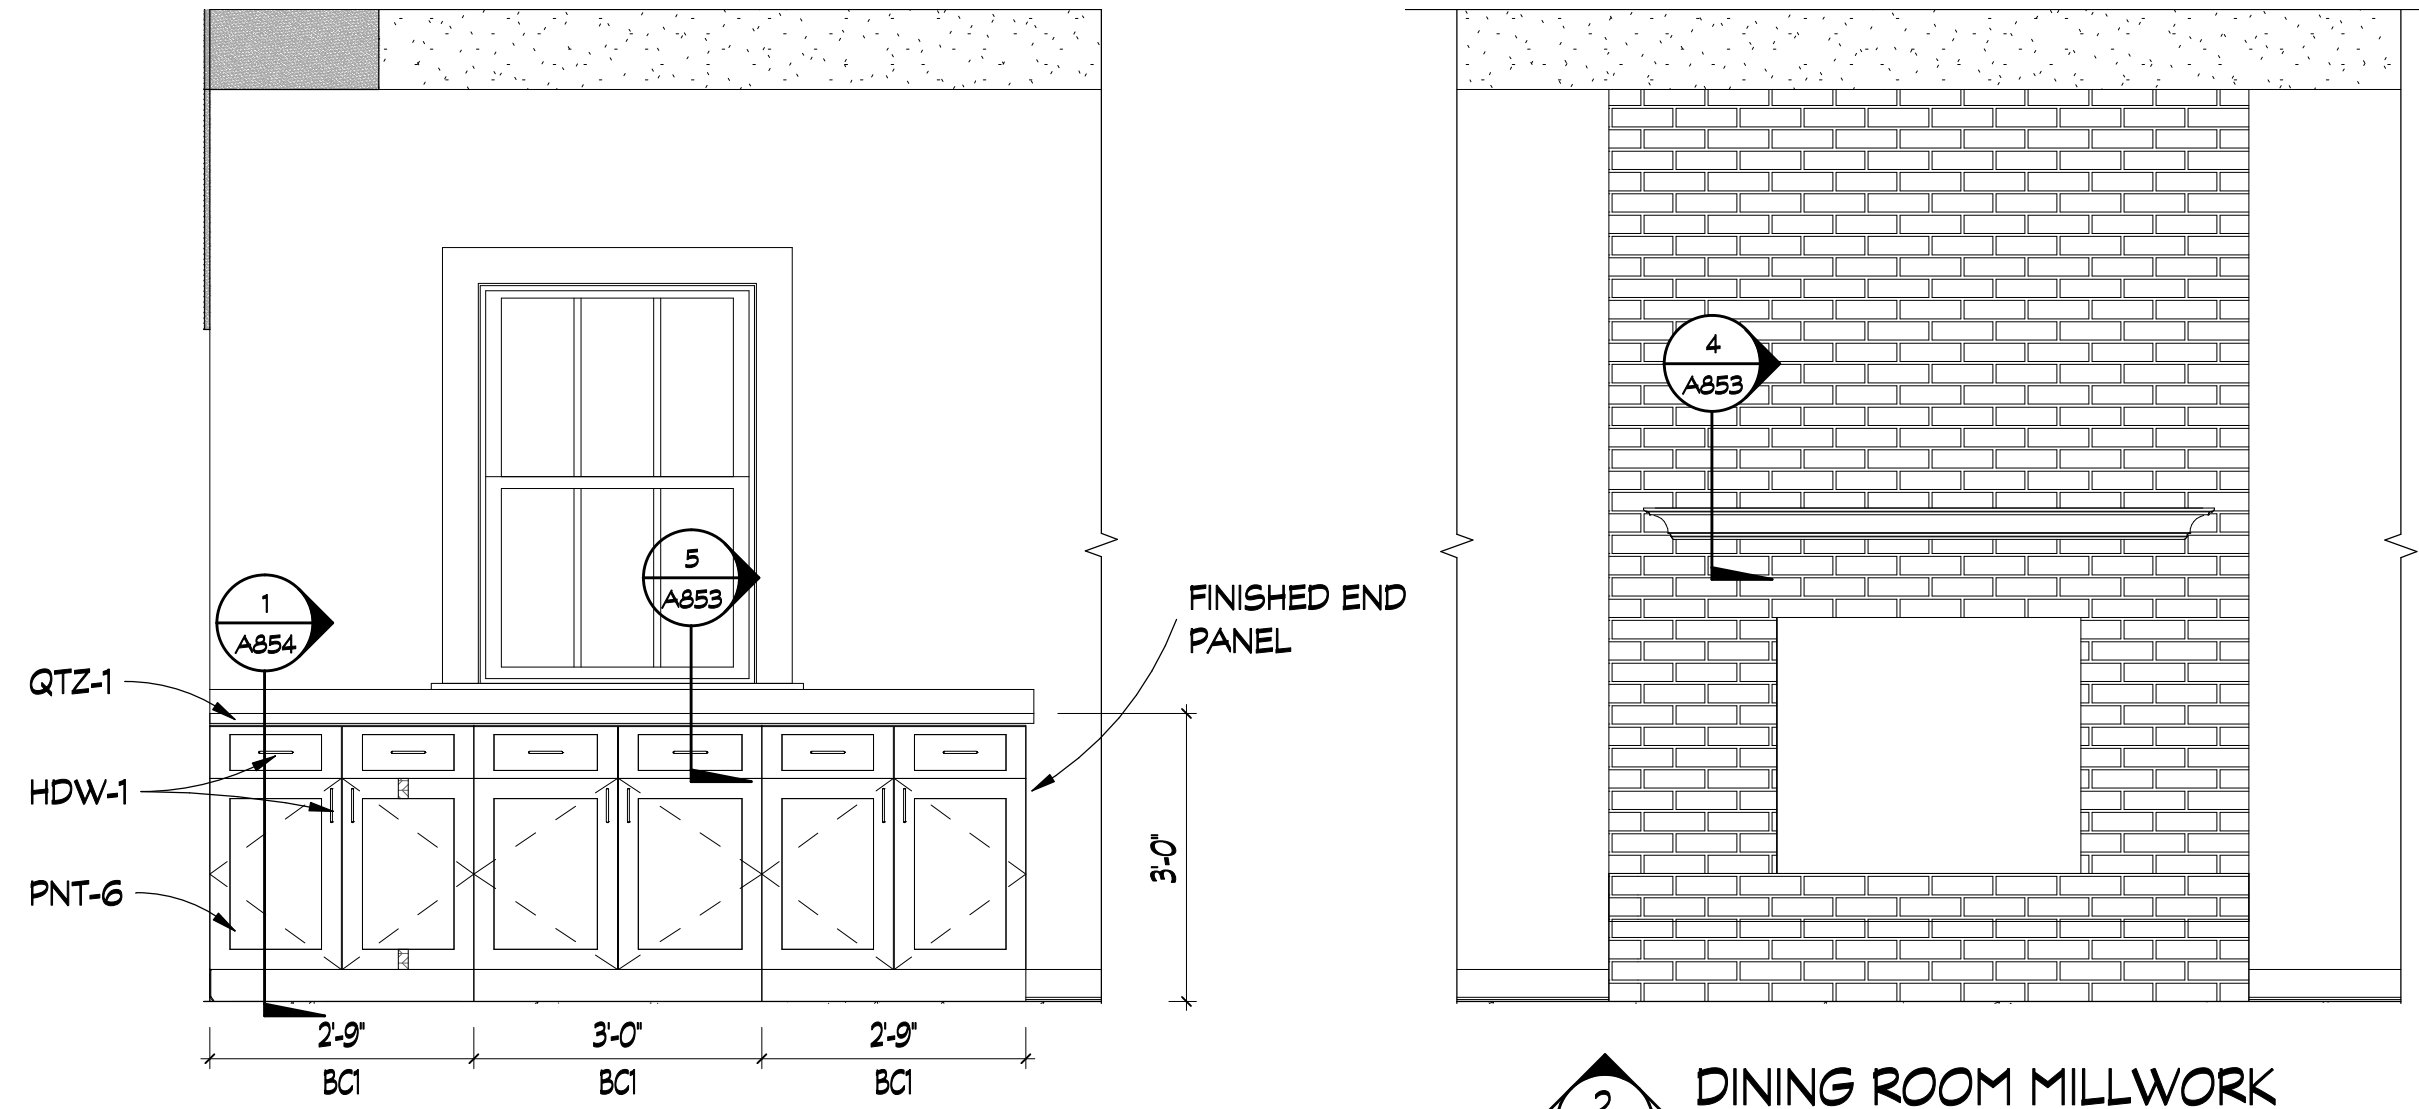


2 DINING ROOM MILLWORK
SCALE: 1/2" = 1'-0"

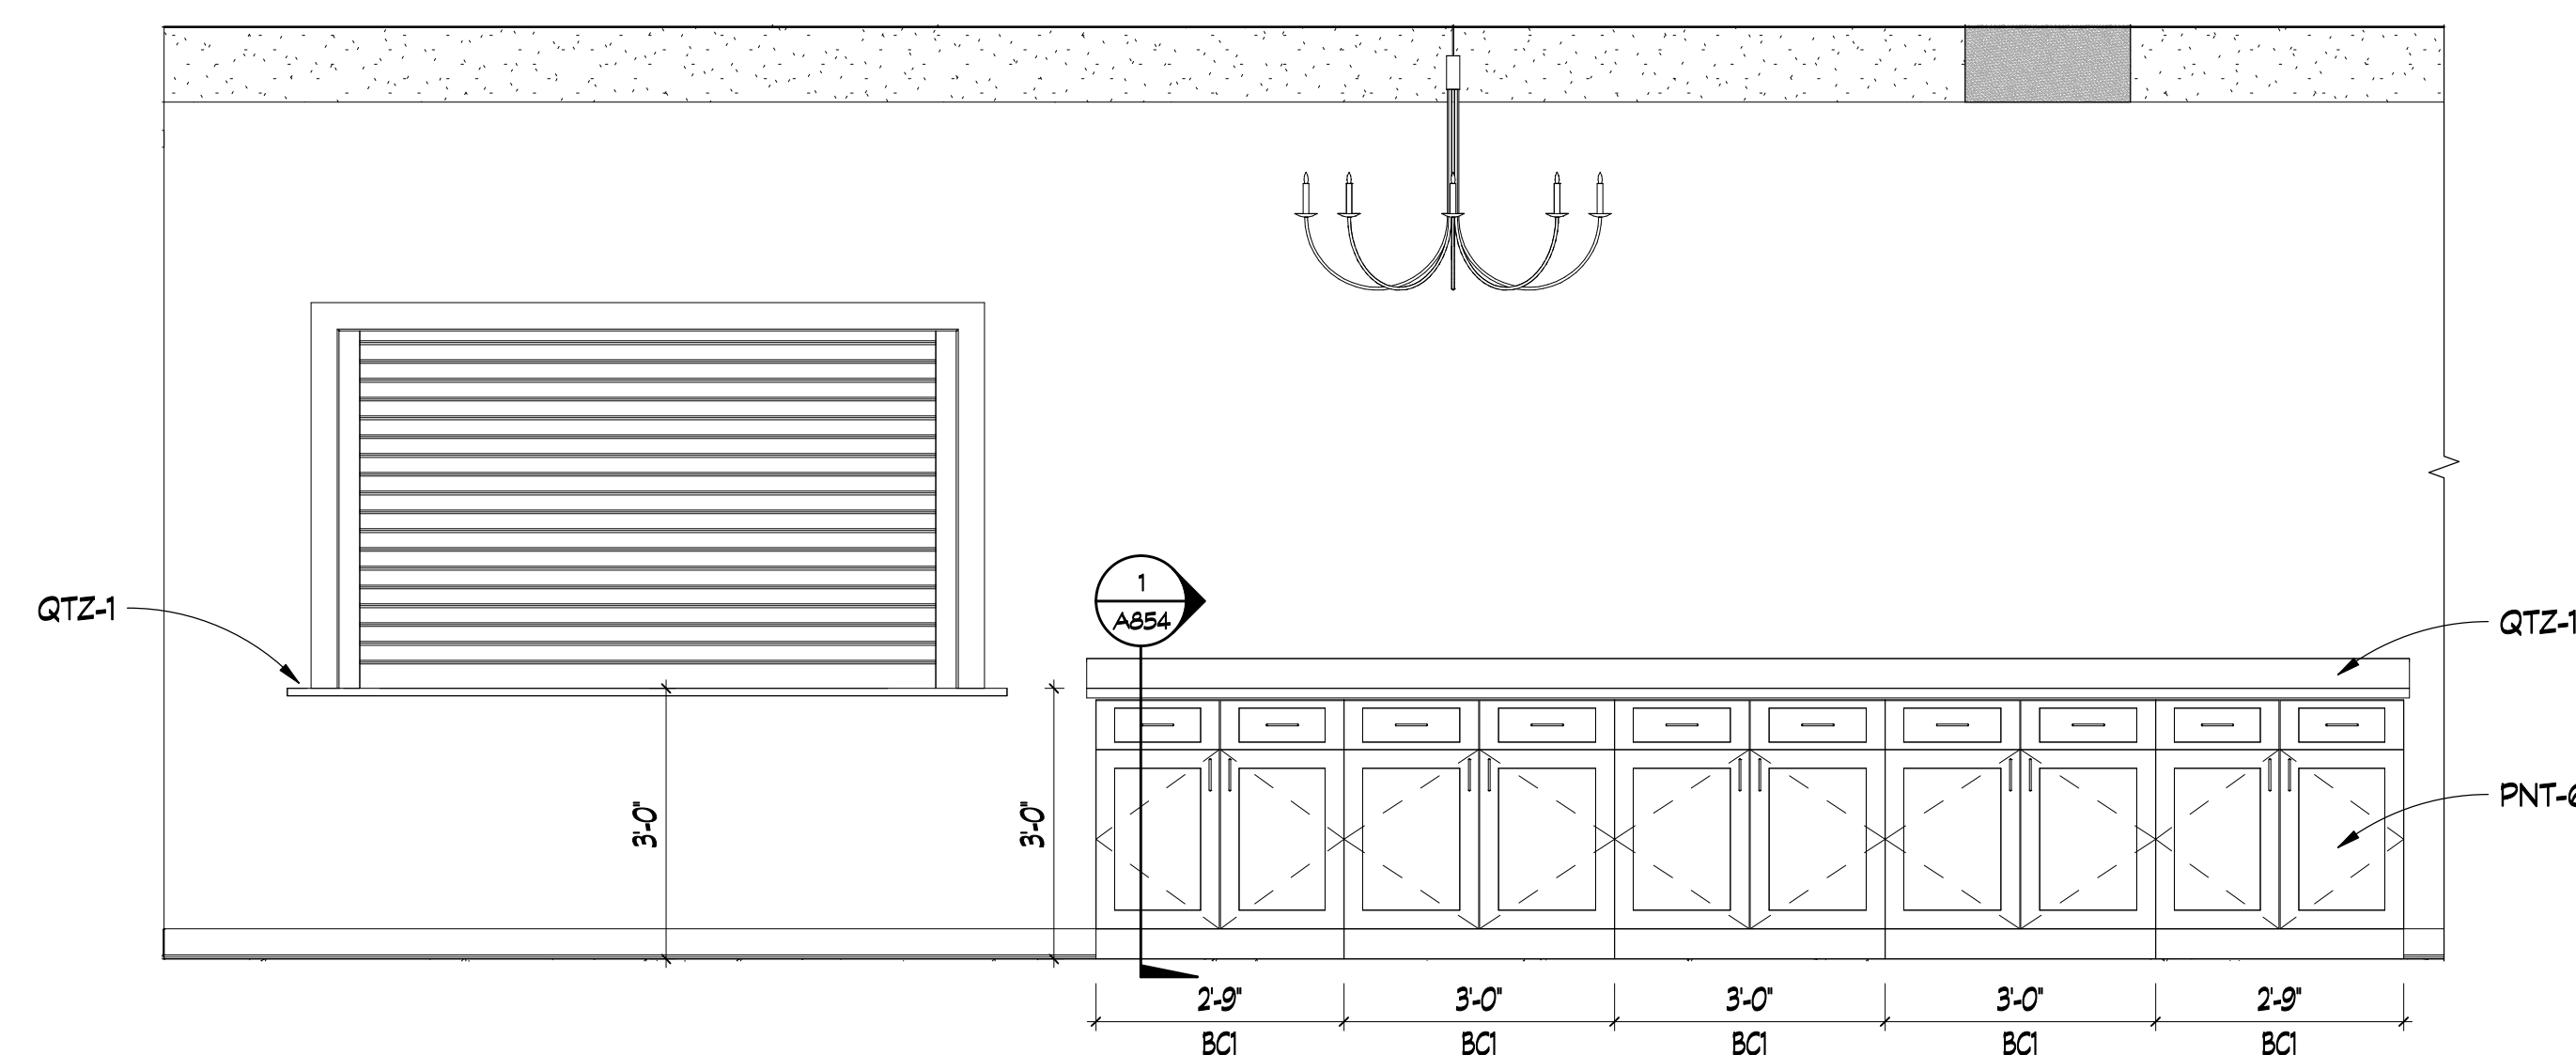


3 DINING ROOM MILLWORK
SCALE: 1/2" = 1'-0"

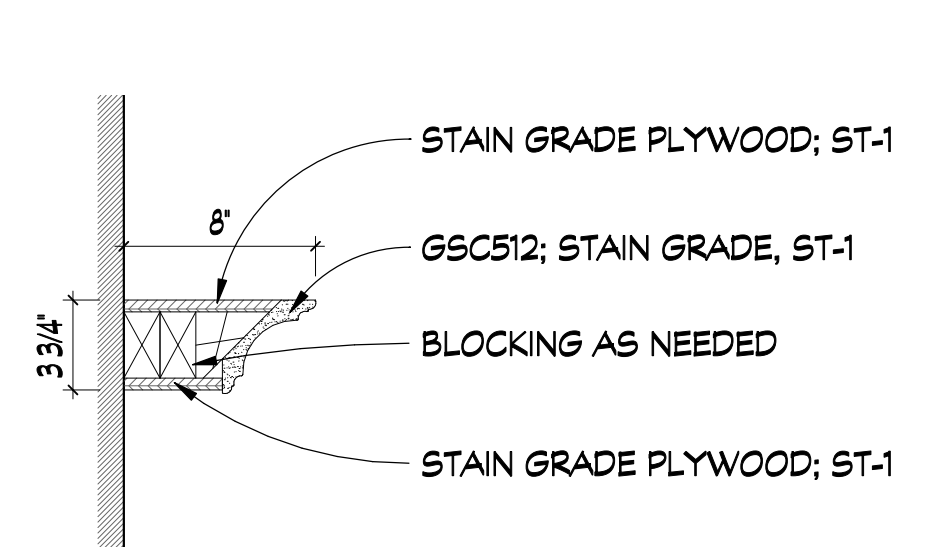

4 MANTLE DETAIL
SCALE: 1 1/2" = 1'-0"

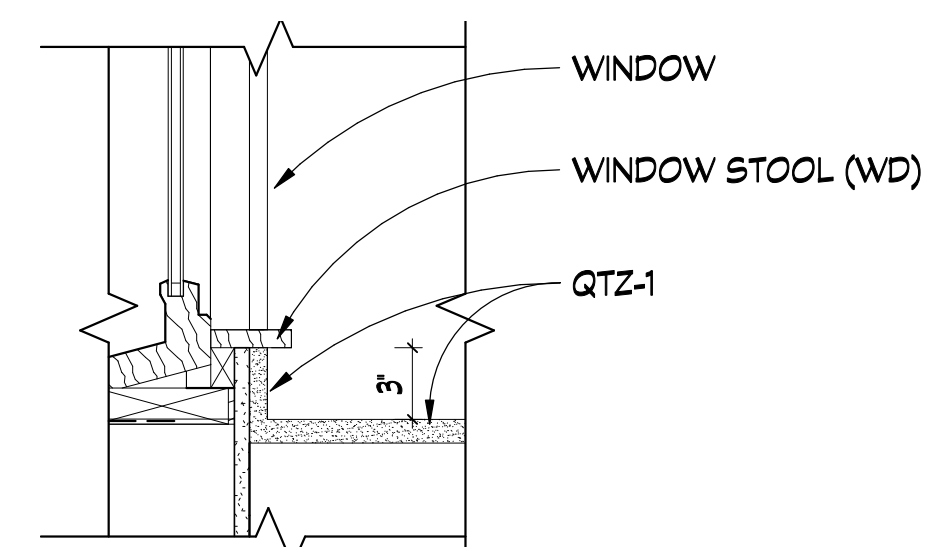


5 BACKSPLASH DETAIL @ DINING ROOM WINDOWS
SCALE: 1 1/2" = 1'-0"

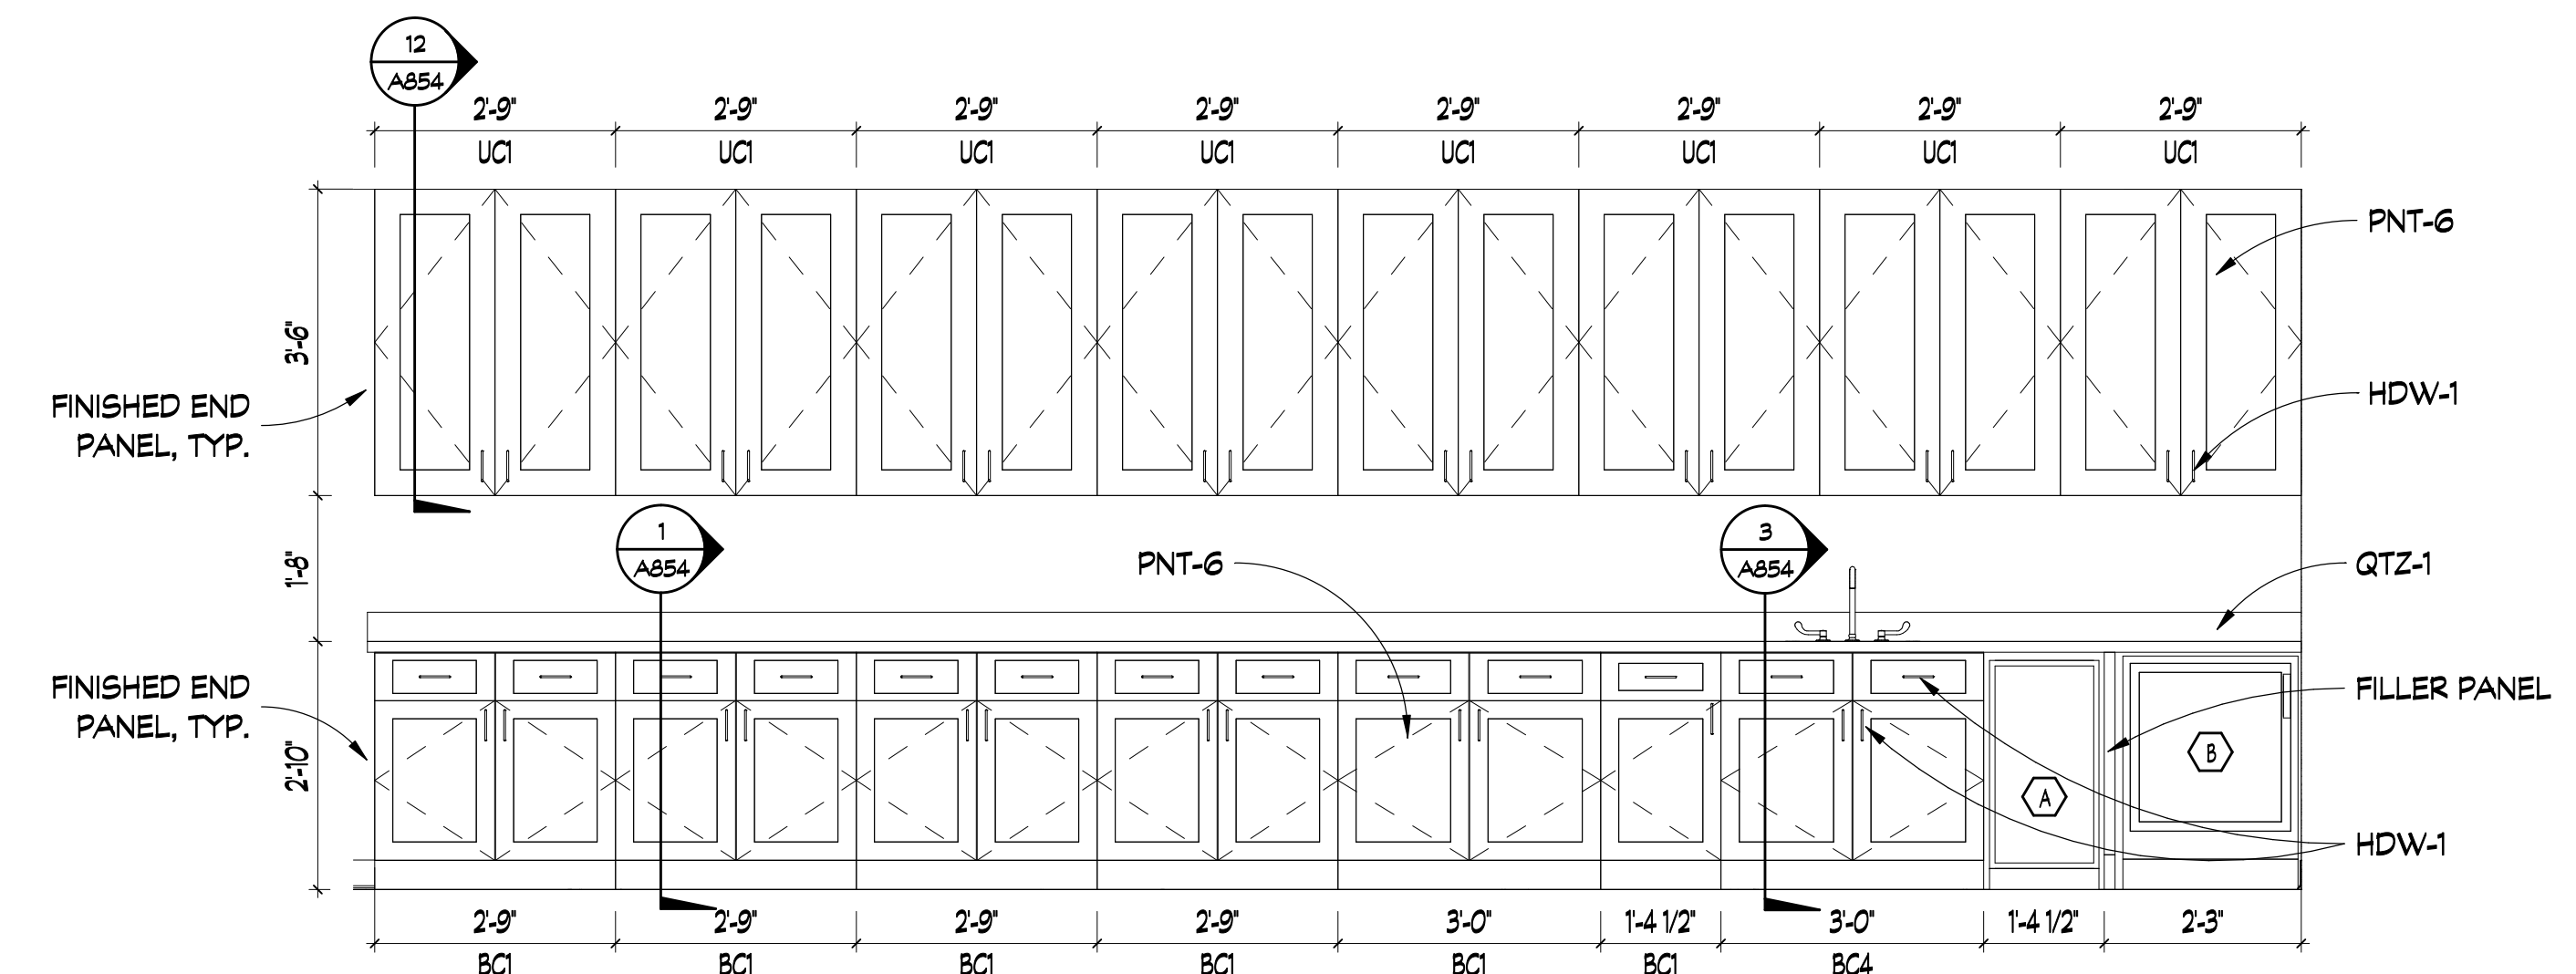


12 BRAIN HEALTH CENTER MILLWORK
SCALE: 1/2" = 1'-0"

** COORDINATE APPLIANCES WITH OWNER BEFORE MILLWORK FABRICATION

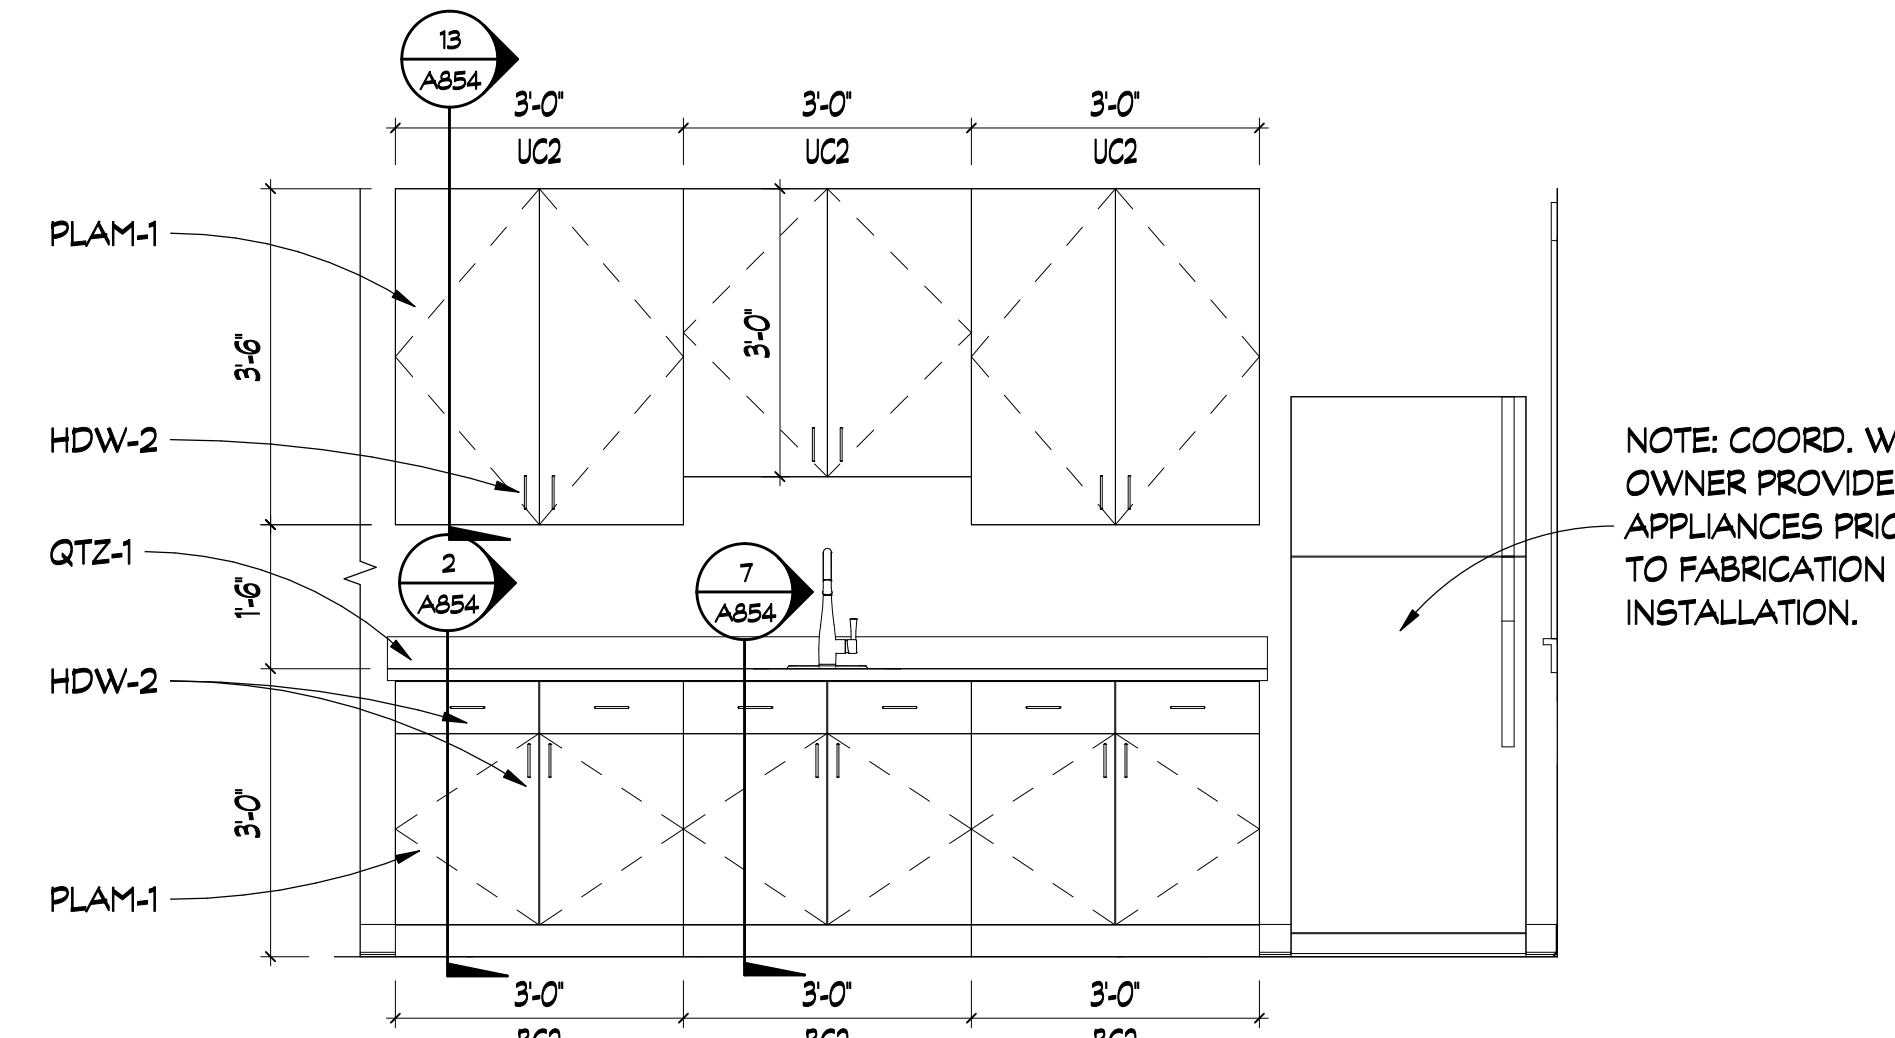


13 BREAK ROOM MILLWORK
SCALE: 1/2" = 1'-0"


NOTE: COORD. W/ OWNER PROVIDED APPLIANCES PRIOR TO FABRICATION / INSTALLATION.

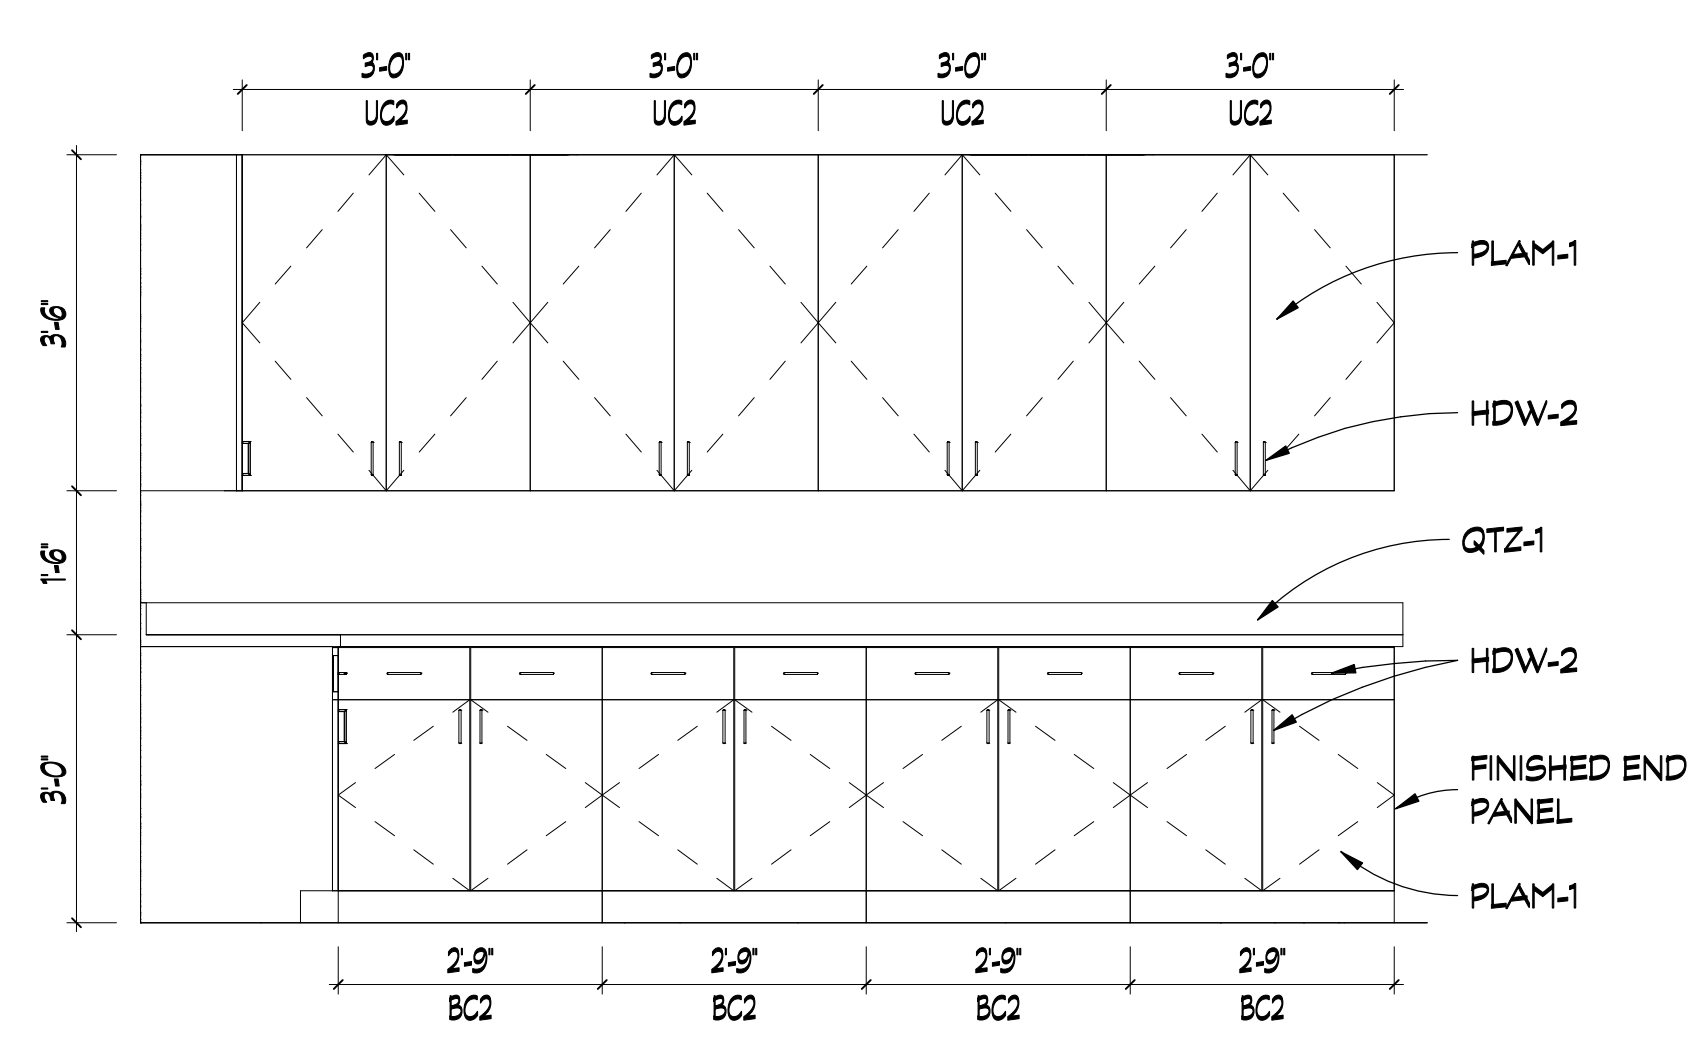


6 COPY ROOM MILLWORK
SCALE: 1/2" = 1'-0"

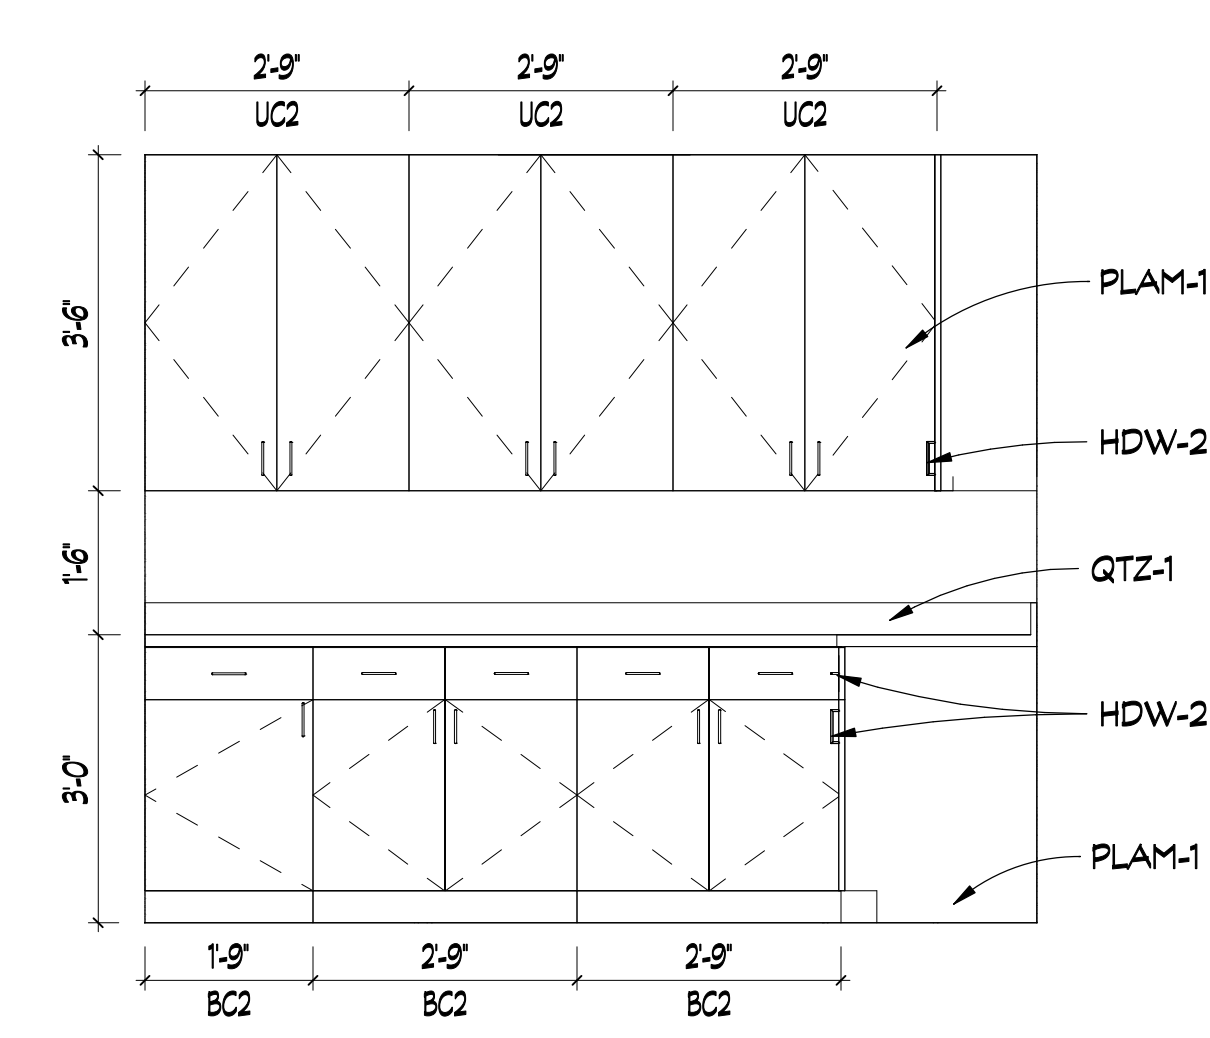


7 COPY ROOM MILLWORK
SCALE: 1/2" = 1'-0"

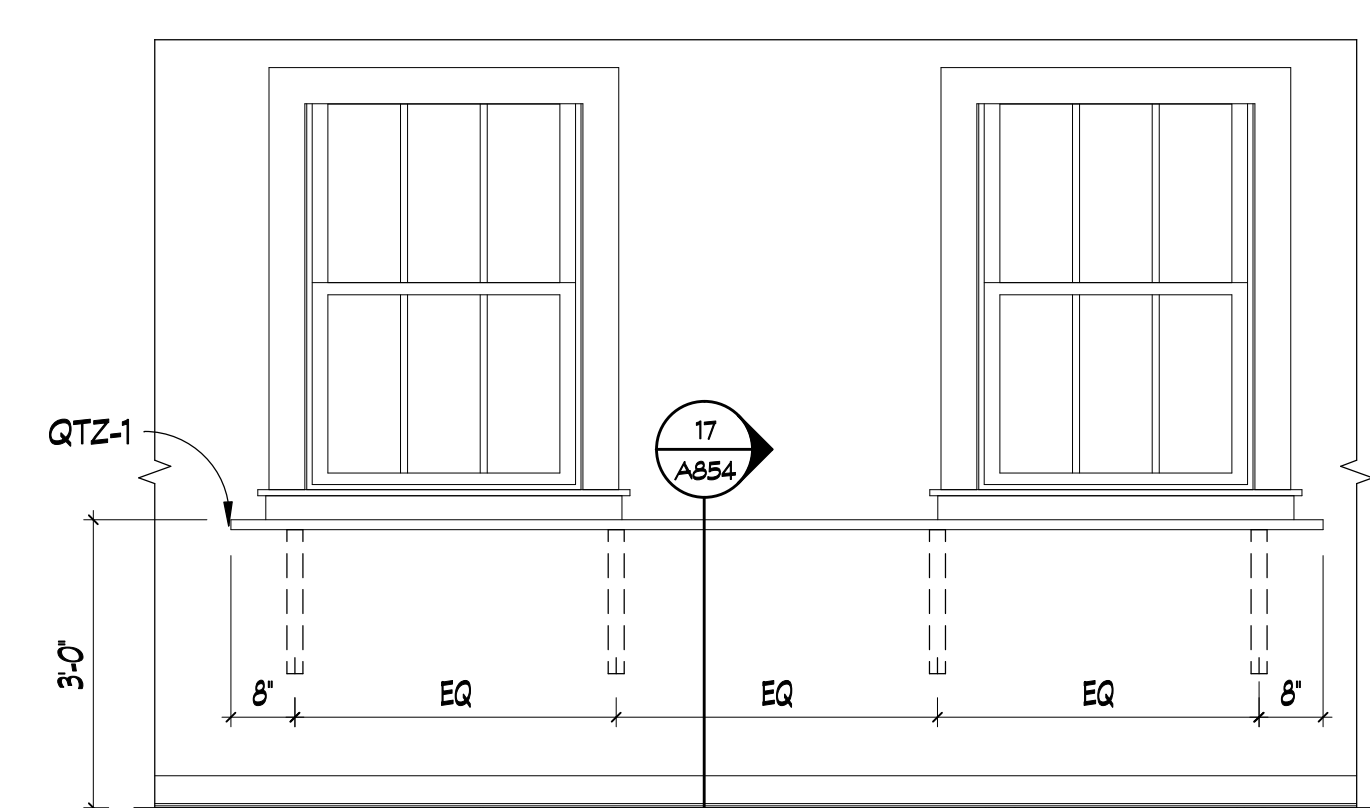


8 FILE ROOM MILLWORK
SCALE: 1/2" = 1'-0"

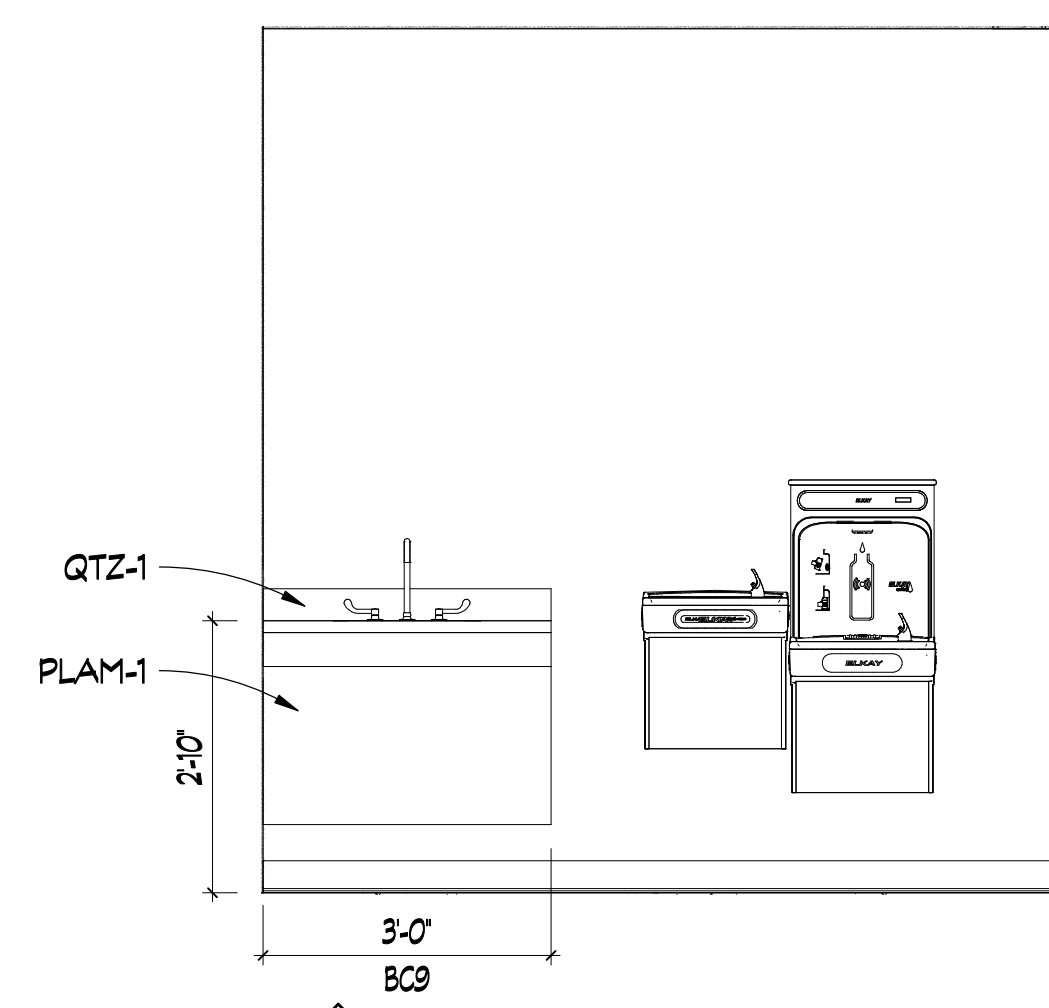

9 HAND WASHING STATION
SCALE: 1/2" = 1'-0"

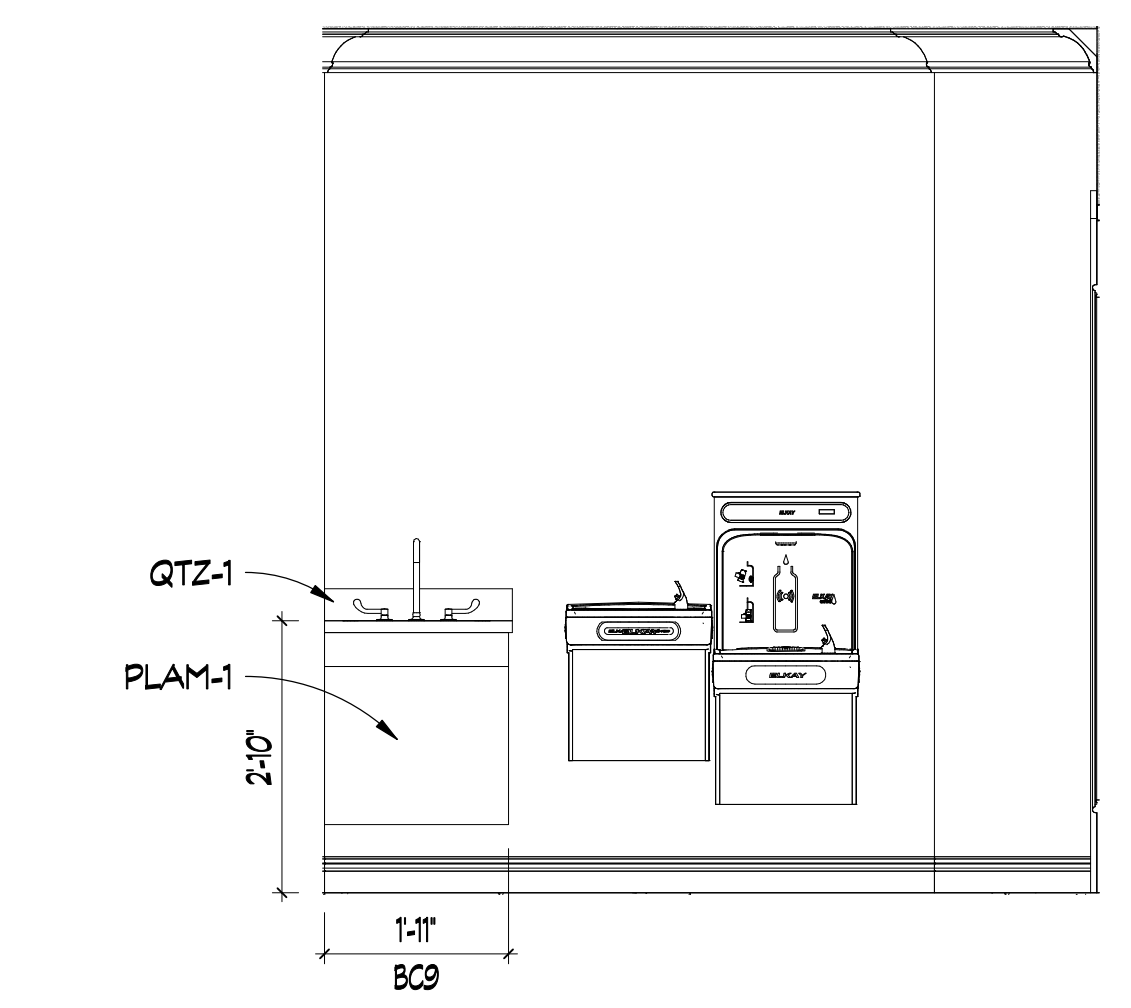

10 HAND WASHING STATION @ SIDE ENTRANCE
SCALE: 1/2" = 1'-0"

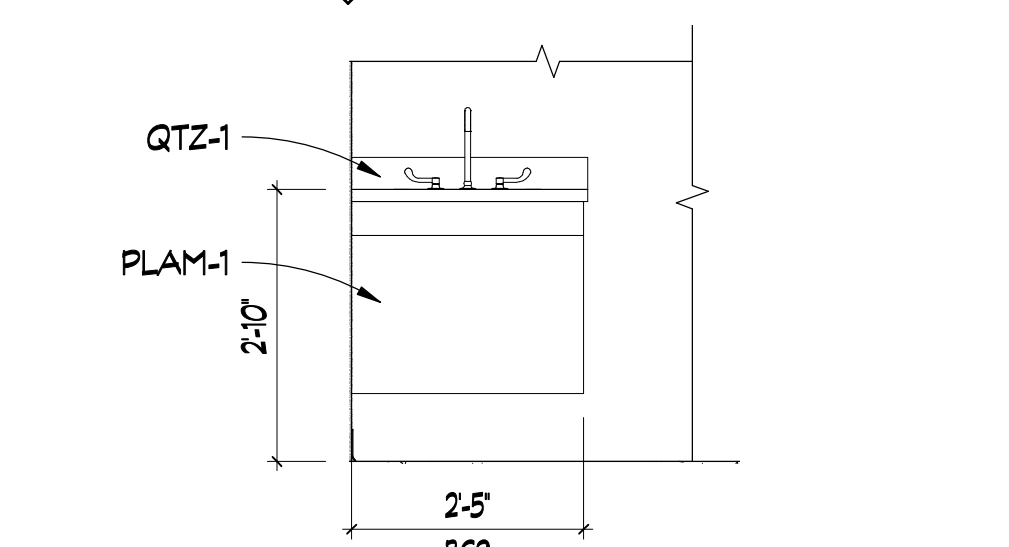



11 HAND WASHING STATION @ SALON
SCALE: 1/2" = 1'-0"

MILLWORK KEY
BC# - BASE CABINET
UC# - UPPER CABINET
TCH - TALL CABINET


MILLWORK NOTES

- SEE ELEVATIONS FOR BACKSPLASH HEIGHTS
- COORDINATE ALL APPLIANCES WITH OWNER PRIOR TO MILLWORK FABRICATION

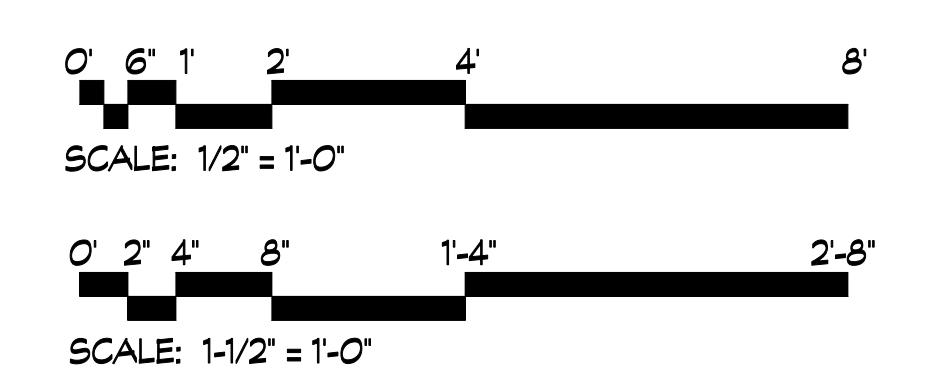


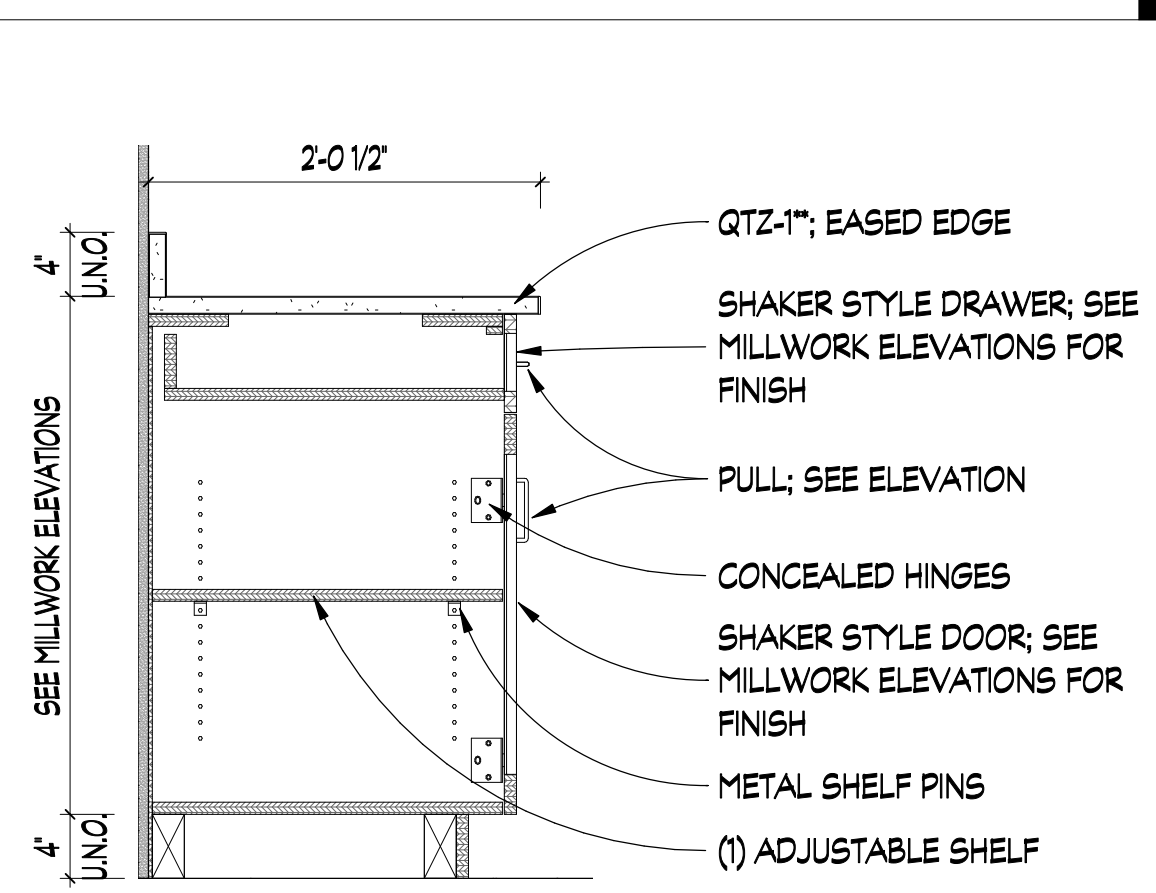


1 BC1
SCALE: 1" = 1'-0"

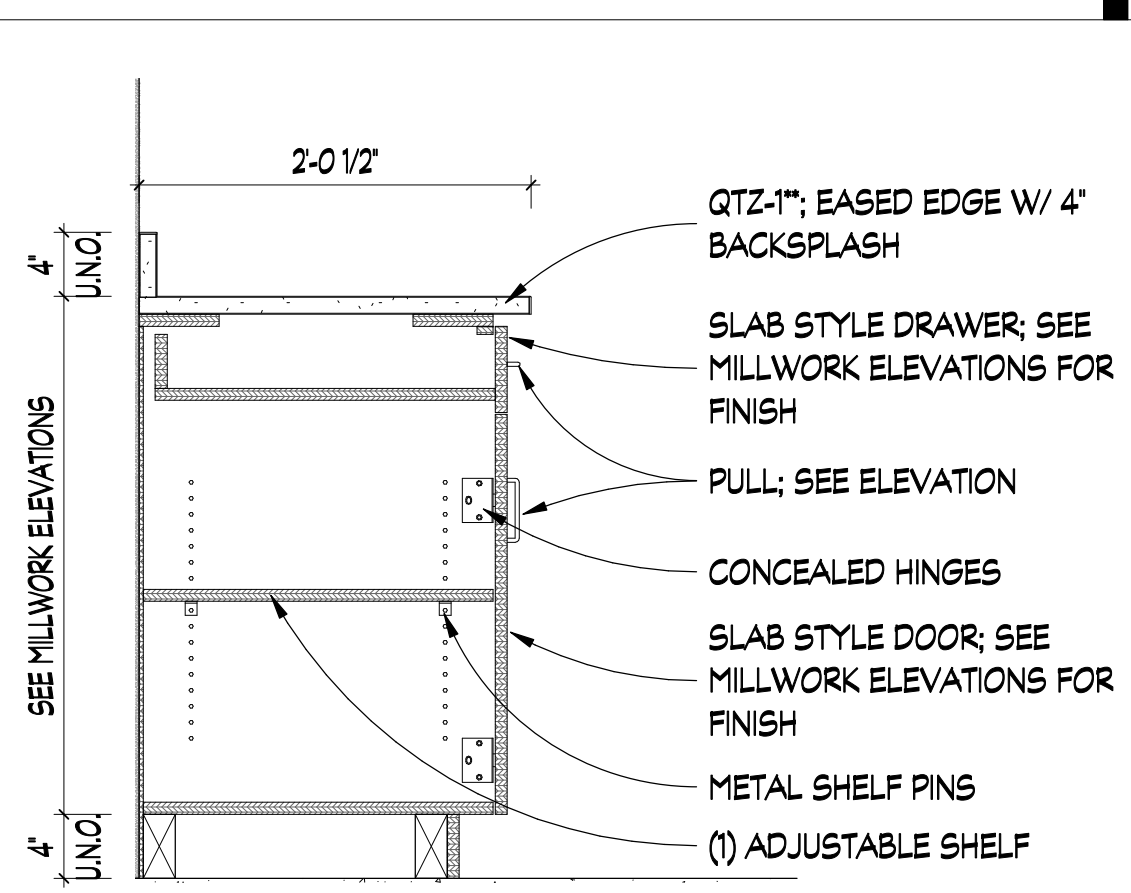


2 BC2
SCALE: 1" = 1'-0"

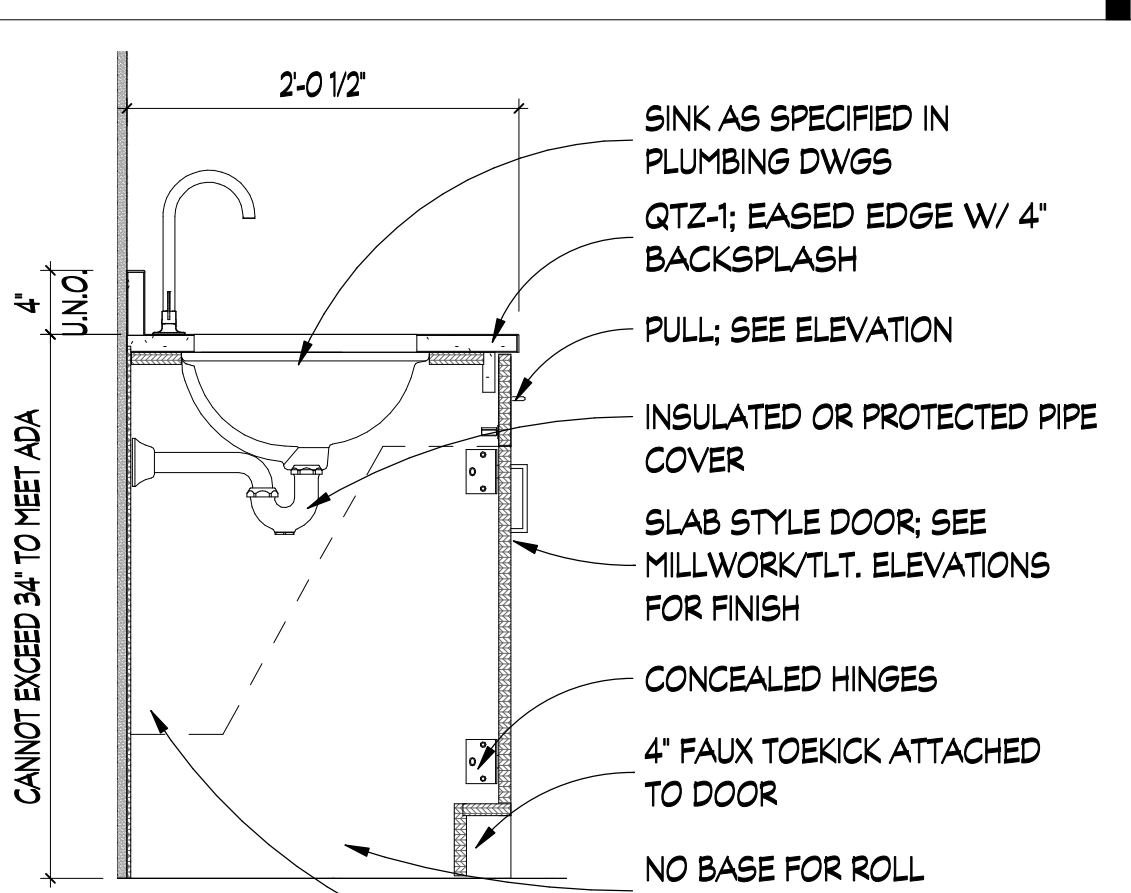


3 BC3
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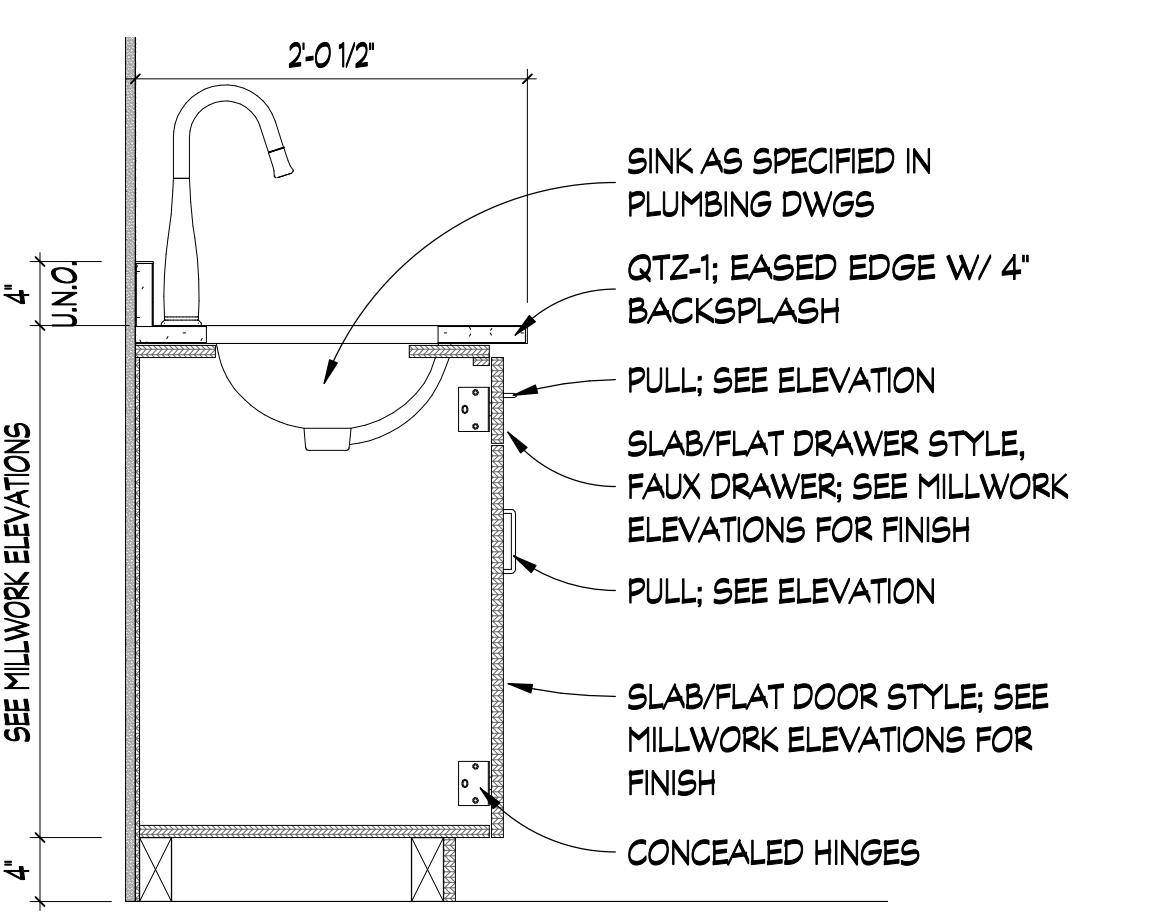
4 BC4
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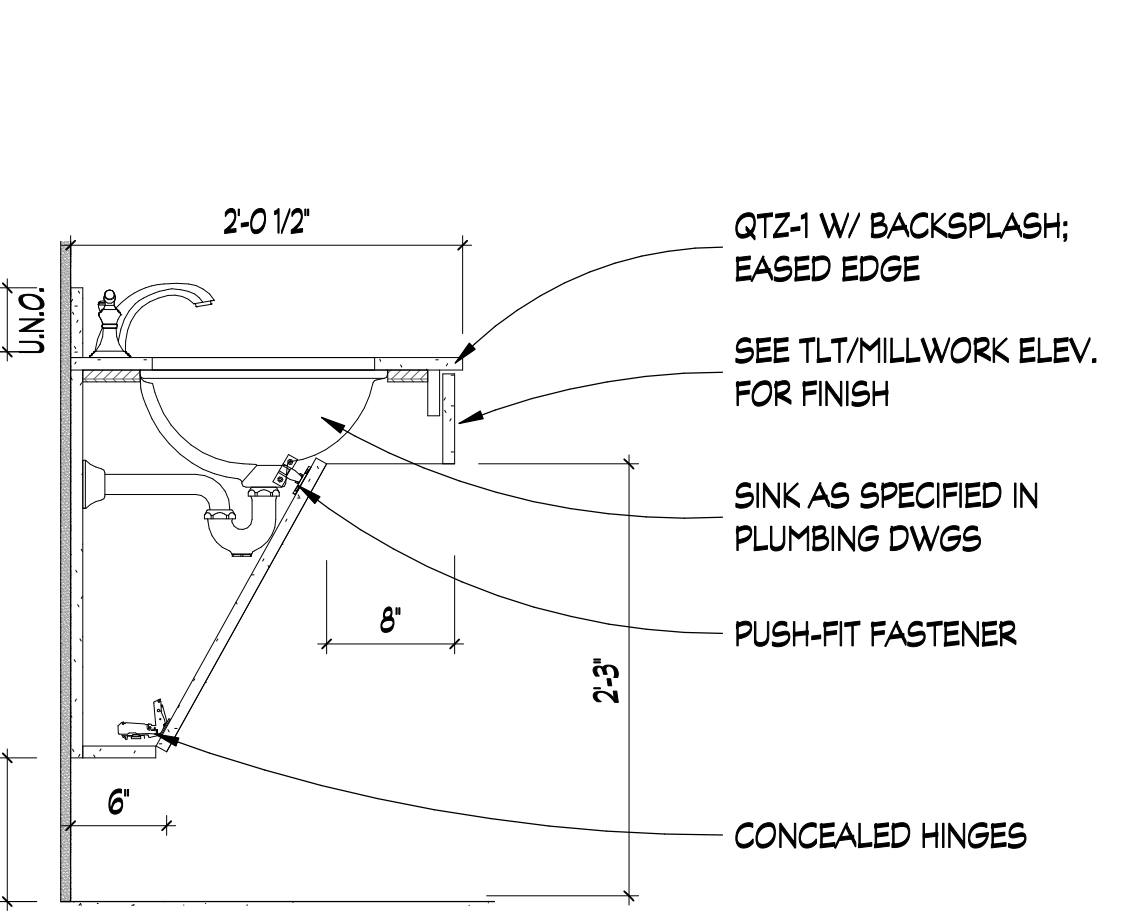
5 BC5
SCALE: 1" = 1'-0"

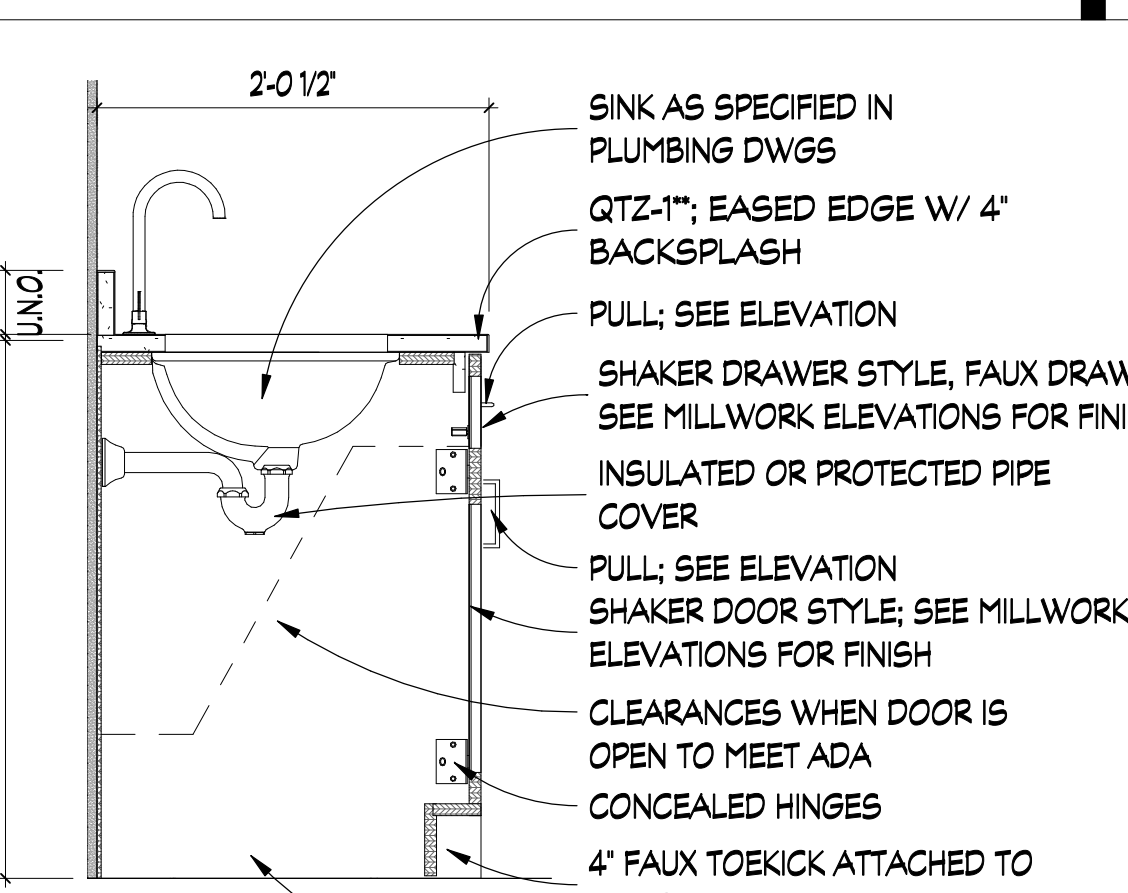


6 BC6
SCALE: 1" = 1'-0"

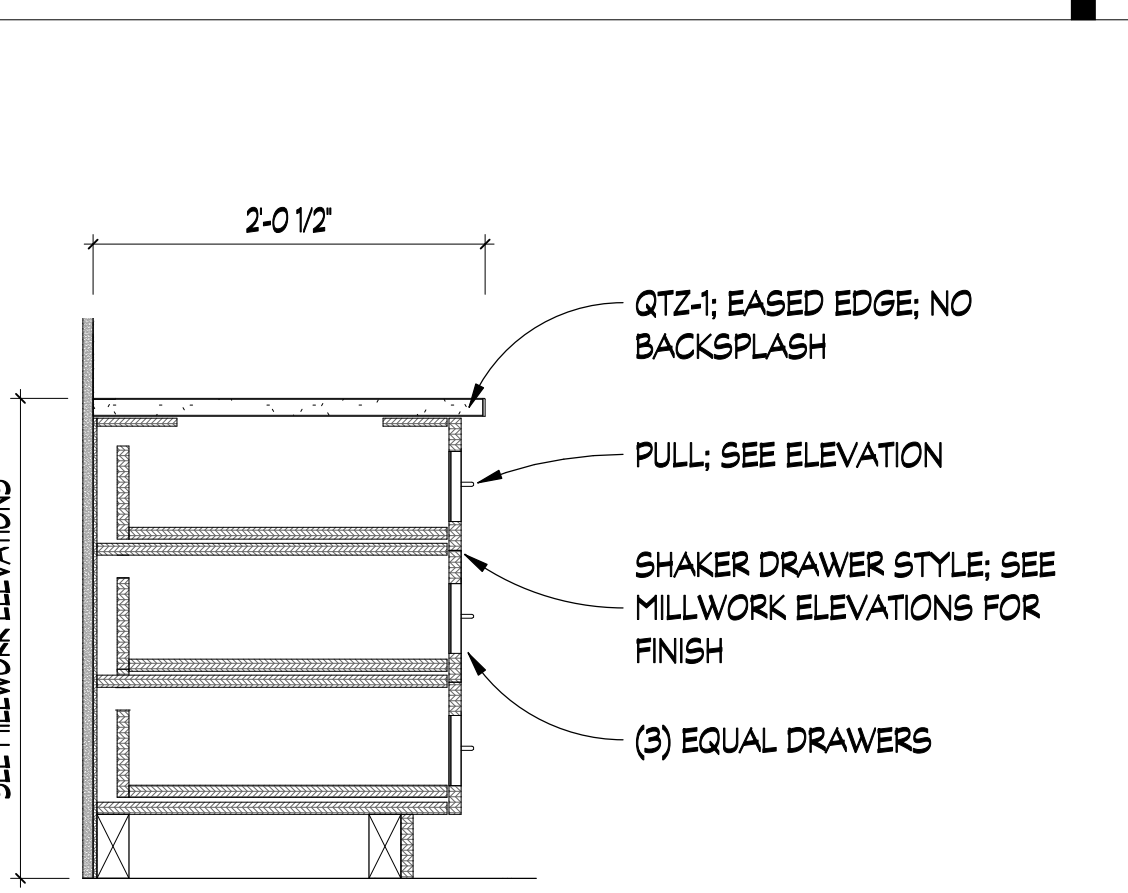


7 BC7
SCALE: 1" = 1'-0"

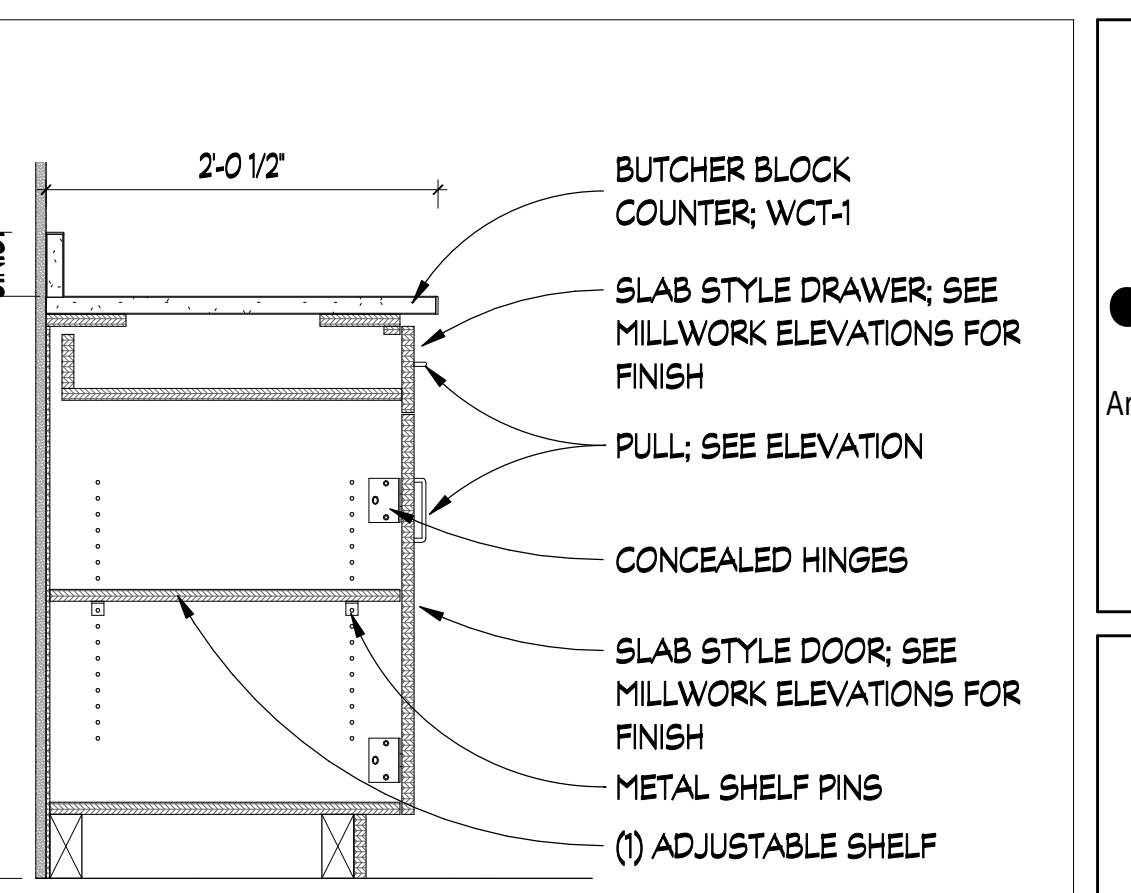


8 BC8
SCALE: 1" = 1'-0"

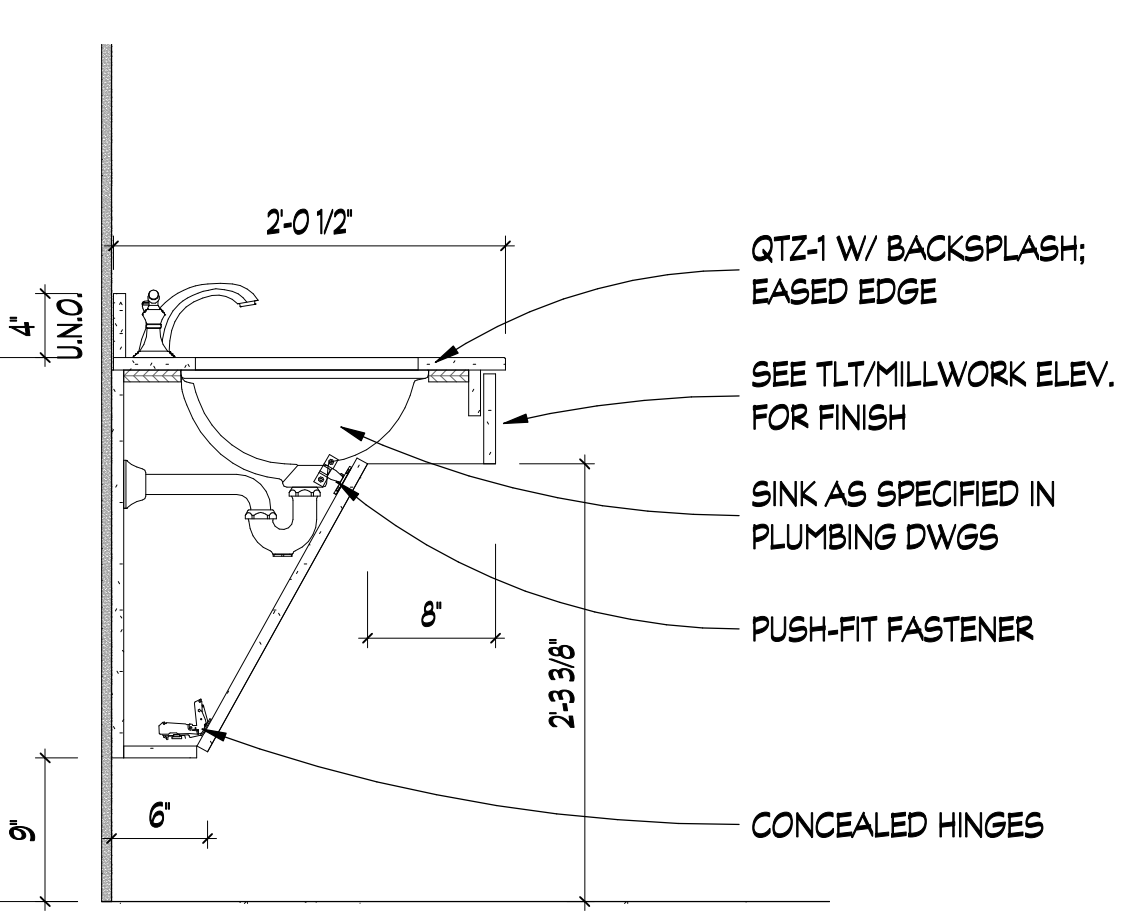


9 BC9
SCALE: 1" = 1'-0"

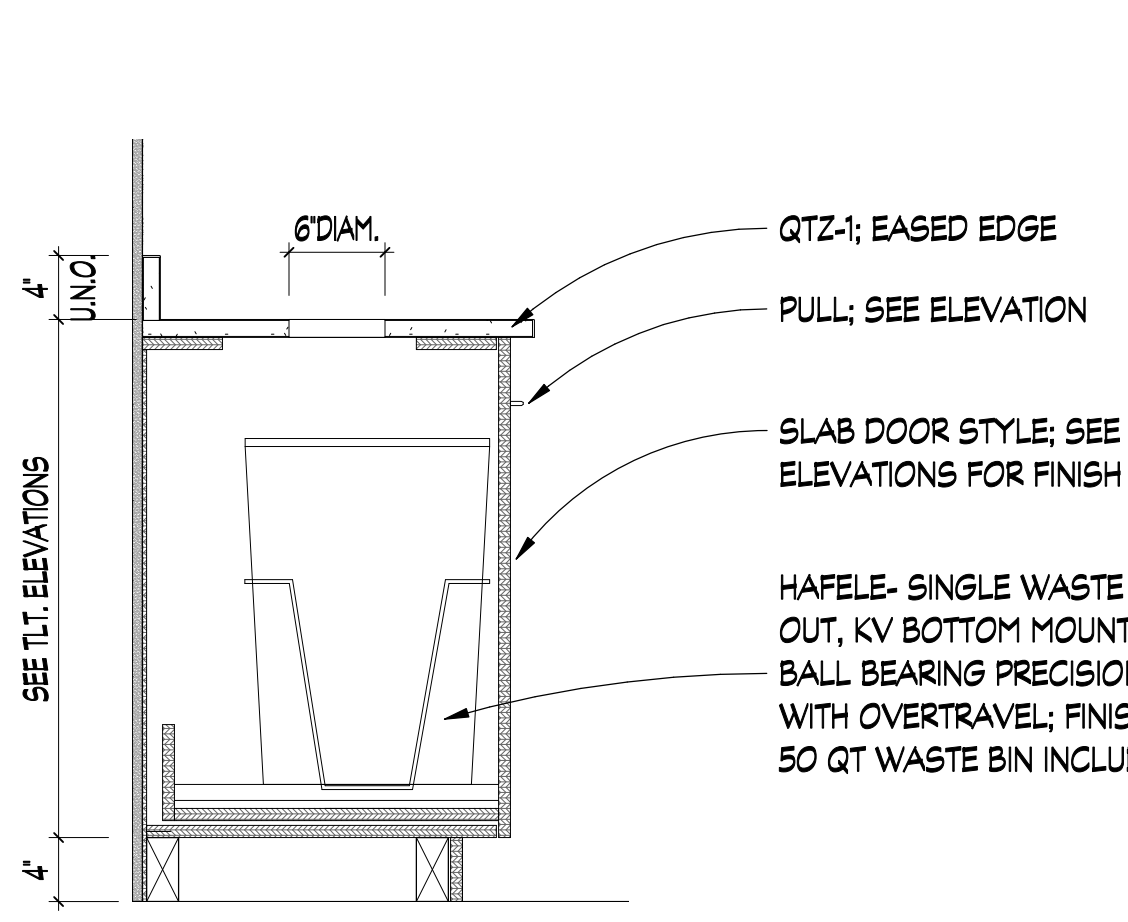


10 BC10
SCALE: 1" = 1'-0"

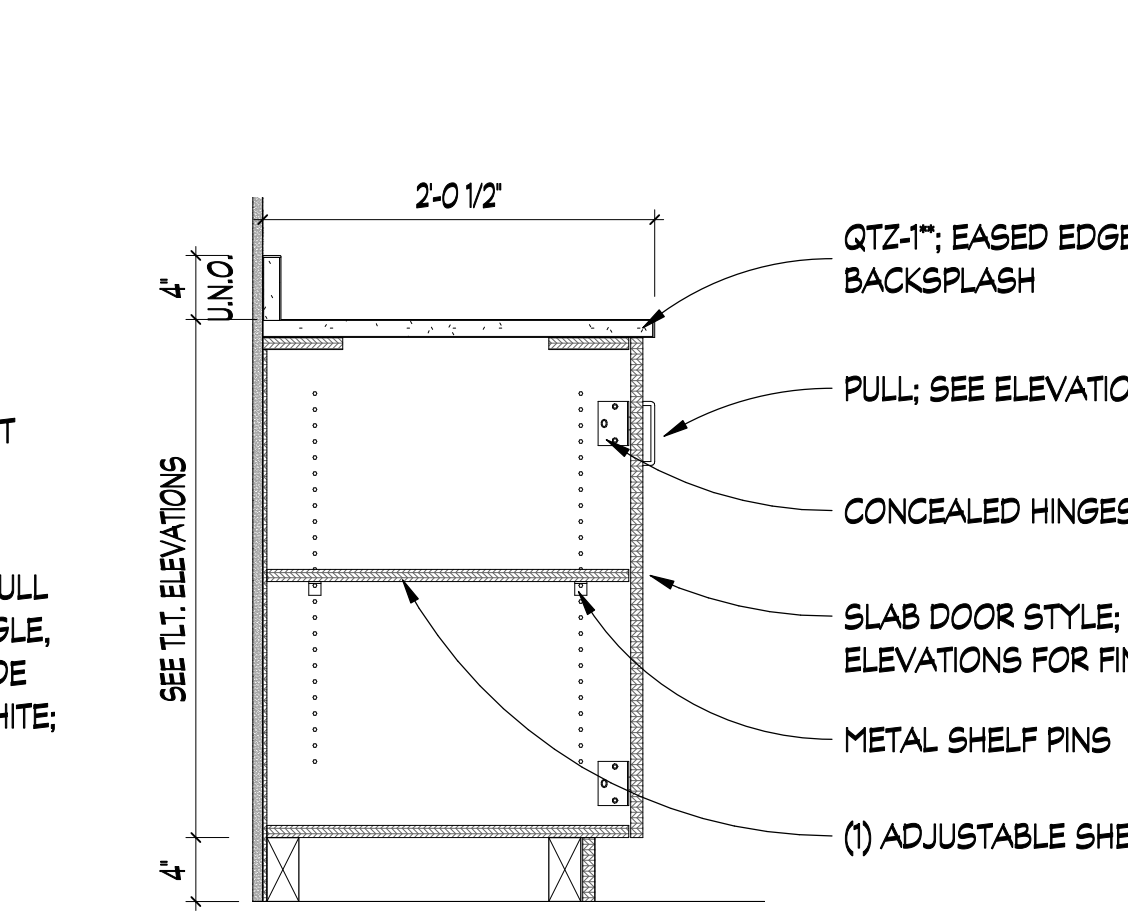


11 BC11
SCALE: 1" = 1'-0"

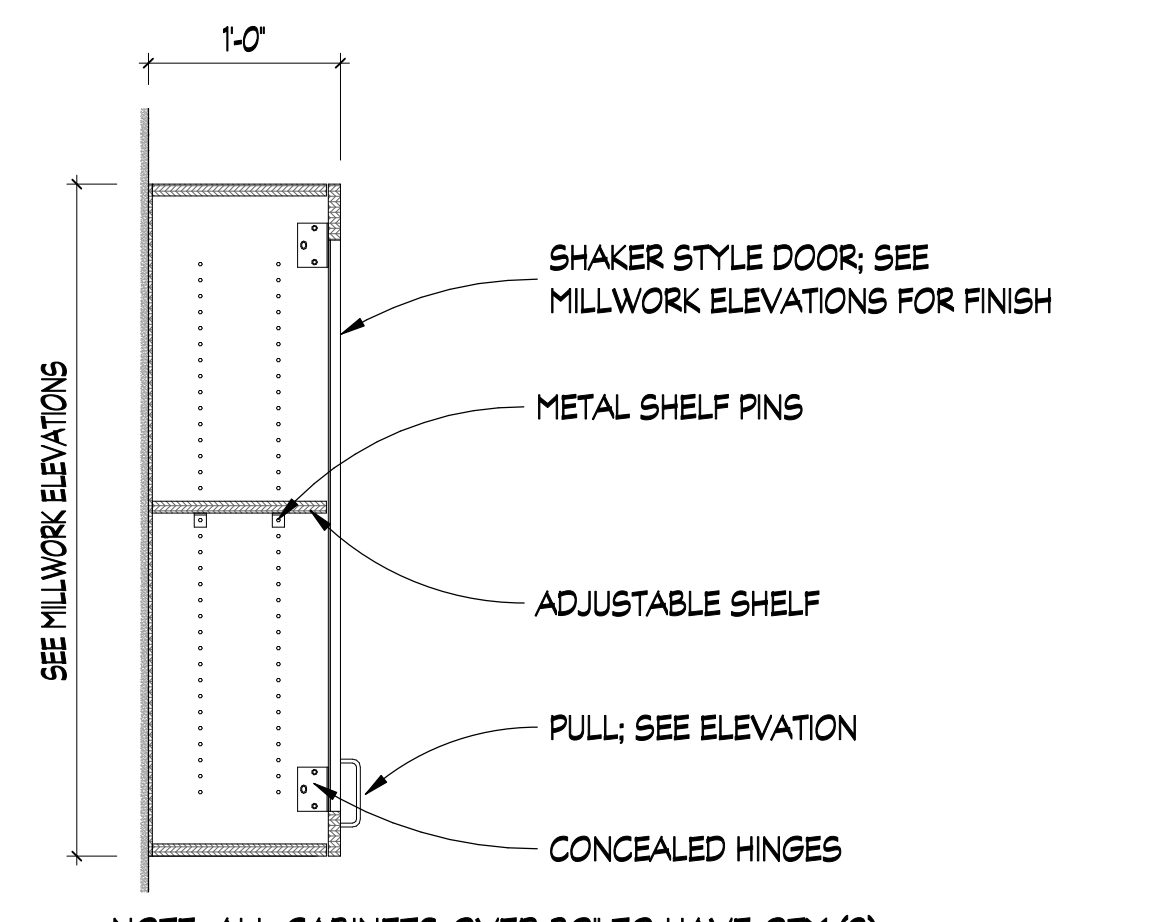


12 UC1
SCALE: 1" = 1'-0"

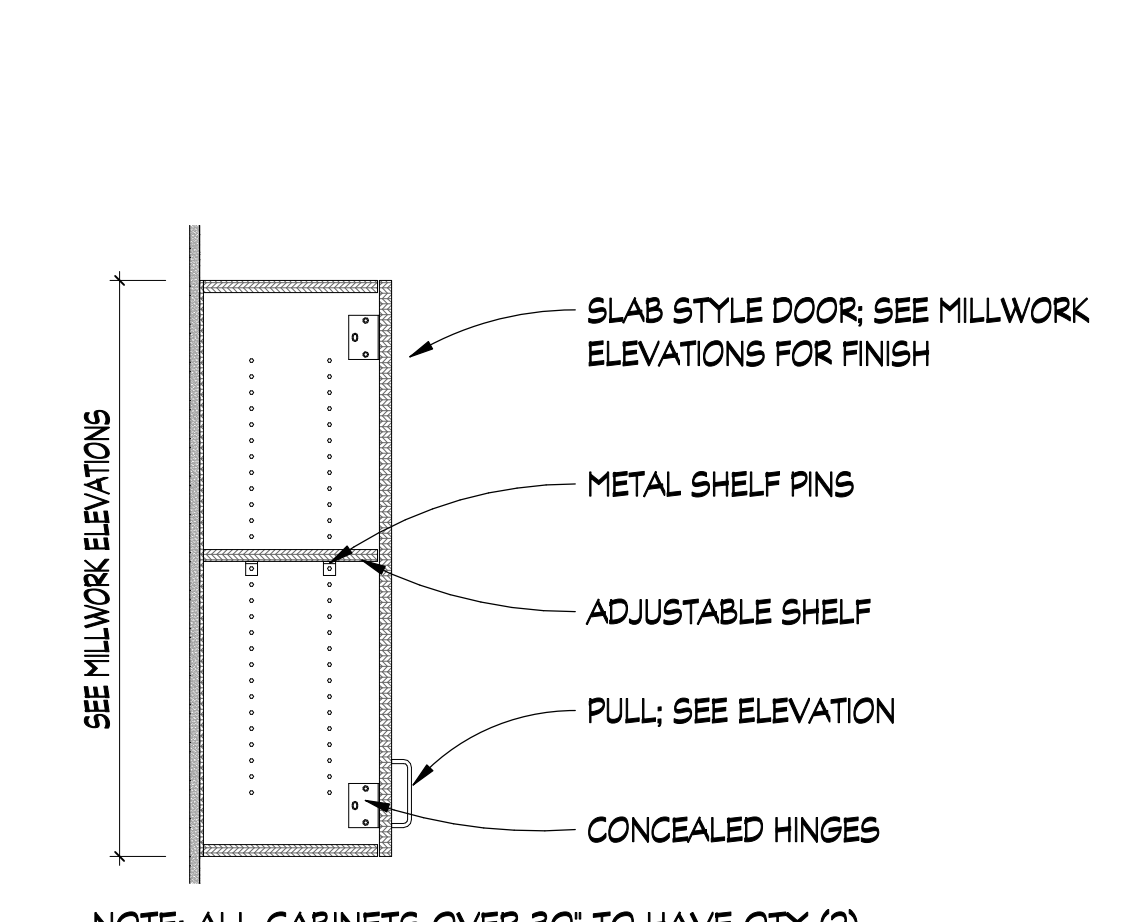


13 UC2
SCALE: 1" = 1'-0"

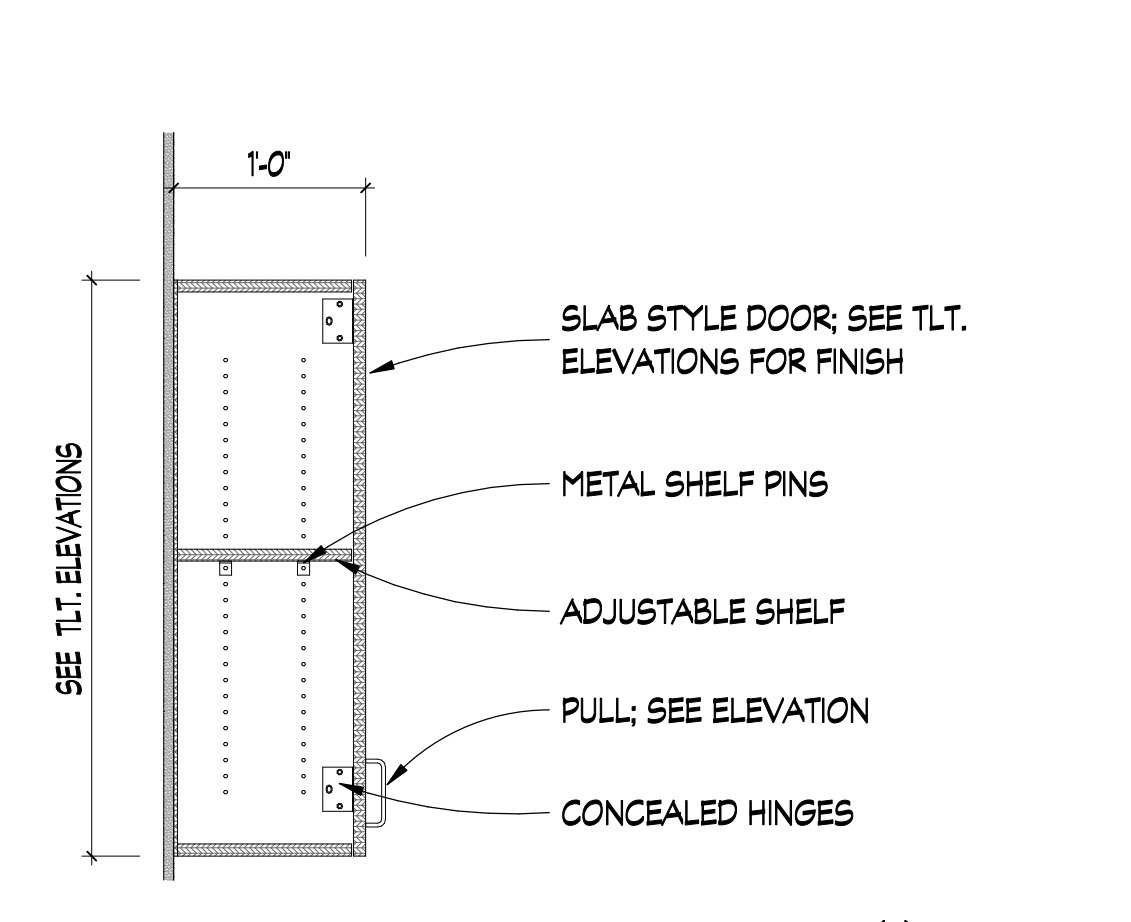


14 UC3
SCALE: 1" = 1'-0"

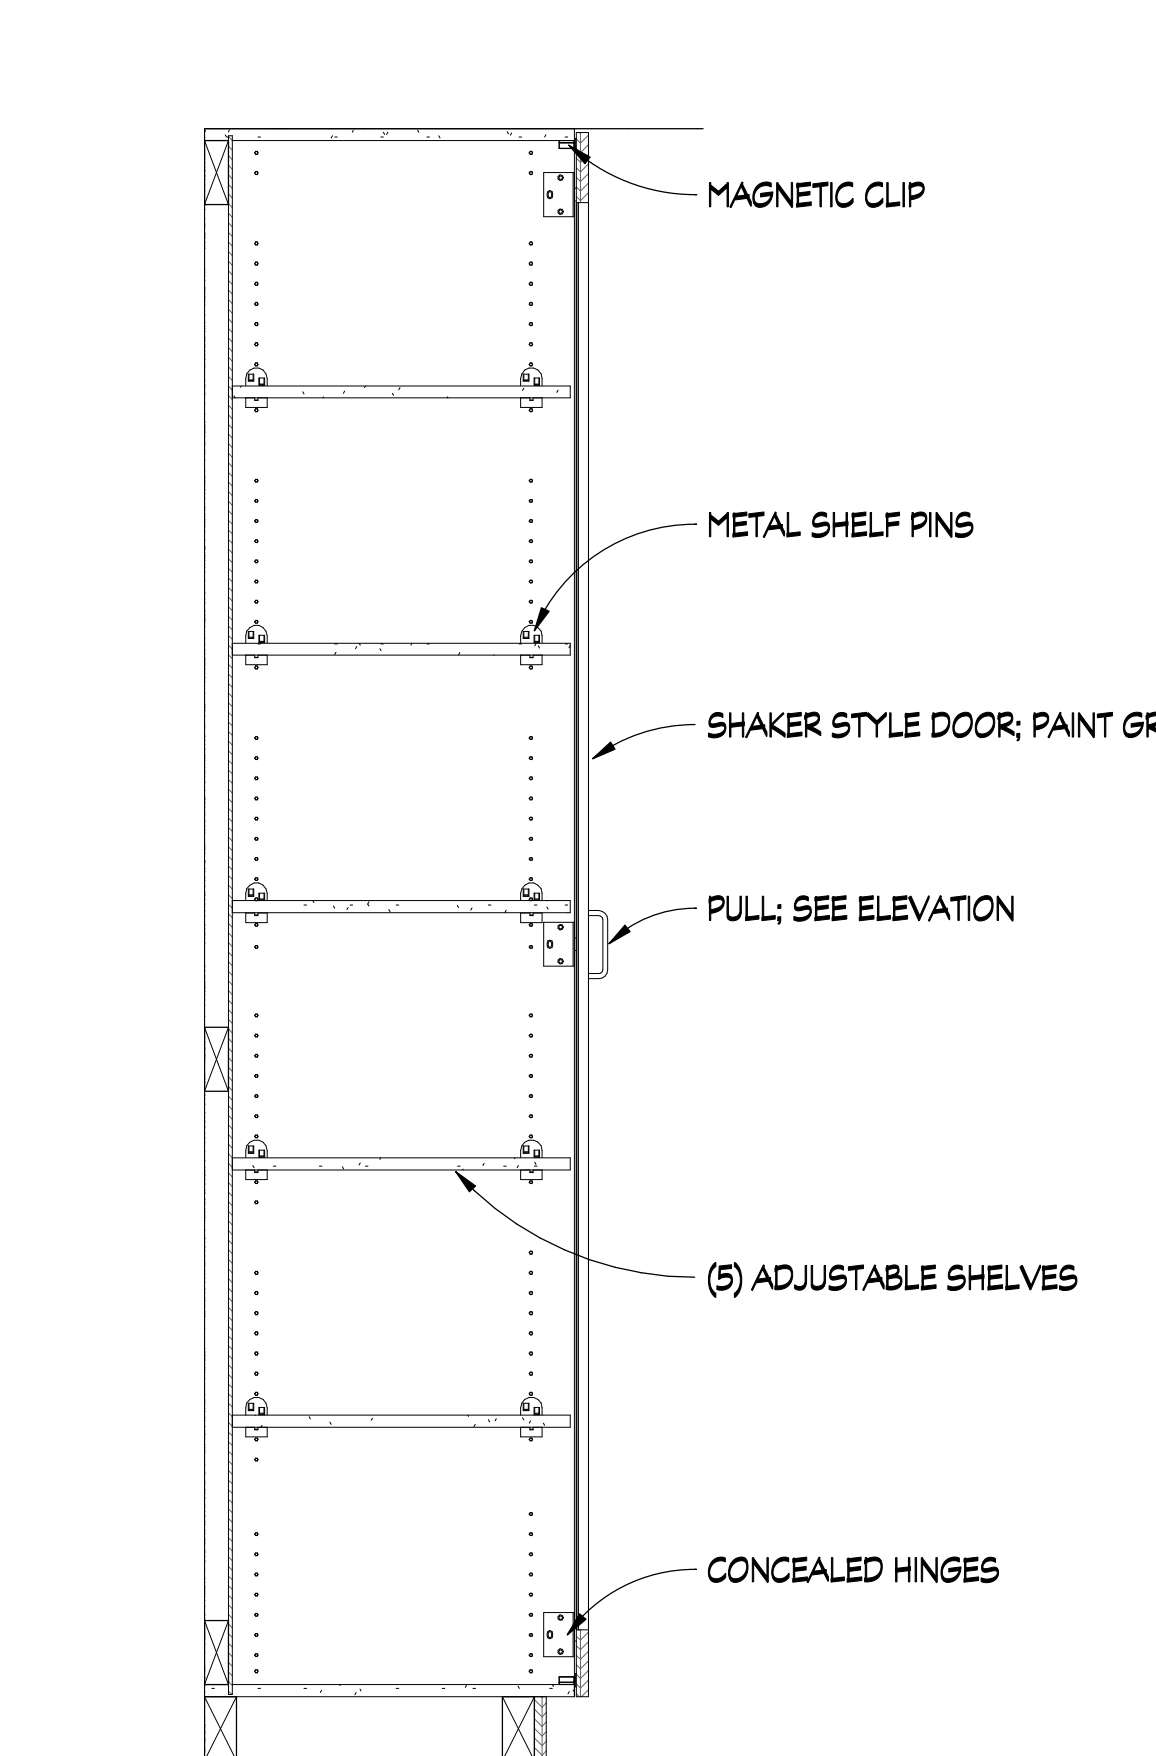

15 TC1
SCALE: 1" = 1'-0"

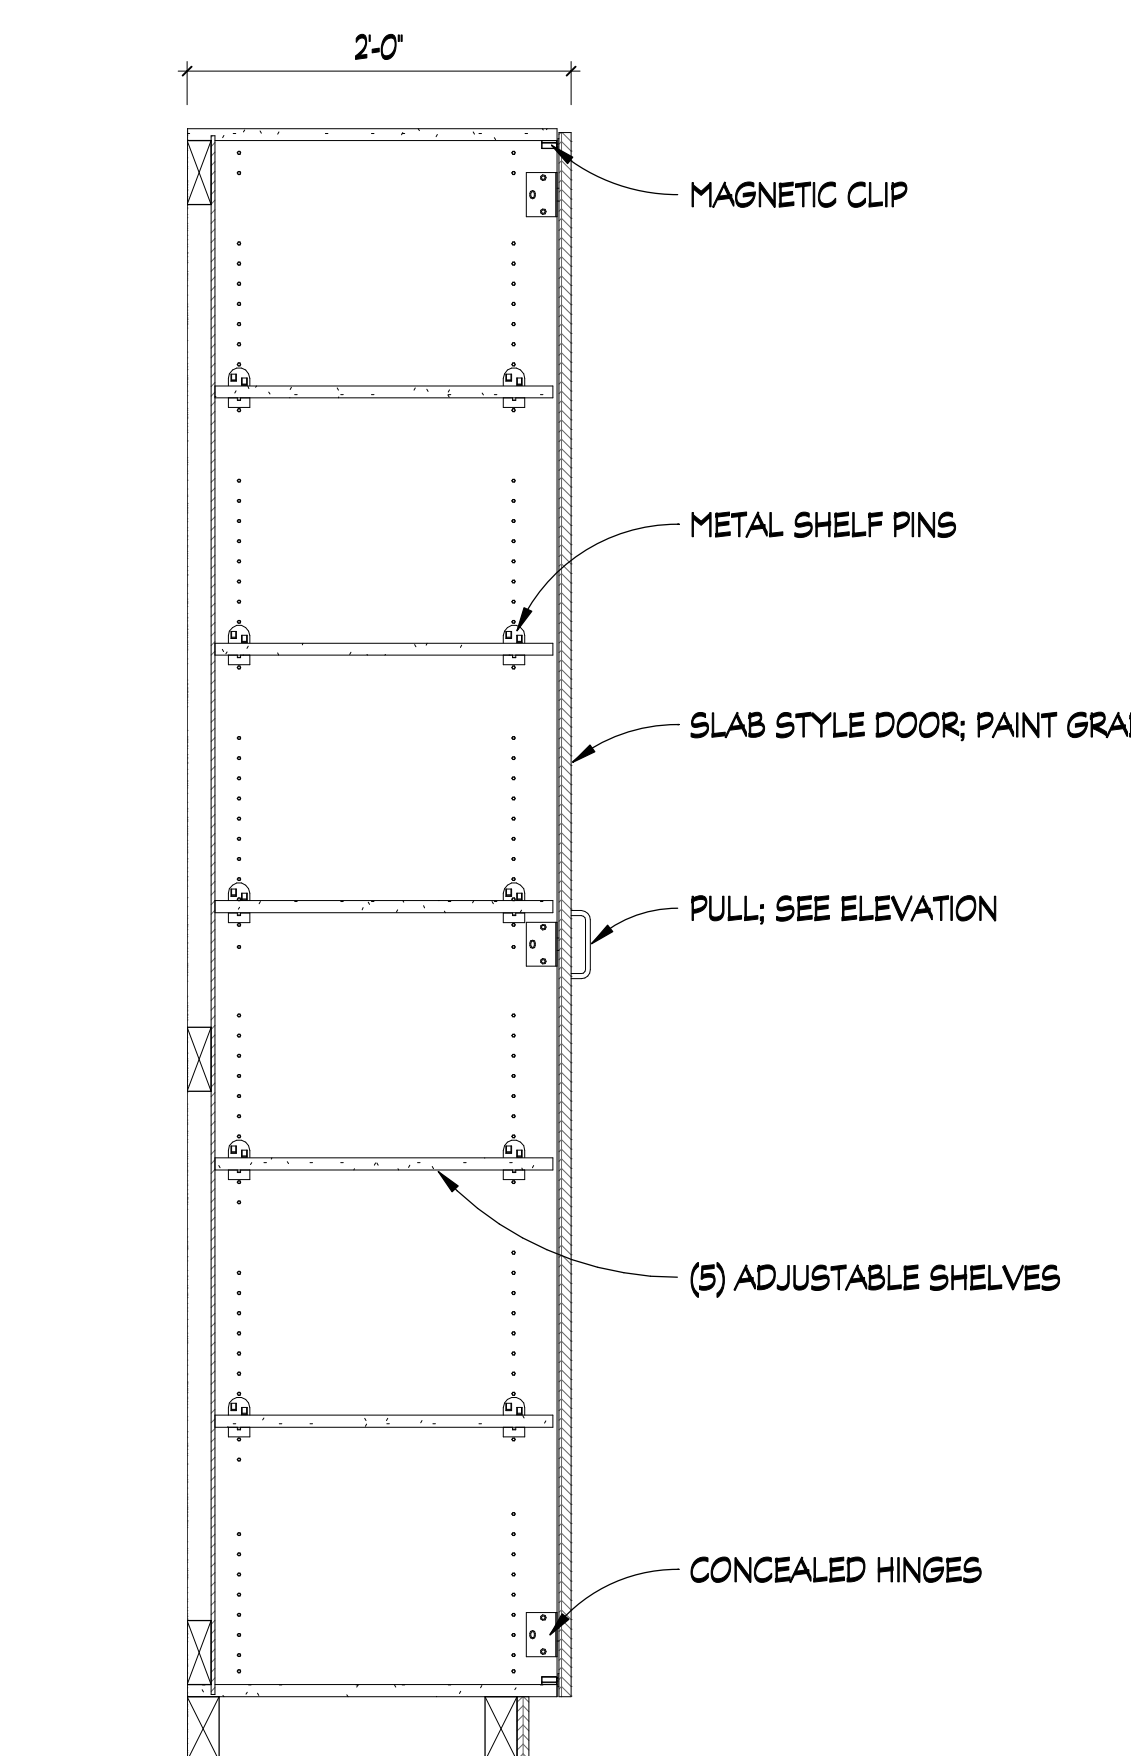


16 TC2
SCALE: 1" = 1'-0"

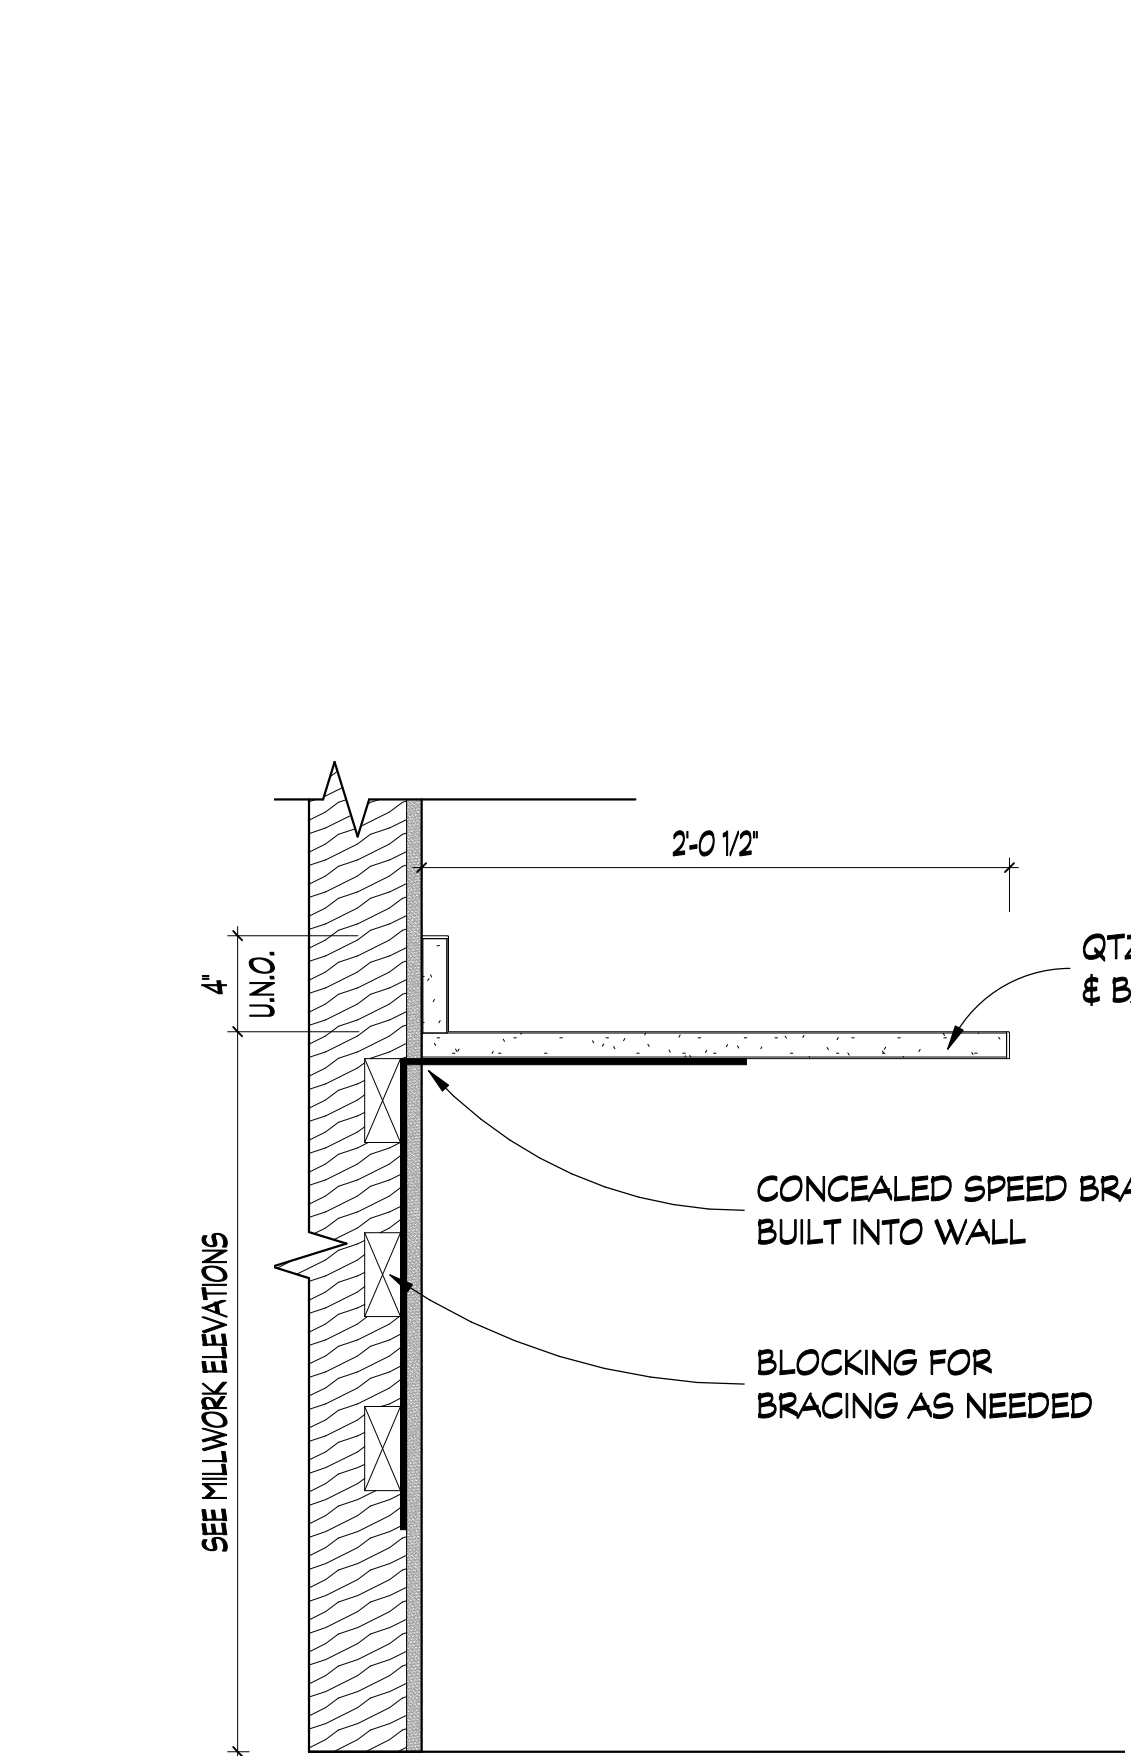


17 FLOATING COUNTER DETAIL
SCALE: 1 1/2" = 1'-0"

REVISIONS			
REV #	DATE	APPROV BY	REVISION
1	2/16/22	EA	ISSUE FOR PERMIT

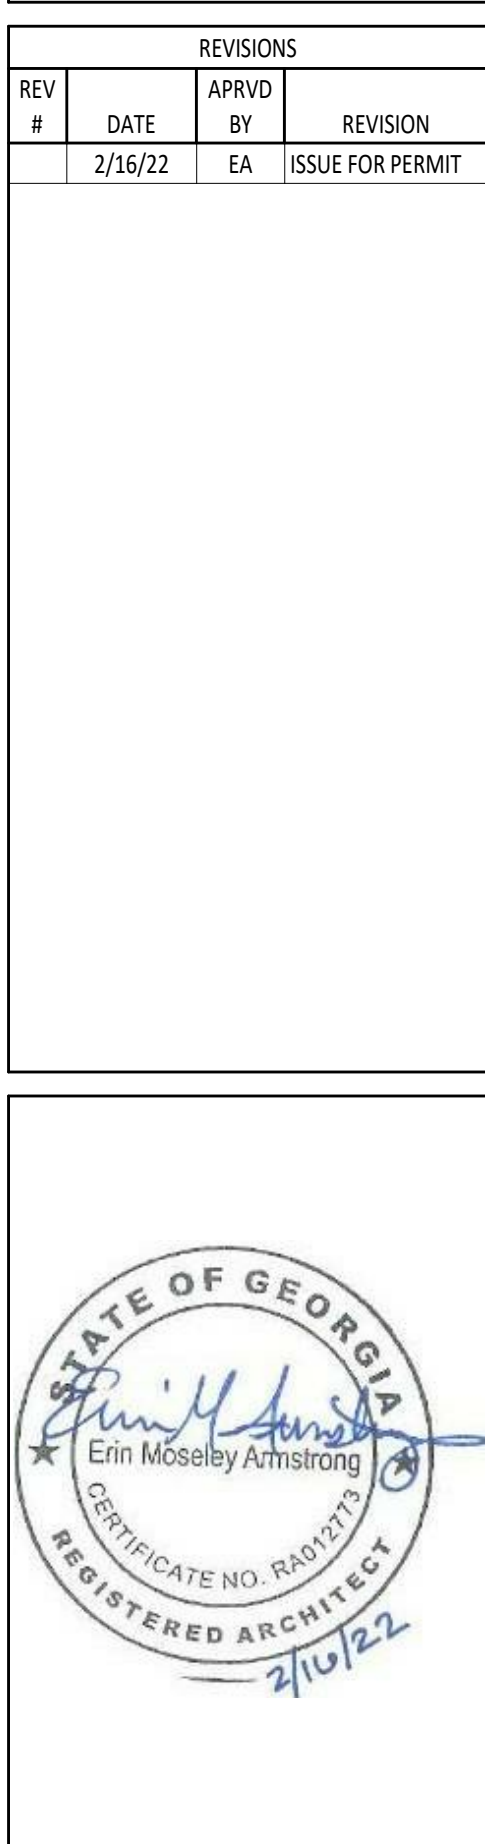

MILLWORK NOTES
1. " SEE ELEVATIONS FOR BACKSPLASH HEIGHTS
2. COORDINATE ALL APPLIANCES WITH OWNER PRIOR TO MILLWORK FABRICATION

MILLWORK KEY
BC# - BASE CABINET
UC# - UPPER CABINET
TC# - TALL CABINET

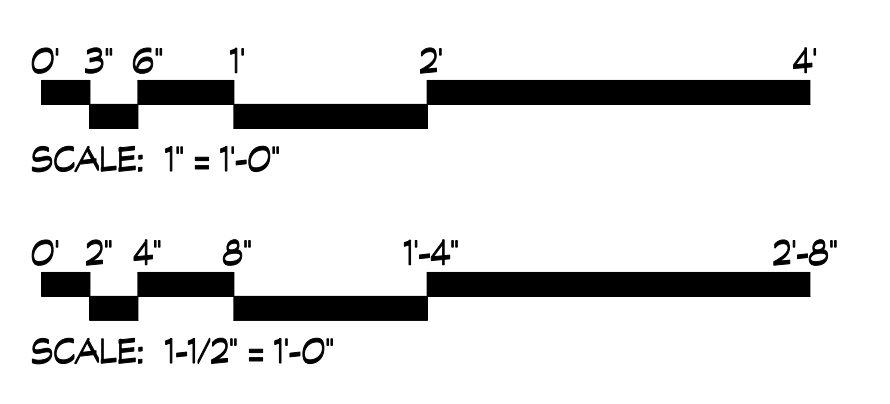

E

D

C

B

A

REQUIRED PECIAL INSPECTIONS AND TESTS OF CONCRETE CONSTRUCTION PER IBC 2018 CH. 17				
TYPE	CONTINUOUS SPECIAL INSPECTION	PERIODIC SPECIAL INSPECTION	REFERENCED STANDARD	IBC REFERENCE
1. INSPECT REINFORCEMENT, INCLUDING PRESTRESSING TENDONS, AND VERIFY PLACEMENT.	-	X	ACI 318: CH 20, 25.2, 25.3, 26.6.1-26.6.3	1908.4
2. REINFORCING BAR WELDING:				
A. VERIFY WELDABILITY OF REINFORCING BARS OTHER THAN ASTM A706.	-	X		
B. INSPECT SINGLE-PASS FILLET WELDS, MAXIMUM 5/16", AND	-	X	AWS D1.4 ACI 318: 26.6.4	
C. INSPECT ALL OTHER WELDS	-	-		
3. INSPECT ANCHORS CAST IN CONCRETE	-	X	ACI 318: 17.8.23	
4. INSPECT ANCHORS POST-INSTALLED IN HARDENED CONCRETE MEMBERS.				
A. ADHESIVE ANCHORS INSTALLED IN HORIZONTALLY OR UPWARDLY INCLINED ORIENTATIONS TO RESIST SUSTAINED TENSION LOADS.	-	X	ACI 318: 17.8.24 ACI 318: 17.8.2	
B. MECHANICAL ANCHORS AND ADHESIVE ANCHORS NOT DEFINED IN 4.A.				
5. VERIFY USE OF REQUIRED DESIGN MIX.	-	X	ACI 318: CH 19, 26.4.3, 26.4.4	1904.1, 1904.2, 1908.2, 1908.3
6. PRIOR TO CONCRETE PLACEMENT FABRICATE SPECIMENS FOR STRENGTH TESTS, PERFORM SLUMP AND AIR CONTENT TESTS, AND DETERMINE THE TEMPERATURE OF THE CONCRETE.	X	-	ASTM C172 ASTM C31 ACI 318: 26.5, 26.12	1908.1
7. INSPECT CONCRETE AND SHOTCRETE PLACEMENT FOR PROPER APPLICATION TECHNIQUES.	X	-	ACI 318: 26.5	1908.6, 1908.7, 1908.8
8. VERIFY MAINTANANCE OF SPECIFIED CURING TEMPERATURE AND TECHNIQUES.	-	X	ACI 318: 26.5.3-26.5.5	1908.9
9. INSPECT PRESTRESSED CONCRETE FOR:				
A. APPLICATION OF PRESTRESSED FORCES; AND	-	-	ACI 318: 26.10	
B. GROUTING OF BONDED PRESTRESSING TENDONS.	-	-		
10. INSPECT ERECTION OF PRECAST CONCRETE MEMBERS.	-	-	ACI 318: 26.9	
11. VERIFY IN-SITU CONCRETE STRENGTH, PRIOR TO STRESSING OF TENDONS IN POST-TENSIONED CONCRETE AND PRIOR TO REMOVAL OF SHORES AND FORMS FROM BEAMS AND STRUCTURAL SLABS.	-	-	ACI 318: 26.11.2	
12. INSPECT FORMWORK FOR SHAPE, LOCATION AND DIMENSIONS OF THE CONCRETE MEMBER BEING FORMED.	-	X	ACI 318: 26.11.1, 2(B)	

REQUIRED SPECIAL INSPECTION AND TESTS OF SOILS PER IBC 2018 CH. 17		
TYPE	CONTINUOUS SPECIAL INSPECTION	PERIODIC SPECIAL INSPECTION
1. VERIFY MATERIALS BELOW SHALLOW FOUNDATION ARE ADEQUATE TO ACHIEVE THE DESIGN BEARING CAPACITY	-	X
2. VERIFY EXCAVATIONS ARE EXTENDED TO PROPER DEPTH AND HAVE REACHED PROPER MATERIAL.	-	X
3. PERFORM CLASSIFICATION AND TESTING OF COMPACTED FILL MATERIALS	-	X
4. VERIFY USE OF PROPER MATERIALS, DENSITIES AND LIFT THICKNESS DURING PLACEMENT AND COMPACTION OF COMPACTED FILL	X	-
5. PRIOR TO PLACEMENT OF COMPACTED FILL, INSPECT SUBGRADE AND VERIFY THAT SITE HAS BEEN PREPARED PROPERLY.	-	X



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PROJECT TITLE:
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REVISIONS			
REV #	DATE	APPROV BY	REVISION
4-16-21	JRH	JRH	35% SET
11-17-21	JRH	JRH	65% SET
2-16-22	JRH	JRH	ISSUE FOR PERMIT




GEORGIA REGISTERED PROFESSIONAL ENGINEER
JOSE H. HERNANDEZ
02/16/2022

DA PROJECT NUMBER & NAME:
1893
SHEET TITLE:
**SPECIAL
INSPECTIONS**

SHEET NO:
S110




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1 FOUNDATION PLAN
SCALE: 1/8" = 1'-0"

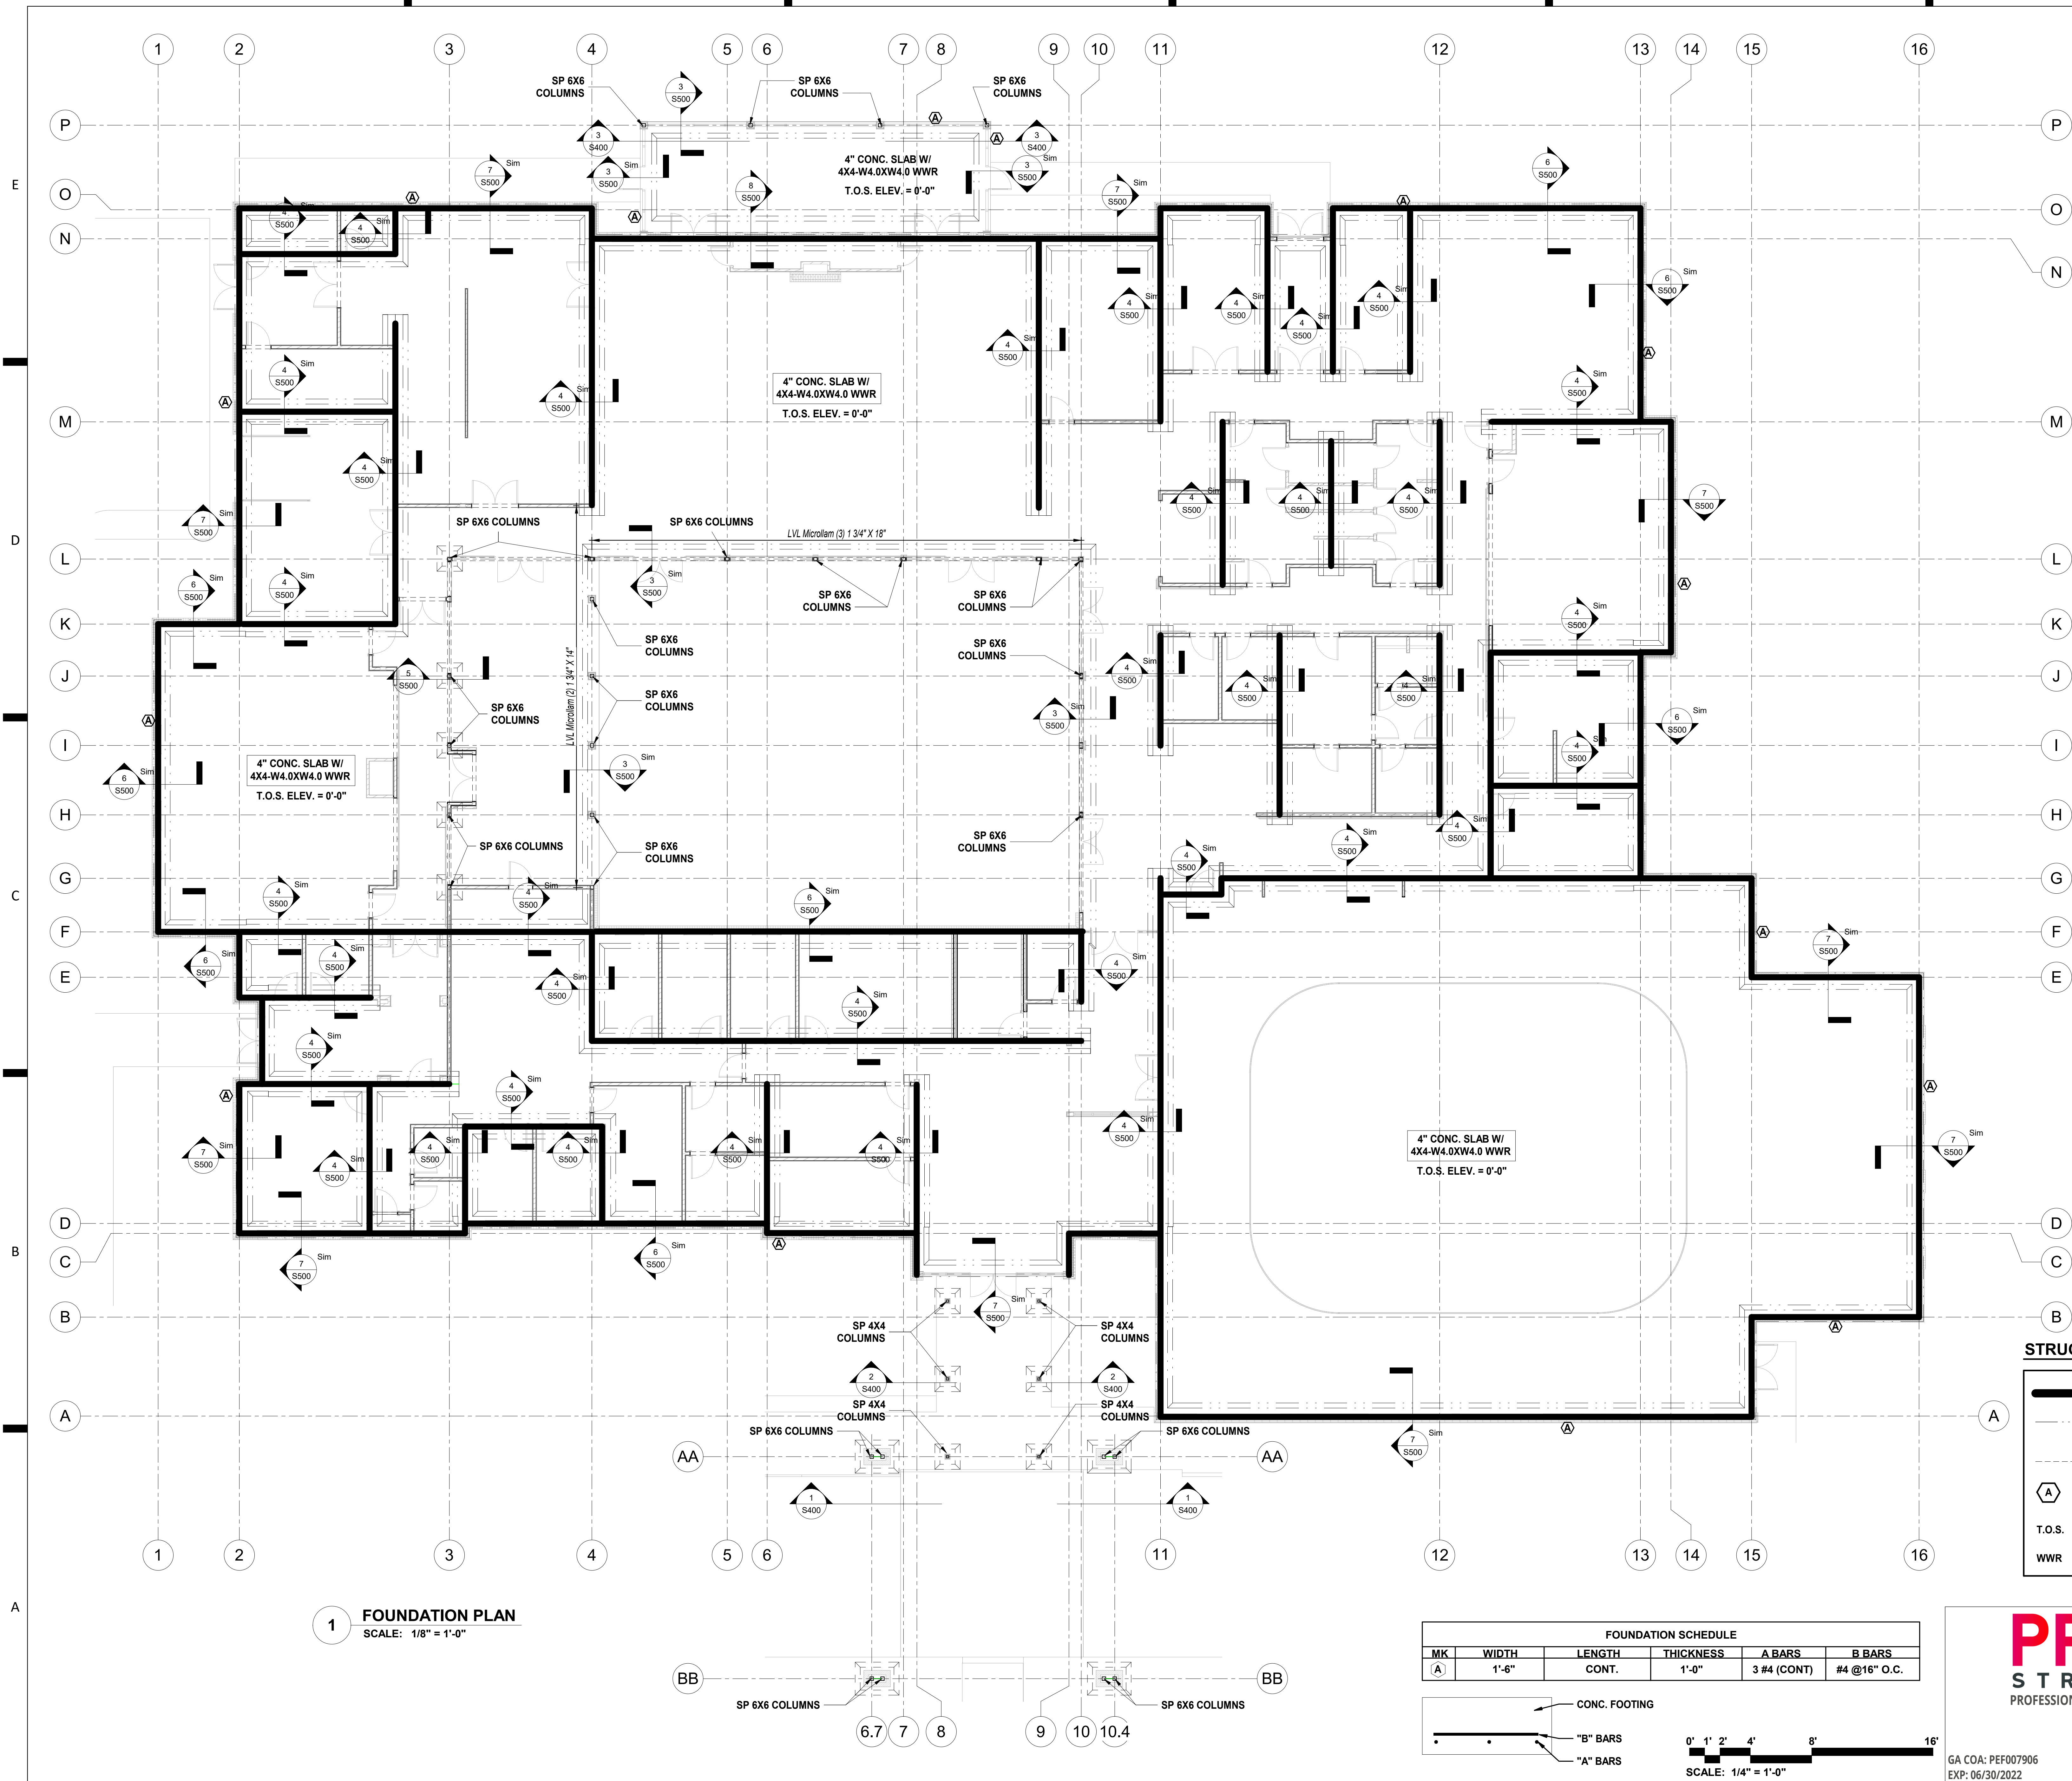FOUNDATION SCHEDULE					
MK	WIDTH	LENGTH	THICKNESS	A BARS	B BARS
(A)	1'-6"	CONT.	1'-0"	3 #4 (CONT)	#4 @16" O.C.



STRUCTURAL LEGEND

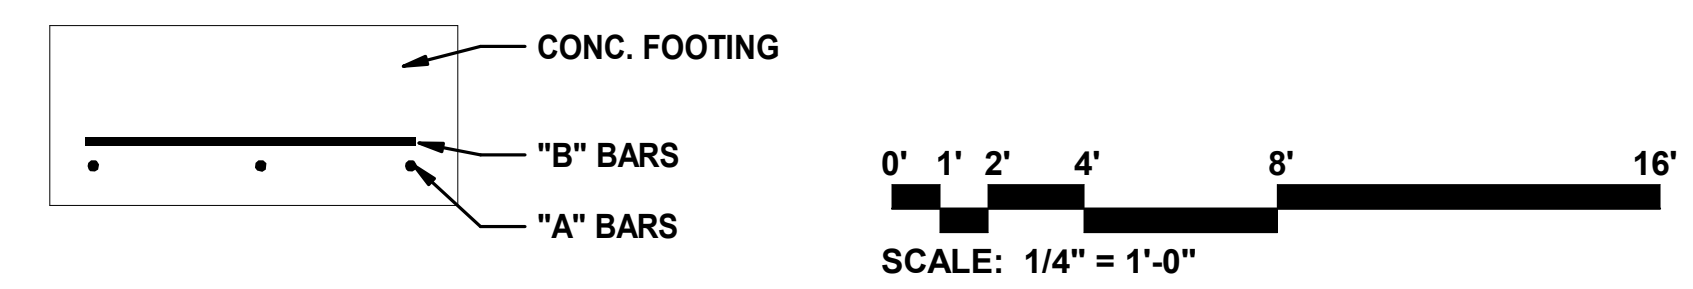- SHEAR WALL
- THICKENED SLAB
- CONTROL JOINT
- FOOTING MARK, REF. FOOTING SCHEDULE
- TOP OF SLAB
- WELDED WIRE REINFORCEMENT

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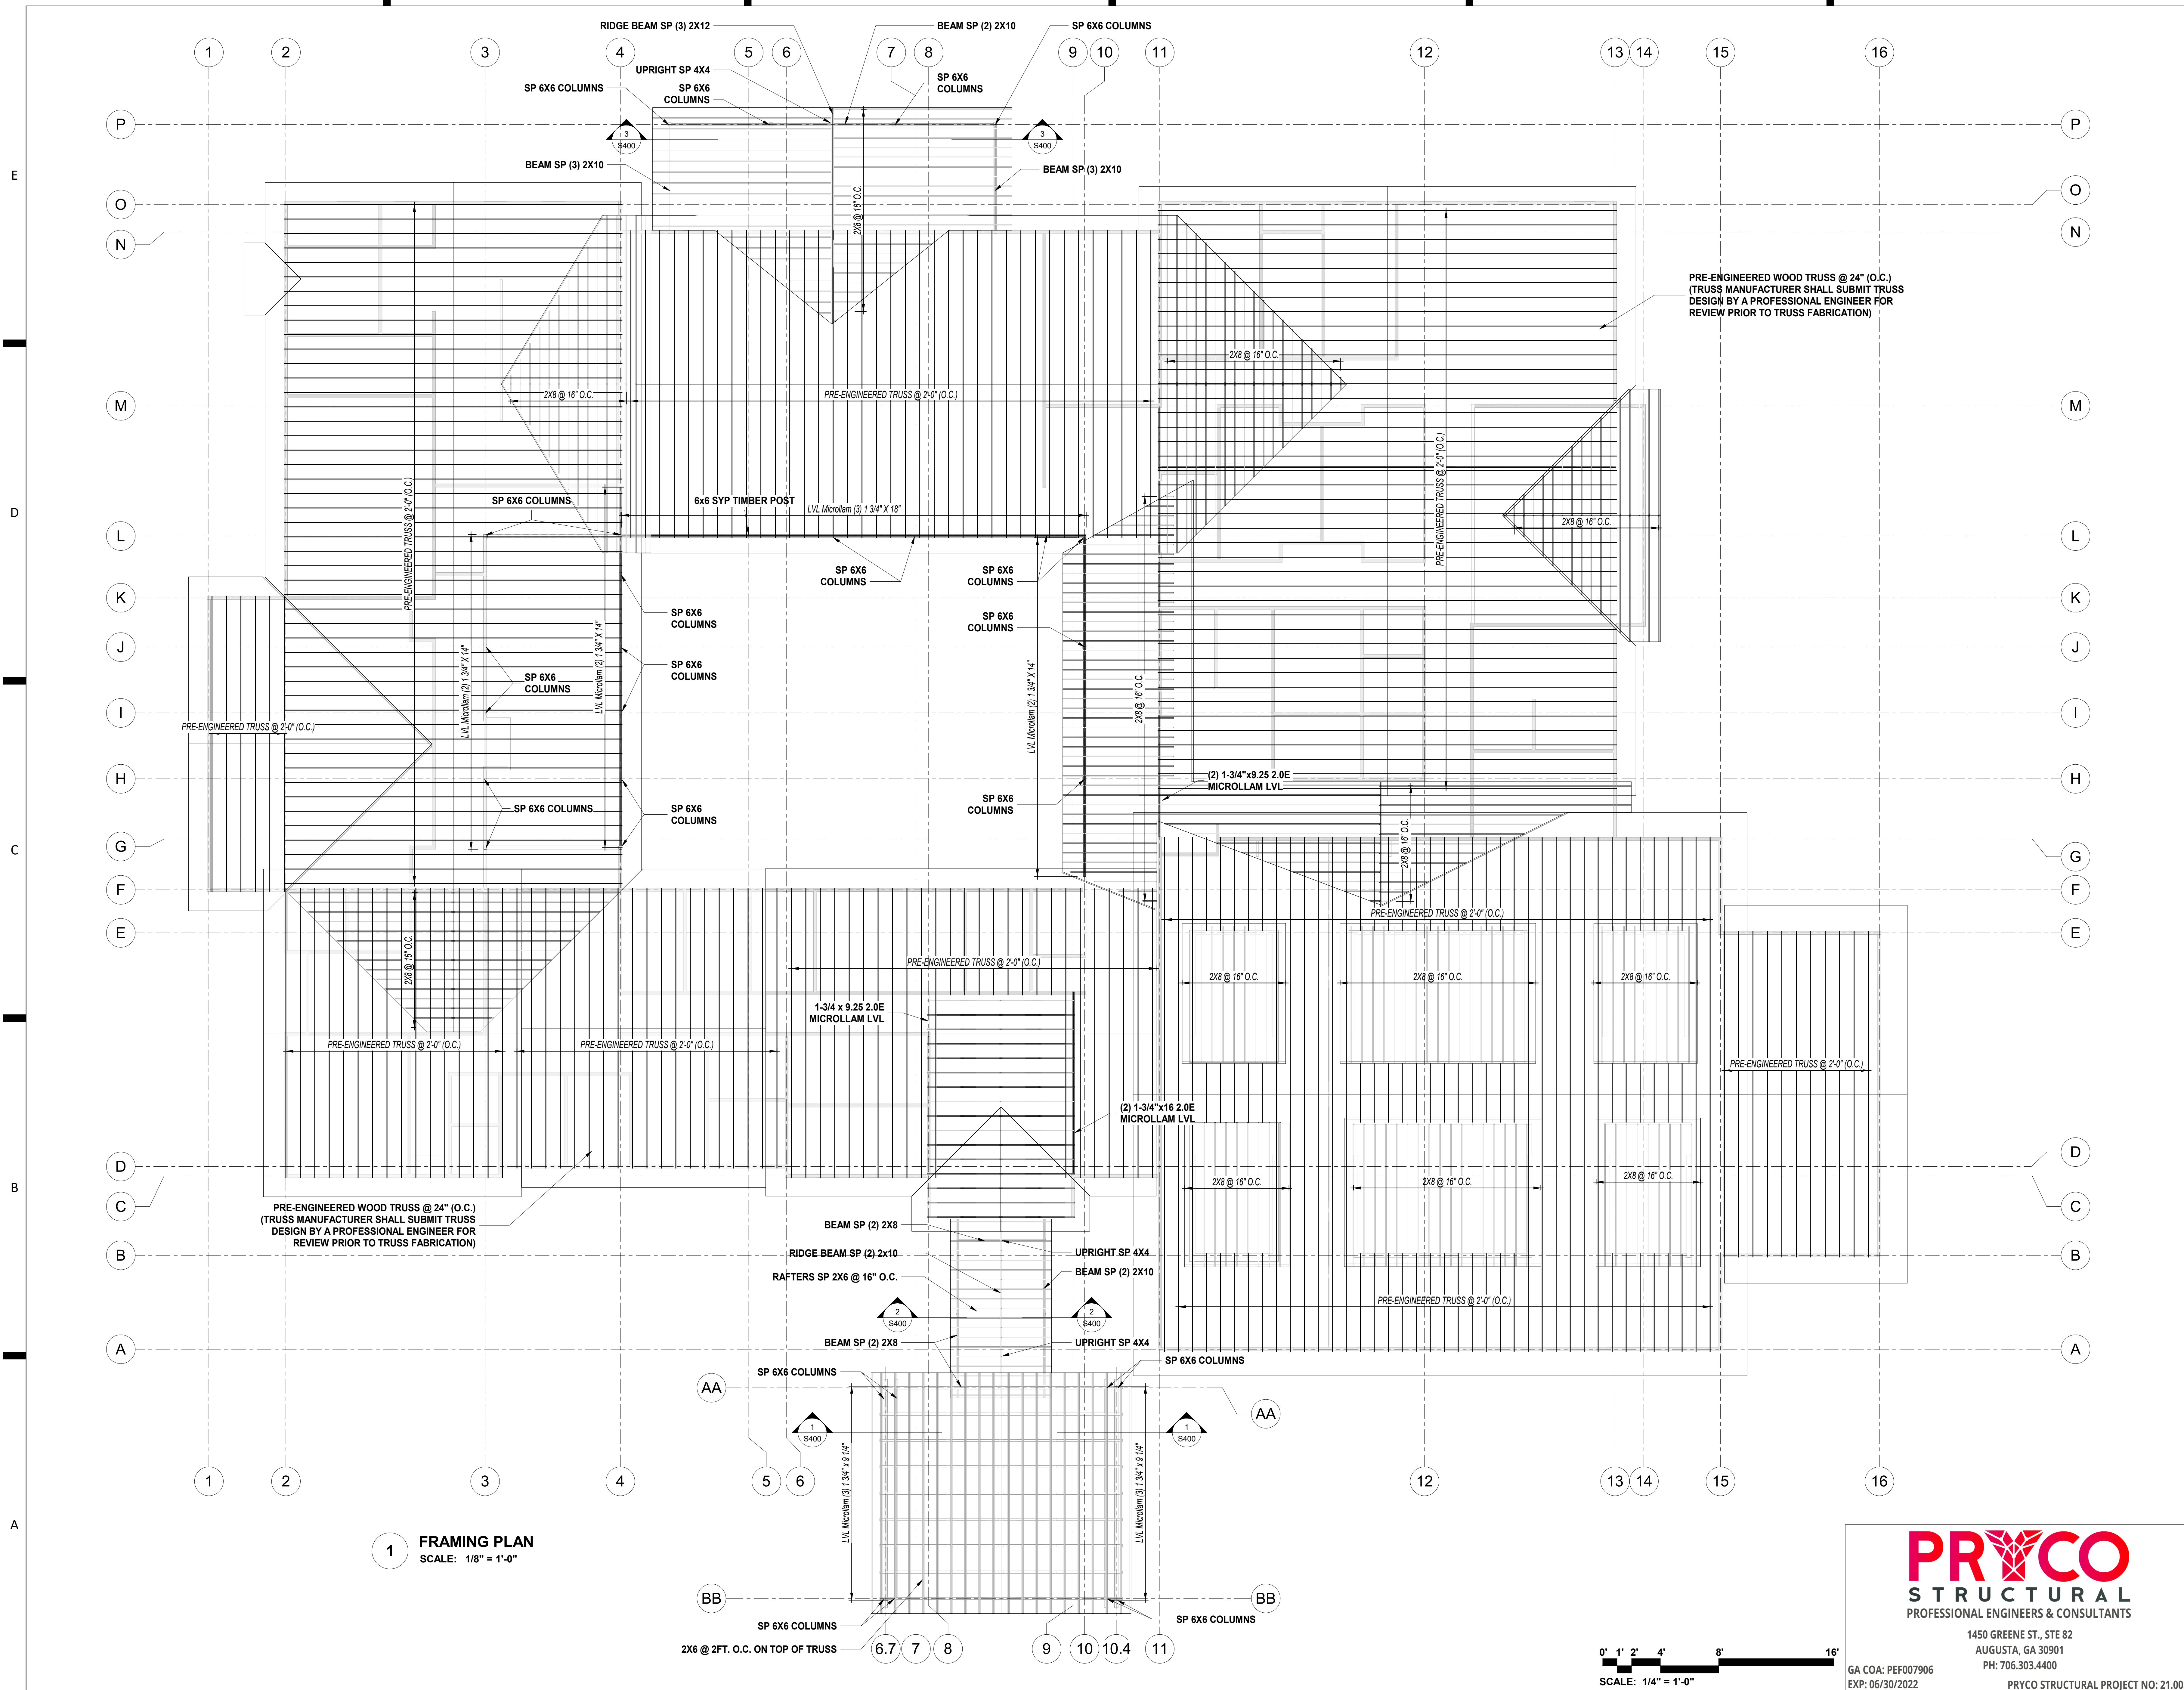
PROJECT TITLE:
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REVISIONS				
REV #	DATE	BY	APPROV	REVISION
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11-17-21	JRH	JRH		65% SET
2-16-22	JRH	JRH		ISSUE FOR PERMIT




DA PROJECT NUMBER & NAME:
1893
SHEET TITLE:
**FOUNDATION
PLAN**

SHEET NO:
S200



1 FRAMING PLAN
SCALE: 1/8" = 1'-0"

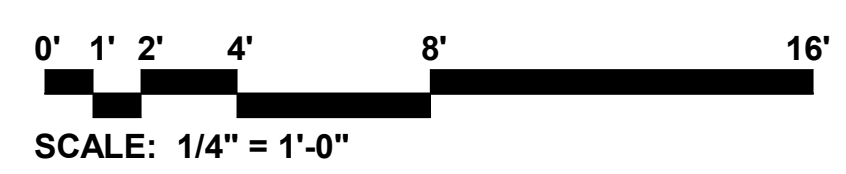

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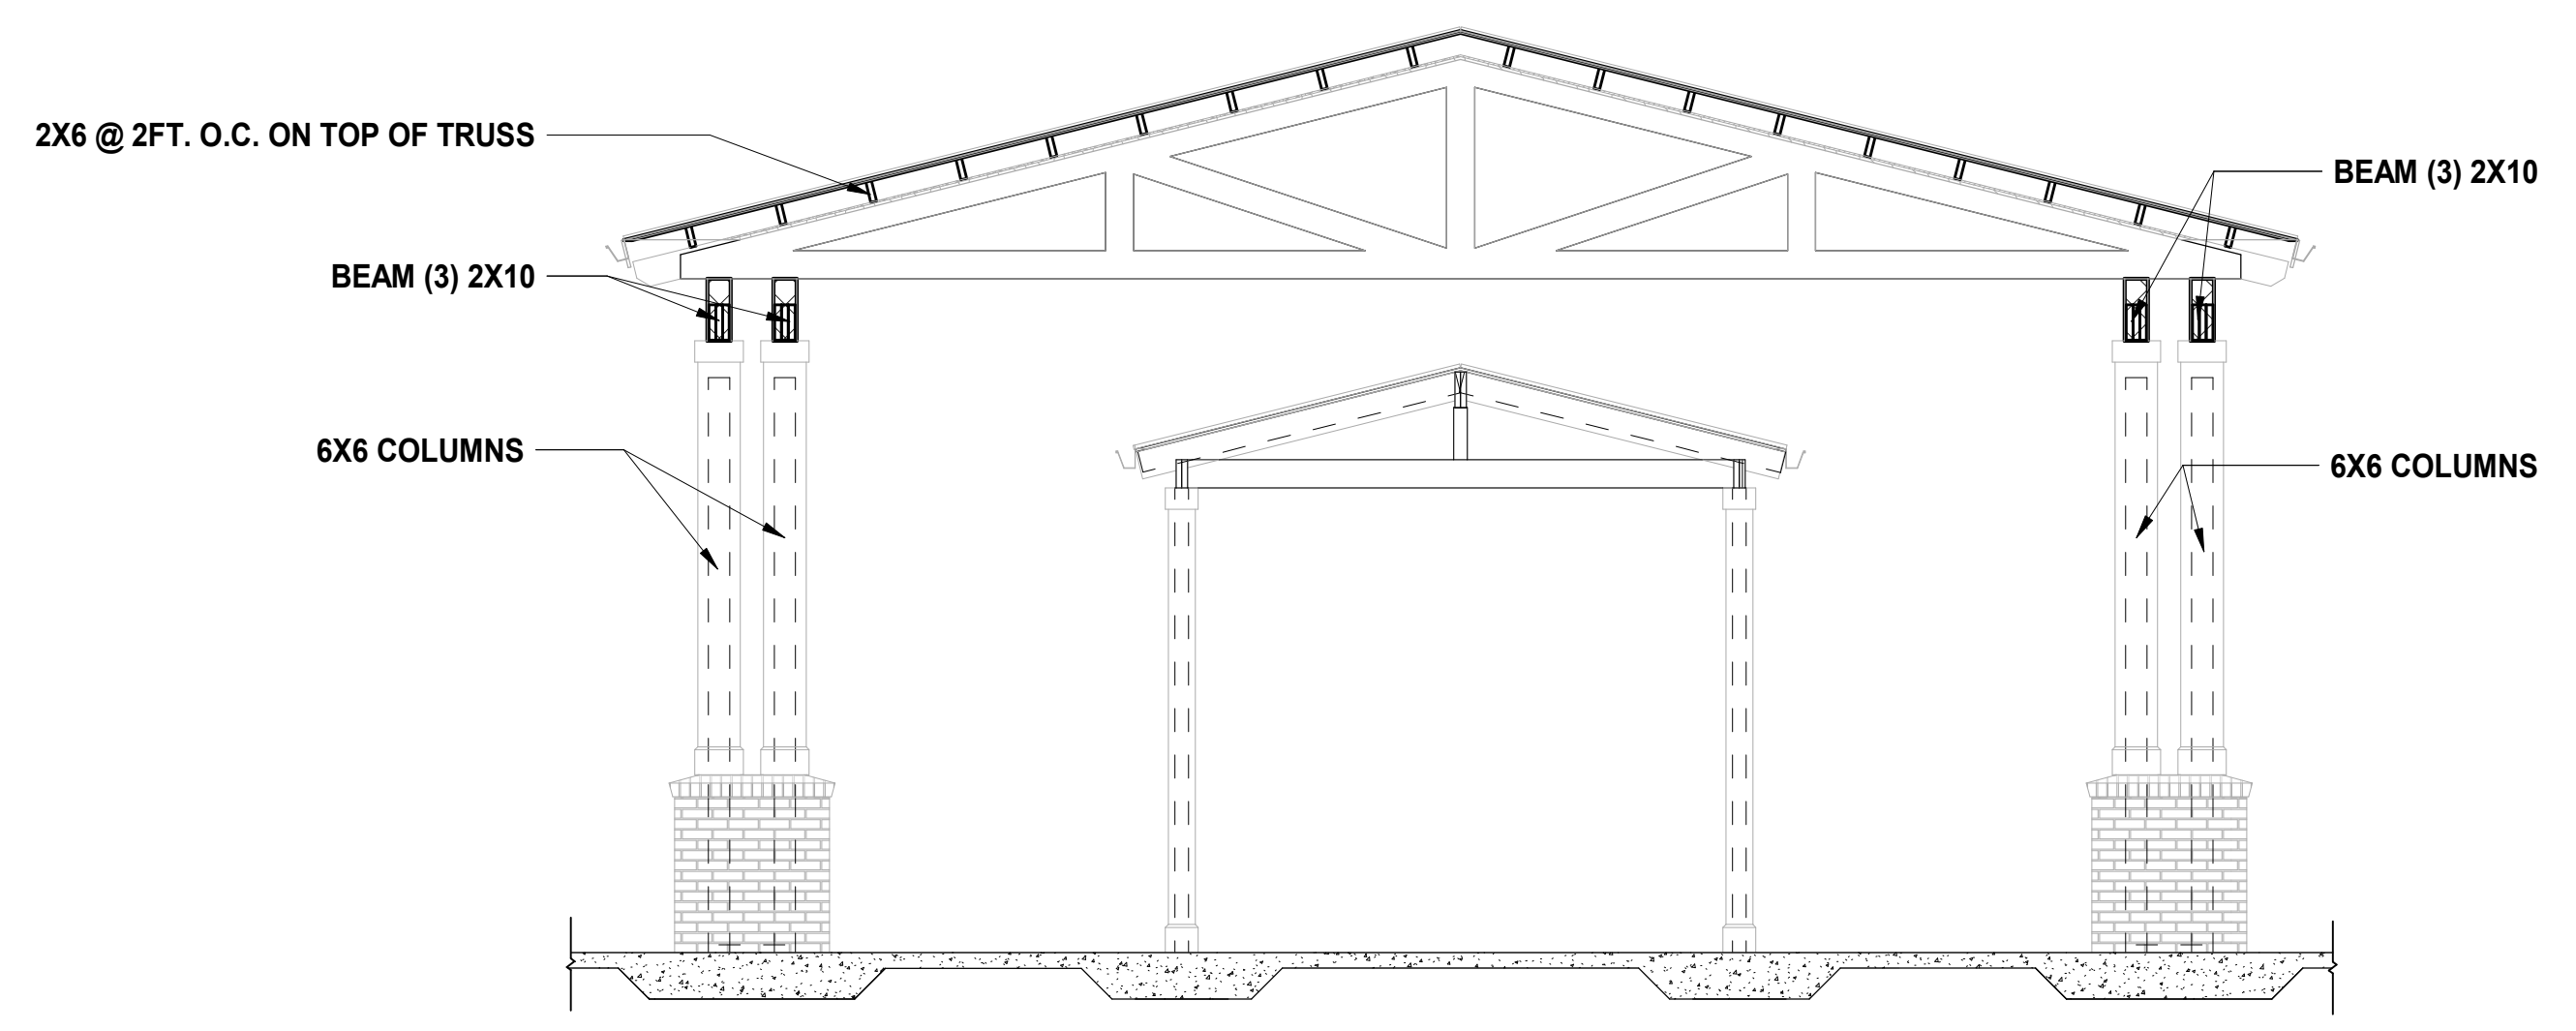
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REV #	DATE	APPROV	REVISION
4-16-21	JRH		35% SET
11-17-21	JRH		65% SET
2-16-22	JRH		ISSUE FOR PERMIT

DA PROJECT NUMBER & NAME:
1893


SHEET TITLE:
FRAMING PLAN

SHEET NO:
S300


PROJECT TITLE:
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1 BUILDING SECTION
S200 SCALE: 1/4" = 1'-0"




2 BUILDING SECTION
S200 SCALE: 1/4" = 1'-0"

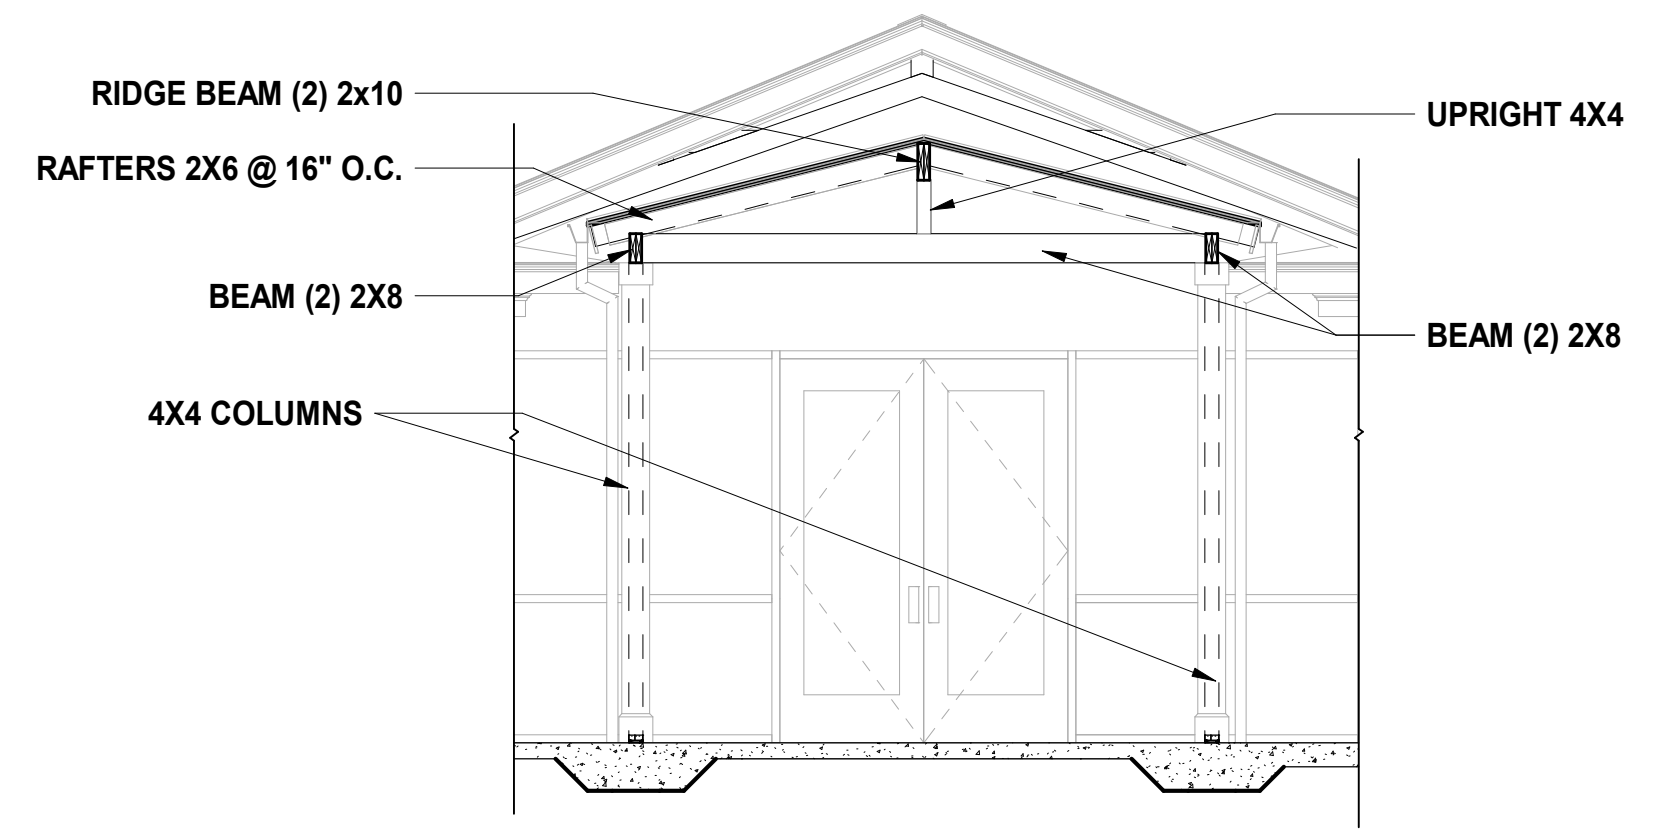

3 BUILDING SECTION
S200 SCALE: 1/4" = 1'-0"

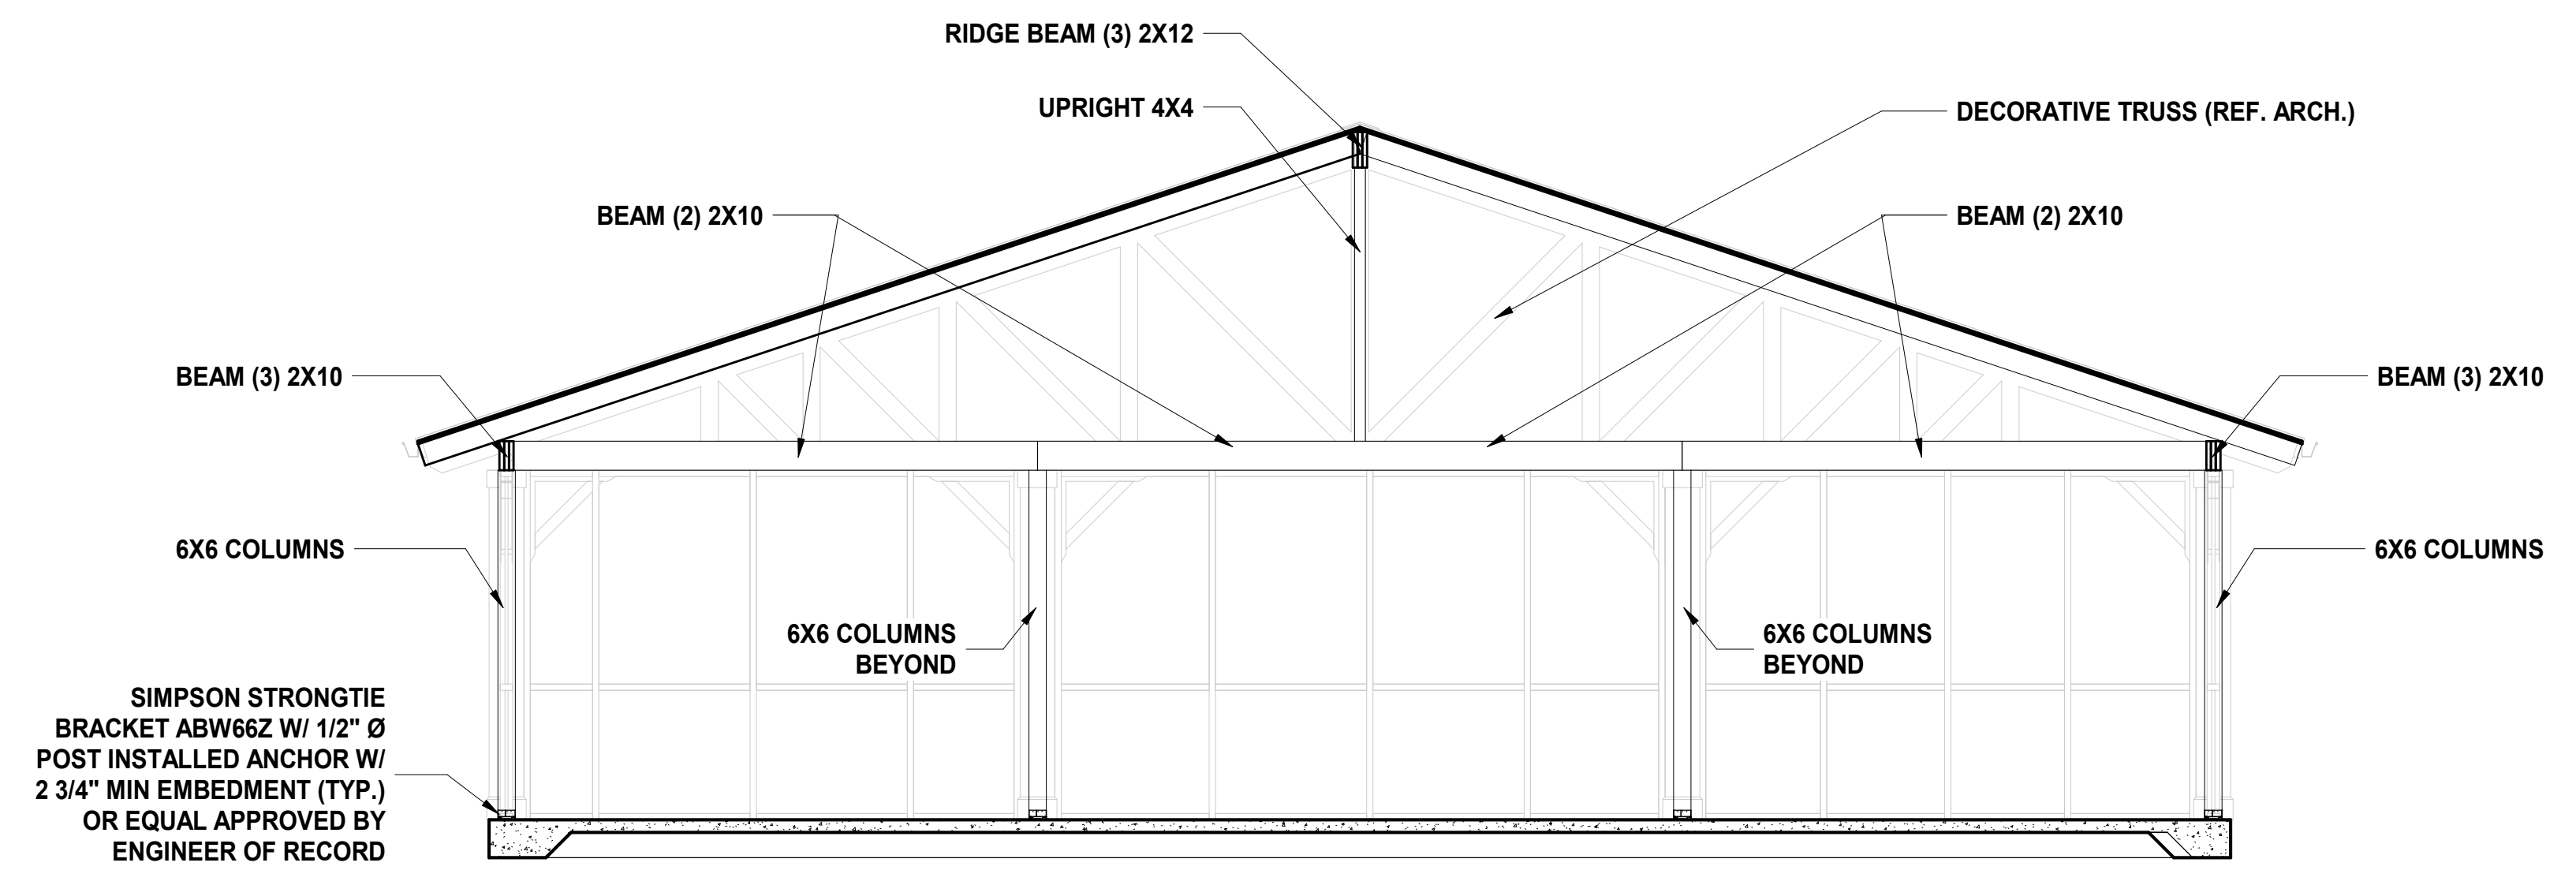
REVISIONS			
REV #	DATE	APRVD BY	REVISION
4-16-21	JRH		35% SET
11-17-21	JRH		65% SET
2-16-22	JRH		ISSUE FOR PERMIT

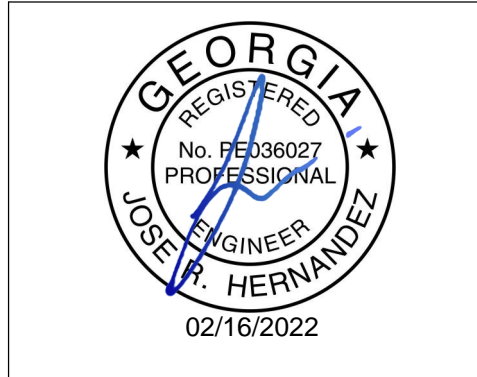


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1893
SHEET TITLE:
**BUILDING
SECTION**

SHEET NO:
S400


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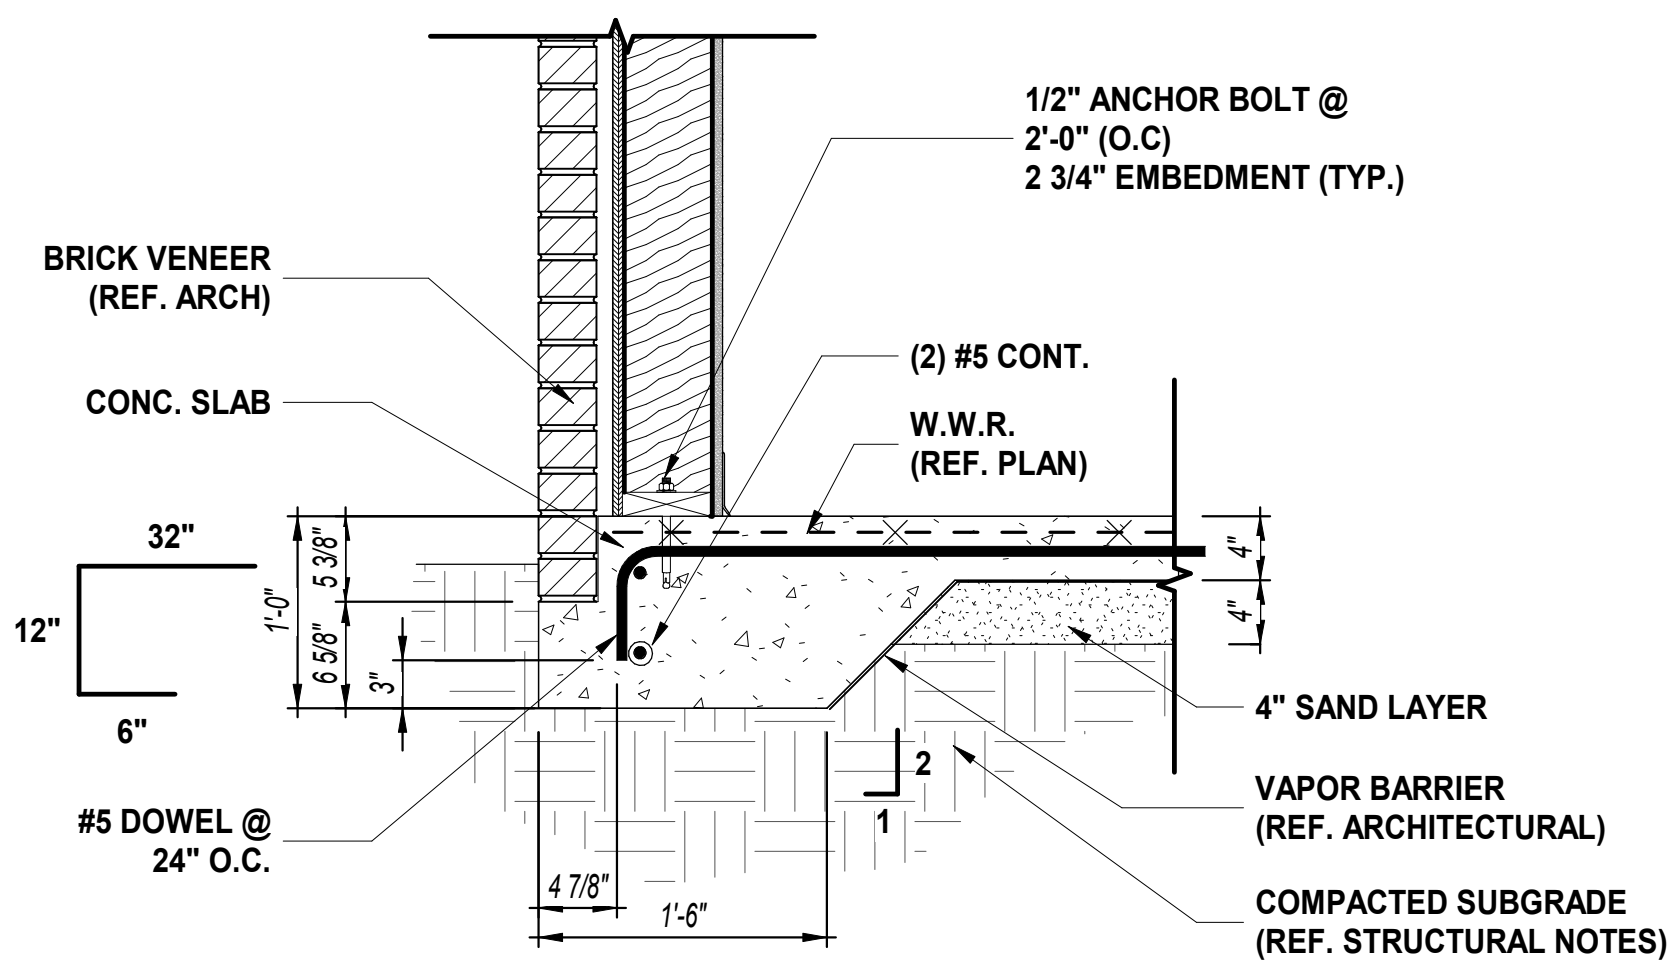
1 CONCRETE SLAB ON GRADE 4"
SCALE: 1" = 1'-0"

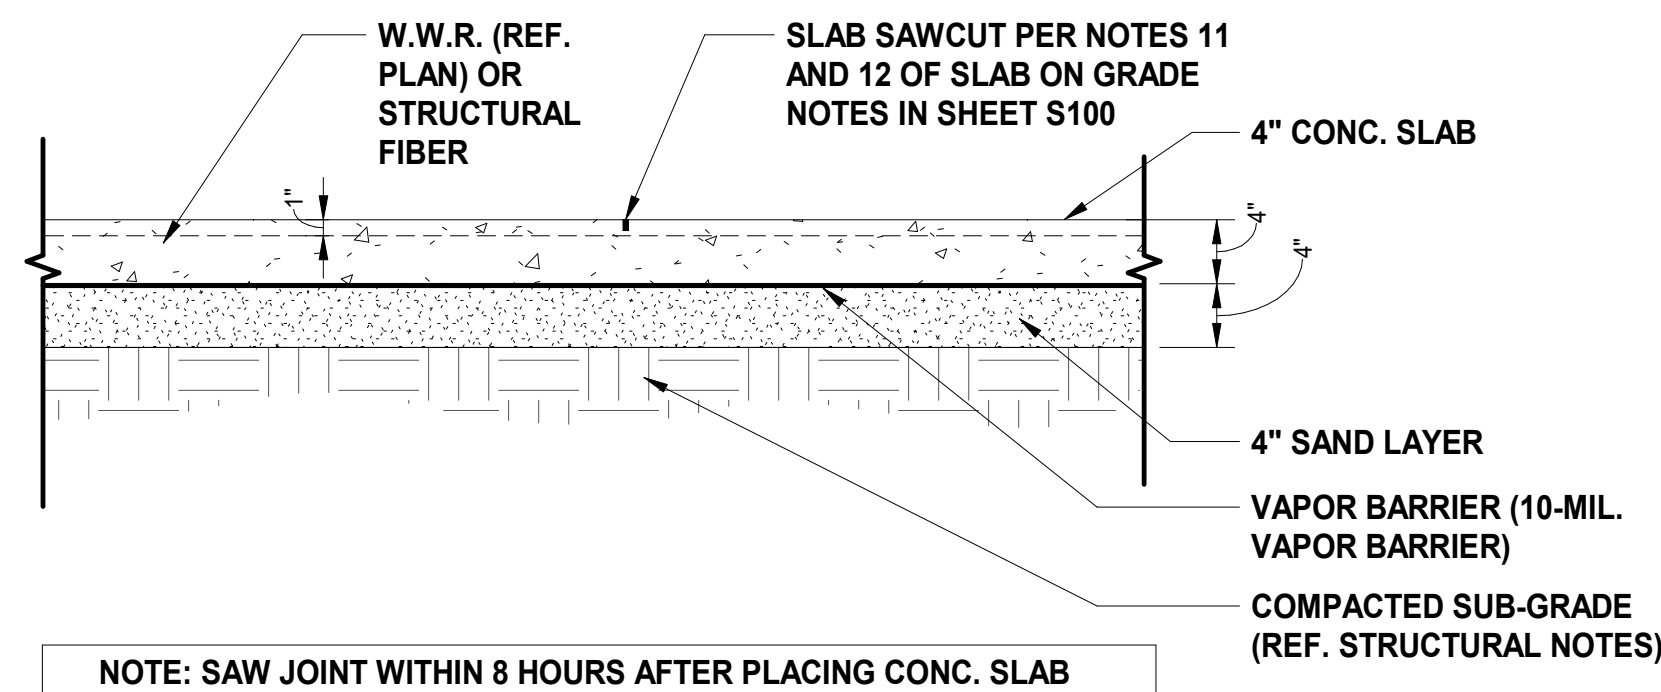


6 TURNDOWN SLAB DETAIL
S200 SCALE: 1" = 1'-0"

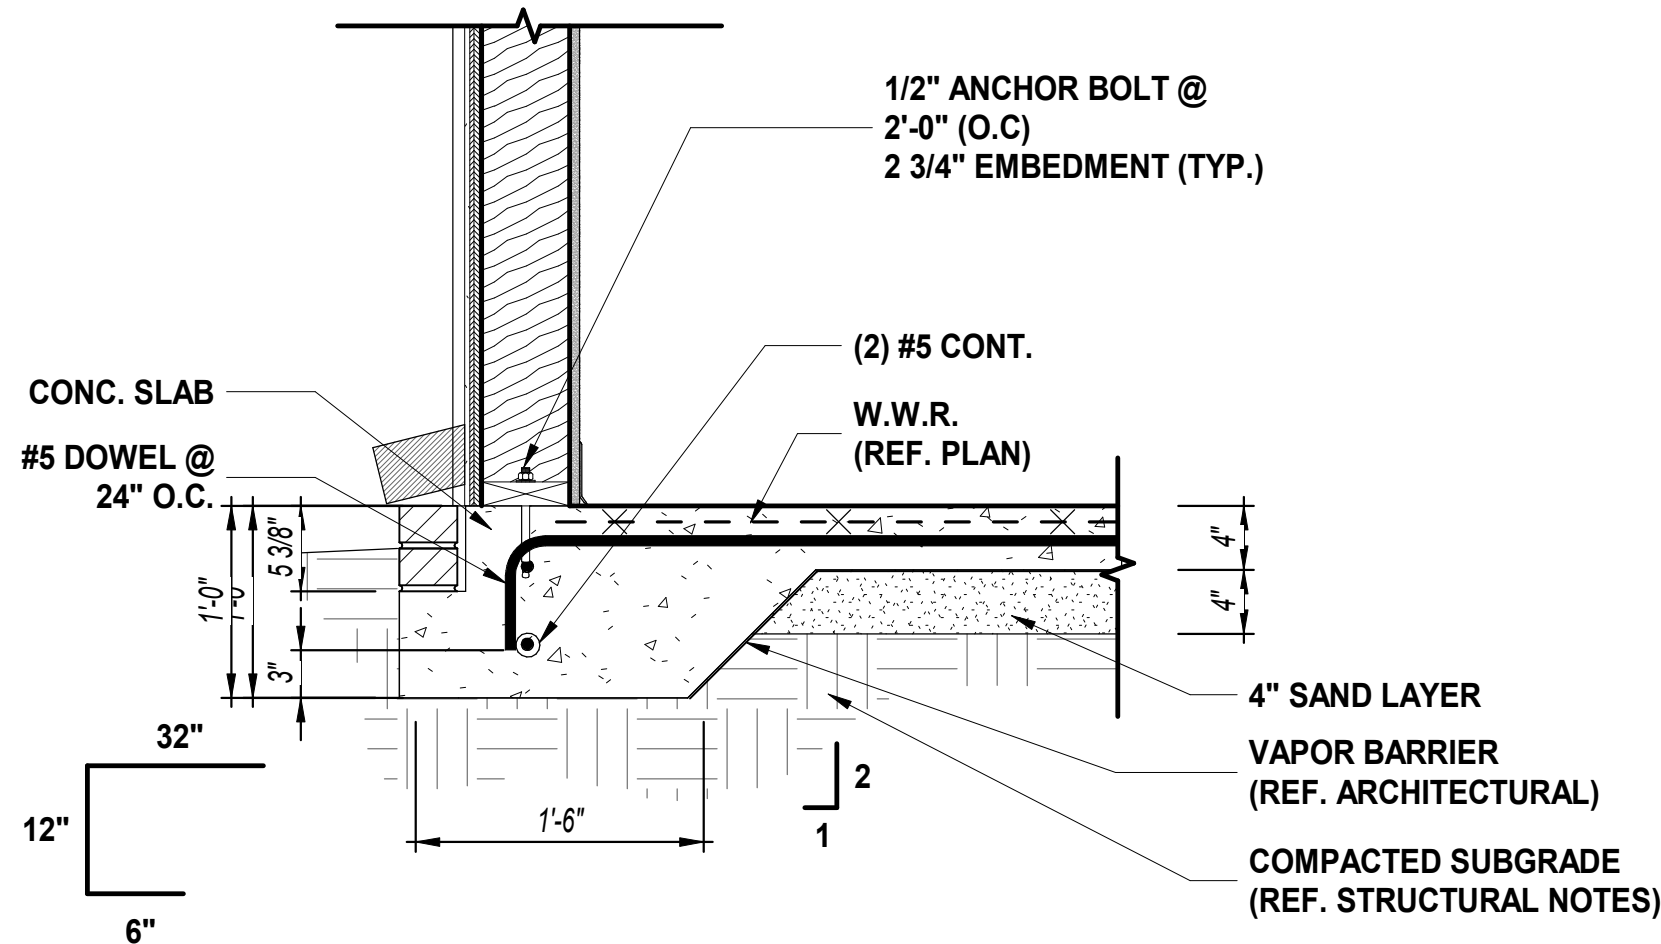


3 TURNDOWN SLAB DETAIL
S200 SCALE: 1" = 1'-0"

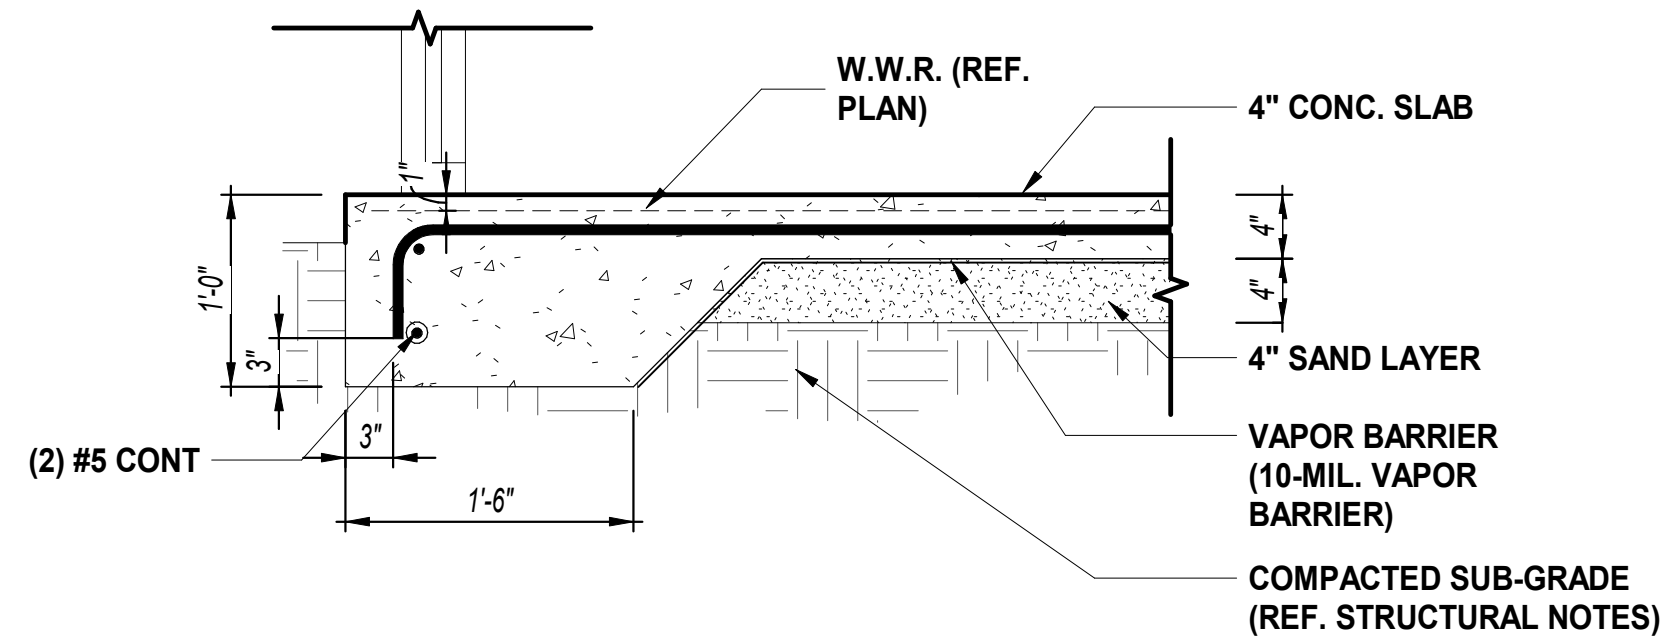


7 TURNDOWN SLAB DETAIL
S200 SCALE: 1" = 1'-0"

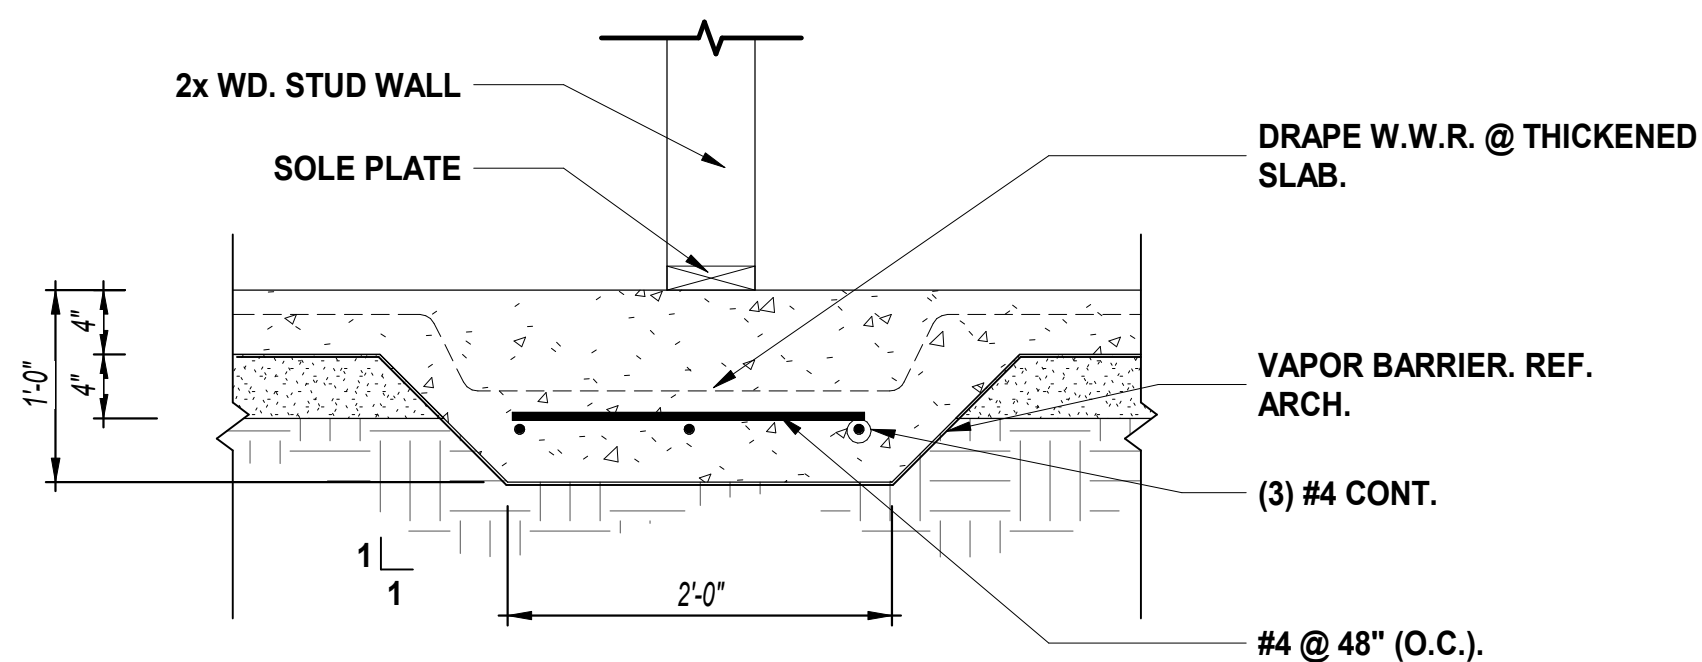


4 THICKENED SLAB AT WALL DETAIL
S200 SCALE: 1" = 1'-0"

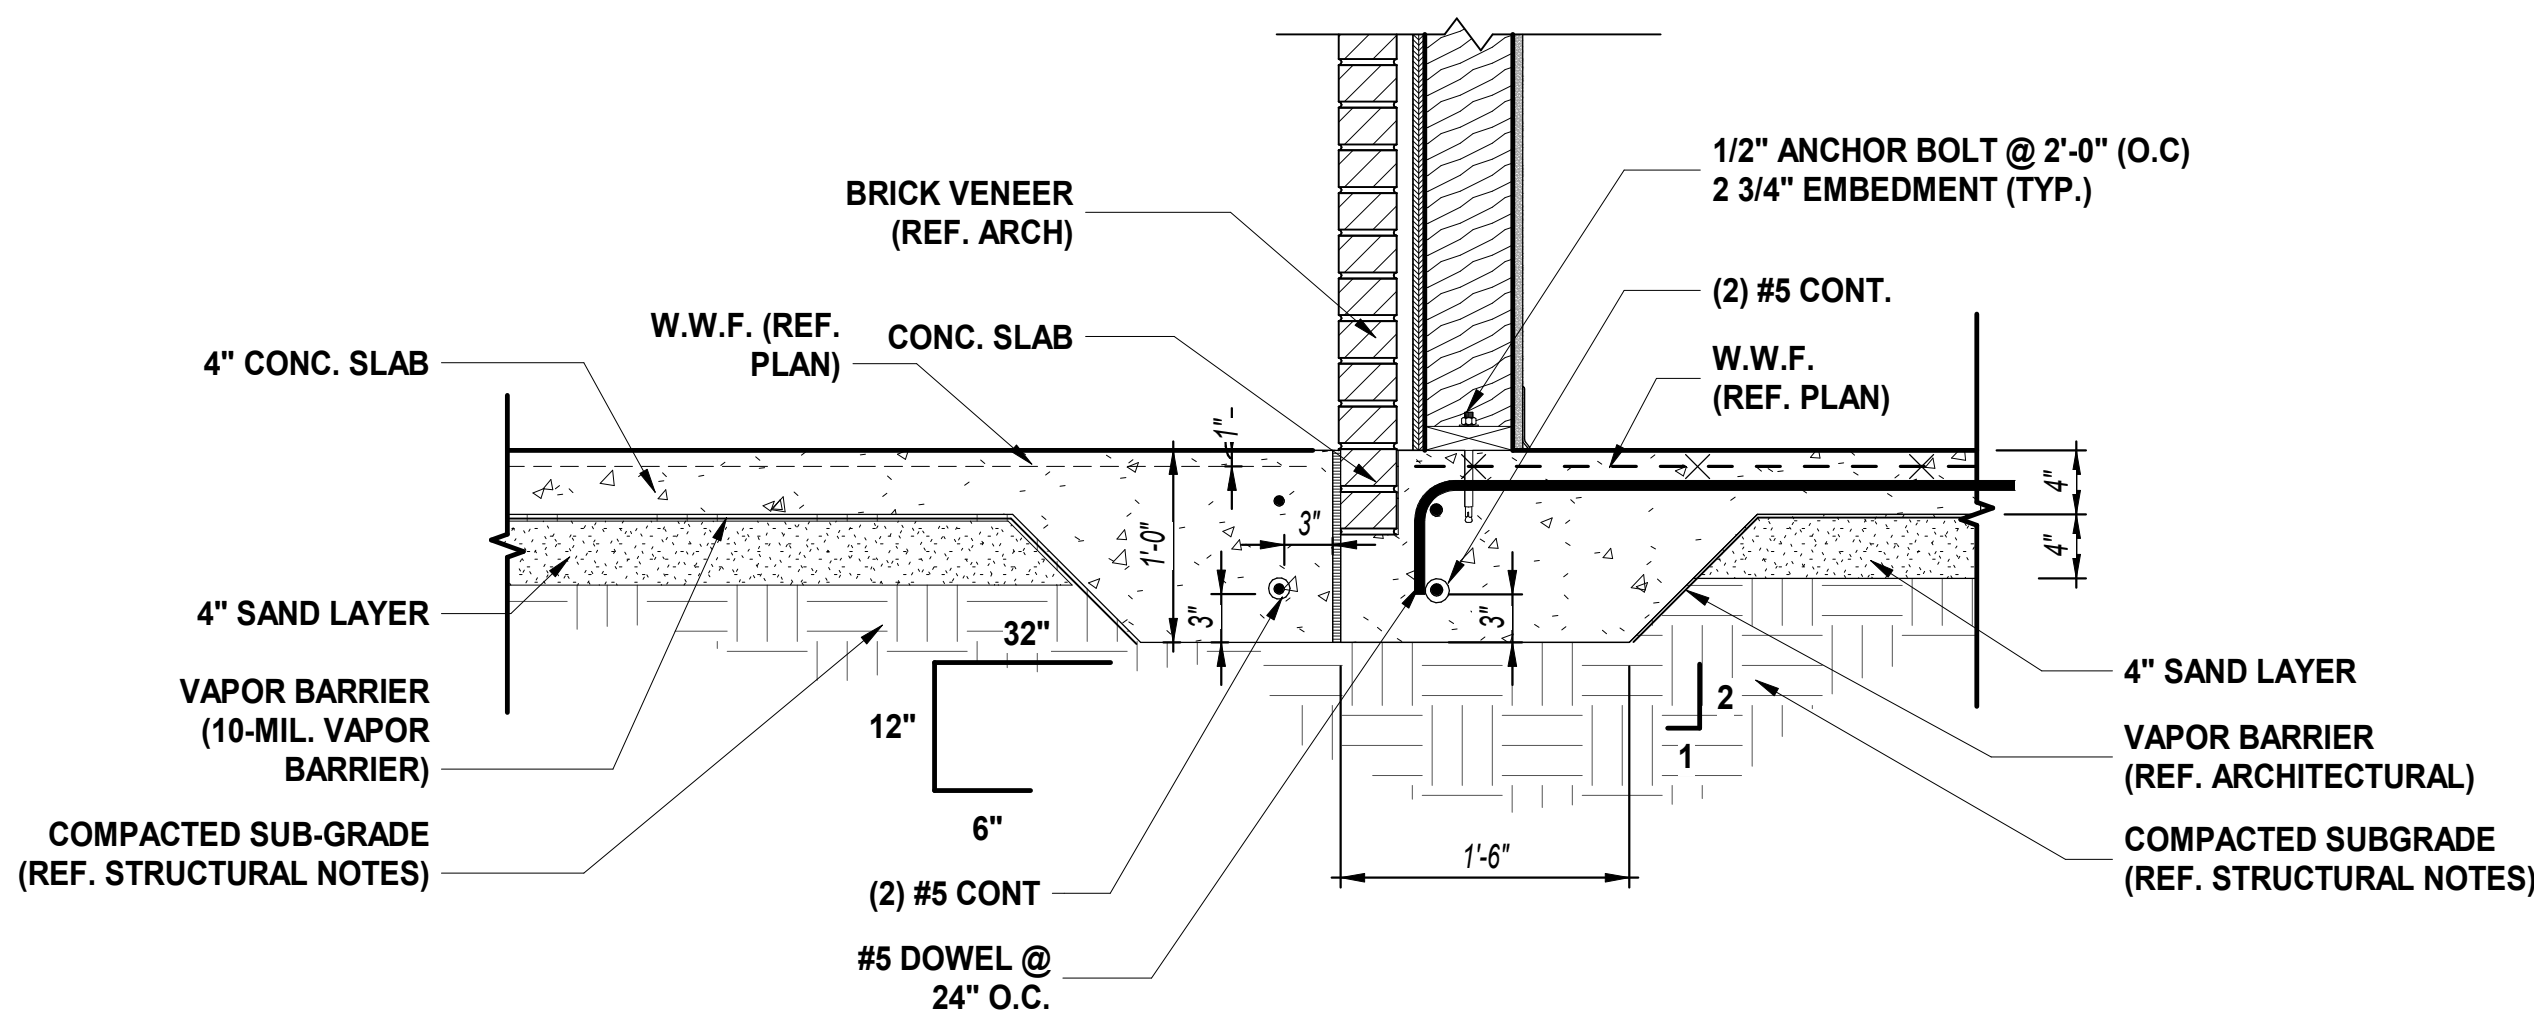

8 TURNDOWN SLAB DETAIL
S200 SCALE: 1" = 1'-0"

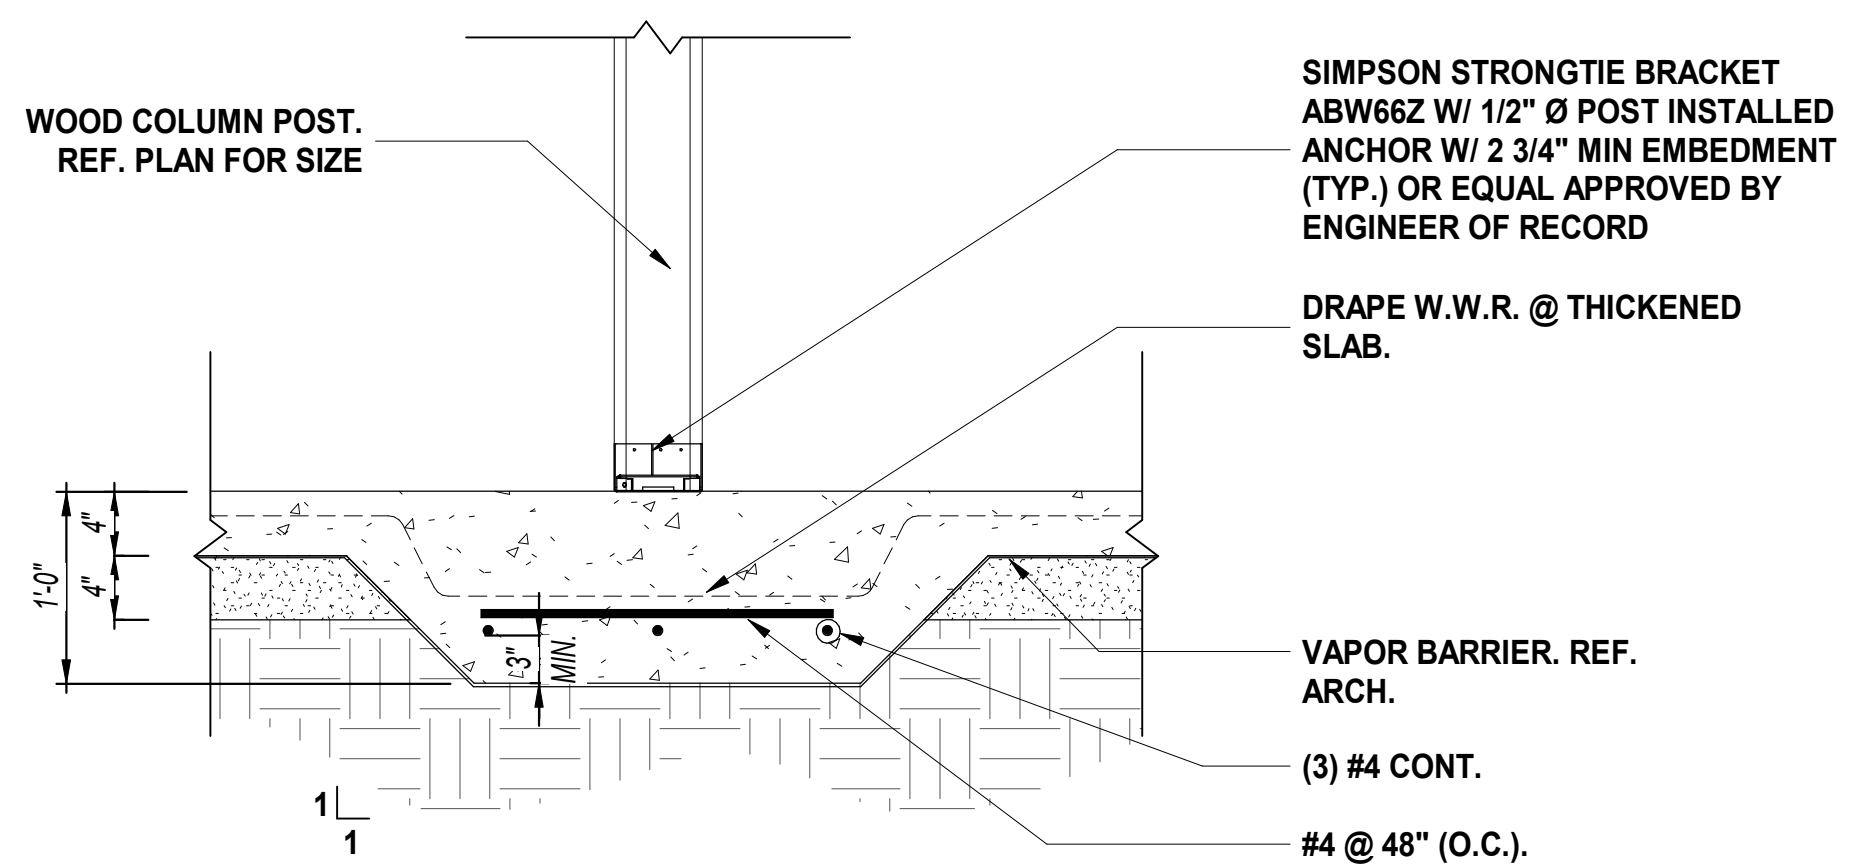

5 THICKENED SLAB AT COLUMN
S200 SCALE: 1" = 1'-0"

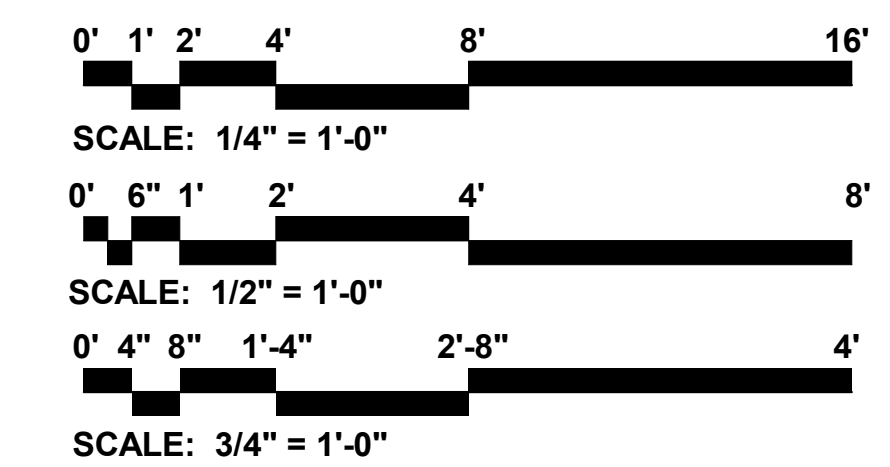

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PROJECT TITLE:
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REVISIONS			
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4-16-21	JRH		35% SET
11-17-21	JRH		65% SET
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DA PROJECT NUMBER & NAME:
1893
SHEET TITLE:
**FOUNDATION
DETAILS**
SHEET NO:
S500

REVISIONS			
REV #	DATE	APRVD BY	REVISION
4-16-21	JRH	JRH	35% SET
11-17-21	JRH	JRH	65% SET
2-16-22	JRH	JRH	ISSUE FOR PERMIT




DA PROJECT NUMBER & NAME:
1893
SHEET TITLE:
**FRAMING
DETAILS**


SHEET NO:
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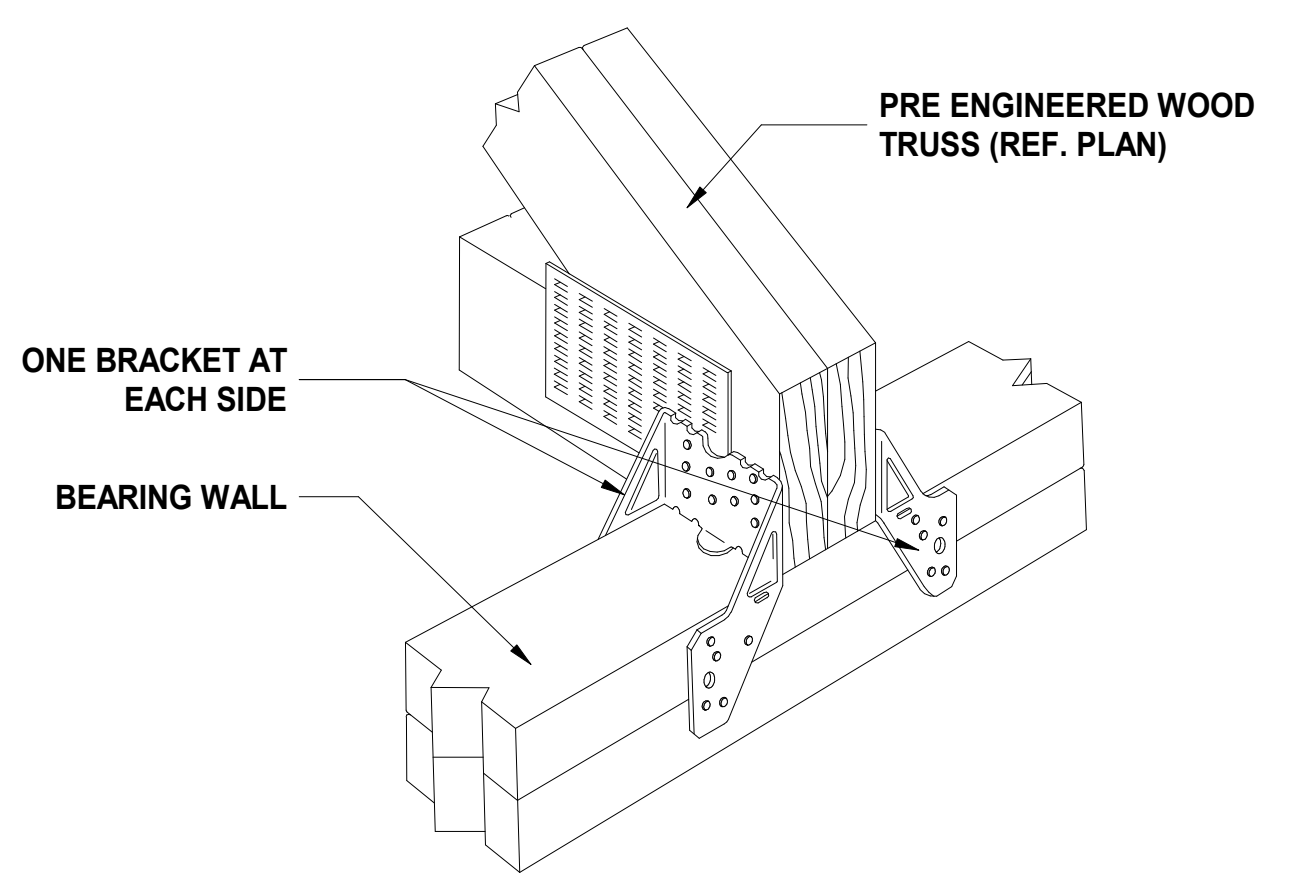
TRUSS LOADING
TOP CHORD
GOSS UPLIFT: 30 PSF
DEAD LOAD: 25 PSF
LIVE LOAD: 20 PSF
BOTTOM CHORD
DEAD LOAD 20+MECH
EQUIPMENT WHEIGHT
PLF




4 TYPICAL PRE-ENGINEERED TRUSS CONNECTIONS
SCALE: 1/4" = 1'-0"

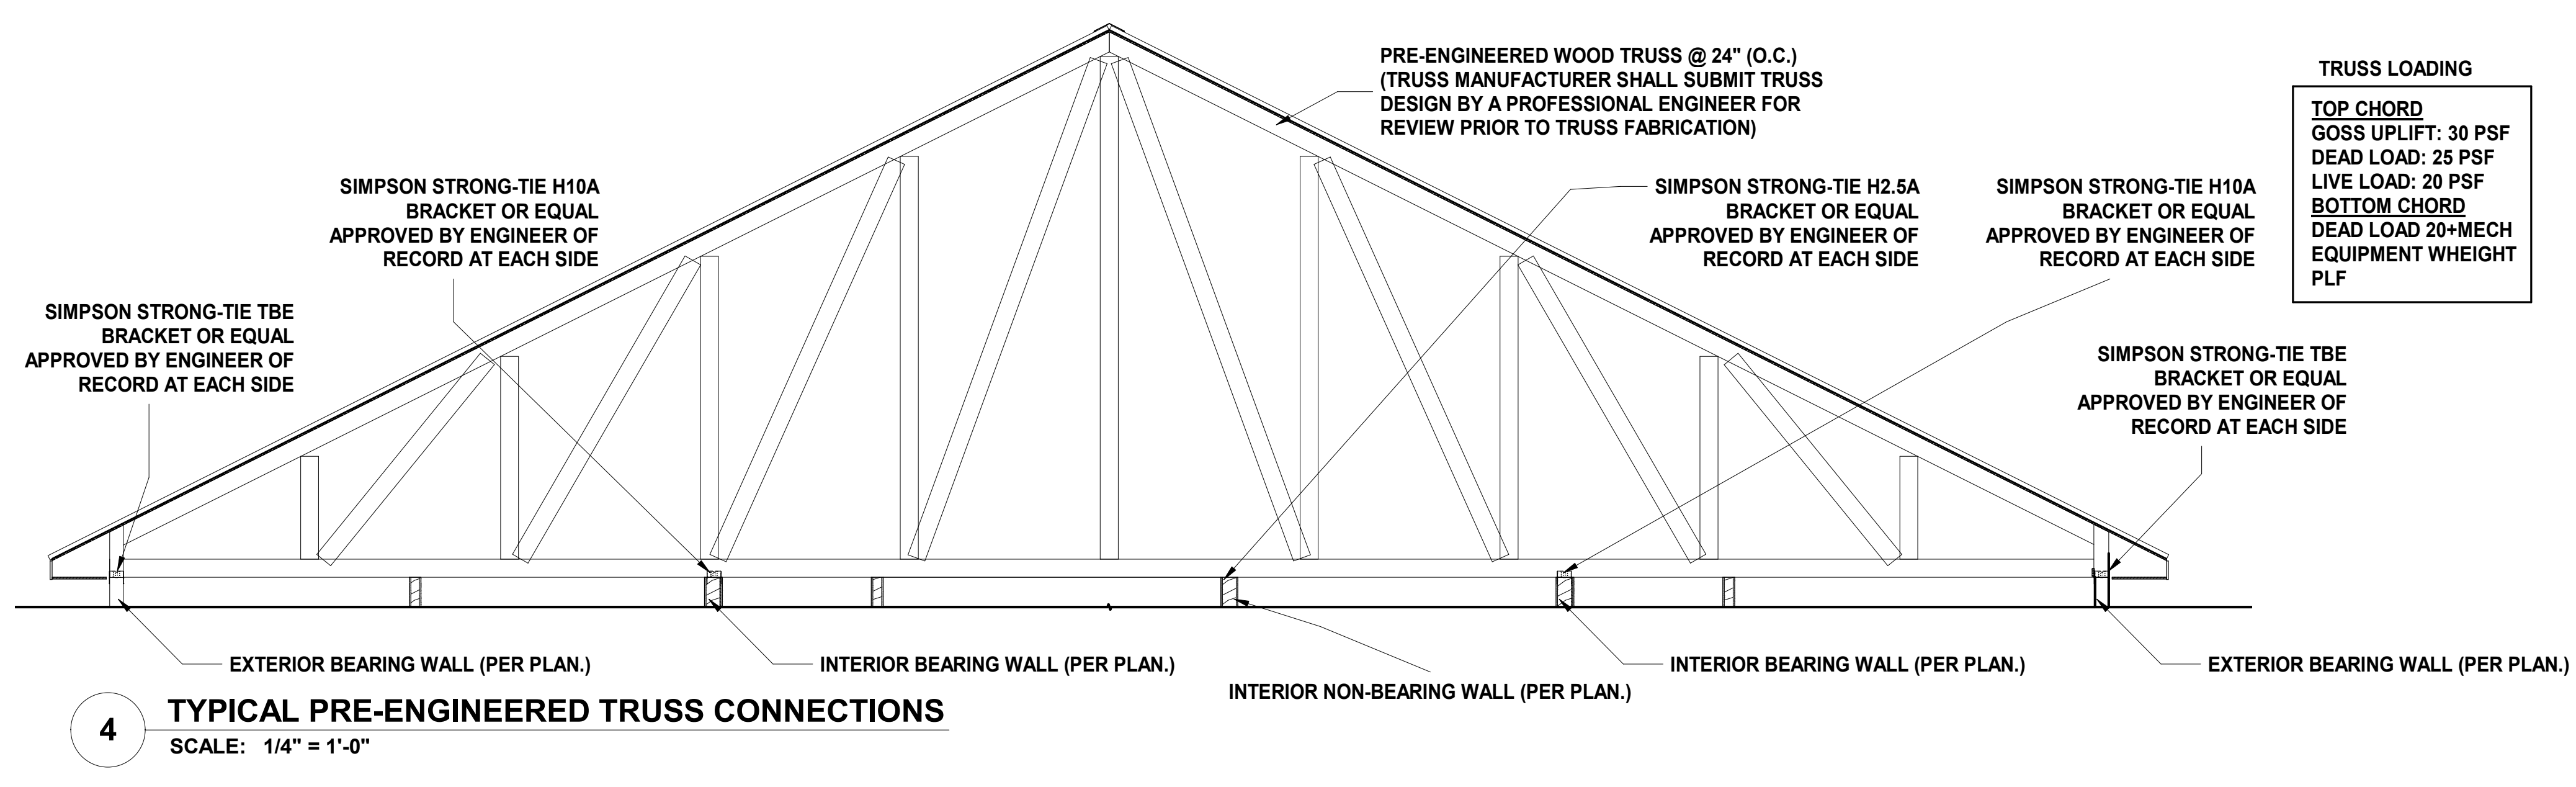

1 ROOF SHEATHING
SCALE: 1" = 1'-0"

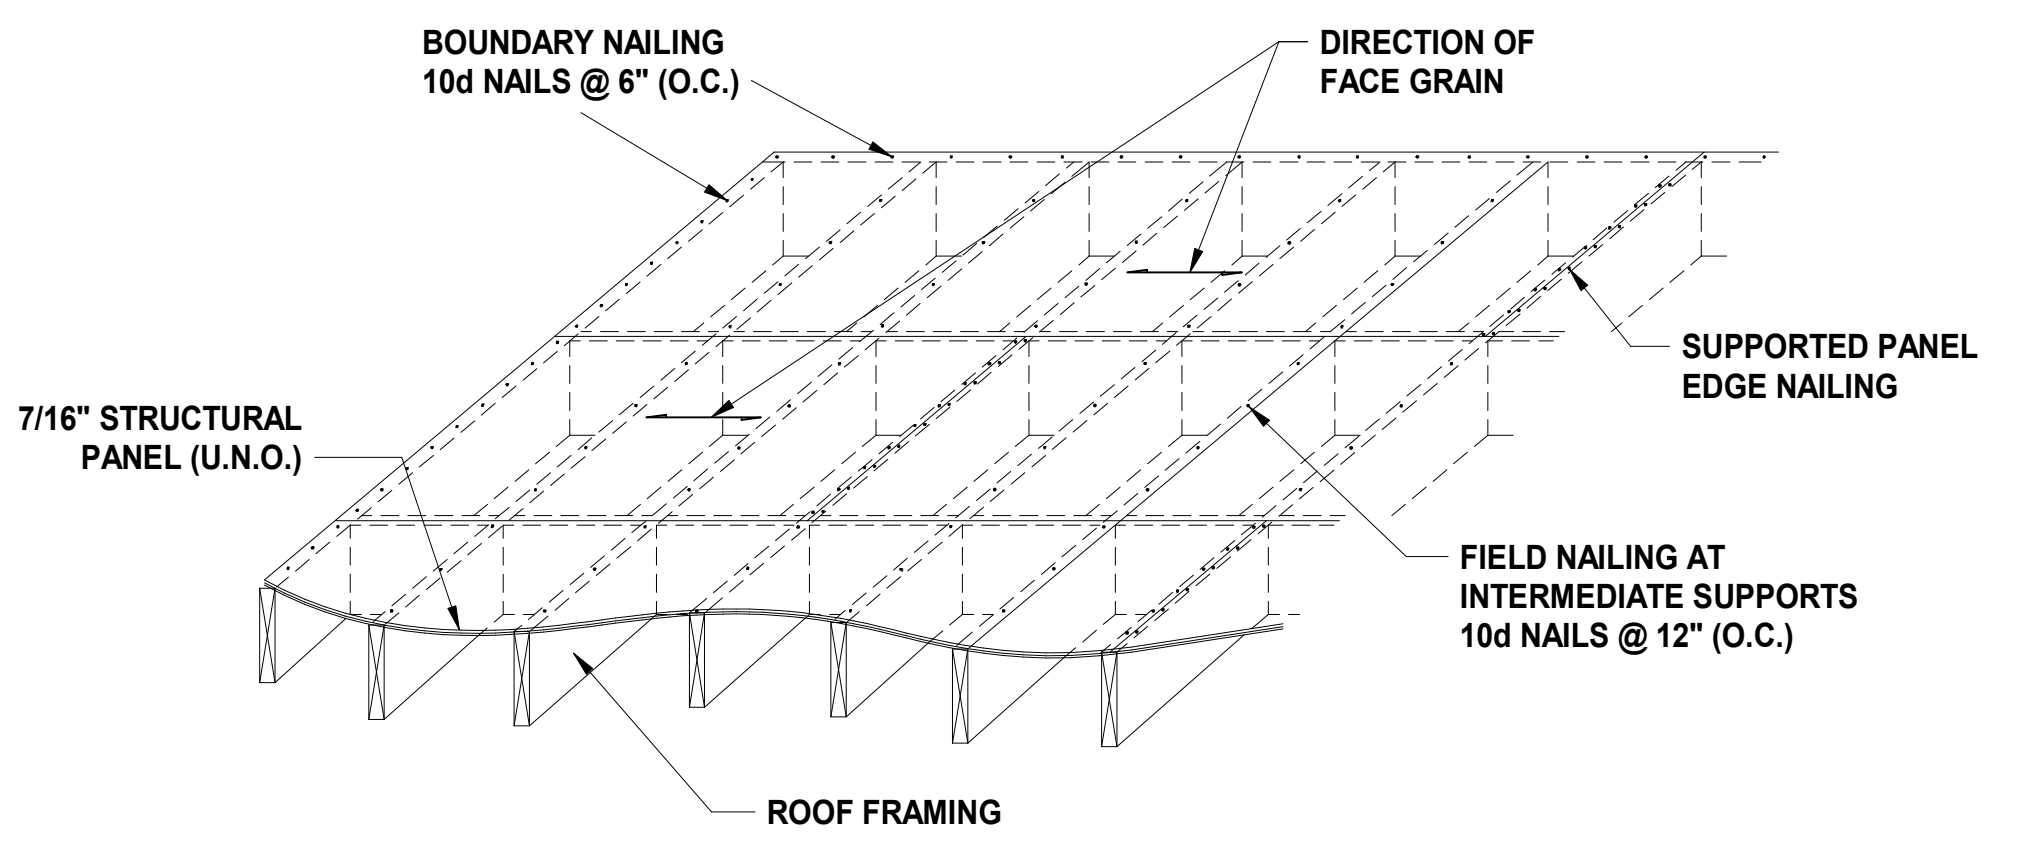


2 TRUSS BEARING WALL CONNECTION
SCALE: 3" = 1'-0"

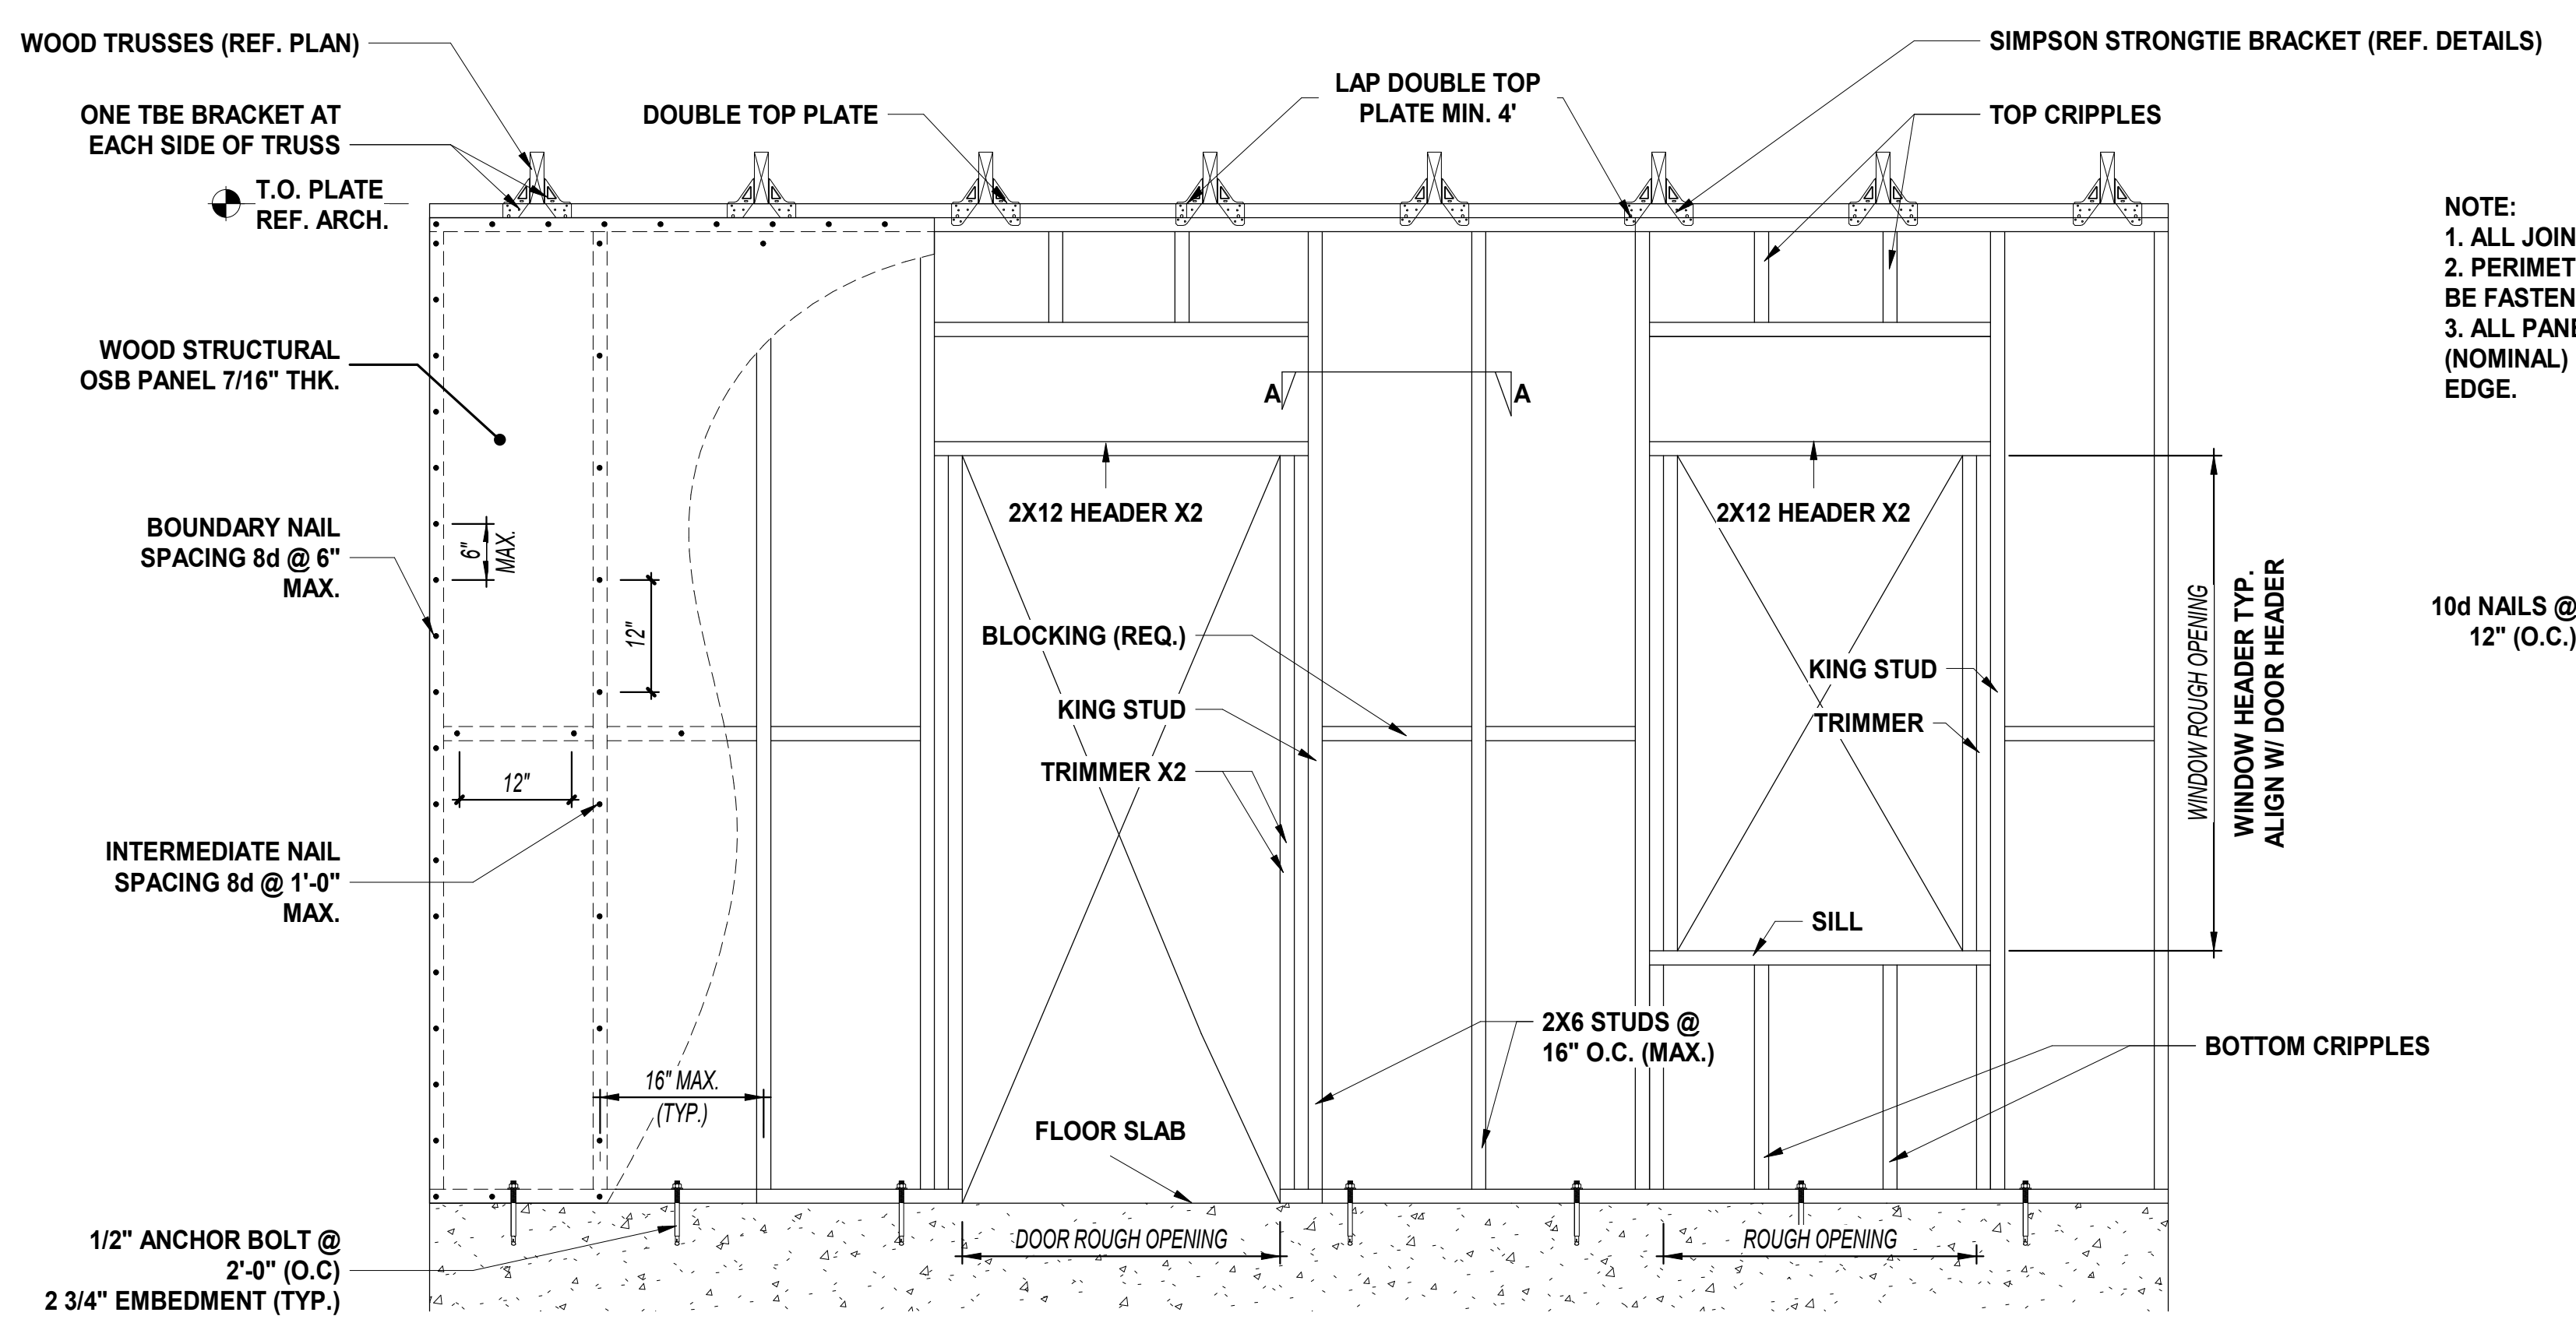


3 SHEAR WALL DETAIL
SCALE: 3/4" = 1'-0"

NOTE:
1. ALL JOINTS SHALL BE SOLID BLOCKED
2. PERIMETER OF WINDOW/DOOR ROUGH OPENINGS SHALL BE FASTENED AS BOUNDARY NAILING.
3. ALL PANEL EDGES SHALL BE BACKED WITH 2" OR WIDER (NOMINAL) FRAMING MEMBERS OR SOLID BLOCKING ON EDGE.

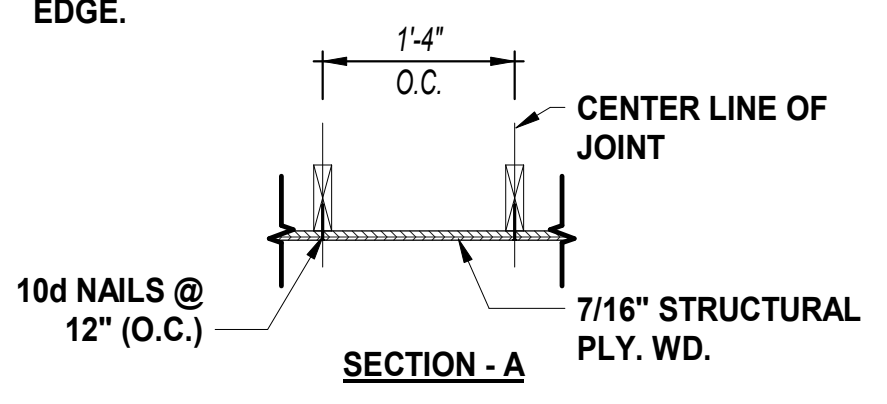

REVISIONS			
REV #	DATE	APPROV	REVISION
10/29/21	JMF	JMF	65% SET
2/16/22	JMF	JMF	ISSUE FOR PERMIT

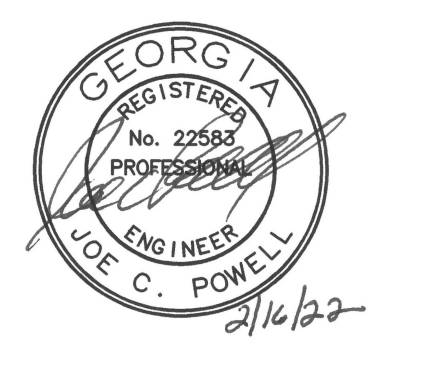


DA PROJECT NUMBER & NAME:
1893
DRAWING TITLE:
**PLUMBING
PLAN -
WASTE AND
VENT**
DRAWING NO:
P100

KITCHEN EQUIPMENT SCHEDULE						
SYMBOL	FIXTURE	RUNOUT SIZE			REMARKS	
		W	CW	HW		
2	HAND SINK	2"	1/2"	1/2"	-	
3	ICE MAKER	FD	1/2"	-	-	
7	ICE/SODA DISPENSER	FD	1/2"	-	-	
8	ICE TEA BREWER	FD	1/2"	-	-	
11	COFFEE BREWER	FD	1/2"	-	-	
21	RANGE	-	-	-	3/4" 302 MBH	
22	CONVECTION OVEN	-	-	-	3/4" 70 MBH	
31	SINK	FS	1/2"	1/2"	-	
34	THREE COMPARTMENT SINK	FS	1/2"	1/2"	-	
38	DISHWASHER	FS	-	3/4"	-	
39	SOILED DISH TABLE	FS	1/2"	1/2"	-	

KEYNOTE (THIS SHEET ONLY)

- 1 MOUNT DRAIN IN WALL PER DETAIL 7/P200

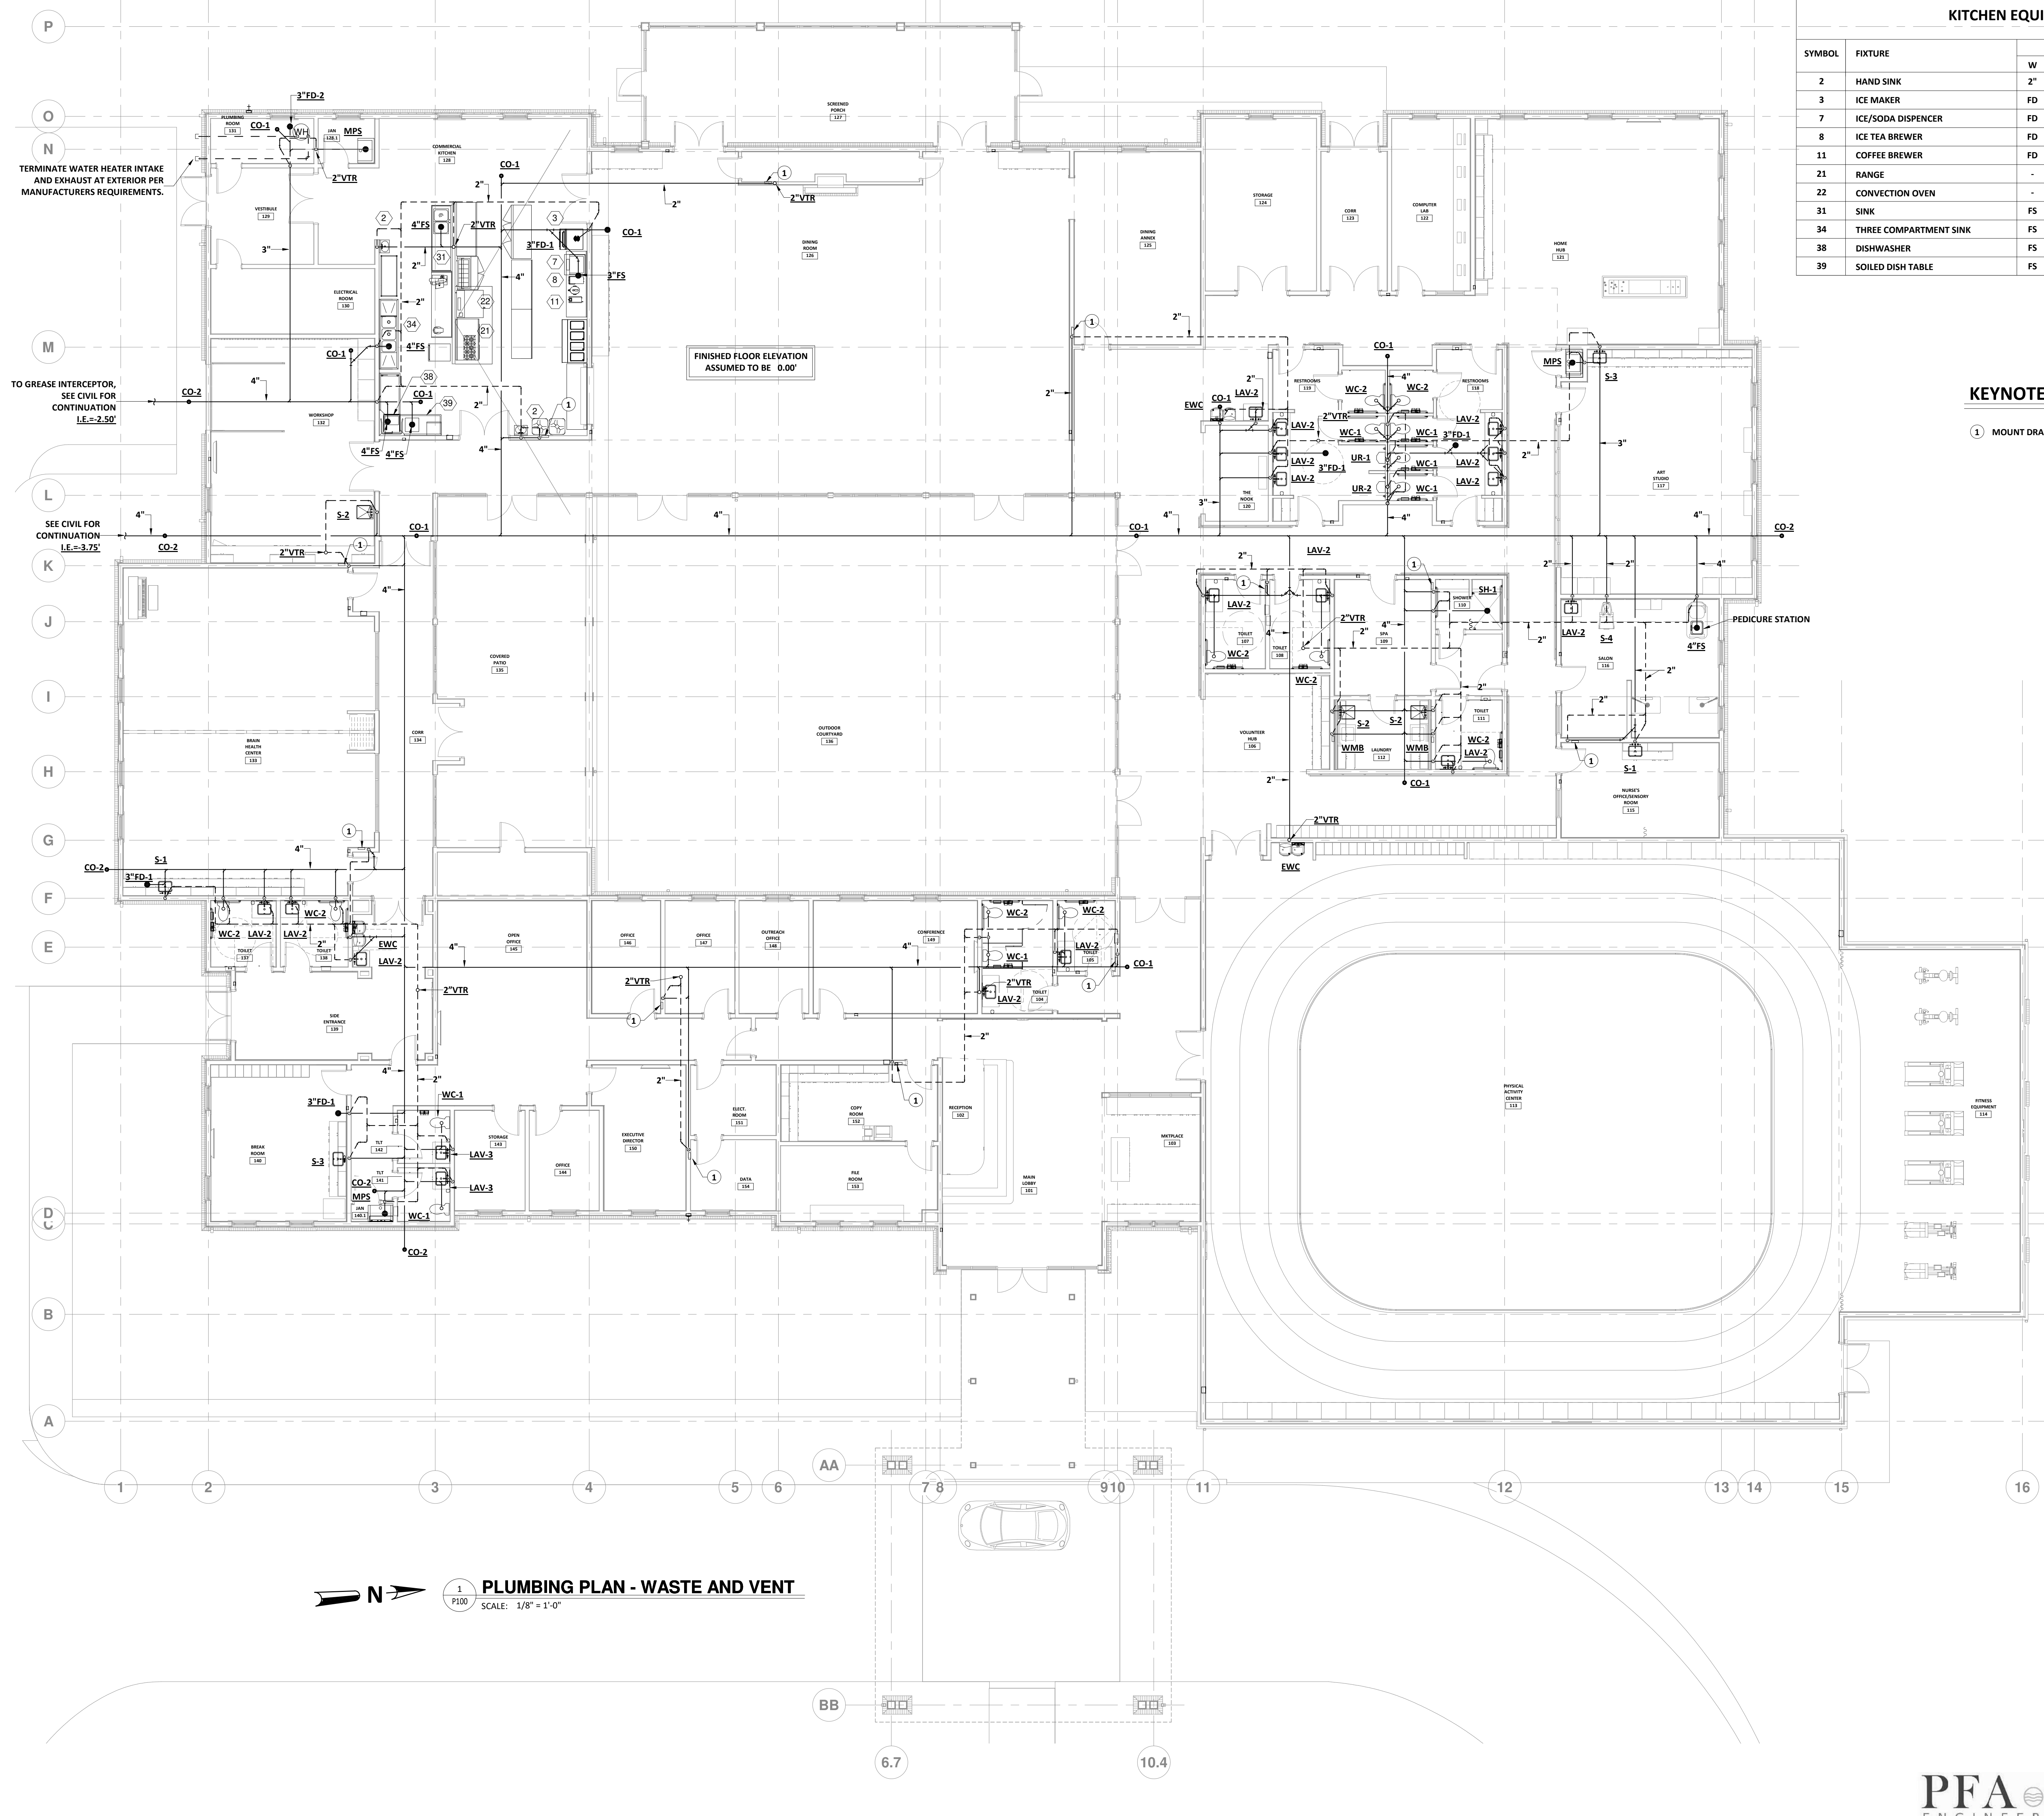


PLUMBING PLAN - WASTE AND VENT
SCALE: 1/8" = 1'-0"

KEYNOTE (THIS SHEET ONLY)

- 1 COORDINATE EMERGENCY SHUTOFF VALVE ON GAS SUPPLY WITH HOOD FIRE SUPPRESSION SYSTEM.
- 2 1/2" HW AND CW DN TO PEDICURE SUPPLY STOPS AT 12" A.F. AND CONNECT TO EQUIPMENT.

REVISIONS			
REV #	DATE	APPROV BY	REVISION
1	10/29/21	JMF	65% SET
2	2/16/22	JMF	ISSUE FOR PERMIT

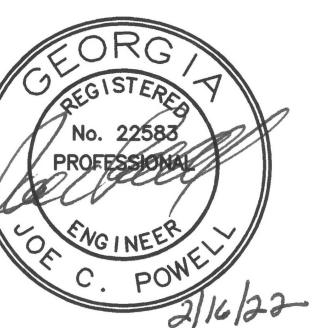


DA PROJECT NUMBER & NAME:
1893

DRAWING TITLE:
**PLUMBING
PLAN -
WATER AND
GAS**


DRAWING NO.:

P101

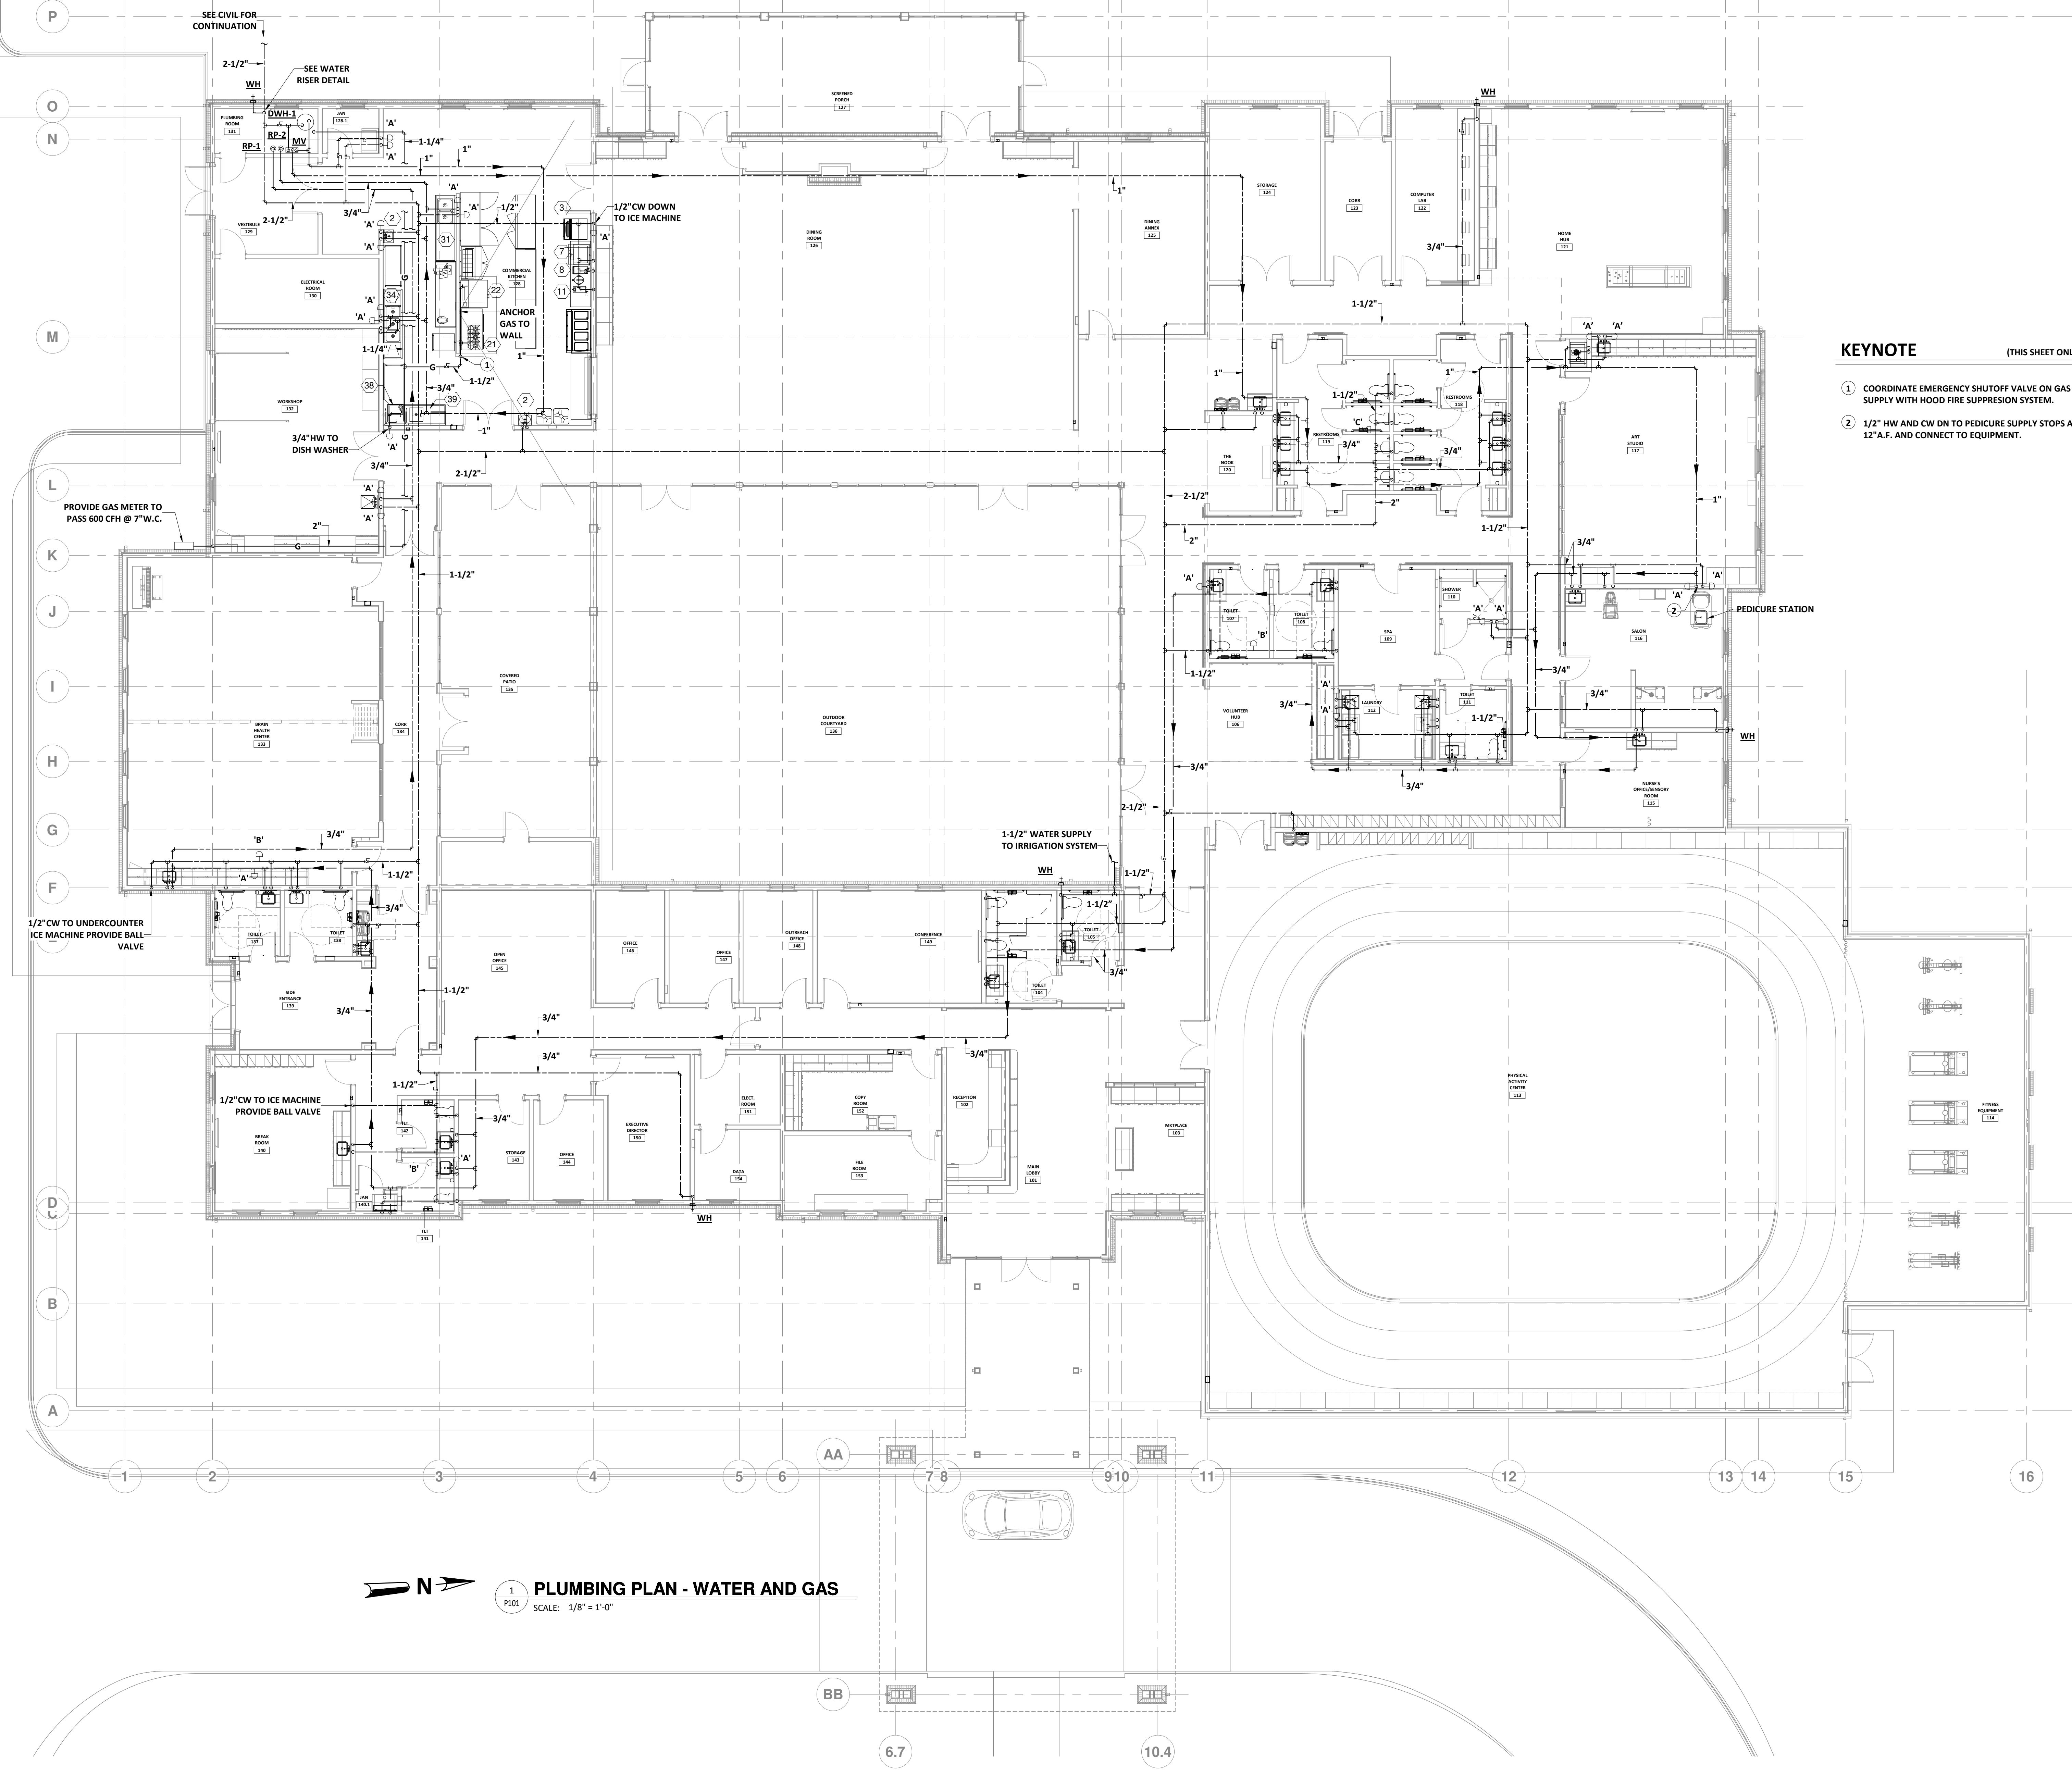


PLUMBING PLAN - WATER AND GAS
SCALE: 1/8" = 1'-0"


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P O N M L K J I H G F D C B A
AA BB 6.7 10.4
7-8 9-10 11 12 13 14 15 16

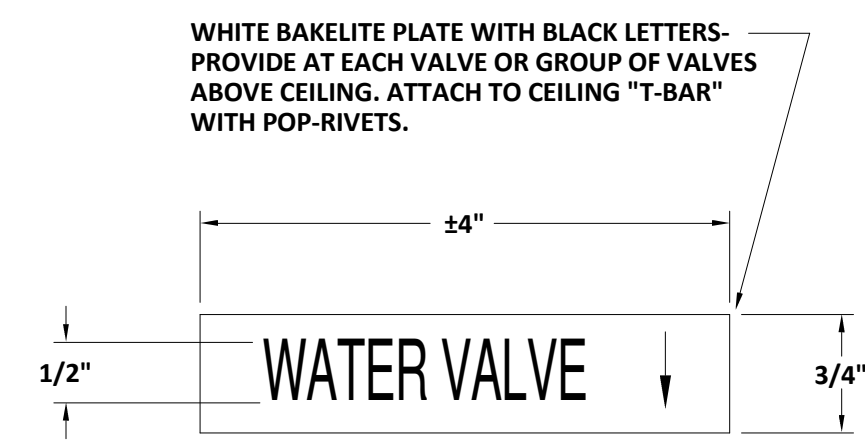


1 WATER VALVE LOCATOR TAG
P200 NOT TO SCALE

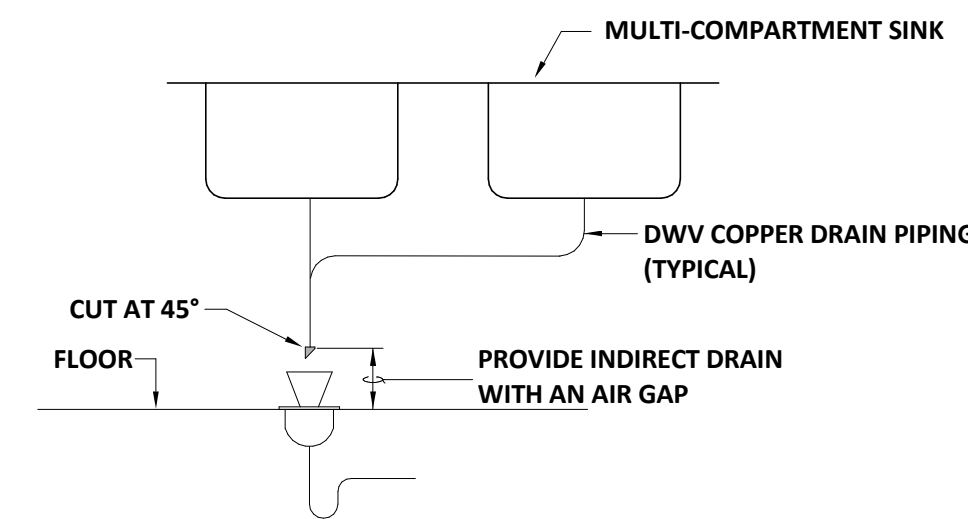


5 MULTI-COMPARTMENT SINK DETAIL
P200 NOT TO SCALE

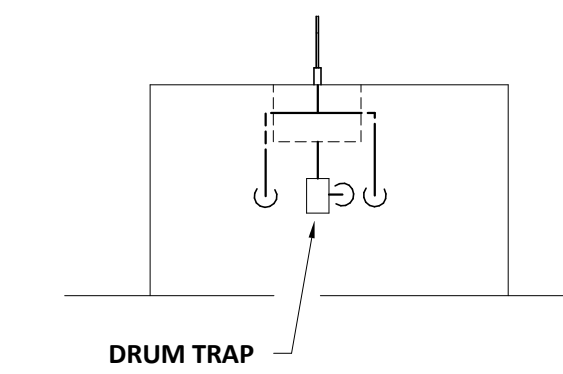


9 DRUM TRAP DETAIL
P200 SCHEMATIC ONLY

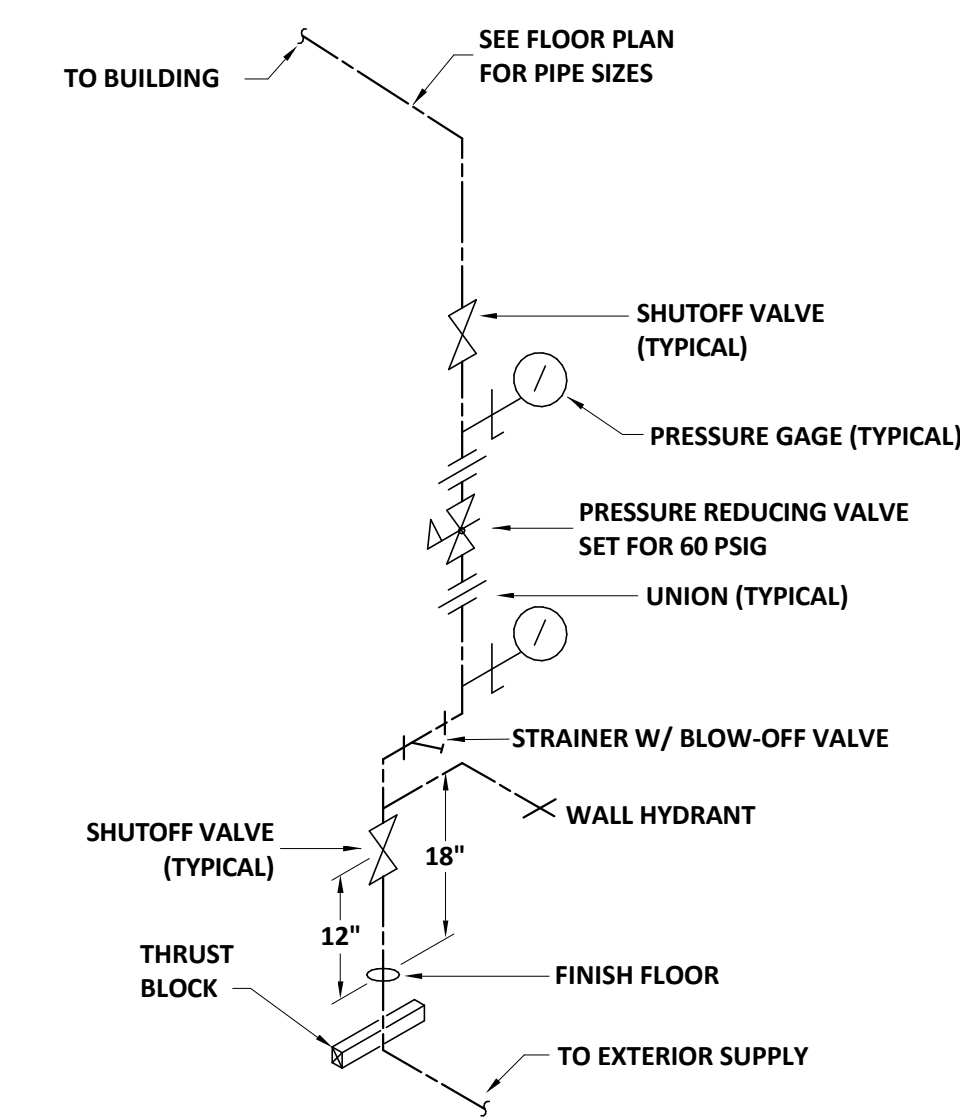


2 PLUMBING DOMESTIC WATER RISER
P200 SCHEMATIC ONLY

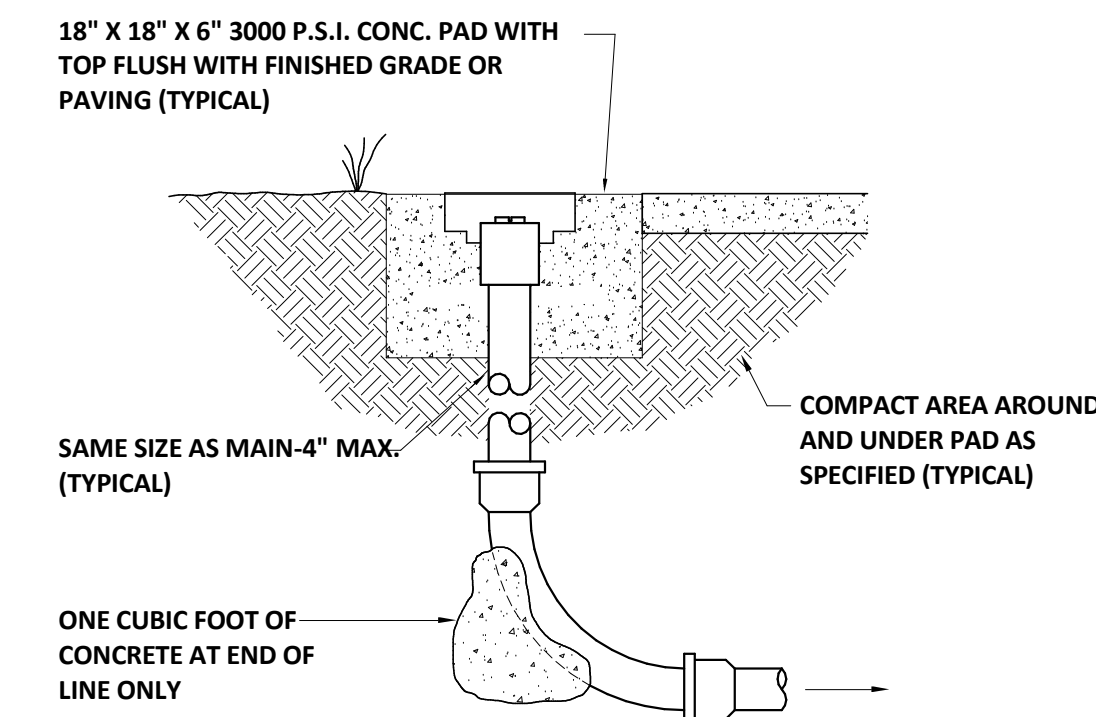


6 CLEANOUT DETAILS
P200 SCHEMATIC ONLY

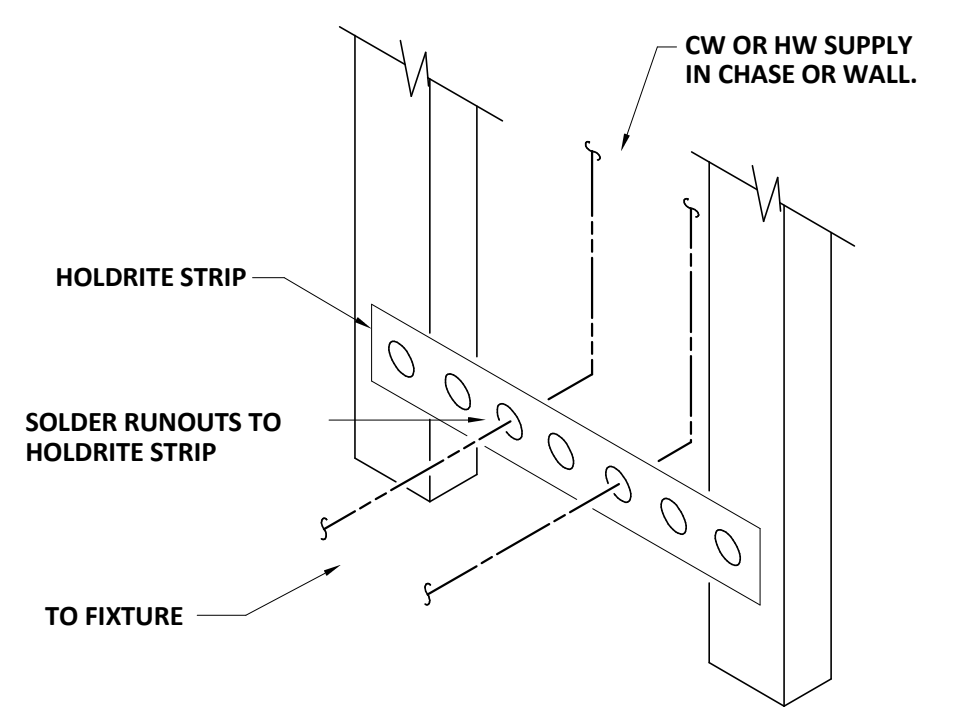


3 RUNOUT ANCHOR DETAILS
P200 SCHEMATIC

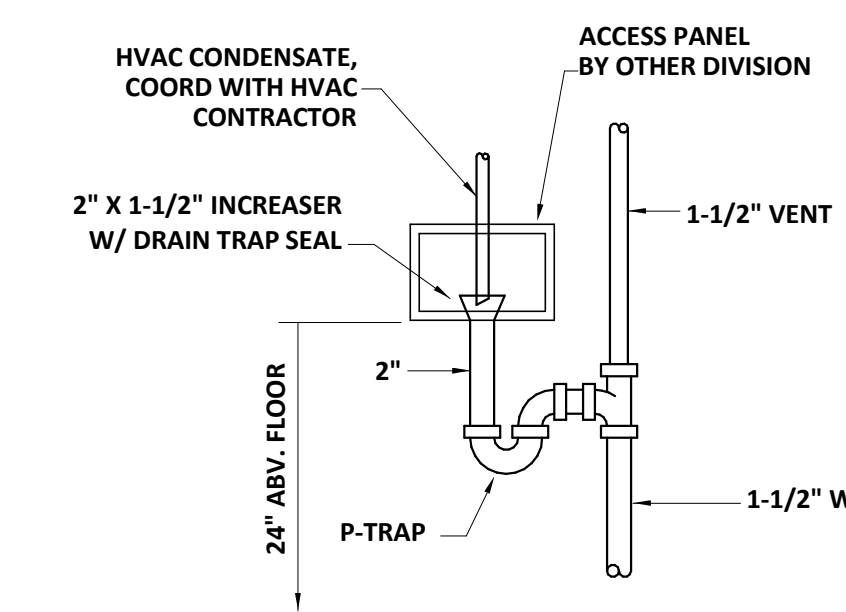

7 CONDENSATE DRAIN OUTLET
P201 SCHEMATIC ONLY

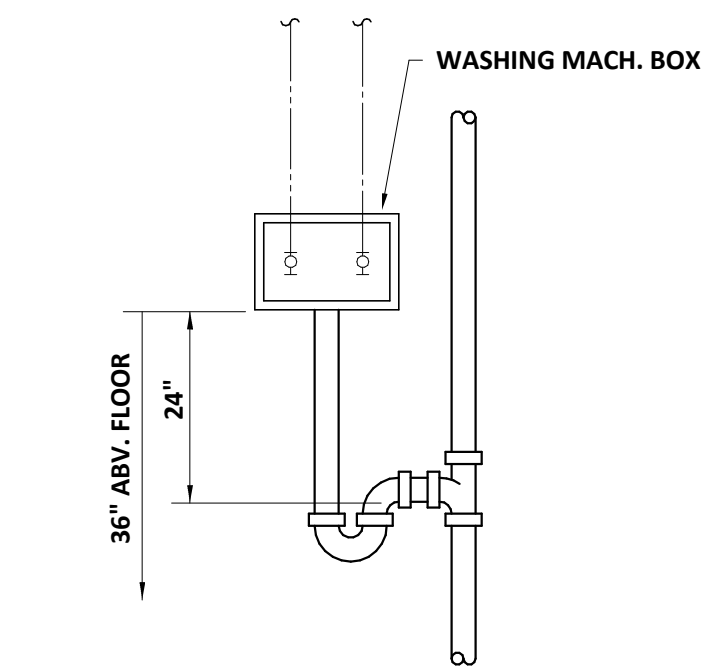


4 WASHING MACHINE BOX DETAIL
P200 SCHEMATIC ONLY

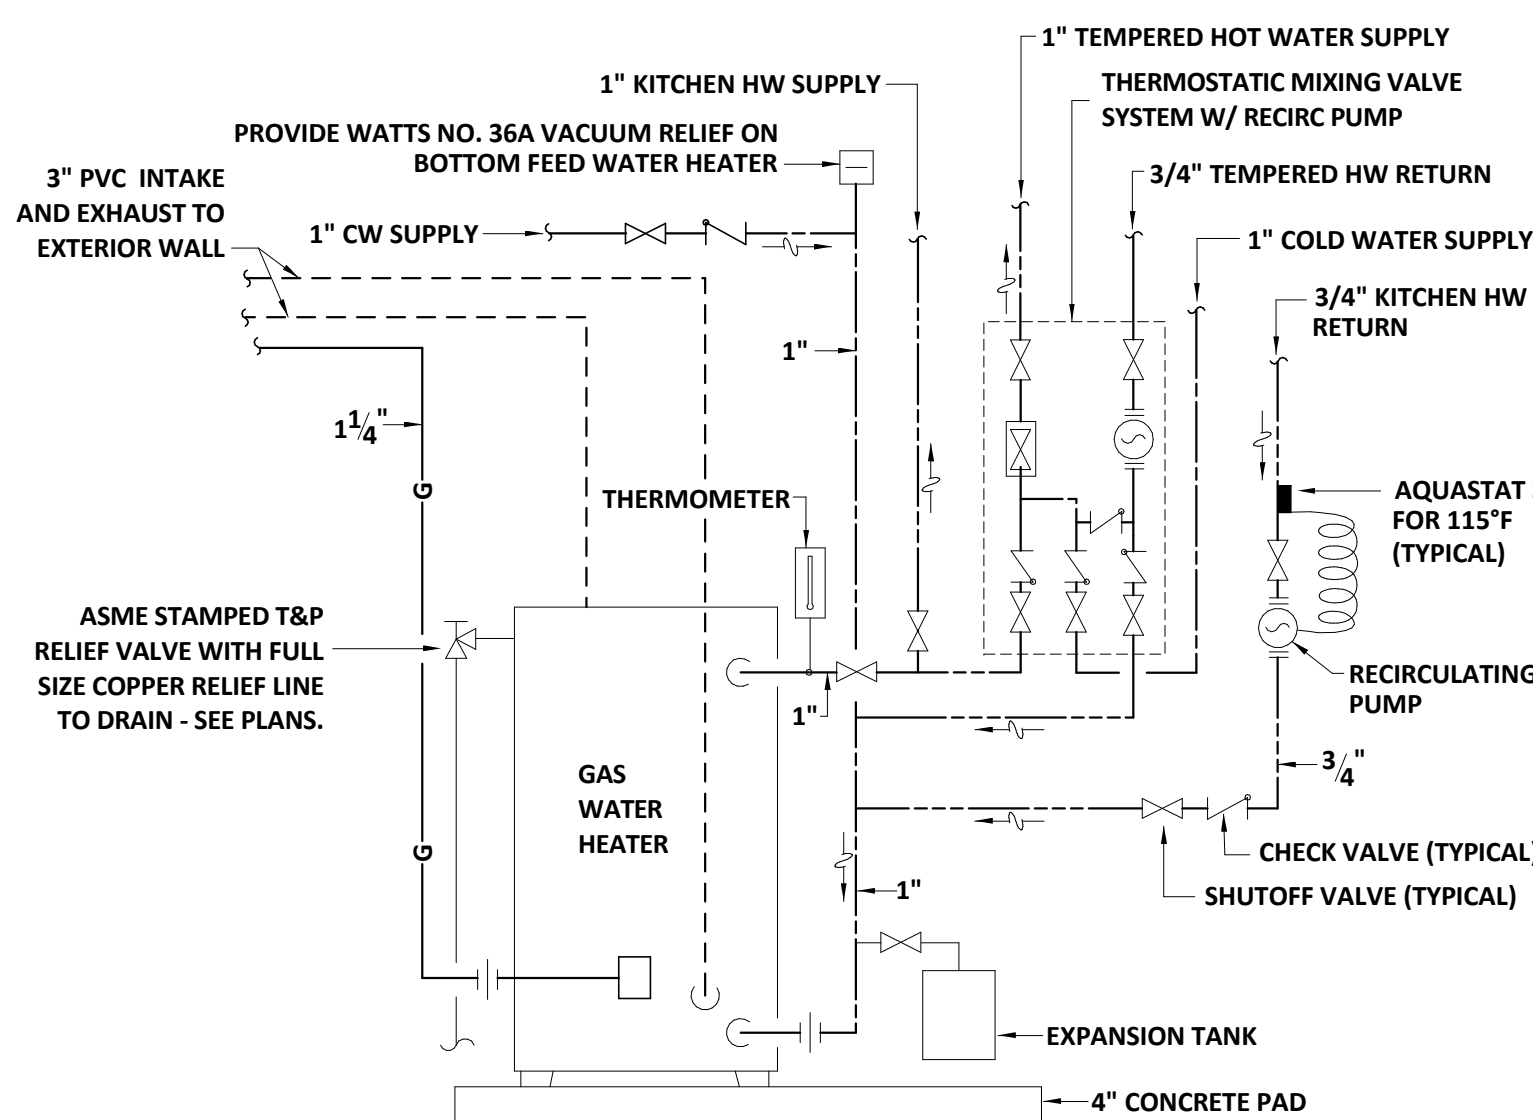

8 WATER HEATER PIPING DETAIL
P200 NOT TO SCALE

REVISIONS			
REV #	DATE	APRVD BY	REVISION
1	2/16/22	JMF	ISSUE FOR PERMIT



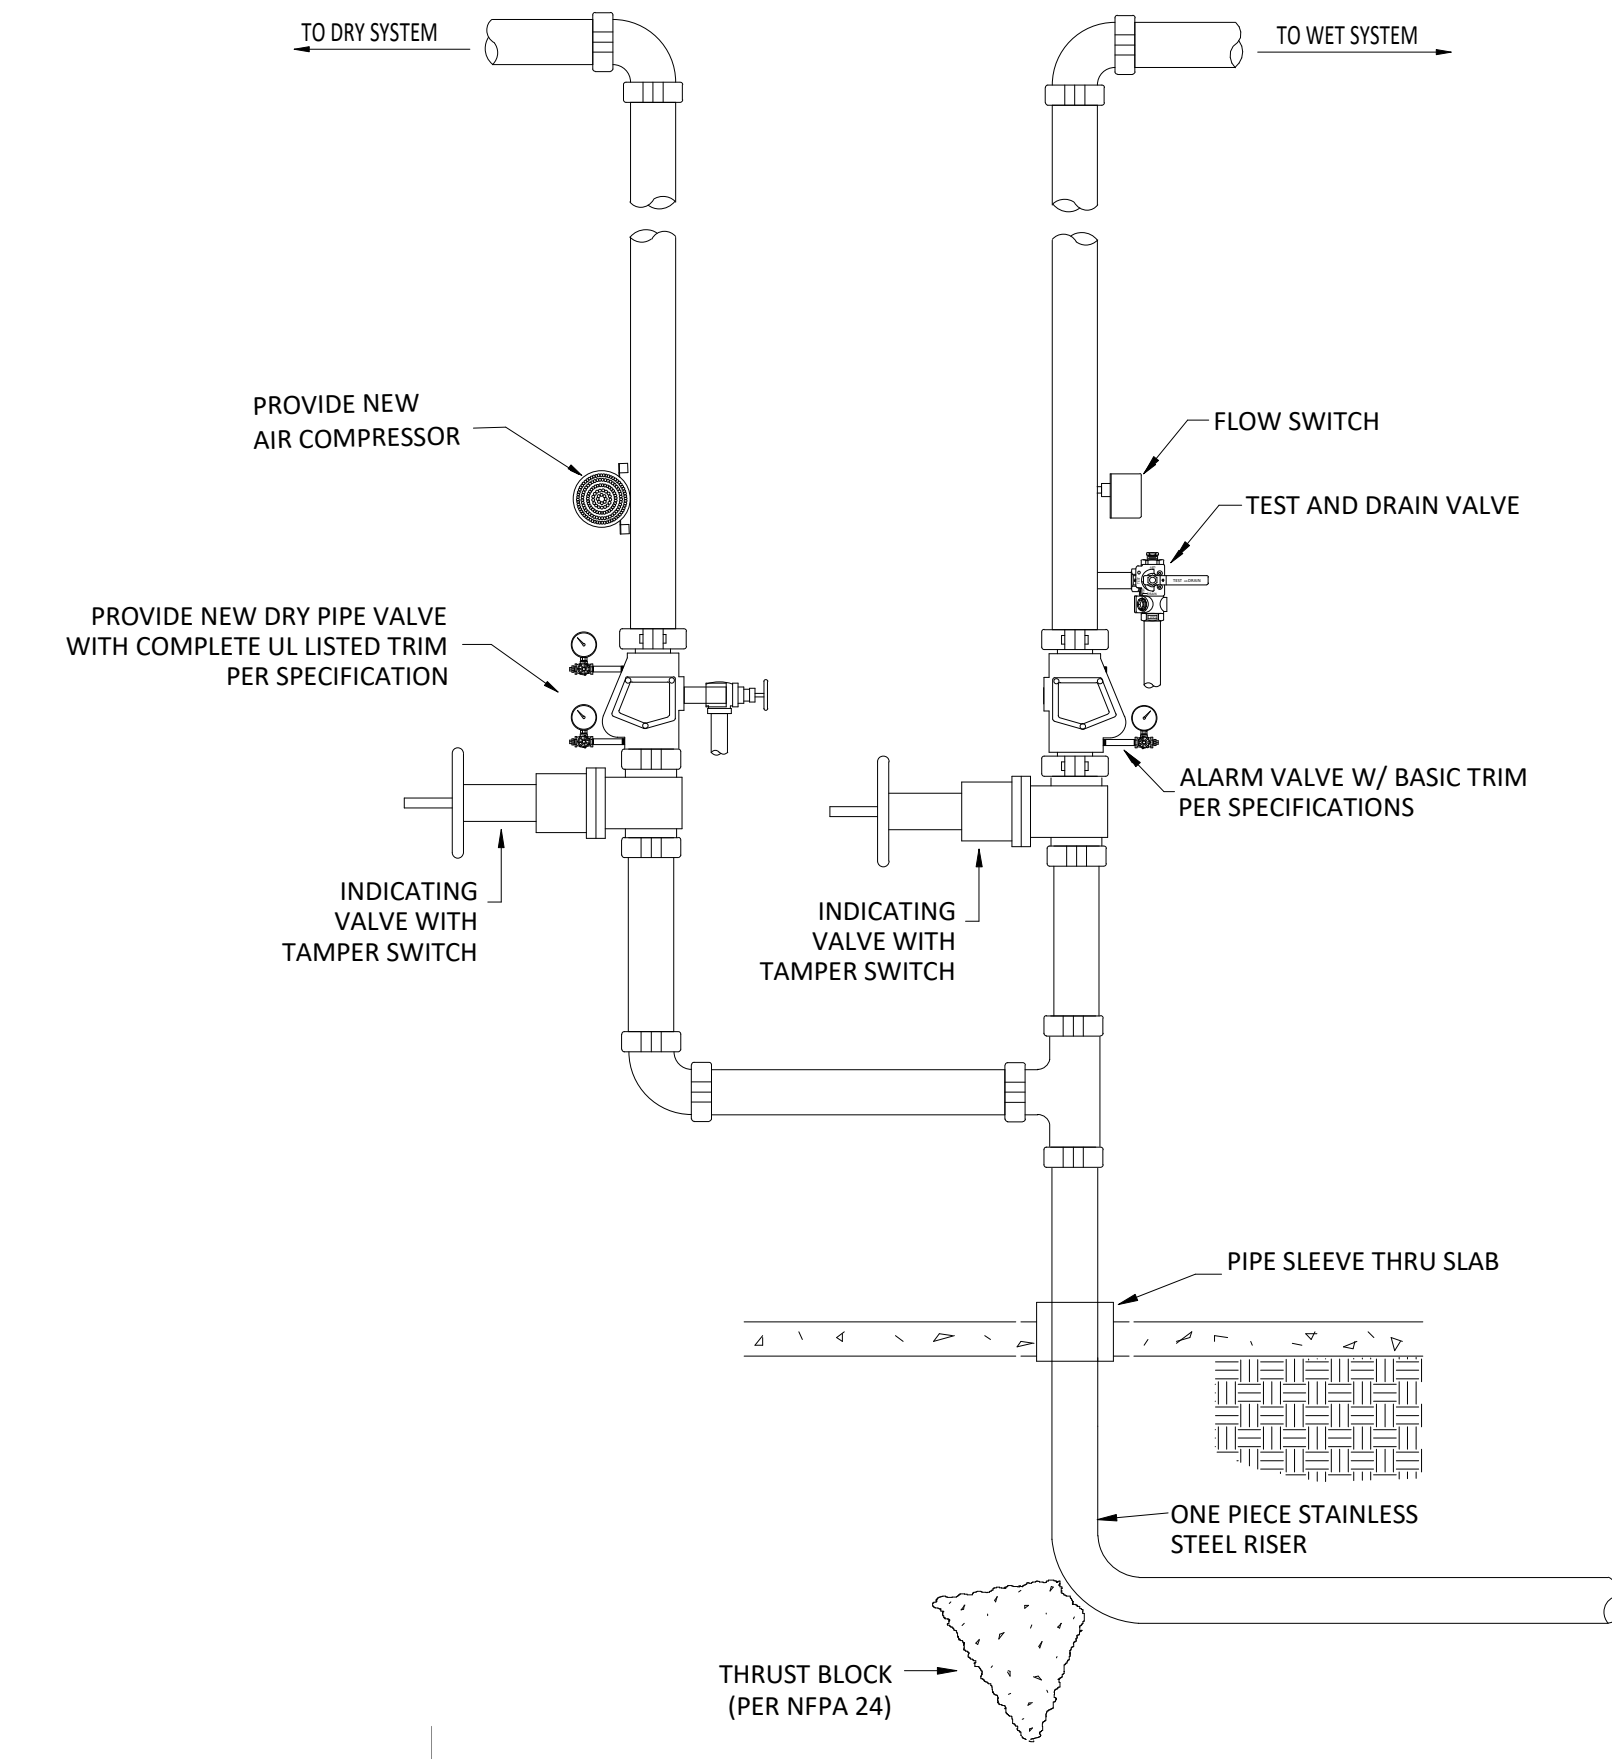

2 FIRE SPRINKLER RISER - NEW WORK
FP100 NOT TO SCALE


GENERAL FIRE PROTECTION NOTES

- PROVIDE WET PIPE SPRINKLER SYSTEM IN BUILDING INCLUDING INSULATED PORTIONS OF COMBUSTIBLE ATTIC SPACE.
- PROTECT PORCH AND CORRESPONDING ATTICS WITH DRY PIPE SYSTEM.
- PROTECT PORTE COCHERE WITH DRY PIPE SYSTEM.
- SPRINKLER SYSTEM SHALL BE DESIGNED IN ACCORDANCE WITH NFPA 13 (2019), INTERNATIONAL BUILDING CODE, GEORGIA FIRE CODE 120-3-3 (2020) AND SPECIFICATIONS. PROVIDE SHOP DRAWINGS AND EQUIPMENT SUBMITTALS FOR REVIEW BY ENGINEER, AHI AND OWNER.
- EXACT LOCATIONS AND ROUGHING REQUIREMENTS FOR PIPING AND EQUIPMENT SHALL BE DETERMINED FROM ARCHITECTURAL DRAWINGS, LARGE SCALE DETAILS AND APPROVED MANUFACTURER'S SHOP DRAWINGS. PARTICULAR ATTENTION SHALL BE DIRECTED TO EQUIPMENT AND FIXTURES FURNISHED UNDER OTHER DIVISIONS.
- EXACT LOCATION OF PIPING SHALL BE DETERMINED BY JOB CONDITIONS. CONTRACTOR SHALL COORDINATE THE INSTALLATION OF HIS WORK WITH THAT OF OTHER TRADES AND ARRANGE PIPING TO CLEAR STRUCTURAL MEMBERS AND DUCTWORK.
- IN FIRE WALLS, PACK ANNULAR SPACE BETWEEN PIPE AND WALL WITH FIRESTOP COMPOUND IN ACCORDANCE WITH ITS U.L. LISTING.
- PROVIDE WHITE, CONCEALED SPRINKLERS IN AREAS WITH FINISHED CEILING UNLESS NOTED OTHERWISE. LOCATE SPRINKLERS IN THE CENTER OF ACOUSTICAL TILE.
- PROVIDE BRASS UPRIGHT SPRINKLERS IN ATTIC SPACE AND IN CEILING SPACE BELOW ATTIC FLOOR. PROVIDE PROTECTIVE CAGES ON SPRINKLERS WHERE SPRINKLERS COULD BE SUBJECT TO DAMAGE.
- PROVIDE INTERMEDIATE - TEMPERATURE, QUICK - RESPONSE SPRINKLERS.

HAZARD CLASSIFICATION

- ALL AREAS ARE LIGHT HAZARD UNLESS NOTED OTHERWISE
- (01) ORDINARY HAZARD GROUP 1

REVISIONS				
REV #	DATE	APPROV	BY	REVISION
10/29/21	JMF			65% SET
2/16/22	JMF			ISSUE FOR PERMIT

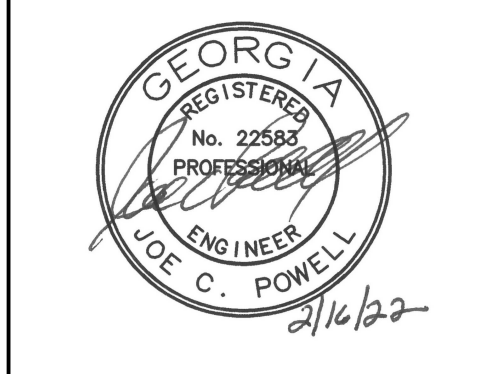

DA PROJECT NUMBER & NAME:
1893
DRAWING TITLE:
**FIRE
PROTECTION
PLAN**

DRAWING NO:
FP100


PFA
ENGINEERING
1501 BROAD STREET, SUITE 200, AUGUSTA, GEORGIA 30901
706-722-3909 • FAX: 706-724-5827 • www.pfaengineers.com
GA LIC. PE#000760 EXP. 06/30/2022

DATE: 03/30/21
FILE NAME: 21011 MECH
PLOT SCALE: 1" = 96'
RWW

1" REFERENCE SCALE
1/4 1/2 3/4


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Augusta, GA 30901 (706) 722-3909

1 FIRE PROTECTION PLAN
SCALE: 1/8" = 1'-0"

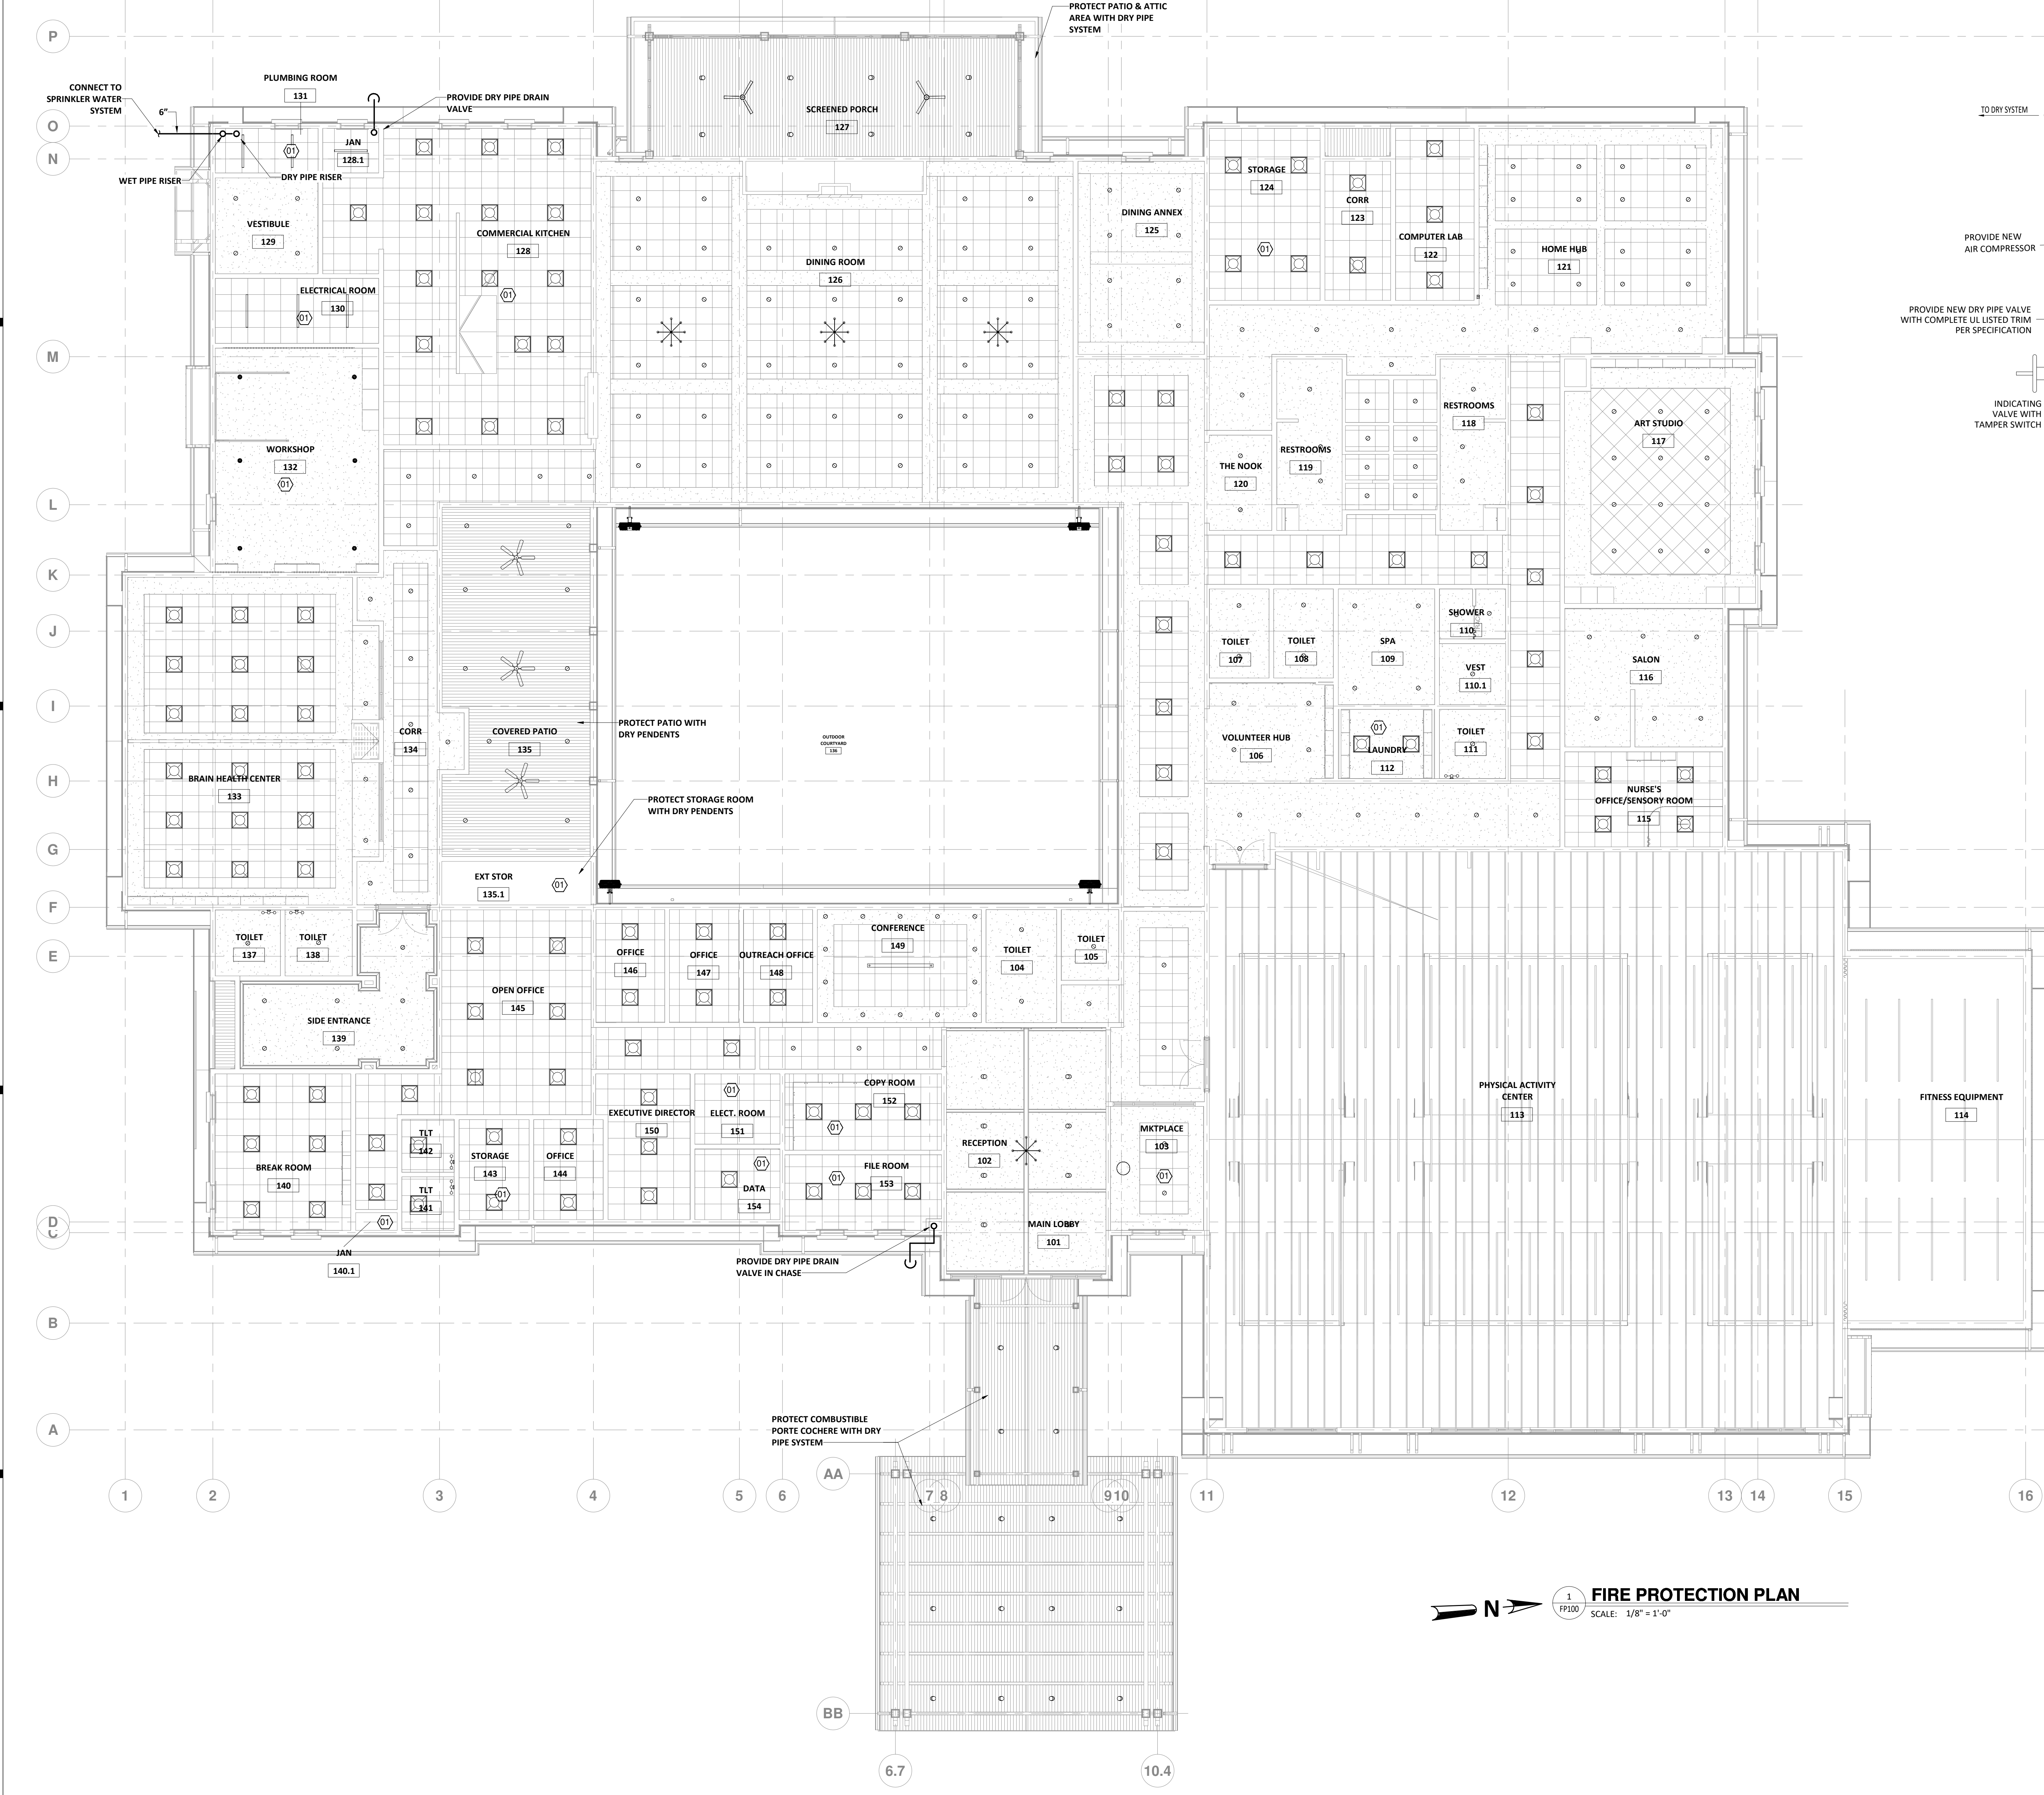



REVISIONS			
REV #	DATE	APRVD BY	REVISION
1	10/29/21	JMF	65% SET
2	2/16/22	JMF	ISSUE FOR PERMIT

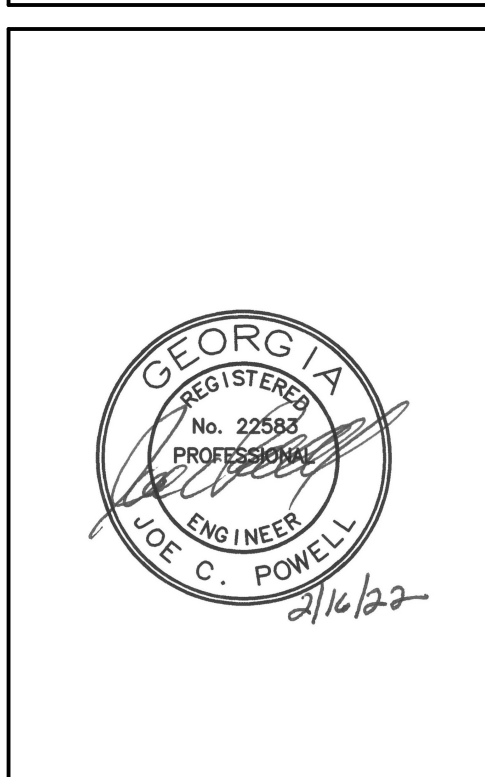

1 FIRE PROTECTION PLAN - ATTIC
SCALE: 1/8" = 1'-0"

REV #	DATE	APPROV	BY	REVISION
04/16/21	JMF			35% SET
11/17/21	JMF			65% SET
2/16/22	JMF			ISSUE FOR PERMIT

REVISIONS

REV #	DATE	APPROV	BY	REVISION
04/16/21	JMF			35% SET
11/17/21	JMF			65% SET
2/16/22	JMF			ISSUE FOR PERMIT

REVISIONS


REV #	DATE	APPROV	BY	REVISION
04/16/21	JMF			35% SET
11/17/21	JMF			65% SET
2/16/22	JMF			ISSUE FOR PERMIT



DA PROJECT NUMBER & NAME:
1893


DRAWING TITLE:
HVAC PLAN

DRAWING NO:
M101

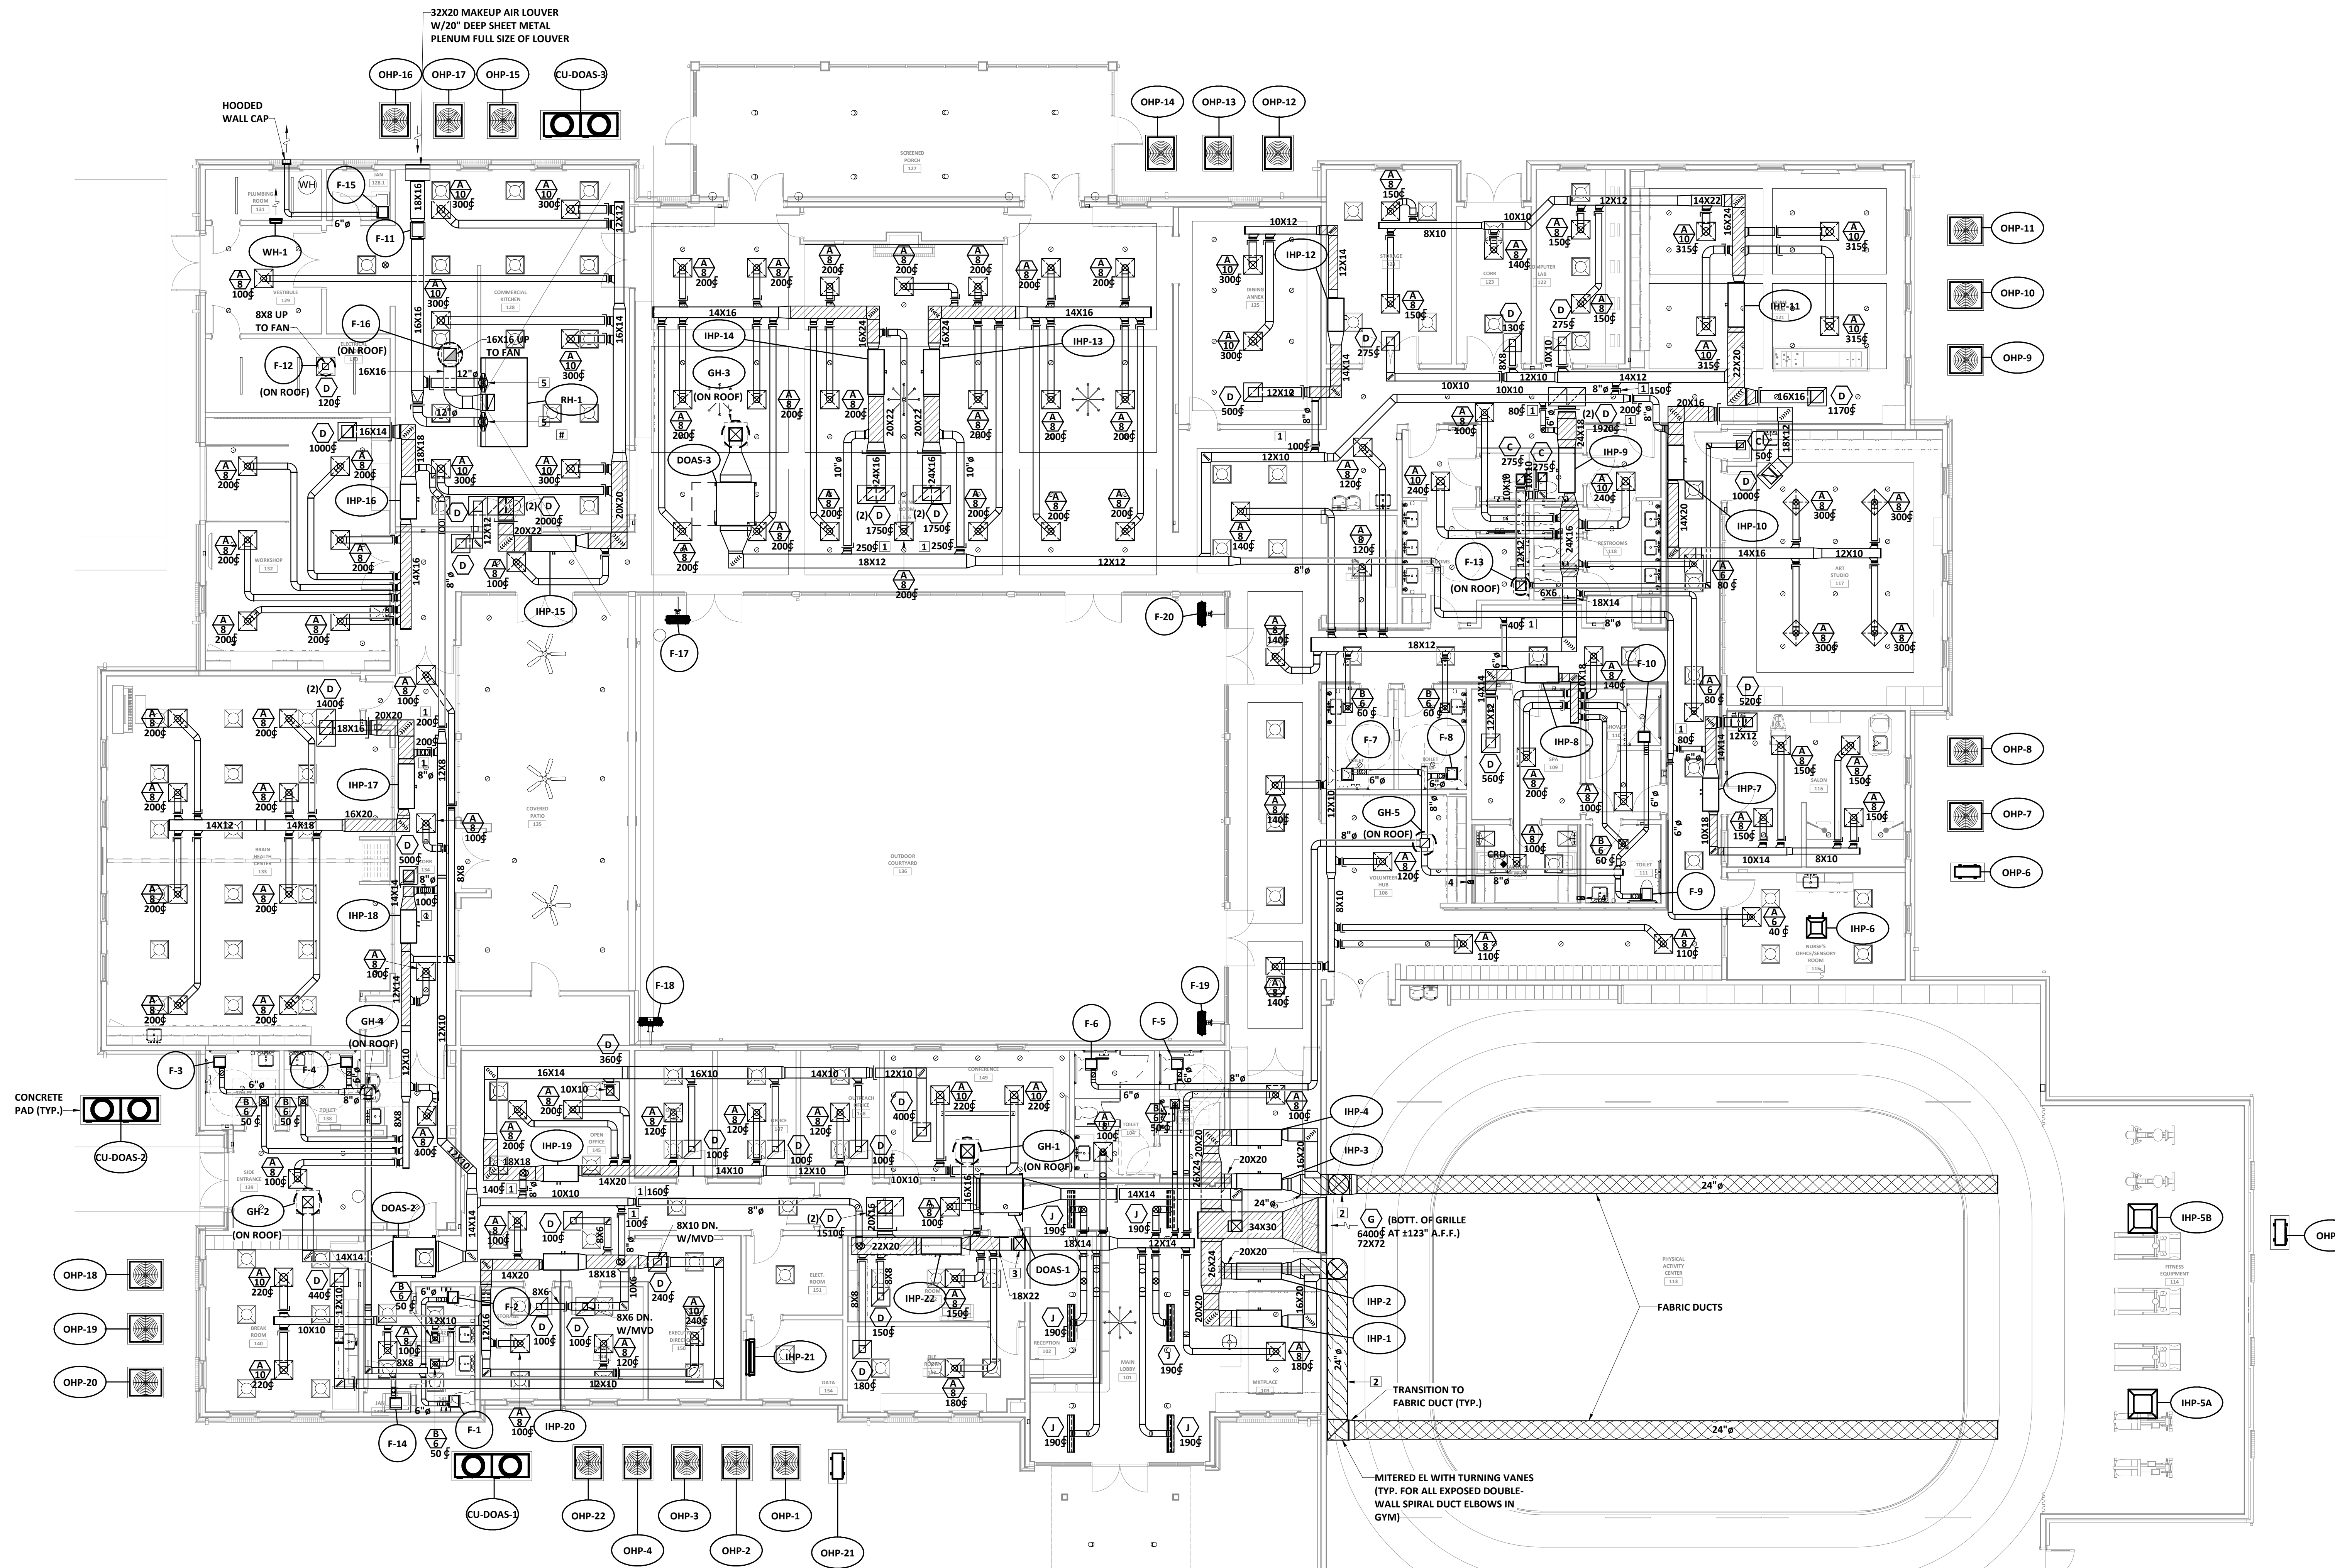

- KEYNOTES** (THIS SHEET ONLY)
- BALANCE OUTSIDE AIR TO AIRFLOW VALUE SHOWN.
 - EXPOSED DUCT TO BE DOUBLE-WALL SPIRAL, PAINT-GRIP FINISH. PAINT COLOR SELECTED BY ARCHITECT.
 - OFFSET 18X14 UP TO ABOVE VAULTED CEILING IN MAIN LOBBY 101.
 - DRYER VENT THROUGH ROOF.
 - TRANSITION TO HOOD CONNECTION SIZE IN VERTICAL.

1 HVAC NEW WORK PLAN
SCALE: 1/8" = 1'-0"

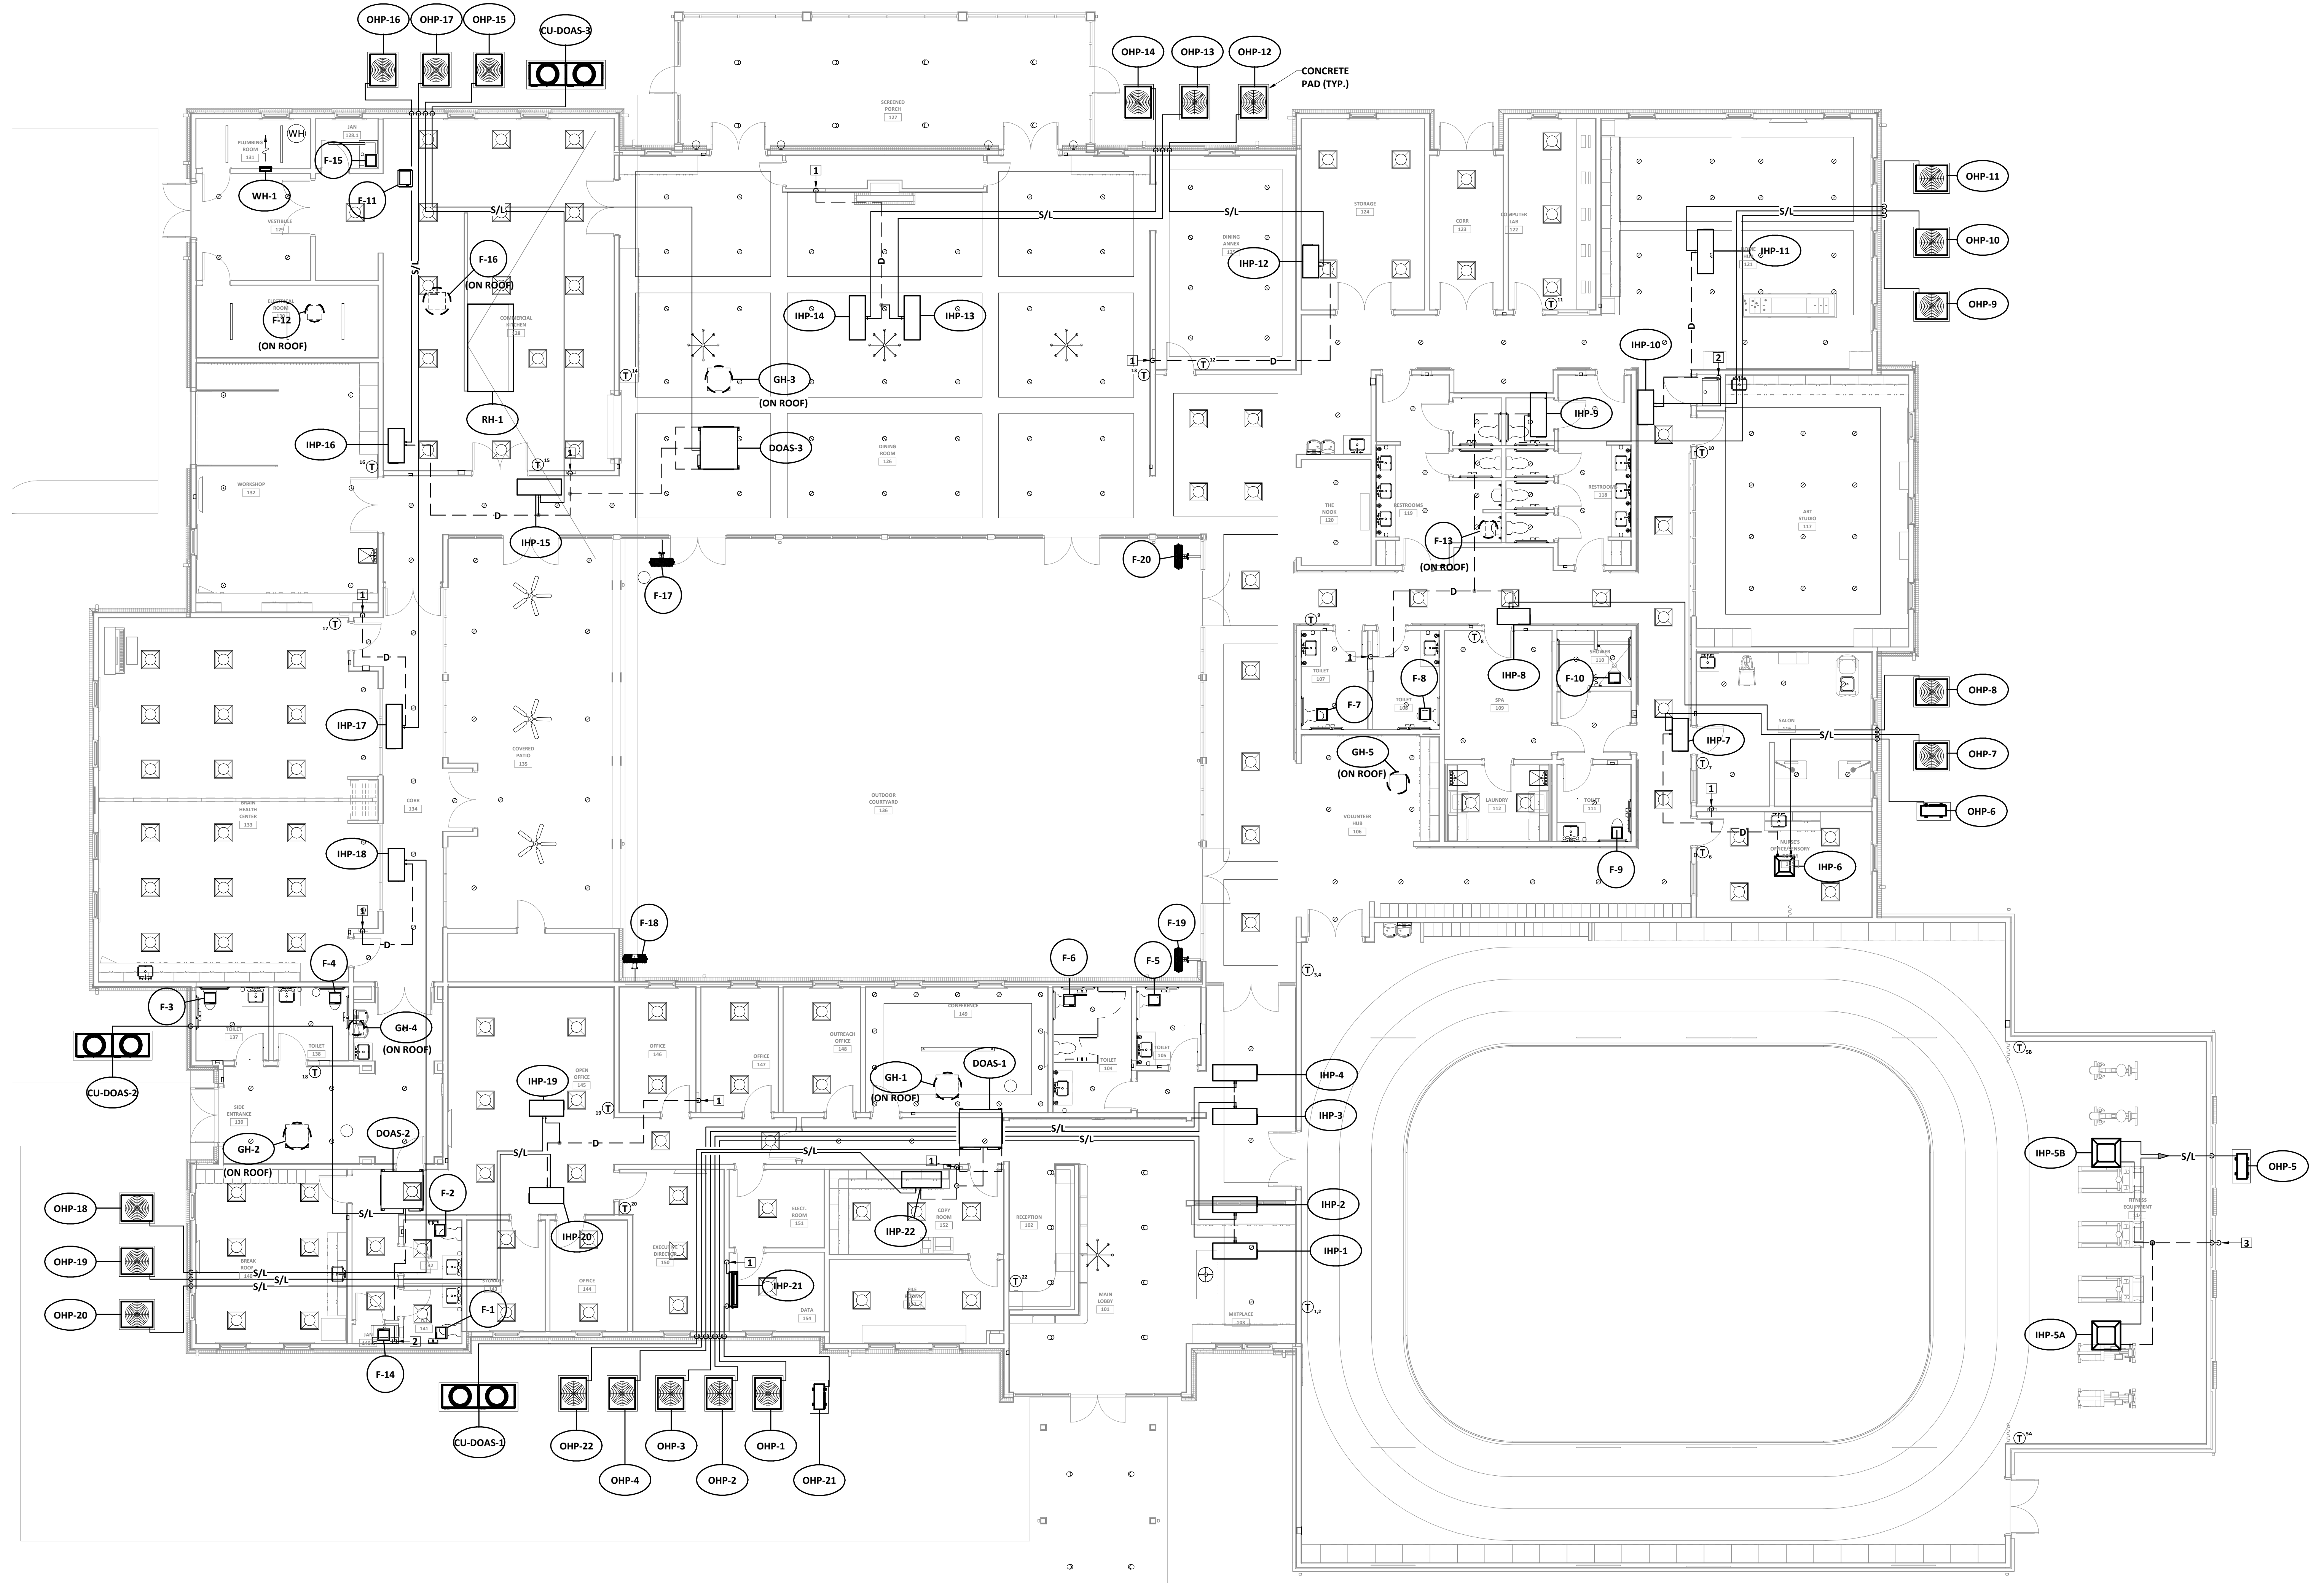

1 HVAC PIPING PLAN
SCALE: 3/8" = 1'-0"

KEYNOTES (THIS SHEET ONLY)

- 1 DISCHARGE CONDENSATE IN WALL BOX BY PLUMBING. SEE PLUMBING DRAWINGS.
- 2 ROUTE CONDENSATE AND DISCHARGE INTO JANITOR SINK.
- 3 ROUTE CONDENSATE DOWN IN WALL AND DISCHARGE ON GRADE.

REVISIONS				
REV #	DATE	BY	APPROV	REVISION
04/16/21	JMF			35% SET
11/17/21	JMF			65% SET
2/16/22	JMF			ISSUE FOR PERMIT



DA PROJECT NUMBER & NAME:
 1893
 DRAWING TITLE:
**HVAC PIPING
 PLAN**

DRAWING NO:
M201



E

D

C

B

A

-- INDOOR HEAT PUMP SCHEDULE --

Table with columns: ITEM, SUPPLY CFM, ESP (IN. WG), OA CFM, FAN HP, DRIVE, COOLING CAP. BTUH (SENSIBLE, TOTAL), AUX. HEAT (KW, STGS.), TRANE MODEL NO., REMARKS. Rows include IHP-1 through IHP-22.

- (1) RATINGS IN ACCORDANCE WITH A.R.I. STANDARD 240.
(2) FURNISH AND INSTALL BIPOLEAR IONIZATION UNIT SIZED FOR FULL UNIT AIRFLOW.

-- AIR DISTRIBUTION SCHEDULE --

Table with columns: MARK, TYPE, NECK CONNECTION, FINISH, OBD, PRICE NO., REMARKS. Rows include ceiling diffusers, return/exhaust, and louvers.

- (1) DUCT RUNOUT SIZE SAME AS NECK CONNECTION SIZE, UNLESS NOTED OTHERWISE.
(2) PROVIDE LAY-IN TYPE FOR T-BAR CEILINGS AND SURFACE TYPE FOR ALL OTHER CEILINGS.
(3) PROVIDE WITH REMOVABLE CORE (RC) AND MOLDED, INSULATED BACKPAN WITH FOIL SKRIM VAPOR BARRIER.
(4) BAKED ENAMEL FINISH, CUSTOM COLOR. COLOR AS SELECTED BY ARCHITECT.
(5) CONCEALED OPERATOR AND LINKAGE. SIZE INDICATED DOES NOT INCLUDE OPERATOR COMPARTMENT.

-- GRAVITY HOOD SCHEDULE --

Table with columns: ITEM, LOCATION, CFM, THROAT WIDTH (IN.), ESP (IN. WG), GREENHECK MODEL NO., REMARKS. Rows include GH-1 through GH-5.

-- OUTDOOR HEAT PUMP SCHEDULE --

Table with columns: ITEM, COOLING CAP. BTUH, EER MIN., HEATING CAP. MBH, COP, TRANE MODEL NO. Rows include OHP-1 through OHP-22.

- (1) RATINGS IN ACCORDANCE WITH A.R.I. STANDARD 240.

-- FAN SCHEDULE --

Table with columns: ITEM, LOCATION, CFM, ESP (IN. WG), HP, RPM, MAX. RPM, MAX. SONES, GREENHECK MODEL NO., REMARKS. Rows include F-1 through F-20.

- (1) COMPLETE WITH BACKDRAFT DAMPER, ROOF CURB, BIRDSCREEN, (SPEED CONTROLLER), AND DISCONNECT MEANS.
(2) COMPLETE WITH BACKDRAFT DAMPER, HANGING BRACKETS, METAL CEILING GRILLE, (SPEED CONTROLLER), AND DISCONNECT MEANS.
(3) COMPLETE WITH BACKDRAFT DAMPER, ISOLATION HANGERS, (SPEED CONTROLLER), AND DISCONNECT MEANS.
(4) SWITCH WITH ROOM LIGHTS. FURNISH CONTACTORS AS REQUIRED.
(5) CONTROL WITH WALL SWITCH.
(6) CONTROL WITH THERMOSTAT SET AT 85" (ADJ.).
(7) CONTROL WITH HOOD MOUNTED SWITCH.
(8) SEE SPECIFICATIONS FOR REQUIRED ACCESSORIES.
(9) 30" OSCILLATING WALL MOUNT FAN. 110V PLUG WITH PULL CHAIN.

-- RANGEHOOD SCHEDULE --

Table with columns: ITEM, SUPPLY C.F.M., SUPPLY S.P., SUPPLY HP., EXHAUST C.F.M., EXHAUST S.P., EXHAUST HP., EXHAUST SONES, GREENHECK MODEL NO. Row includes RH-1.

- (1) FURNISH CONTROL PACKAGE FOR SINGLE POINT CONNECTION.

-- REFRIGERATION PIPE SCHEDULE --

Table with columns: ITEM, SUCTION LINE OD, LIQUID LINE OD, REMARKS. Rows include IHP-1/OHP-1 through IHP-22/OHP-22.

- (1) REFRIGERANT PIPE SIZES INDICATED ARE FOR ESTIMATING PURPOSES ONLY. EXACT SIZES AND ACCESSORIES REQUIRED SHALL BE DETERMINED BY EQUIPMENT MANUFACTURER FROM FIELD OBTAINED DIMENSIONS.

-- DEDICATED OUTDOOR AIR UNIT SCHEDULE --

Table with columns: ITEM, C.F.M. TOTAL, EXT. S.P. INCHES W.C., NET COOLING CAP. SENS/TOT MBH, SUMMER DESIGN (ENTERING DB/WB, LEAVING DB/WB), REHEAT COIL CAP. MBH, ELEC HEAT KW/STAGES, WINTER DESIGN (ENTERING DB, LEAVING DB), MITSUBISHI MODEL NO., REMARKS. Rows include DOAS-1 through DOAS-3.

- (1) UNIT WITH SMART ME STAND-ALONE CONTROLLER WITH TIME-OF-DAY SCHEDULING AND DISCHARGE TEMPERATURE CONTROL.

-- CONDENSING UNIT SCHEDULE --

Table with columns: ITEM, SERVES, CAPACITY M.B.H., S.E.E.R., MANUF. MODEL NO. Rows include CU-DOAS-1 through CU-DOAS-3.

-- BRANCH CONTROLLER SCHEDULE --

Table with columns: ITEM, # OF PORT SETS, SERVED FROM, MITSUBISHI MODEL NO. Rows include BC-DOAS-1 through BC-DOAS-3.

- (1) REFRIGERANT PIPE SIZES AND ACCESSORIES REQUIRED SHALL BE DETERMINED BY EQUIPMENT MANUFACTURER FROM FIELD OBTAINED DIMENSIONS.

-- ELECTRIC HEATER SCHEDULE --

Table with columns: ITEM, LOCATION, WATTS, Q-MARK MODEL NO., REMARKS. Row includes WH-1.

- (1) COMPLETE WITH RECESSED TRIM KIT AND UNIT MOUNTED THERMOSTAT.

HVAC LEGEND

Table with columns: SYMBOL, DESCRIPTION. Lists symbols for refrigerant suction, condensate drain, thermostat, damper, diffuser, grille, manual volume damper, lined duct, square ell, fabric duct, air device neck connection, and diameter.

HVAC NOTES:

NOT ALL EXISTING WORK IS SHOWN, AND THAT SHOWN IS IN ITS APPROXIMATE LOCATION AND ARRANGEMENT. EXACT LOCATION, ARRANGEMENT, AND SIZES SHALL BE VERIFIED ON THE JOB BEFORE STARTING ANY NEW WORK.
INSTALL PIPING AND DUCTWORK IN EQUIPMENT ROOMS ADJACENT TO WALLS AND CEILINGS WHERE POSSIBLE TO PROVIDE MAXIMUM ROOM CLEARANCE.
COORDINATE THE INSTALLATION OF WORK UNDER THIS DIVISION WITH THAT OF OTHER TRADES TO PROVIDE THE BEST ARRANGEMENT OF PIPING, DUCTWORK, AND EQUIPMENT.
PIPING, DUCTWORK, AND EQUIPMENT IS SHOWN IN ITS GENERAL LOCATION UNLESS DIMENSIONED.
ARRANGE PIPING AND DUCTWORK TO CLEAR STRUCTURAL MEMBERS, PIPING AND LIGHT FIXTURES.
EXACT LOCATION OF GRILLES AND CEILING OUTLETS SHALL BE DETERMINED ON THE JOBSITE. COORDINATE WITH LIGHTS, SPRINKLER HEADS, AND OTHER CEILING APPURTENANCES TO PROVIDE A UNIFORM AND SYMMETRICAL APPEARANCE. REFER TO ARCHITECTURAL AND ELECTRICAL DRAWINGS AND DETAILS.
ALL PIPING SHALL BE CONCEALED, UNLESS NOTED OTHERWISE.
PROVIDE FLEXIBLE DUCT CONNECTIONS TO ALL AIR HANDLING EQUIPMENT.
PROVIDE UNION OR FLANGE CONNECTIONS IN PIPING AT ALL HYDRONIC EQUIPMENT AND CONTROL VALVES, AND AS REQUIRED FOR SERVICE.
SLOPE DRAIN LINES TOWARD DRAIN WITH A MINIMUM SLOPE OF 1/4" PER FOOT.



771 Broad Street Suite 200
Augusta, Georgia 30901
(706) 722-7488
mail@dickinsonarchitects.com
www.dickinsonarchitects.com

PROJECT TITLE:
JUD C
HICKEY
CENTER

Table with columns: REV #, DATE, BY, REVISION. Shows revision history for 04/16/21, 11/17/21, and 2/16/22.



DA PROJECT NUMBER & NAME:
1893
DRAWING TITLE:
HVAC
SCHEDULES

DRAWING NO:
M401

PFA ENGINEERING logo and contact information: 1501 BROAD STREET, SUITE 200, AUGUSTA, GEORGIA 30901. 706-722-3969 • FAX: 706-726-927 • www.pfaengineering.com. Includes a graphic scale from 1/4" to 1" and a date stamp: PLOT DATE: 4/18/21, FILE NAME: 2101MECH, PLOT SCALE: 1"=1'-0" WGC.

LEGEND




Table with columns for symbols and descriptions for lighting and power fixtures, including conduit runs, troffer fixtures, emergency lighting, and various sensors.

GENERAL NOTES:

- List of 38 general notes regarding scale drawings, mounting heights, electrical drawings, conduit routing, and specific equipment requirements.

LIGHTING FIXTURE SCHEDULE

Table with columns for Type, Description, Watts, Lumens, Color Temp, Manufacturers, and Notes. Lists various lighting fixtures like recessed ceiling, surface wall, and emergency lighting.

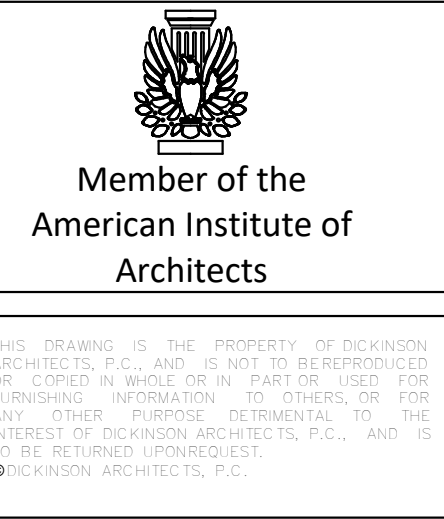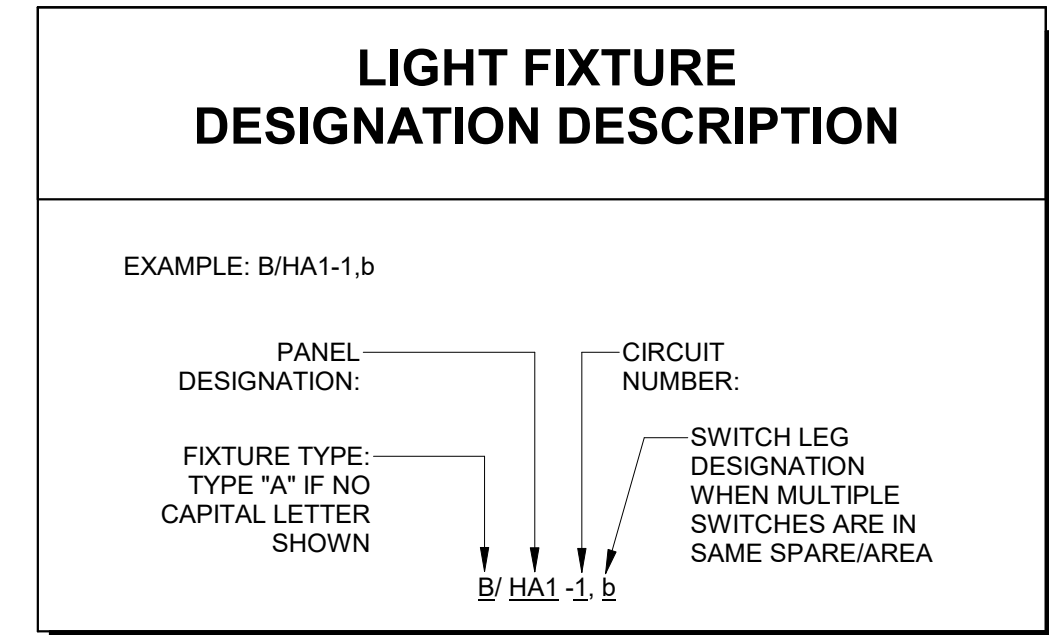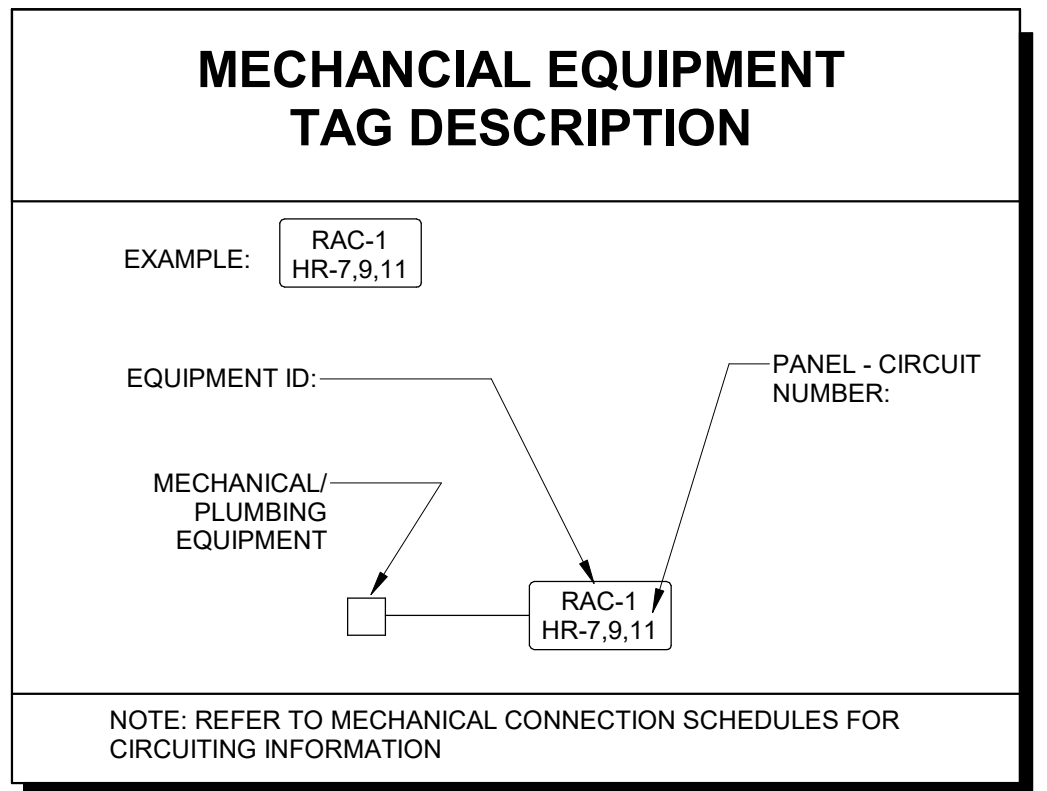

PROJECT TITLE: JUD C HICKEY CENTER

Table with columns for REV #, DATE, BY, and REVISION. Shows revision history for the project.



DA PROJECT NUMBER & NAME: 1893
DRAWING TITLE: LEGEND, NOTES, DETAILS, AND FIXTURE SCHEDULE
DRAWING NO: E100

EDC logo and contact information for Electrical Design Consultants, Inc. including address and phone numbers.


REVISIONS			
REV #	DATE	APRVD BY	REVISION
4/16/21	MAP		35% SET
11/17/21	MAP		65% SET
2/16/22	MAP		ISSUE FOR PERMIT



DA PROJECT NUMBER & NAME:
1893
DRAWING TITLE:
ELECTRICAL SITE PLAN



DRAWING NO:
E101

EDC ELECTRICAL ENGINEERS
1201 BROAD ST., SUITE 1-A
AUGUSTA, GA 30901
PH: (706) 724-3551
FAX: (706) 724-8507
CONSULTANTS, INC. EDC PROJECT #: 21047

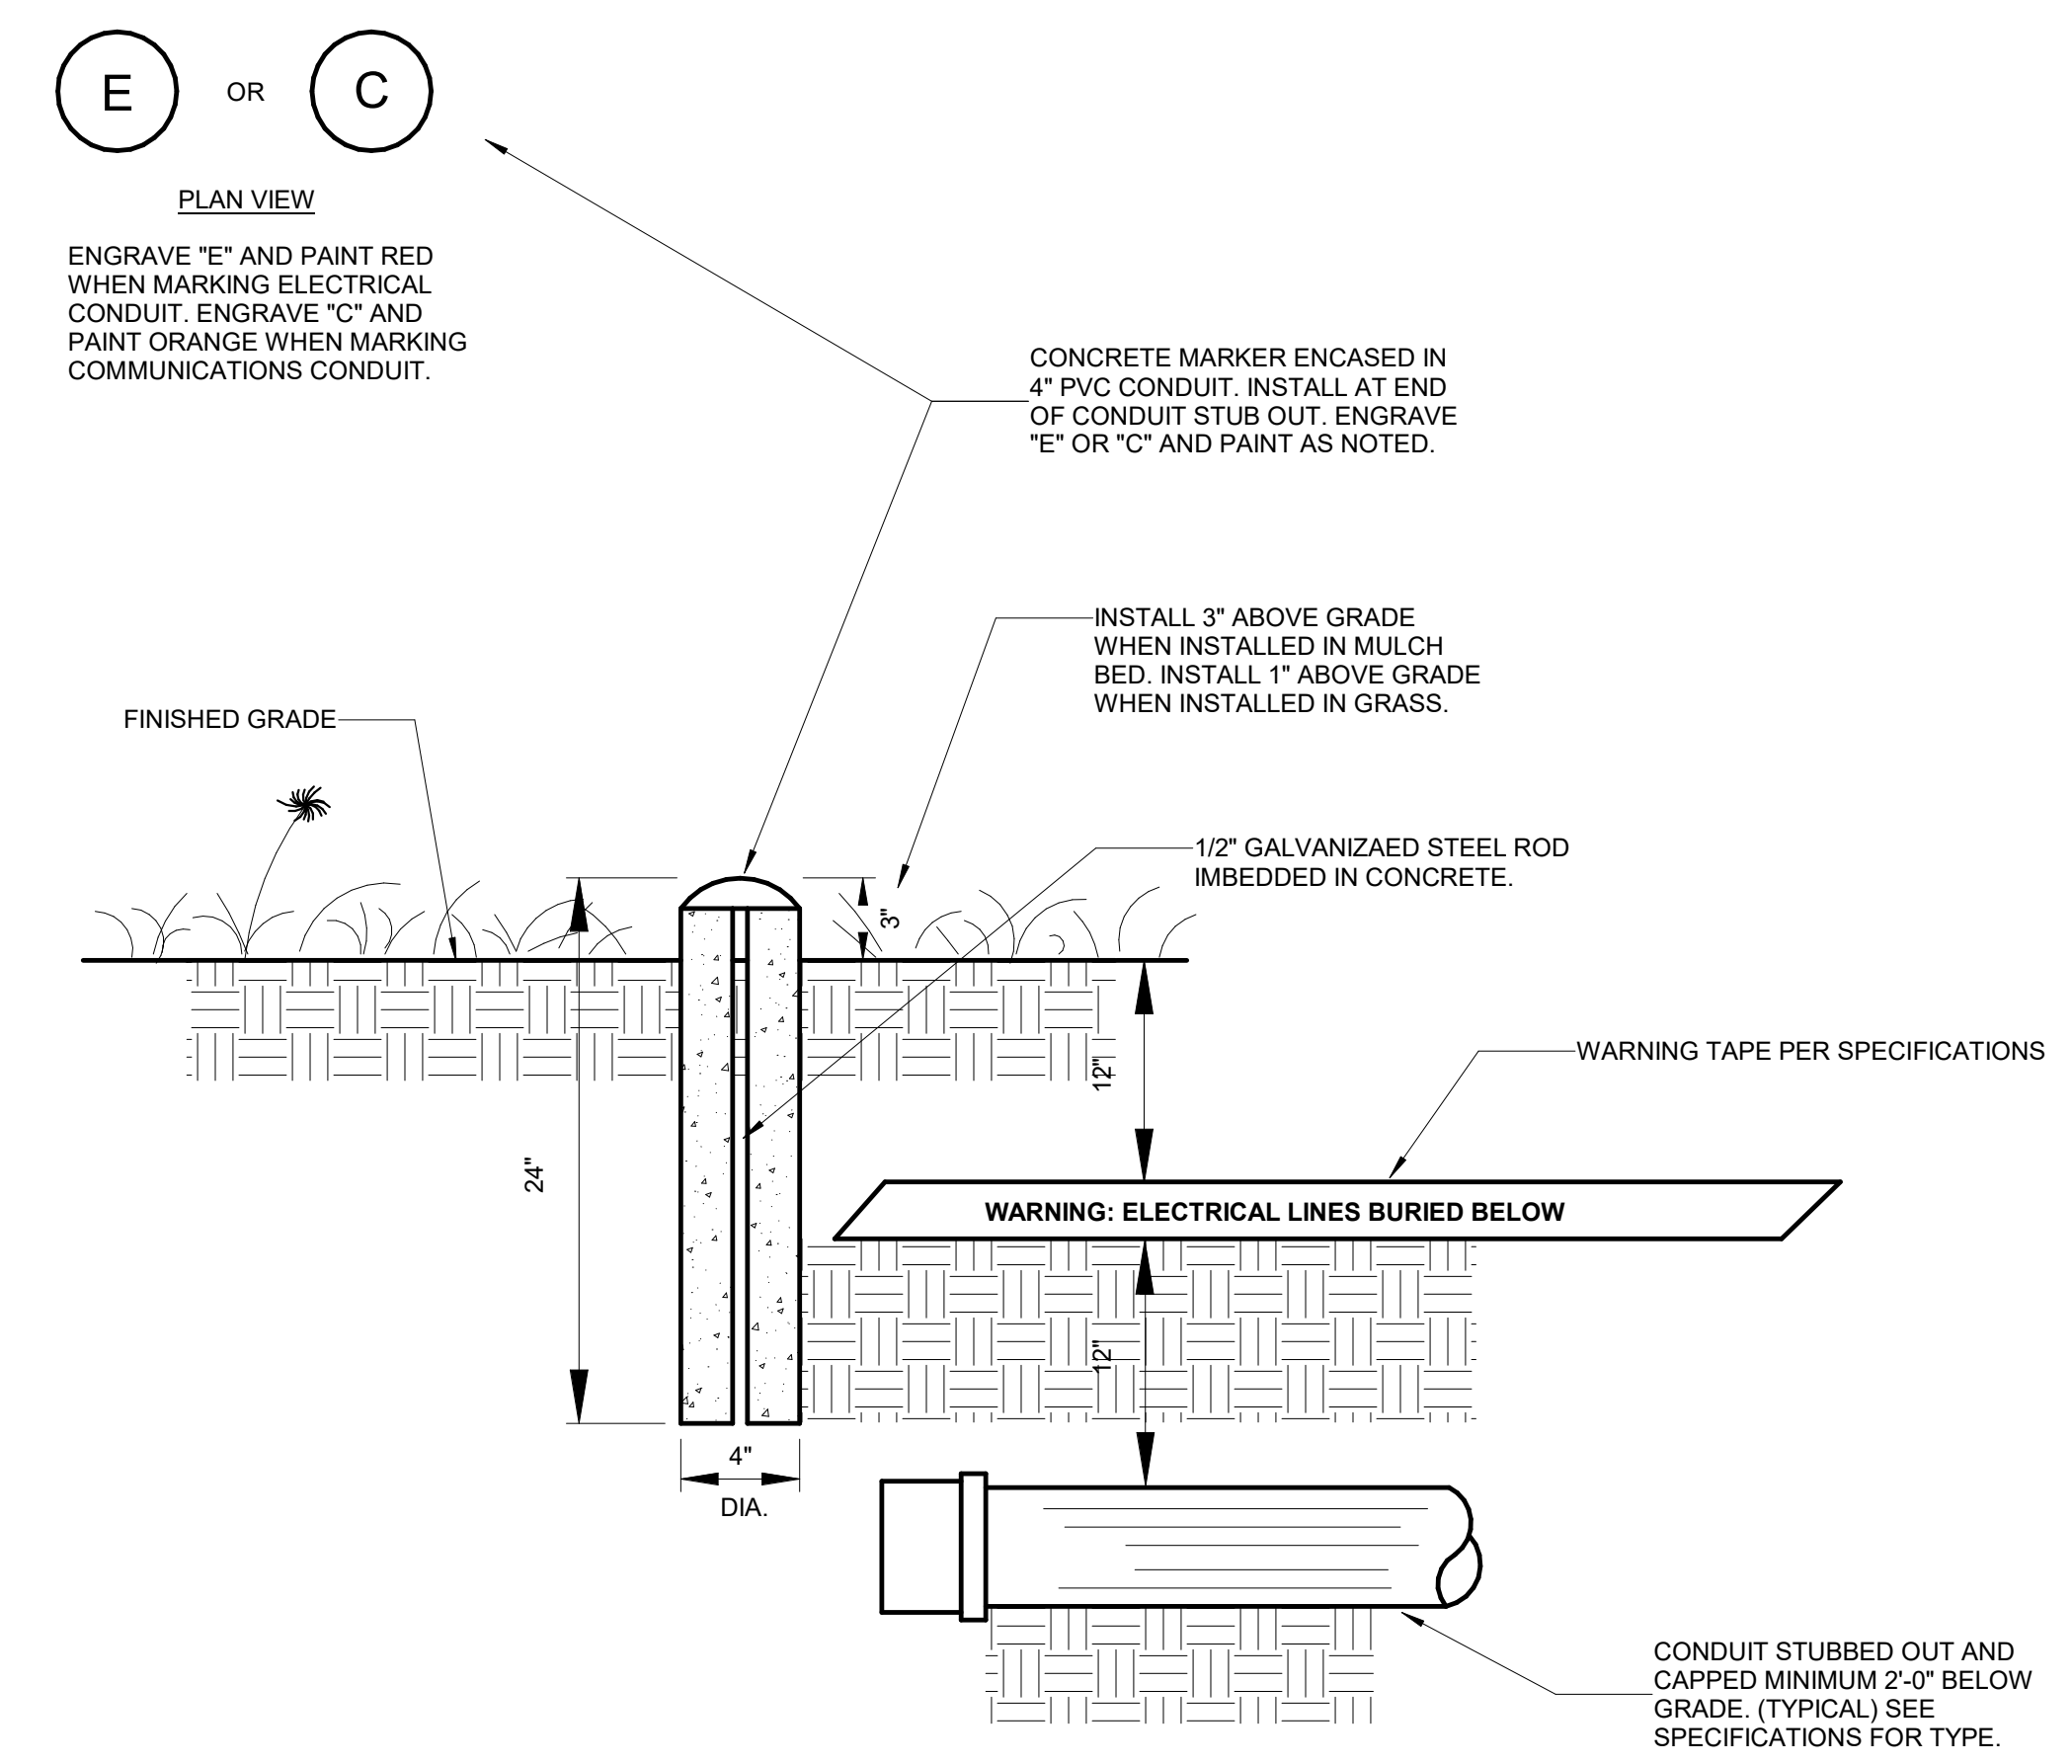

KEYED NOTES:

- COORDINATE UTILITY STUB OUTLOCATION FOR FIBER/TELCO WITH LOCAL UTILITY PRIOR TO ROUGH-IN.
- STUB UP CONDUIT FOR CCTV CAMERAS AND PROVIDE CONCRETE MARKER ACCORDING TO DETAIL 3E101. COORDINATE EXACT LOCATION OF POLES WITH GEORGIA POWER PRIOR TO ROUGH-IN.
- CONNECT GROUND MOUNTED FLOOD LIGHTS TO EXTERIOR LIGHTING CIRCUIT.

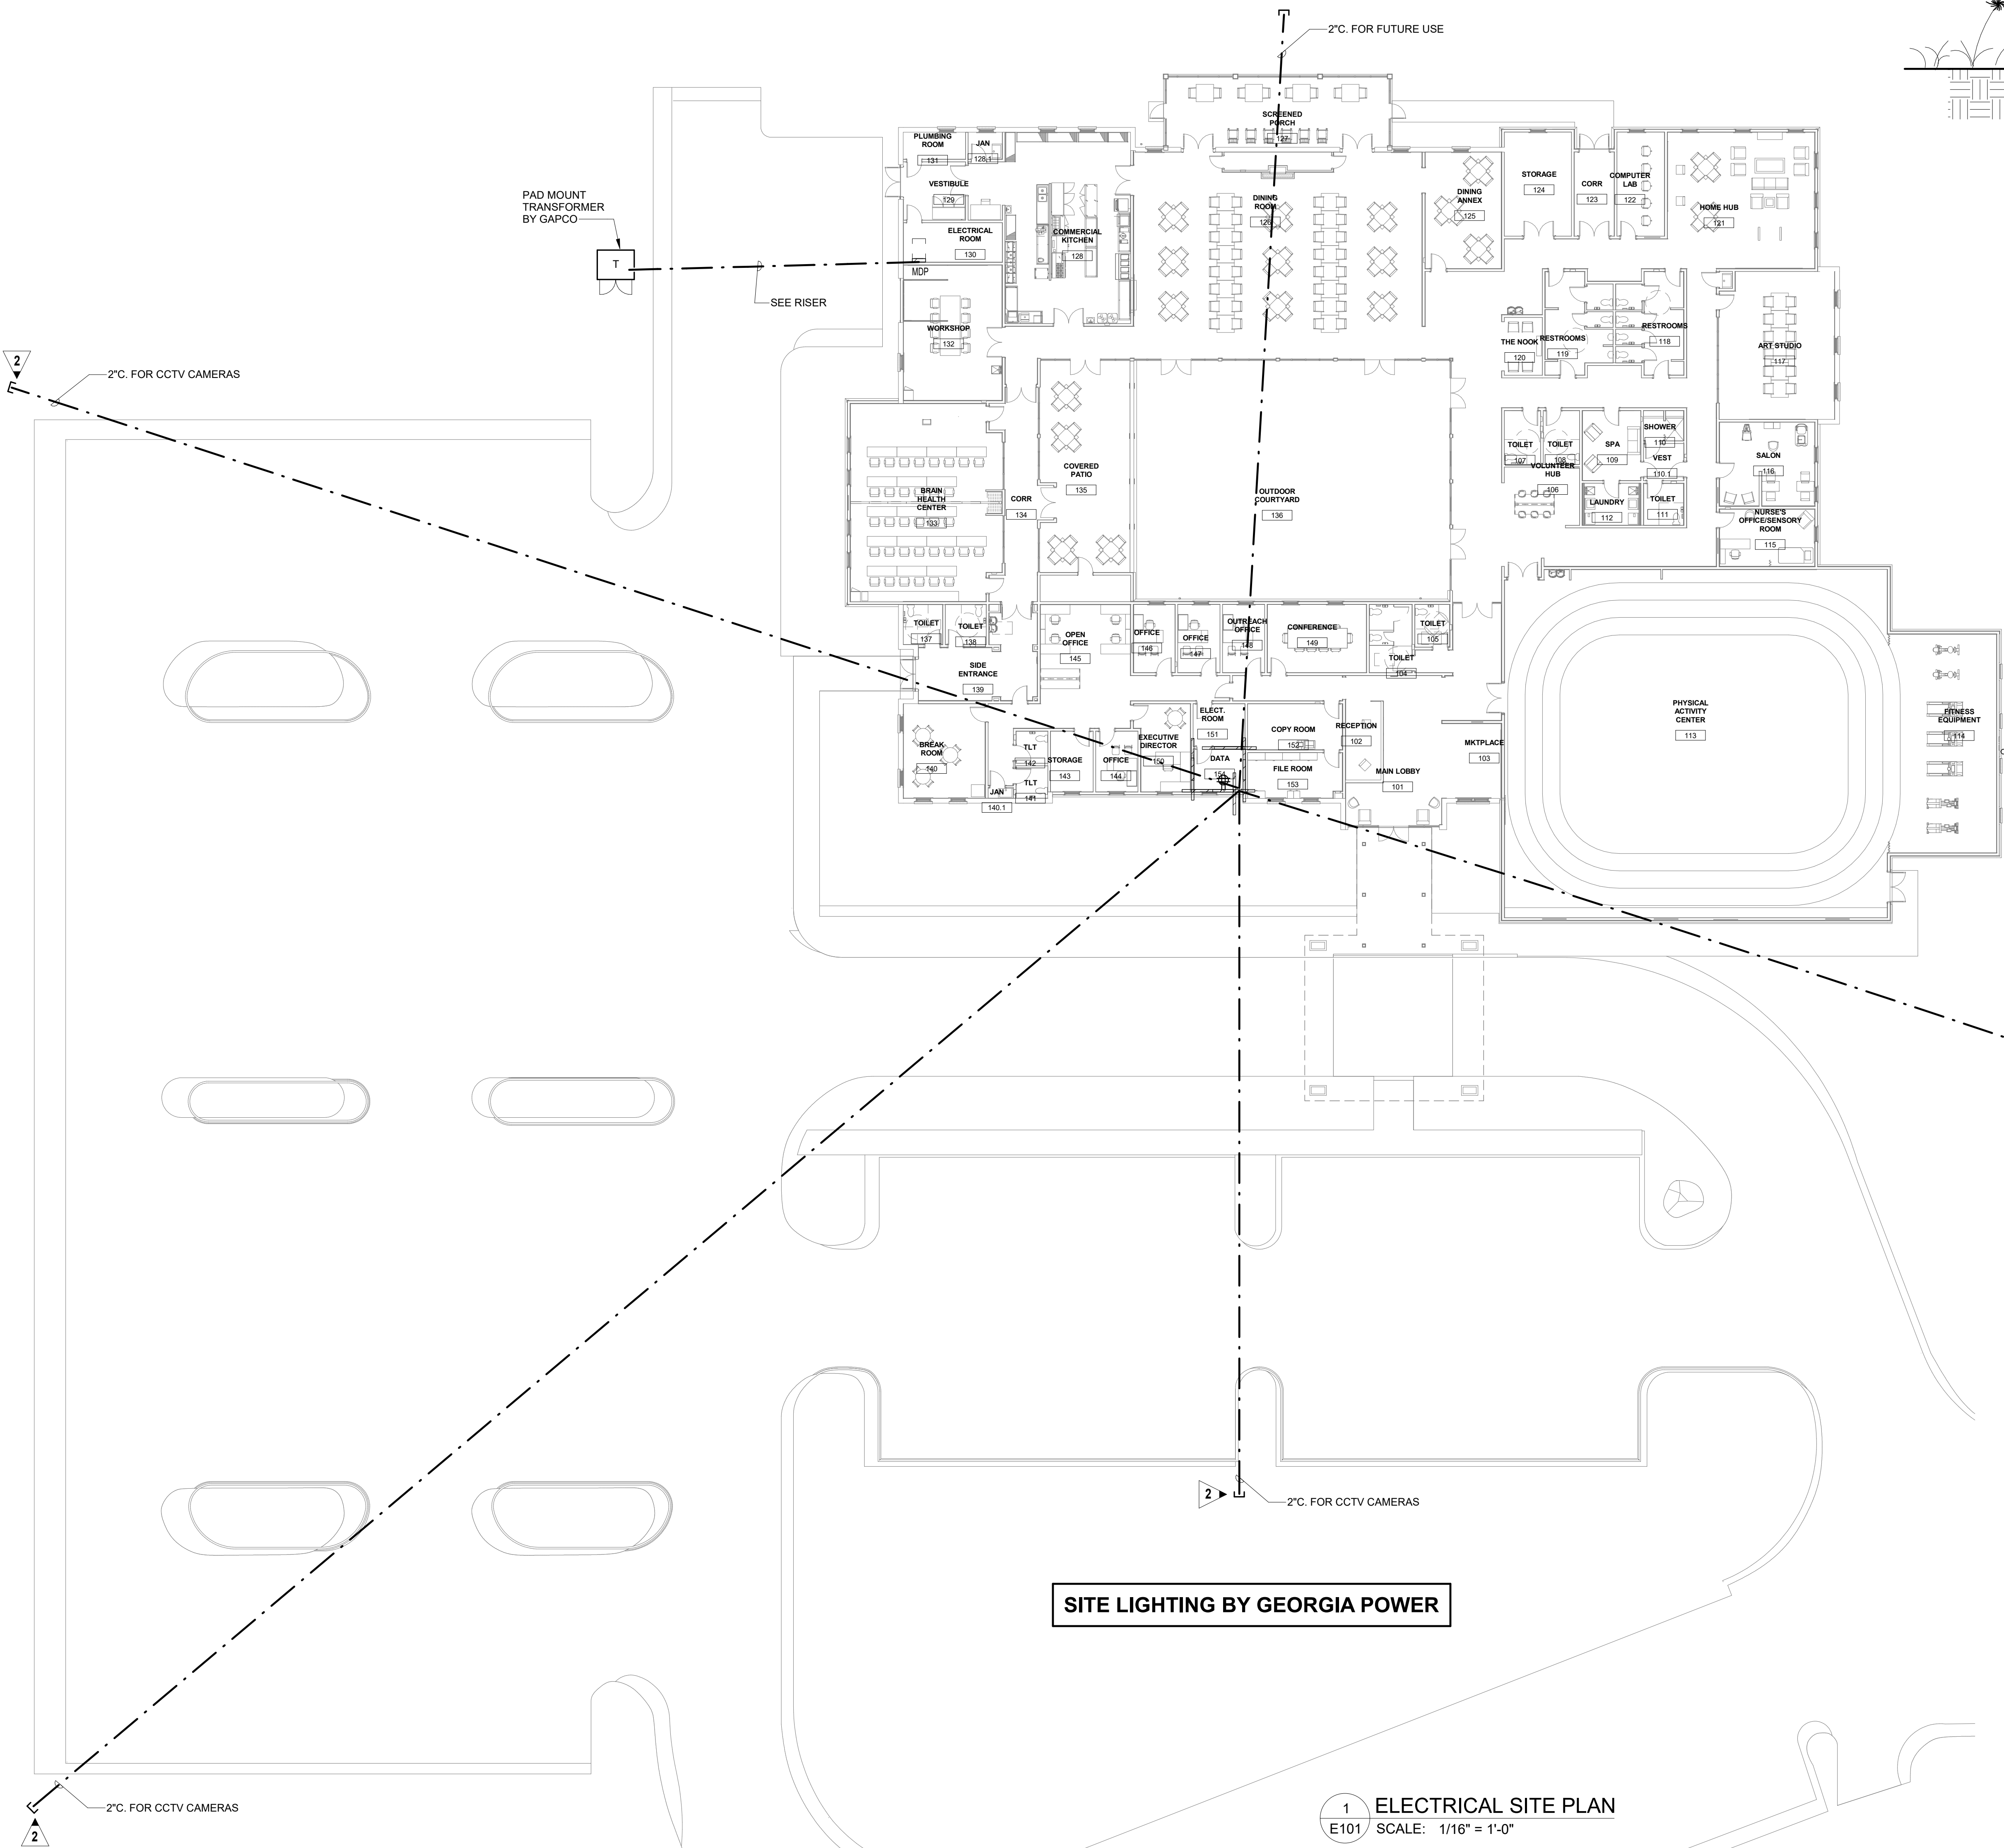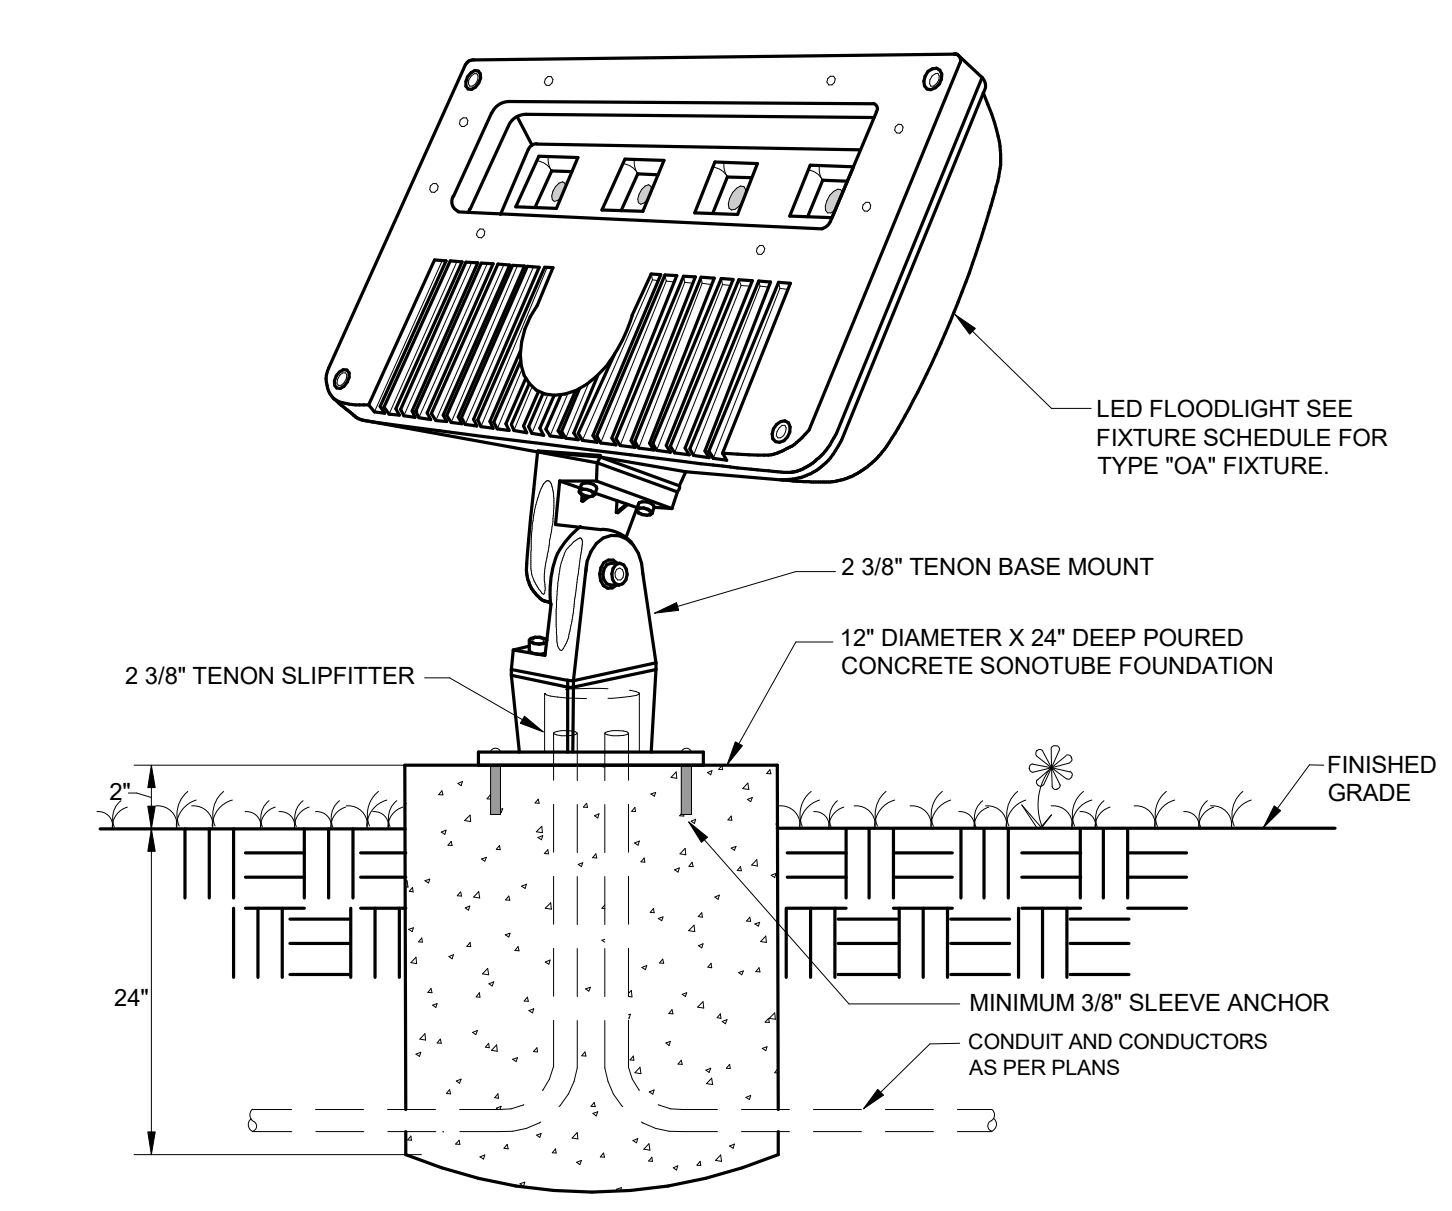

SITE LIGHTING BY GEORGIA POWER

PLAN VIEW
ENGRAVE "E" AND PAINT RED WHEN MARKING ELECTRICAL CONDUIT. ENGRAVE "C" AND PAINT ORANGE WHEN MARKING COMMUNICATIONS CONDUIT.

CONCRETE MARKER ENCASED IN 4" PVC CONDUIT. INSTALL AT END OF CONDUIT STUB OUT. ENGRAVE "E" OR "C" AND PAINT AS NOTED.

INSTALL 3" ABOVE GRADE WHEN INSTALLED IN MULCH BED. INSTALL 1" ABOVE GRADE WHEN INSTALLED IN GRASS.

1/2" GALVANIZED STEEL ROD IMBEDDED IN CONCRETE.

WARNING: ELECTRICAL LINES BURIED BELOW

CONDUIT STUBBED OUT AND CAPPED MINIMUM 2'-0" BELOW GRADE. (TYPICAL) SEE SPECIFICATIONS FOR TYPE.

KEYED NOTES:

- COORDINATE UTILITY STUB OUTLOCATION FOR FIBER/TELCO WITH LOCAL UTILITY PRIOR TO ROUGH-IN.
- STUB UP CONDUIT FOR CCTV CAMERAS AND PROVIDE CONCRETE MARKER ACCORDING TO DETAIL 3E101. COORDINATE EXACT LOCATION OF POLES WITH GEORGIA POWER PRIOR TO ROUGH-IN.
- CONNECT GROUND MOUNTED FLOOD LIGHTS TO EXTERIOR LIGHTING CIRCUIT.

2 DETAIL - STANCHION MOUNTED FLOODLIGHT
E101 SCALE: NONE

1 ELECTRICAL SITE PLAN
E101 SCALE: 1/16" = 1'-0"

3 DETAIL - CONCRETE MARKER DETAIL
E101 NO SCALE


E

D

C

B

A

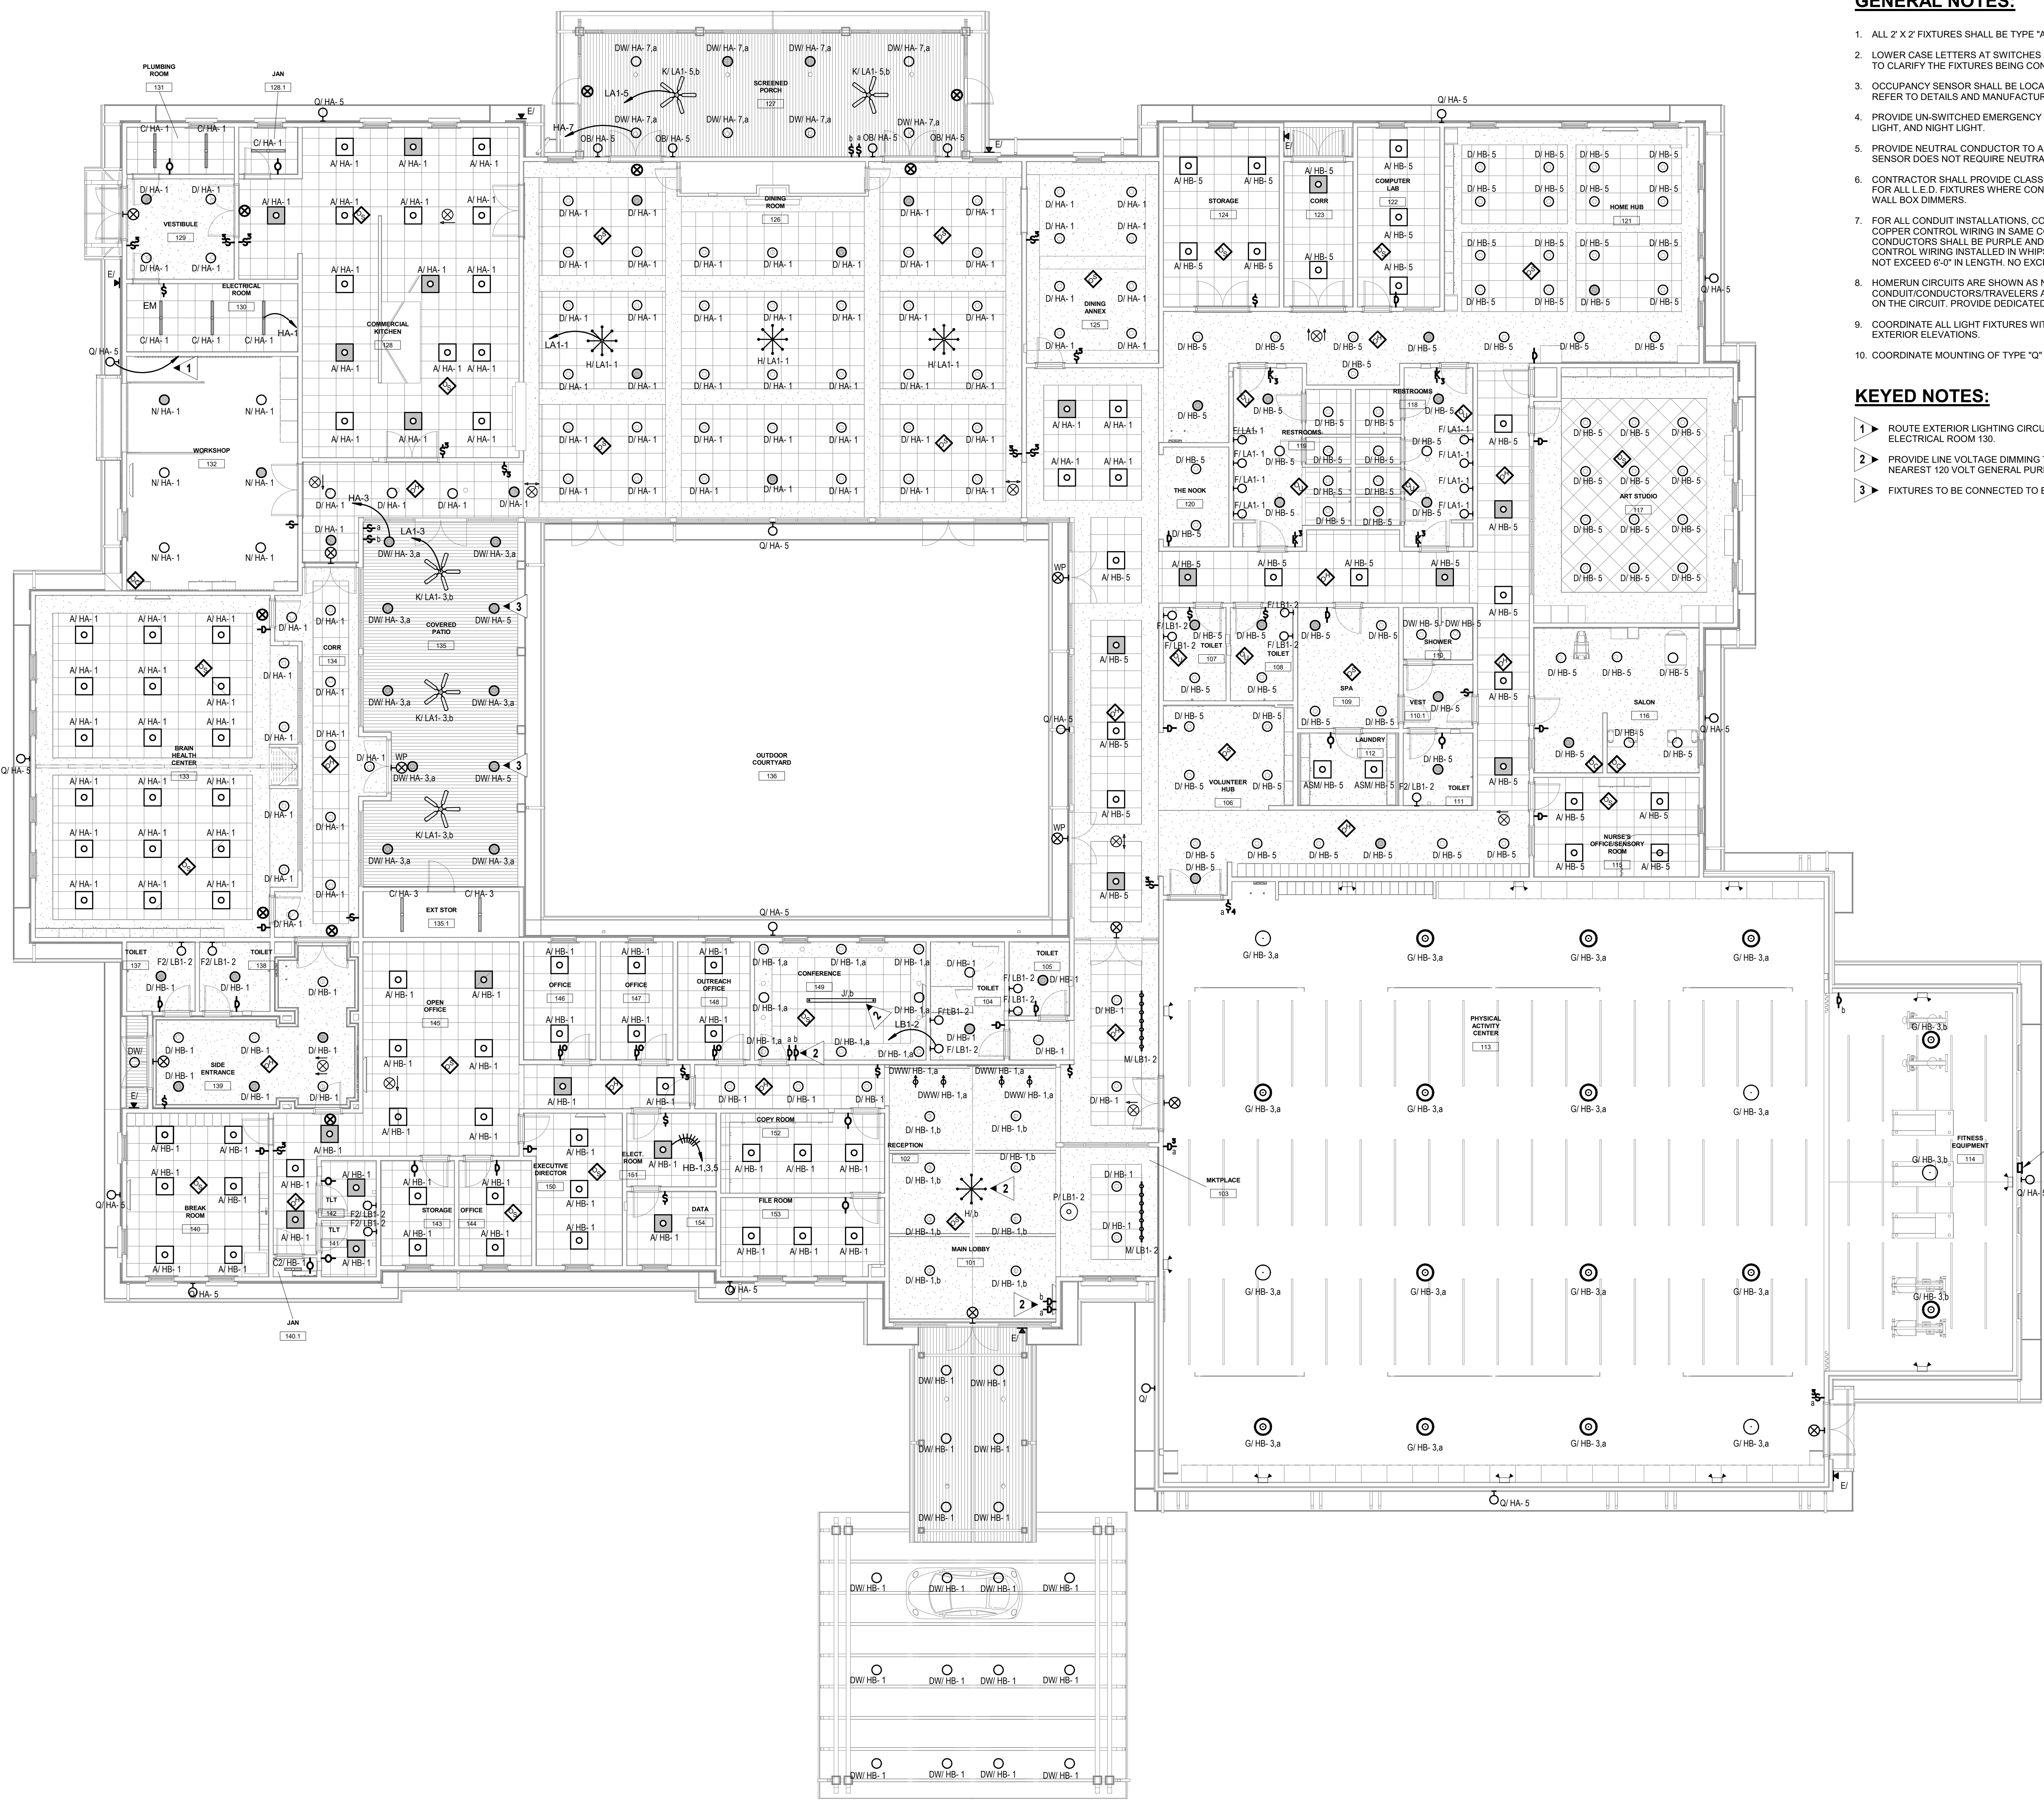

GENERAL NOTES:

- ALL 2" X 2" FIXTURES SHALL BE TYPE "A" UNLESS OTHERWISE NOTED.
- LOWER CASE LETTERS AT SWITCHES AND LIGHT FIXTURES ON THIS SHEET ARE SHOWN TO CLARIFY THE FIXTURES BEING CONTROLLED BY THE ASSOCIATED SWITCHES.
- OCCUPANCY SENSOR SHALL BE LOCATED TO PROVIDE MAXIMUM COVERAGE FOR ROOM. REFER TO DETAILS AND MANUFACTURER LAYOUT FOR CONNECTIONS.
- PROVIDE UN-SWITCHED EMERGENCY "HOT" CONDUCTOR TO EACH EXIT SIGN, TYPE E LIGHT, AND NIGHT LIGHT.
- PROVIDE NEUTRAL CONDUCTOR TO ALL WALL MOUNTED OCCUPANCY SENSORS. IF SENSOR DOES NOT REQUIRE NEUTRAL, CAP NEUTRAL IN BOX.
- CONTRACTOR SHALL PROVIDE CLASS 2, 600 VOLT RATED, 0-10 VOLT CONTROL WIRING FOR ALL L.E.D. FIXTURES WHERE CONTROLLED BY LOW-VOLTAGE CONTROLLERS OR WALL BOX DIMMERS.
- FOR ALL CONDUIT INSTALLATIONS, CONTRACTOR SHALL PULL #18 AWG TPN SOLID COPPER CONTROL WIRING IN SAME CONDUIT AS LINE-VOLTAGE CONDUCTORS. CONDUITS SHALL BE PURPLE AND GRAY. FIXTURE WHIPS SHALL BE PROVIDED WITH CONTROL WIRING INSTALLED IN WHIPS TO MATCH INSTALLATION. FIXTURE WHIPS SHALL NOT EXCEED 6'-0" IN LENGTH. NO EXCEPTIONS.
- HOMERUN CIRCUITS ARE SHOWN AS NOTED. PROVIDE ALL BRANCH CIRCUIT CONDUIT/CONDUCTORS/TRAVELERS AS NECESSARY TO CONNECT ALL DEVICES SHOWN ON THE CIRCUIT. PROVIDE DEDICATED NEUTRALS FOR ALL CIRCUITS.
- COORDINATE ALL LIGHT FIXTURES WITH ARCHITECTURAL REFLECTED CEILING PLAN AND EXTERIOR ELEVATIONS.
- COORDINATE MOUNTING OF TYPE "Q" EXTERIOR FIXTURES TO AVOID DOWNSPOUTS.

KEYED NOTES:

- ROUTE EXTERIOR LIGHTING CIRCUIT THROUGH LOW VOLTAGE RELAY PANEL IN ELECTRICAL ROOM 130.
- PROVIDE LINE VOLTAGE DIMMING TO LIGHT FIXTURE. CONNECT FIXTURE TO NEAREST 120 VOLT GENERAL PURPOSE RECEPTACLE CIRCUIT.
- FIXTURES TO BE CONNECTED TO EXTERIOR LIGHTING CIRCUIT.

RECESSED JUNCTION BOX TO SERVE BUILDING MOUNTED SIGNAGE. COORDINATE EXACT LOCATION AND MOUNTING HEIGHT WITH OWNER/ARCHITECT PRIOR TO ROUGH IN.

1 LIGHTING PLAN
E201 SCALE: 1/8" = 1'-0"



PROJECT TITLE:
JUD C HICKEY CENTER


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REV #	DATE	APPROV	BY	REVISION
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11/17/21	MAP			65% SET
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DA PROJECT NUMBER & NAME:
1893
DRAWING TITLE:
LIGHTING PLAN

DRAWING NO:
E201

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1201 BROAD ST., SUITE 1-A
AUGUSTA, GA 30901
PH: (706) 724-3551
FAX: (706) 724-8507
EDC PROJECT #: 21047



GENERAL NOTES:

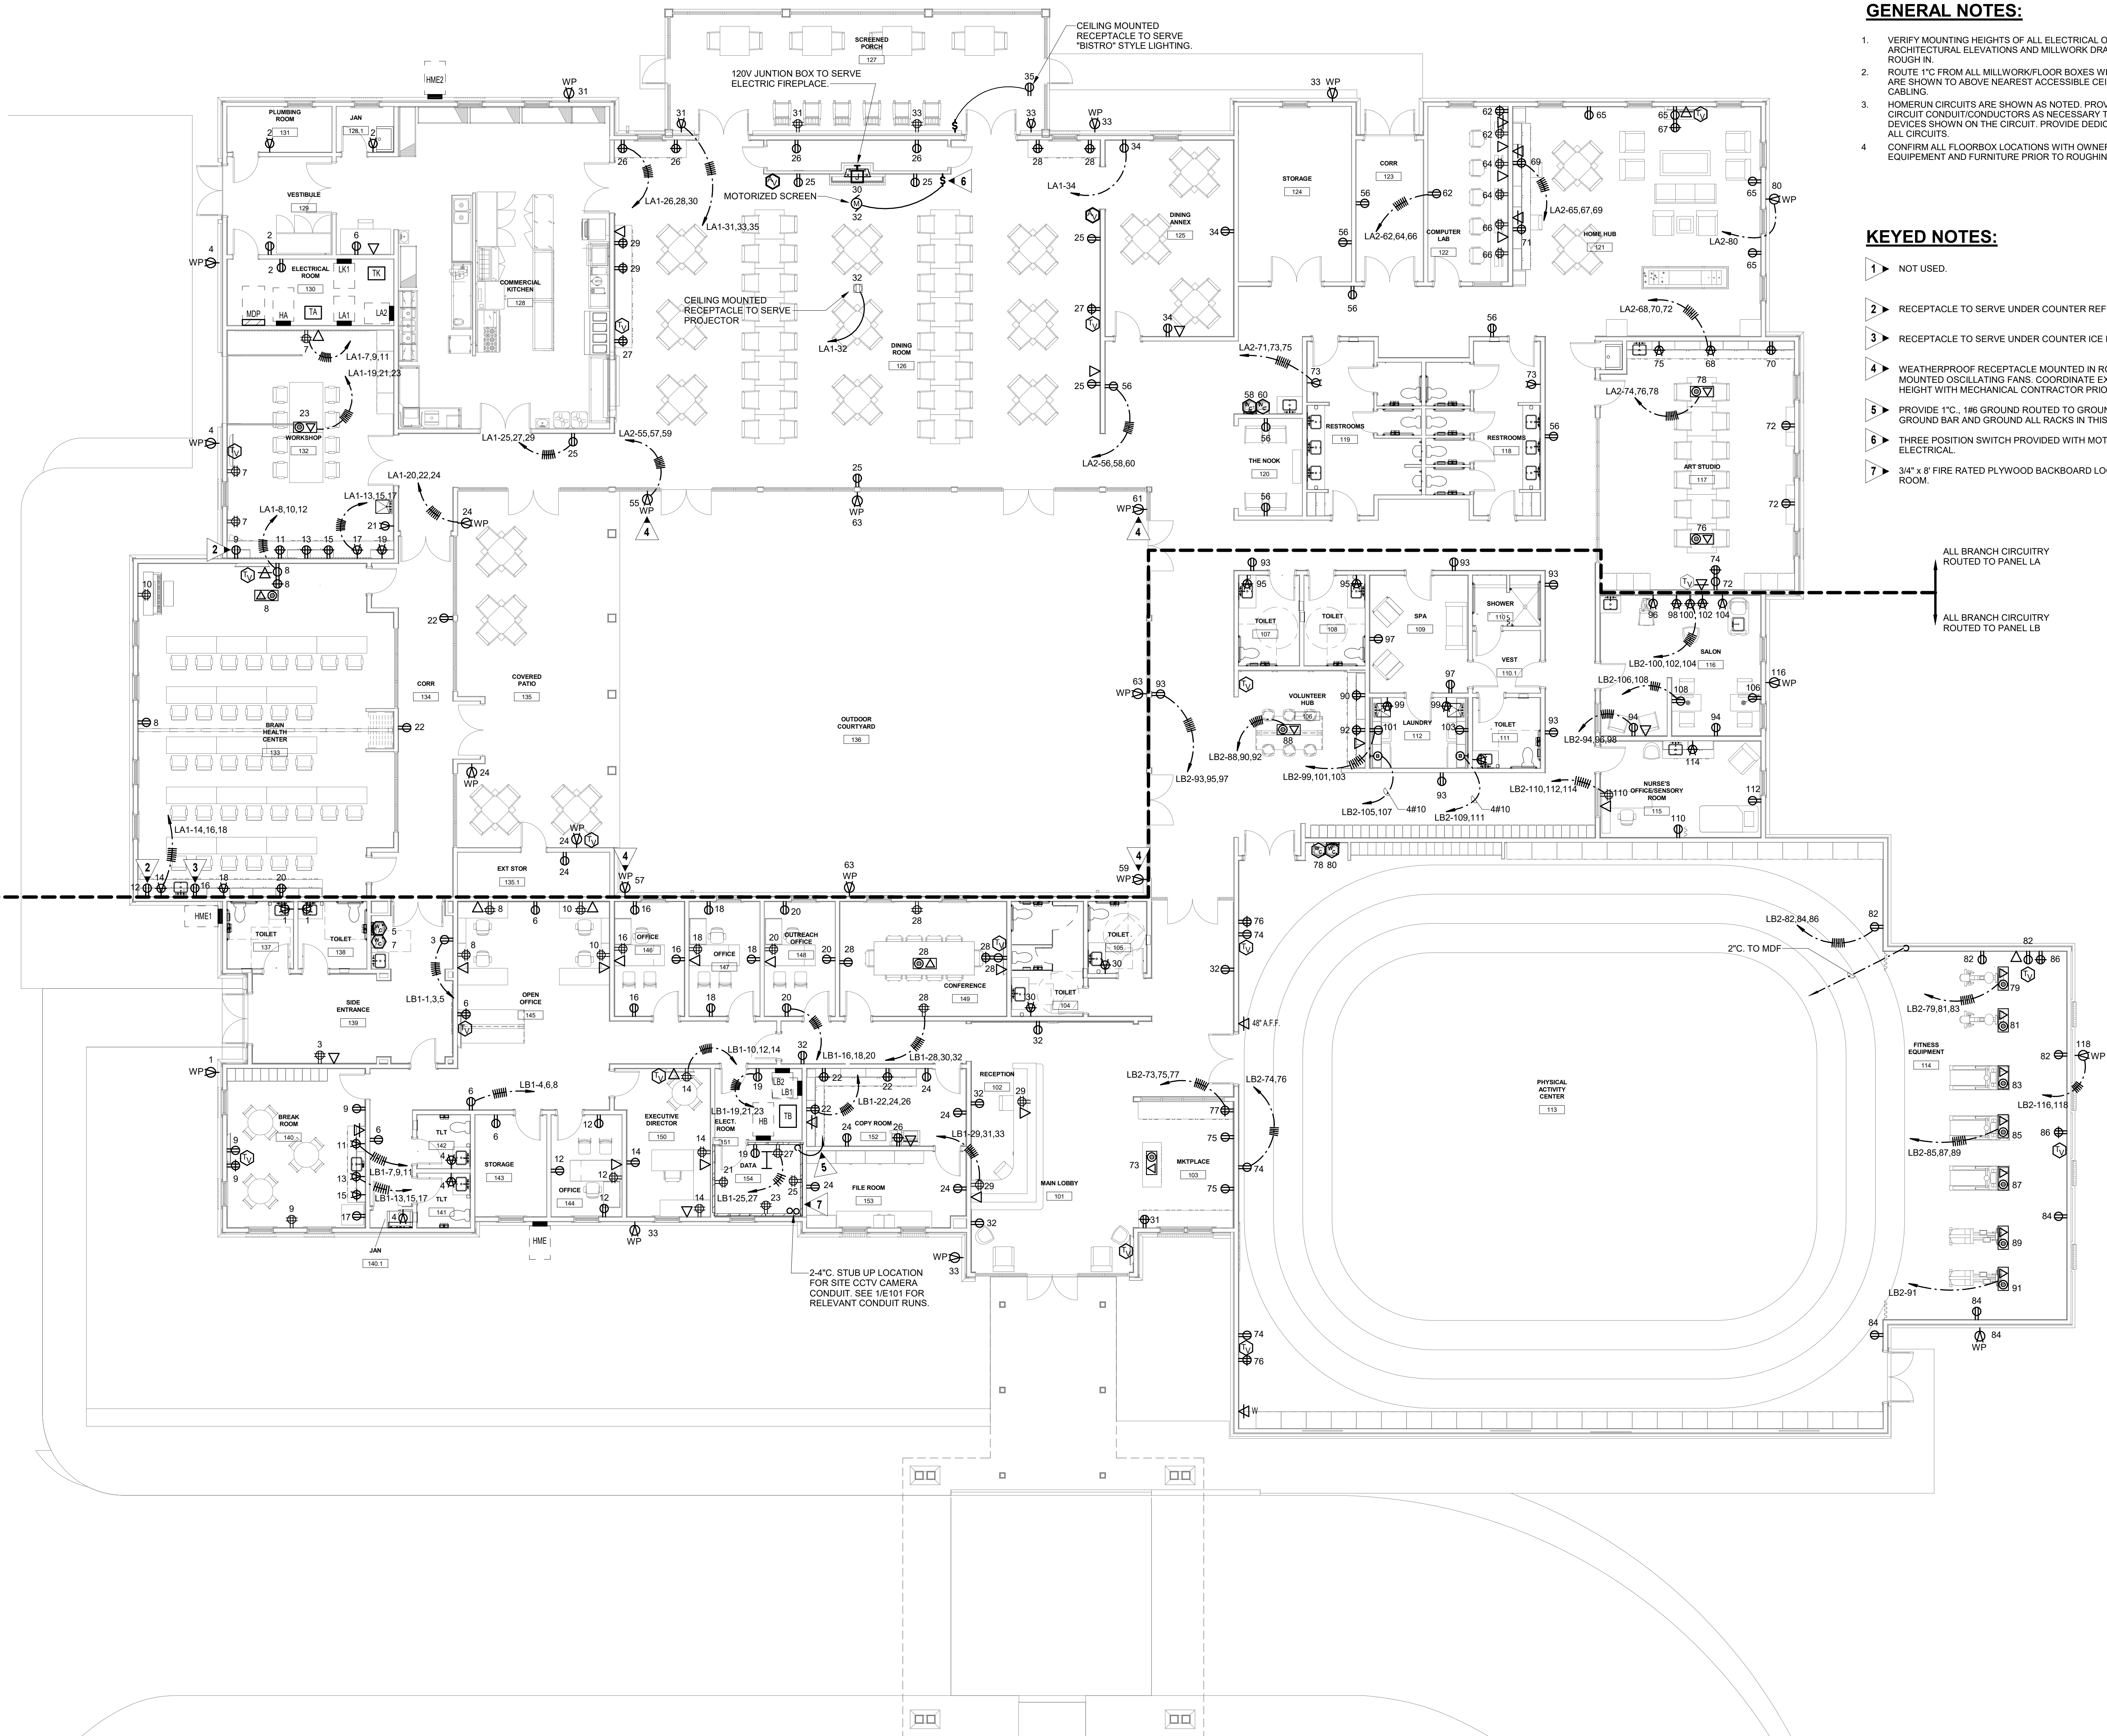1. VERIFY MOUNTING HEIGHTS OF ALL ELECTRICAL OUTLETS WITH ARCHITECTURAL ELEVATIONS AND MILLWORK DRAWINGS PRIOR TO ROUGH IN.
2. ROUTE 1°C FROM ALL MILLWORK/FLOOR BOXES WHERE DATA DROPS ARE SHOWN TO ABOVE NEAREST ACCESSIBLE CEILING TO SERVE DATA CABLING.
3. HOMERUN CIRCUITS ARE SHOWN AS NOTED. PROVIDE ALL BRANCH CIRCUIT CONDUIT/CONDUCTORS AS NECESSARY TO CONNECT ALL DEVICES SHOWN ON THE CIRCUIT. PROVIDE DEDICATED NEUTRALS FOR ALL CIRCUITS.
4. CONFIRM ALL FLOORBOX LOCATIONS WITH OWNER PROVIDED EQUIPMENT AND FURNITURE PRIOR TO ROUGHING IN.

KEYED NOTES:

- 1 NOT USED.
- 2 RECEPTACLE TO SERVE UNDER COUNTER REFRIGERATOR.
- 3 RECEPTACLE TO SERVE UNDER COUNTER ICE MAKER.
- 4 WEATHERPROOF RECEPTACLE MOUNTED IN ROOF SOFFIT TO SERVE WALL-MOUNTED OSCILLATING FANS. COORDINATE EXACT LOCATION AND MOUNTING HEIGHT WITH MECHANICAL CONTRACTOR PRIOR TO ROUGHING IN.
- 5 PROVIDE 1°C, 1#6 GROUND ROUTED TO GROUND BAR IN PANEL LB1. PROVIDE GROUND BAR AND GROUND ALL RACKS IN THIS SPACE.
- 6 THREE POSITION SWITCH PROVIDED WITH MOTORIZED SCREEN, INSTALLED BY ELECTRICAL.
- 7 3/4" x 8' FIRE RATED PLYWOOD BACKBOARD LOCATED ALONG PERIMETER OF ROOM.

ALL BRANCH CIRCUITRY
ROUTED TO PANEL LA

ALL BRANCH CIRCUITRY
ROUTED TO PANEL LB

2-4°C STUB UP LOCATION
FOR SITE CCTV CAMERA
CONDUIT. SEE 1/E101 FOR
RELEVANT CONDUIT RUNS.

1 POWER PLAN
E301 SCALE: 1/8" = 1'-0"

dickinson
ARCHITECTS
Architecture/Interior Design/Planning
771 Broad Street Suite 200
Augusta, Georgia 30901
(706) 722-7488
mail@dickinsonarchitects.com
www.dickinsonarchitects.com

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DA PROJECT NUMBER & NAME:
1893
DRAWING TITLE:
POWER PLAN

DRAWING NO:
E301

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ELECTRICAL ENGINEERS
1201 BROAD ST., SUITE 1-A
AUGUSTA, GA 30901
PH: (706) 724-3551
FAX: (706) 724-8507
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DA PROJECT NUMBER & NAME:
1893
DRAWING TITLE:
**ENLARGED
POWER PLAN -
KITCHEN**

DRAWING NO:
E302


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ELECTRICAL ENGINEERS
1201 BROAD ST., SUITE 1-A
AUGUSTA, GA 30901
PH: (706) 724-3551
FAX: (706) 724-8507
EDC PROJECT #: 21047

GENERAL NOTES:

- REFER TO ELECTRICAL CONNECTION SCHEDULES PER THIS SHEET FOR CIRCUIT DESIGNATIONS, WIRE AND CONDUIT SIZE, DISCONNECT MEANS, AND OTHER ELECTRICAL REQUIREMENTS FOR KITCHEN EQUIPMENT.
- HOMERUN CIRCUITS FOR ALL OTHER CIRCUITS ARE SHOWN AS NOTED. PROVIDE ALL BRANCH CIRCUIT CONDUIT/CONDUCTORS AS NECESSARY TO CONNECT ALL DEVICES SHOWN ON THE CIRCUIT. PROVIDE DEDICATED NEUTRALS FOR ALL CIRCUITS.
- DIMENSIONS INDICATED ARE TO BE VERIFIED AND ADJUSTED AS REQUIRED BY THE EQUIPMENT OR FIELD CONDITIONS. DIMENSIONS SHOWN DO NOT ALLOW FOR OBSTRUCTIONS ON WALLS AT FIXTURE HEIGHTS. ALL DIMENSIONS ARE FROM FINISHED WALL AND FLOOR LINES AND ARE AS ACCURATE AS CAN BE DETERMINED AT THIS TIME. NO RESPONSIBILITY IS ACCEPTED OR IMPLIED FOR ANY DISCREPANCIES BETWEEN DIMENSIONS SHOWN AND ACTUAL FINISHED DIMENSIONS, NOR FOR ANY VARIATIONS IN SERVICE REQUIREMENTS ON FIXTURES DELIVERED TO THE JOB SITE.
- ELECTRICAL CONTRACTORS TO FURNISH ALL LABOR AND MATERIALS TO MAKE FINAL CONNECTIONS INCLUDING ALL DISCONNECTS, CONTROL PANELS, CORDS, PLUGS, ECT.
- ALL EXPOSED OUTLETS IN KITCHEN AND SERVING AREA SHALL BE CAST METAL AND WATERPROOF.
- ALL FLEXIBLE CONDUIT SHALL BE WATERPROOF.
- WHERE KITCHEN EQUIPMENT SHOP DRAWINGS CALL FOR DIRECT CONNECTION AND A RECEPTACLE IS SHOWN ON DRAWING, PROVIDE RECEPTACLE, PLUG AND CORD SET.
- INTERLOCK RANGE HOOD FIRE SUPPRESSION SYSTEM WITH SHUNT TRIP BREAKERS SERVING EQUIPMENT UNDER THE HOOD. SUCH THAT UPON SYSTEM ACTIVATION ALL POWER IS SHUT OFF. RANGE HOOD EXHAUST FAN SHALL REMAIN ON AND MAKE-UP AIR SHALL BE SHUT OFF. ALSO INTERLOCK WITH FIRE ALARM SYSTEM SUCH THAT A GENERAL ALARM IS SOUNDED UPON SYSTEM ACTIVATION.
- BEFORE ROUGHING IN ANY OUTLETS OR ORDERING ANY RECEPTACLES, PLUGS, CORD SETS, DISCONNECTS OR ANY ITEMS NECESSARY FOR THE CONNECTION OF KITCHEN EQUIPMENT, THE CONTRACTOR SHALL CONSULT THE SHOP DRAWINGS FOR THE EQUIPMENT ACTUALLY BEING FURNISHED (UNDER THE CONTRACTOR OR BY THE OWNER) FOR THE PROJECT AND SHALL PROVIDE AND INSTALL DEVICES, CIRCUITS AND ANY OTHER APPURTENANCES COMPATIBLE WITH THE EQUIPMENT FURNISHED SHALL BE PROVIDED AT NO COST TO THE OWNER.
- ALL EXPOSED CONDUITS SHALL BE RIGID STEEL.
- COORDINATE EXACT LOCATION OF WALK IN COOLER AND FREEZER COMPRESSOR LOCATIONS WITH ARCHITECT.
- PROVIDE CORD AND PLUG SET FOR EACH PIECE OF KITCHEN EQUIPMENT LOCATED BENEATH HOOD, SHOWN AS FED FROM A DUPLEX RECEPTACLE.
- ALL DISCONNECTS LOCATED IN KITCHEN AND DISH WASHING AREA SHALL BE NEMA 4X RATED.
- REFER TO KITCHEN EQUIPMENT ELECTRICAL CONNECTION SCHEDULES FOR CIRCUIT DESIGNATIONS, WIRE AND CONDUIT SIZE, DISCONNECT MEANS, AND OTHER ELECTRICAL REQUIREMENTS FOR KITCHEN EQUIPMENT.
- VERIFY ALL ELECTRICAL REQUIREMENTS (VOLTAGE, PHASE, CURRENT) OF EXISTING EQUIPMENT FURNISHED BY OWNER. WITH NAMEPLATE DATA PRIOR TO CONNECTING. NOTIFY ENGINEER OF ANY DISCREPANCIES.
- COORDINATE FINAL LOCATION OF EXISTING AND NEW EQUIPMENT WITH ARCHITECT/OWNER PRIOR TO ROUGH IN.

GENERAL NOTES (KITCHEN):

- ELECTRICAL CONTRACTOR IS TO VERIFY ENLARGED SCALE KITCHEN PLAN REQUIREMENTS.
- ELECTRICAL CONTRACTOR IS TO MAKE ALL EQUIPMENT OPERABLE IN ACCORDANCE WITH MANUFACTURER'S RECOMMENDATION.
- ELECTRICAL CONTRACTOR IS TO VERIFY WITH FOOD SERVICE CONTRACTORS SUBMITTALS TO ENSURE PROPER INSTALLATION.
- ELECTRICAL CONTRACTOR IS TO PROVIDE CONTROL WIRING FROM WALK-IN CONDENSOR TO WALK-IN EVAPORATOR.
- ELECTRICAL CONTRACTOR IS TO SEAL ANY AND ALL CONDUIT WHICH PENETRATE COOLER & FREEZER COMPARTMENTS TO PREVENT AIR CIRCULATION AND SUBSEQUENT CONDENSATION BUILD-UP WITHIN CONDUIT AND/OR EQUIPMENT.
- VERIFY ALL REQUIREMENTS FOR ANY EXISTING EQUIPMENT THAT WILL BE REVISED.
- VERIFY REQUIREMENTS FOR ALL EQUIPMENT NOT SUPPLIED BY FOOD SERVICE CONTRACTOR.
- ALL 120 VOLT EQUIPMENT NOT SUPPLIED WITH CORD AND PLUG BY MANUFACTURER IS TO BE CONNECTED TO JB OR ELECTRICAL CONTRACTOR IS TO SUPPLY CORD AND PLUG.
- REQUIREMENTS UNDER HOOD ARE BASED ON CENTERLINE OF HOOD.
- ALL 120 VOLT, 20 AMP RECEPTACLES IN KITCHEN, DISHWASH AND SERVICE AREA SHALL HAVE WEATHER PROOF COVERS. "WP" INDICATES "IN USE" COVER. "WPH" INDICATES HINGED COVER.

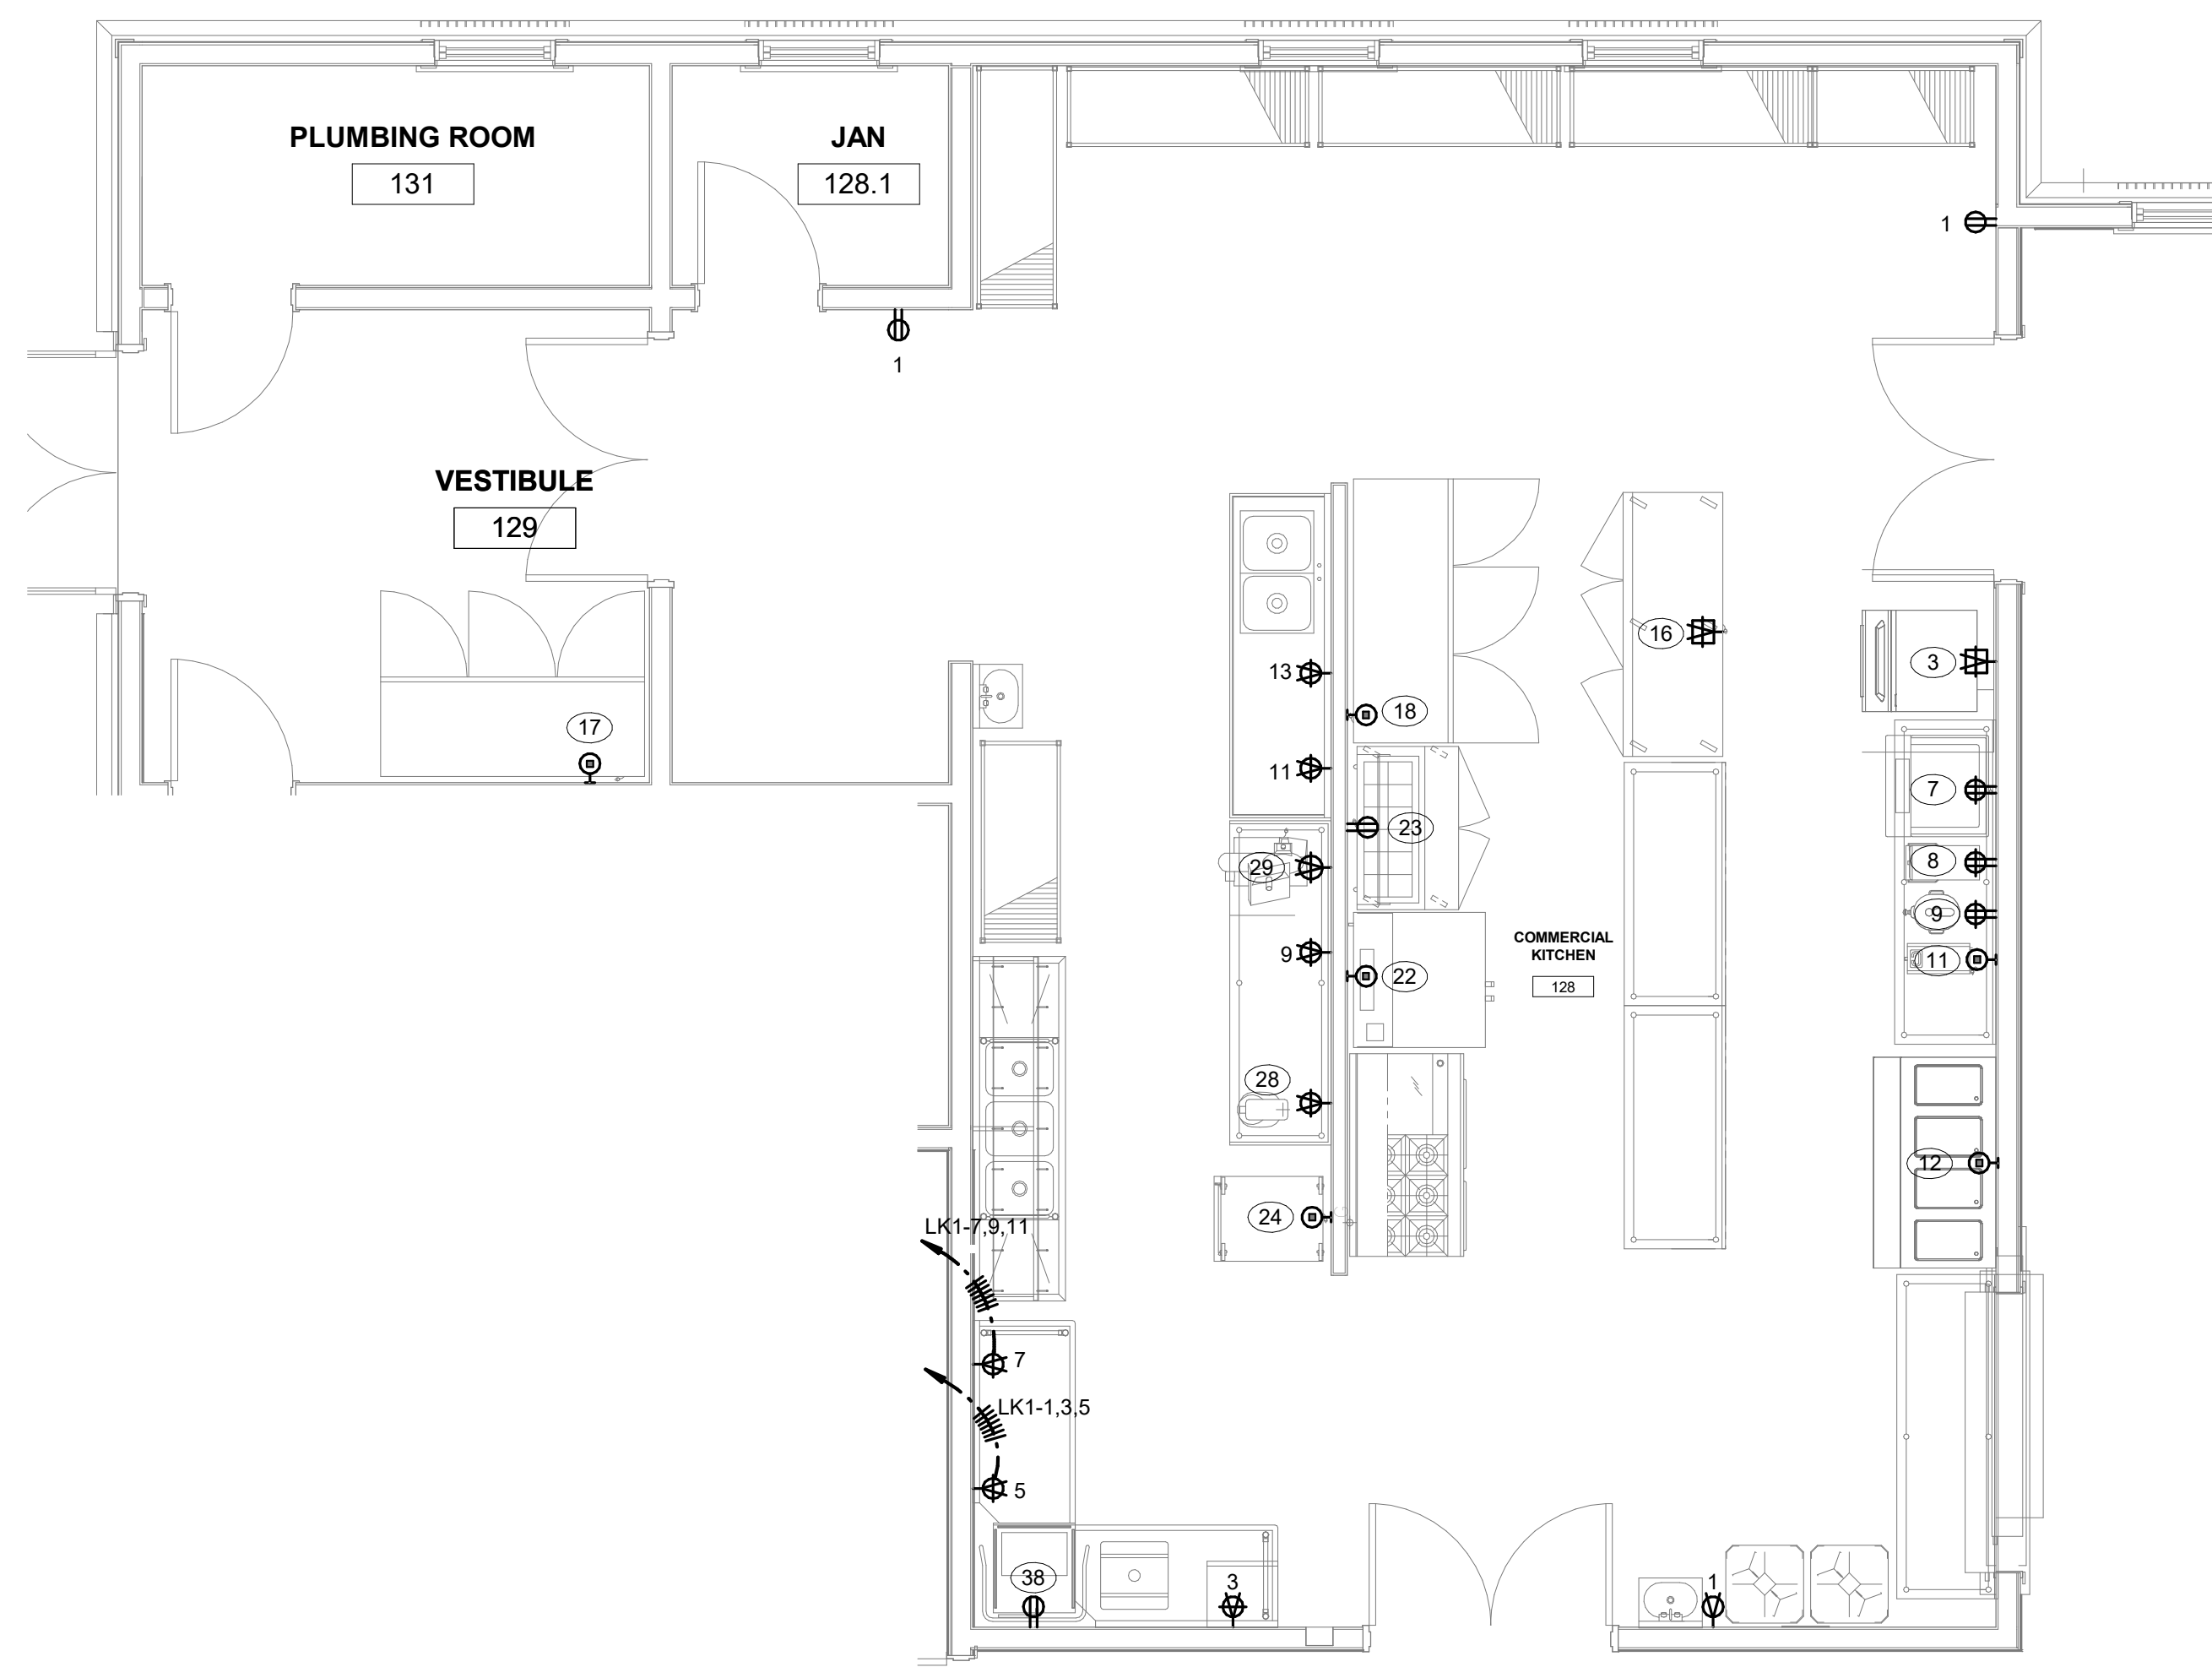

1 ENLARGED POWER PLAN - KITCHEN
E302 SCALE: 1/4" = 1'-0"

KITCHEN EQUIPMENT SCHEDULE

ITEM NO.	DESCRIPTION	CHARACTERISTICS				LOAD (kVA)	PANEL	CIRCUIT NUMBER	CONDUIT & WIRE SIZE	CONNECTION	MTG HT	NOTE
		VOLT	PHASE	MCA	MOCP							
3	ICE MACHINE	120 V	1	15.0 A	20.0 A	1440 VA	LK1	14	3/4" 2#12, 1#12G			
7	SODA/ ICE DISPENSER	120 V	1	1.9 A	15.0 A	180 VA	LK1	16	3/4" 2#12, 1#12G			
8	ICED TEA BREWER	120 V	1	1.9 A	15.0 A	180 VA	LK1	18	3/4" 2#12, 1#12G			
9	TEA DISPENSER	120 V	1	1.9 A	15.0 A	180 VA	LK1	20	3/4" 2#12, 1#12G			
11	COFFEE MAKER	208 V	1	7.2 A	15.0 A	1200 VA	LK1	15, 17	3/4" 2#12, 1#12G			
12	HOT FOOD TABLE	120 V	1	20.0 A	20.0 A	1920 VA	LK1	22	3/4" 2#12, 1#12G			
16	REFRIGERATOR	120 V	1	7.8 A	15.0 A	744 VA	LK1	12	3/4" 2#12, 1#12G			
17	FREEZER	208 V	1	17.5 A	20.0 A	2312 VA	LK1	19, 21	3/4" 2#12, 1#12G			
18	FREEZER	208 V	1	17.5 A	20.0 A	180 VA	LK1	23, 25	3/4" 2#12, 1#12G			
22	CONVECTION OVEN	120 V	1	11.3 A	15.0 A	1080 VA	LK1	8	3/4" 2#12, 1#12G			
23	SANDWICH PREP REFRIGERATOR	120 V	1	12.5 A	15.0 A	1200 VA	LK1	10	3/4" 2#12, 1#12G			
24	HOLDING CABINET	120 V	1	20.0 A	20.0 A	2100 VA	LK1	6	3/4" 2#12, 1#12G			
28	MIXER	120 V	1	1.9 A	15.0 A	180 VA	LK1	4	3/4" 2#12, 1#12G			
29	MEAT SLICER	120 V	1	12.3 A	20.0 A	1176 VA	LK1	2	3/4" 2#12, 1#12G			
38	DISHWASHER	120 V	1	12.5 A	15.0 A	1200 VA	LK1	24	3/4" 2#12, 1#12G			



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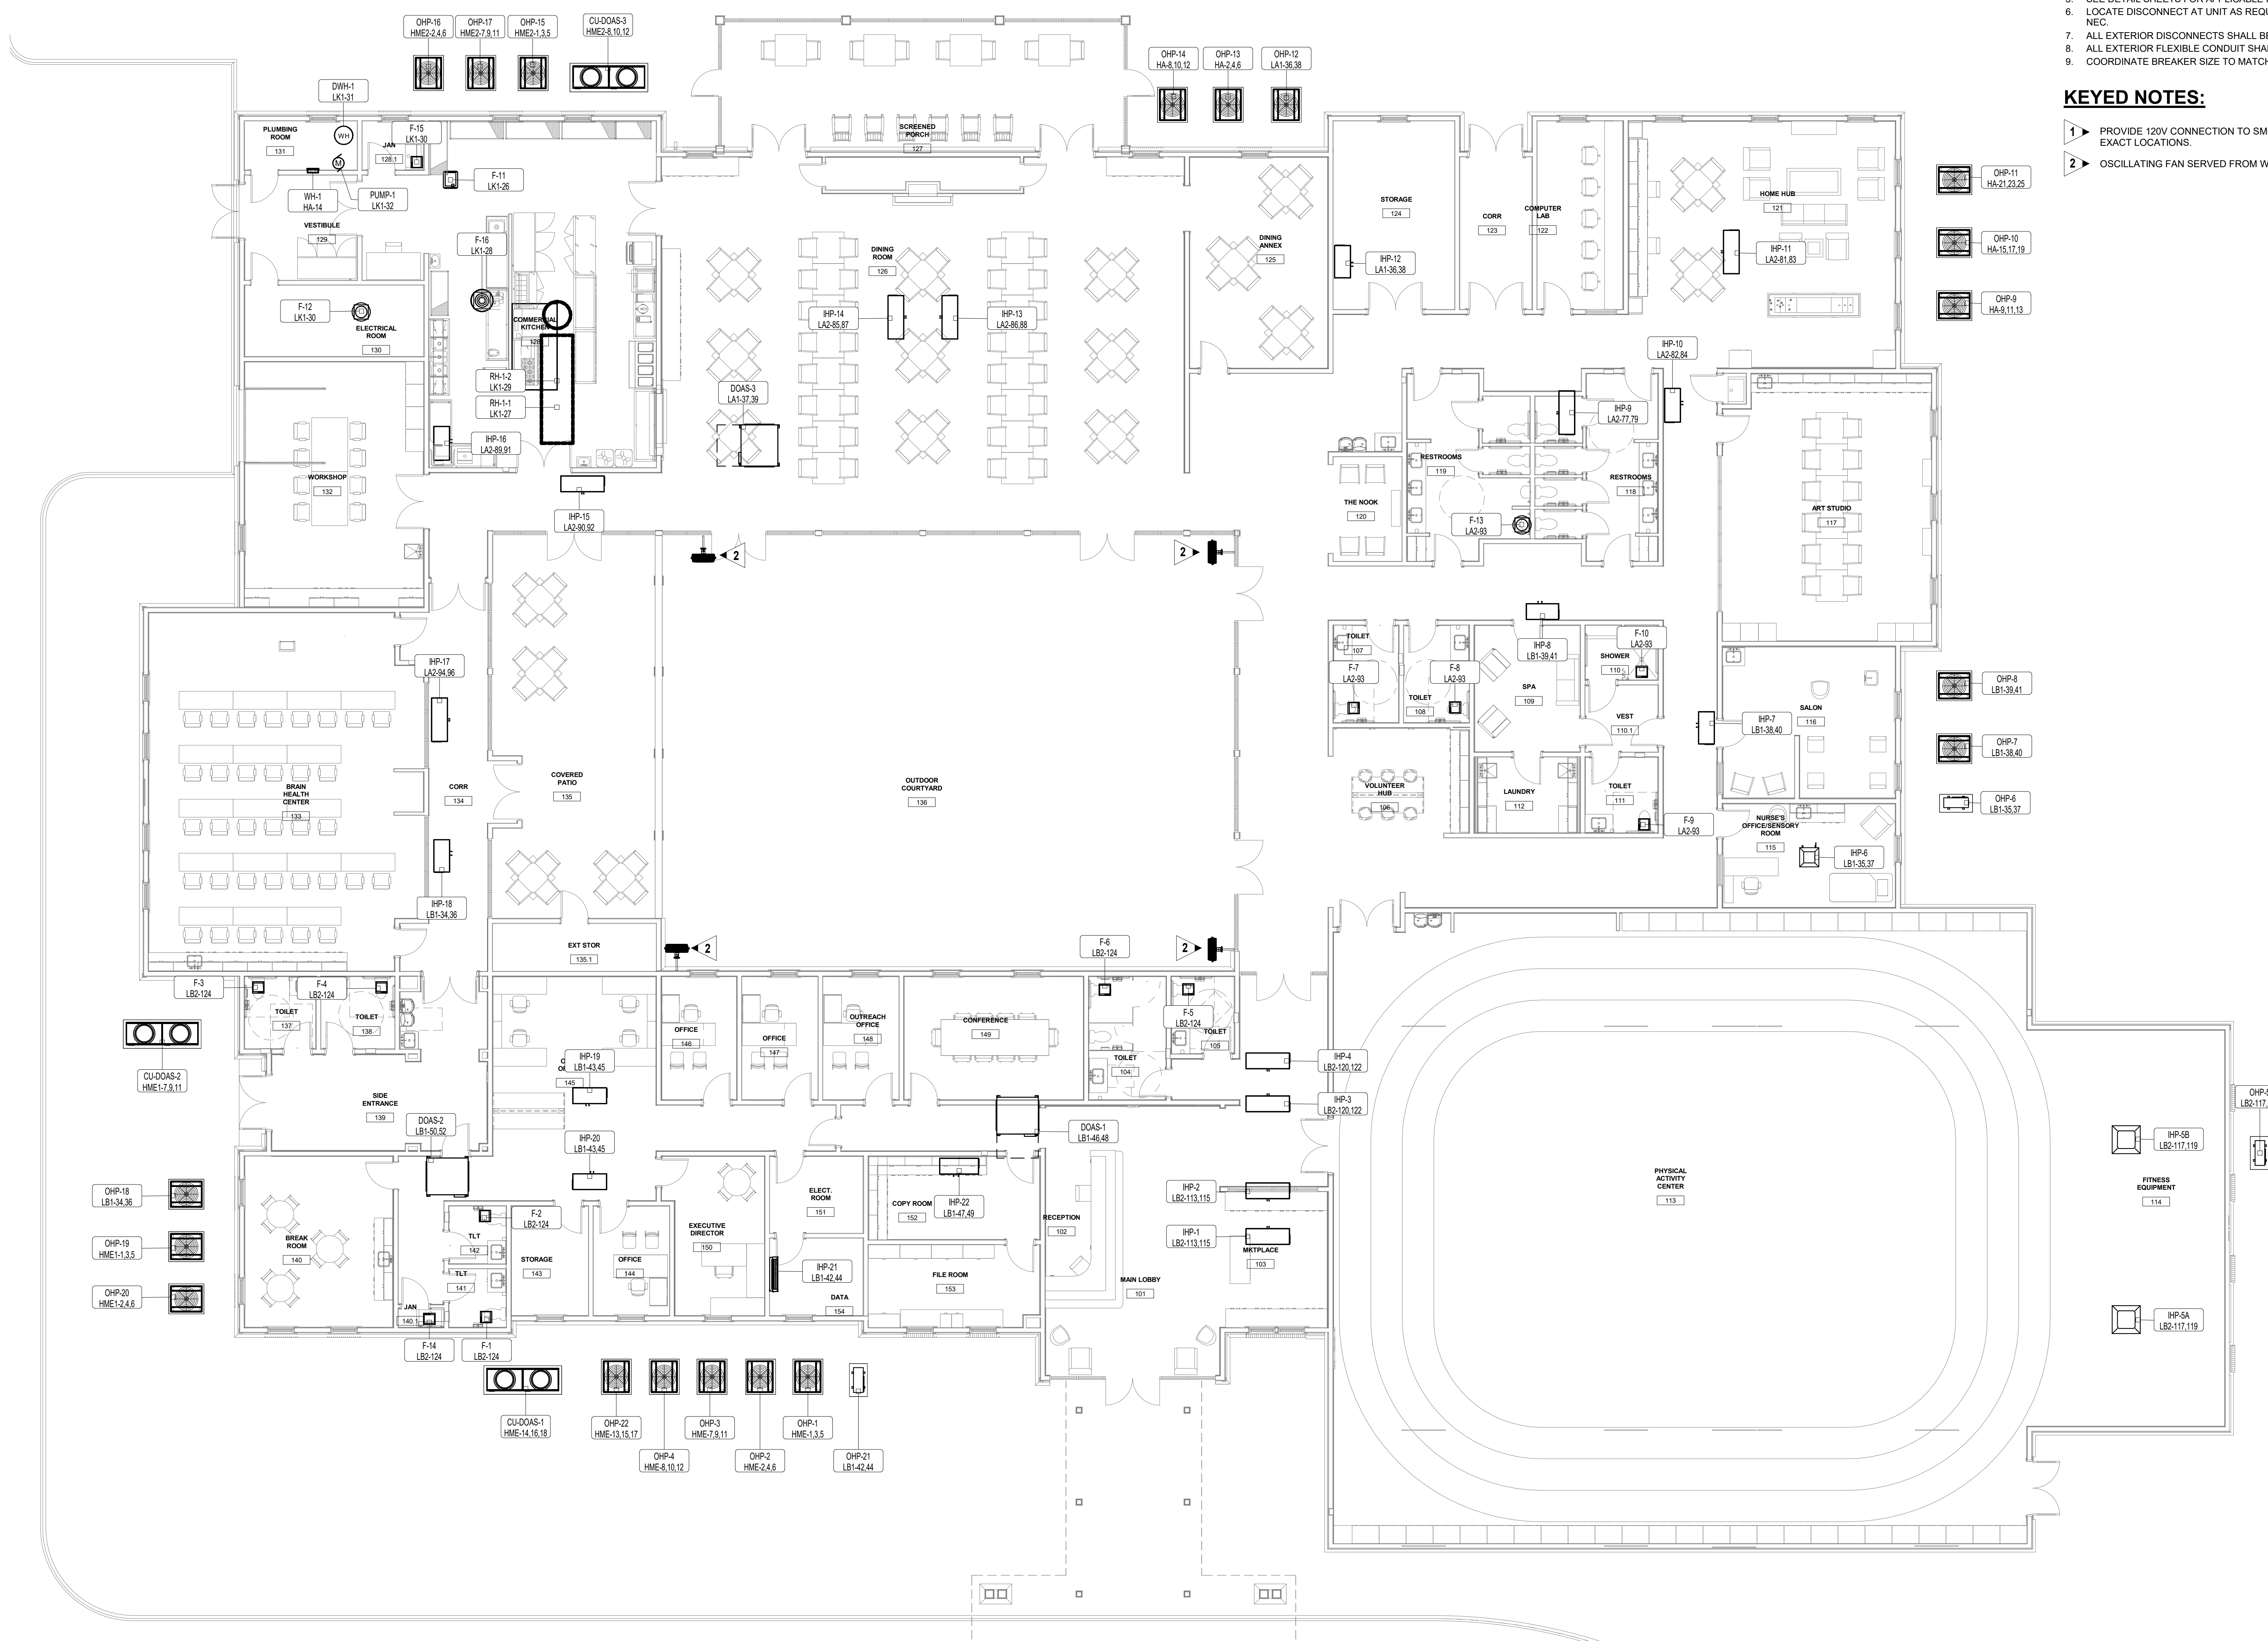


GENERAL NOTES:

- REFER TO MECHANICAL CONNECTION SCHEDULES FOR CIRCUIT DESIGNATIONS, WIRE AND CONDUIT SIZE, DISCONNECT MEANS AND OTHER ELECTRICAL REQUIREMENTS FOR MECHANICAL, PLUMBING AND FIRE PROTECTION EQUIPMENT.
- COORDINATE EXACT LOCATIONS OF ALL EQUIPMENT WITH MECHANICAL, PLUMBING AND FIRE PROTECTION DRAWINGS.
- PROVIDE 120V CONTROL POWER TO ALL HVAC CONTROL PANELS. SEE MECHANICAL DRAWINGS FOR EXACT LOCATION AND POWER PLANS FOR CIRCUITING.
- WALL JUNCTION BOXES AND CONDUIT FOR THERMOSTATS SHALL BE PROVIDED BY ELECTRICAL CONTRACTOR. VERIFY EXACT LOCATION AND QUANTITY WITH MECHANICAL PRIOR TO ROUGH-IN.
- SEE DETAIL SHEETS FOR APPLICABLE HVAC ROUGH-IN DETAILS.
- LOCATE DISCONNECT AT UNIT AS REQUIRED TO MAINTAIN PROPER CLEARANCES PER NEC.
- ALL EXTERIOR DISCONNECTS SHALL BE RATED NEMA 3R RATED.
- ALL EXTERIOR FLEXIBLE CONDUIT SHALL BE METALLIC WATERPROOF.
- COORDINATE BREAKER SIZE TO MATCH NAMEPLATE RATING ON UNITS.

KEYED NOTES:

- ▶ PROVIDE 120V CONNECTION TO SMOKE DAMPER. REFER TO MECHANICAL FOR EXACT LOCATIONS.
- ▶ OSCILLATING FAN SERVED FROM WEATHERPROOF RECEPTACLE. SEE E301.



1 MECHANICAL POWER PLAN
E401 SCALE: 1/8" = 1'-0"



PROJECT TITLE:
**JUD C
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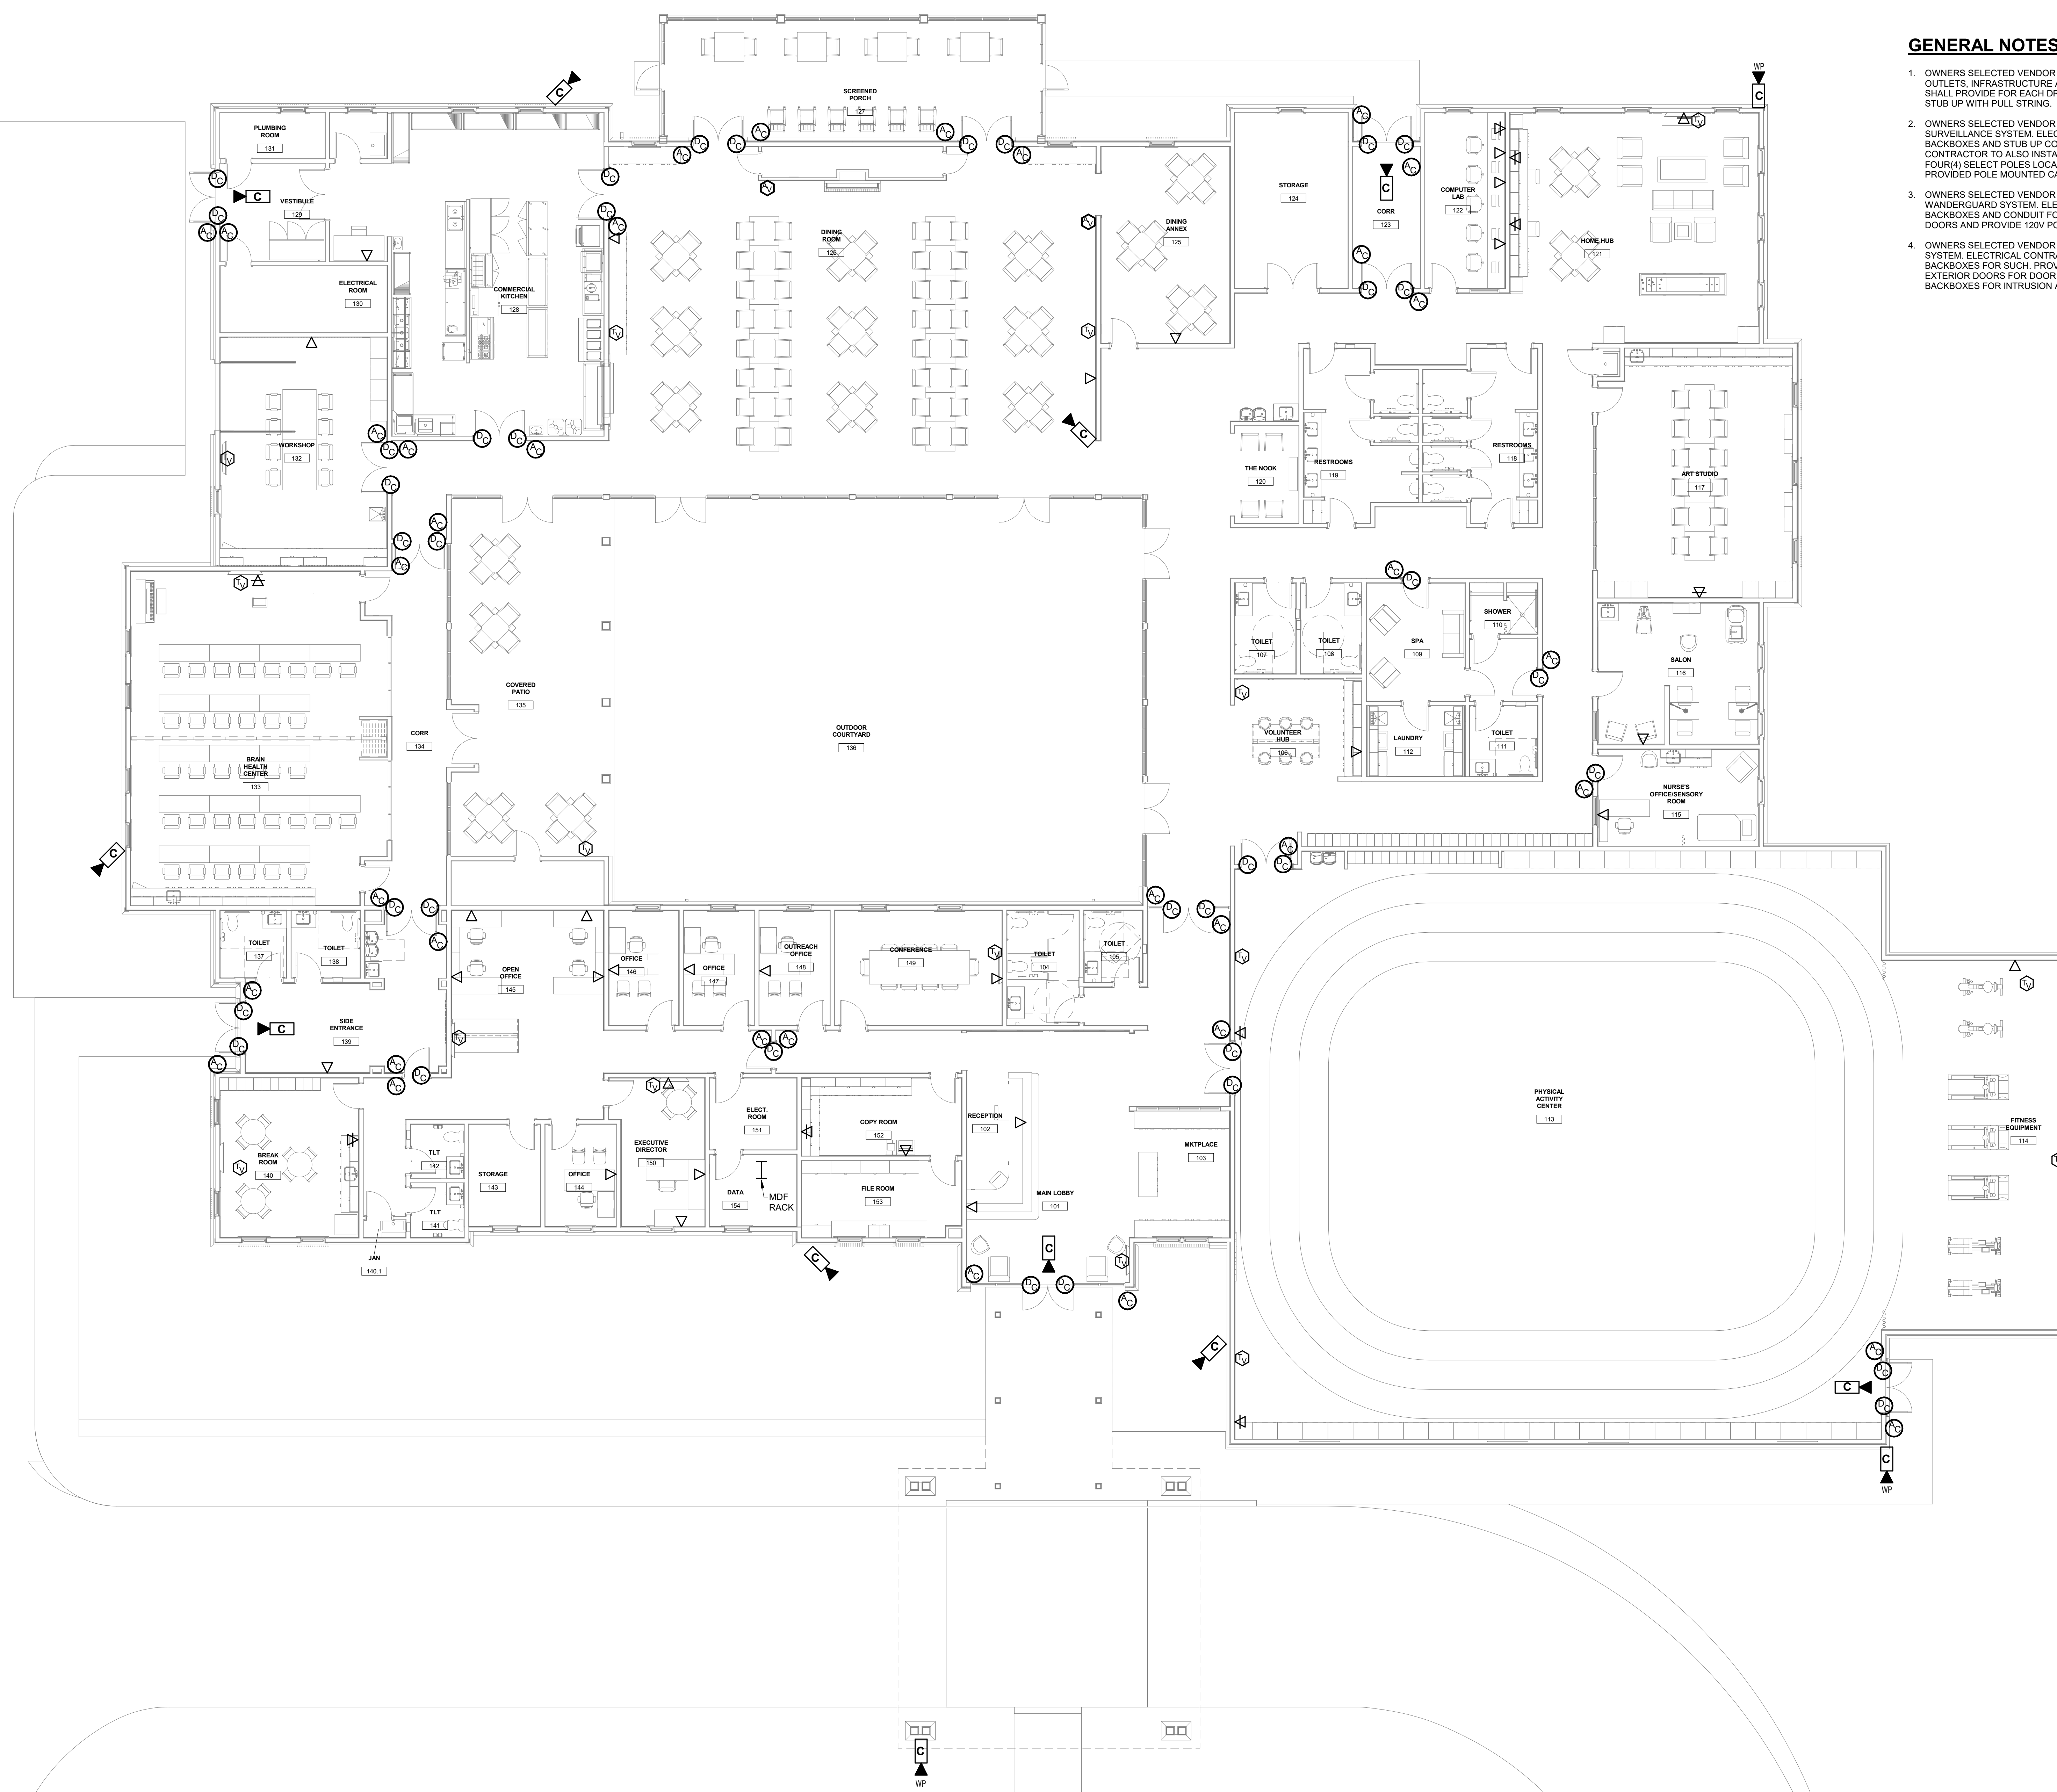
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DA PROJECT NUMBER & NAME:
1893
DRAWING TITLE:
**FIRE ALARM
SYSTEM PLAN**

DRAWING NO:
E501

1 FIRE ALARM SYSTEM PLAN
E501 SCALE: 1/8" = 1'-0"




- GENERAL NOTES:**
- OWNERS SELECTED VENDOR SHALL PROVIDE ALL DATA/VOICE CABLING OUTLETS, INFRASTRUCTURE AND JACKS. ELECTRICAL CONTRACTORS SHALL PROVIDE FOR EACH DROP SHOWN DATA/VOICE BACKBOX AND 1" STUB UP WITH FULL STRING.
 - OWNERS SELECTED VENDOR SHALL INSTALL CCTV CAMERA SURVEILLANCE SYSTEM. ELECTRICAL CONTRACTOR TO INSTALL BACKBOXES AND STUB UP CONDUIT FOR SUCH. ELECTRICAL CONTRACTOR TO ALSO INSTALL UNDERGROUND CONDUIT OUT TO FOUR(4) SELECT POLES LOCATED ON THE SITE PLAN FOR OWNER PROVIDED POLE MOUNTED CAMERAS.
 - OWNERS SELECTED VENDOR SHALL INSTALL ACCESS CONTROL AND WANDERGUARD SYSTEM. ELECTRICAL CONTRACTOR TO PROVIDE BACKBOXES AND CONDUIT FOR SUCH. ROUGH IN BACKBOXES AT ENTRY DOORS AND PROVIDE 120V POWER AT EACH OF THE EXIT DOORS.
 - OWNERS SELECTED VENDOR SHALL INSTALL INTRUSION ALARM SYSTEM. ELECTRICAL CONTRACTOR SHALL PROVIDE CONDUIT AND BACKBOXES FOR SUCH. PROVIDE CONDUIT AND BACKBOX AT EACH EXTERIOR DOORS FOR DOOR CONTACTS AS WELL AS CONDUIT BACKBOXES FOR INTRUSION ALARM KEYPADS.

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ARCHITECTS
Architecture|Interior Design|Planning
771 Broad Street Suite 200
Augusta, Georgia 30901
(706) 722-7488
mail@dickinsonarchitects.com
www.dickinsonarchitects.com

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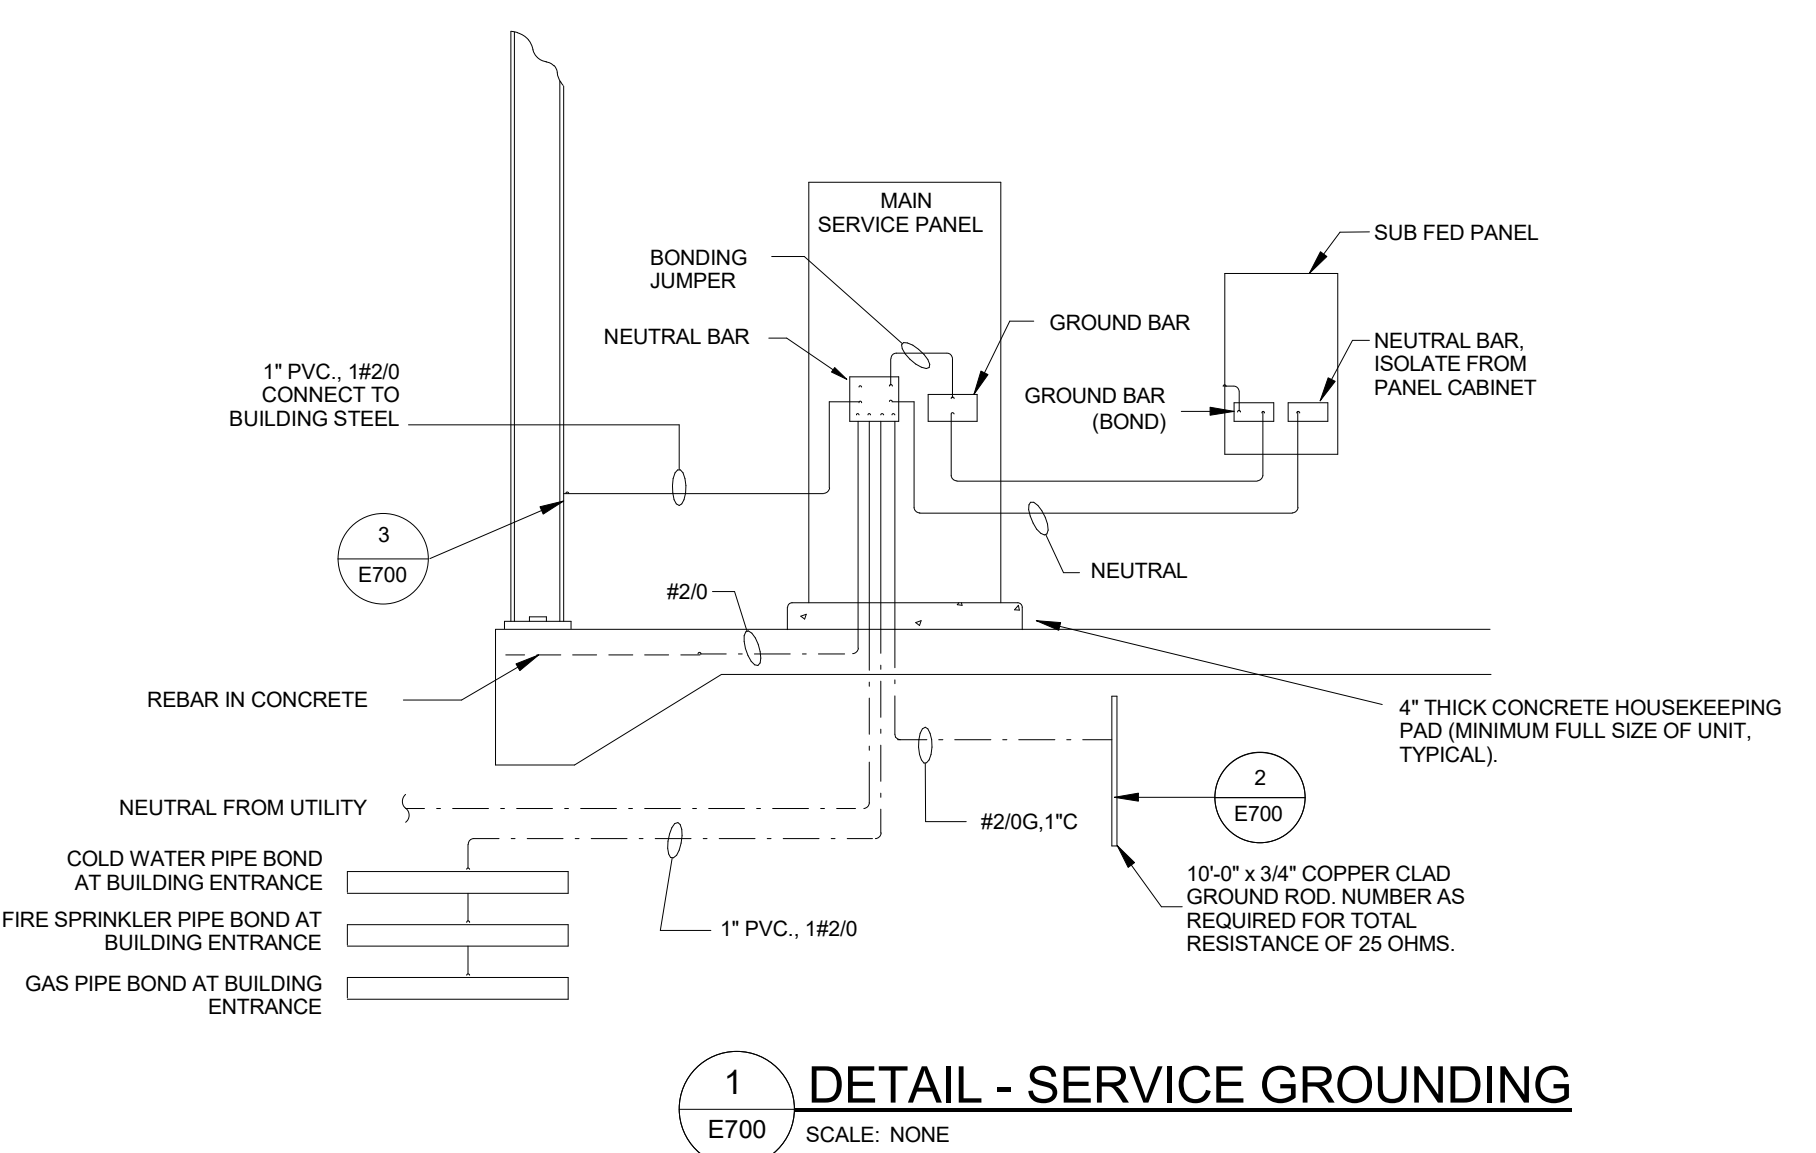
GEORGIA REGISTERED PROFESSIONAL ENGINEER
NO. 12345
PAUL PRANK

DA PROJECT NUMBER & NAME:
1893
DRAWING TITLE:
SYSTEMS PLANS


DRAWING NO:
E502

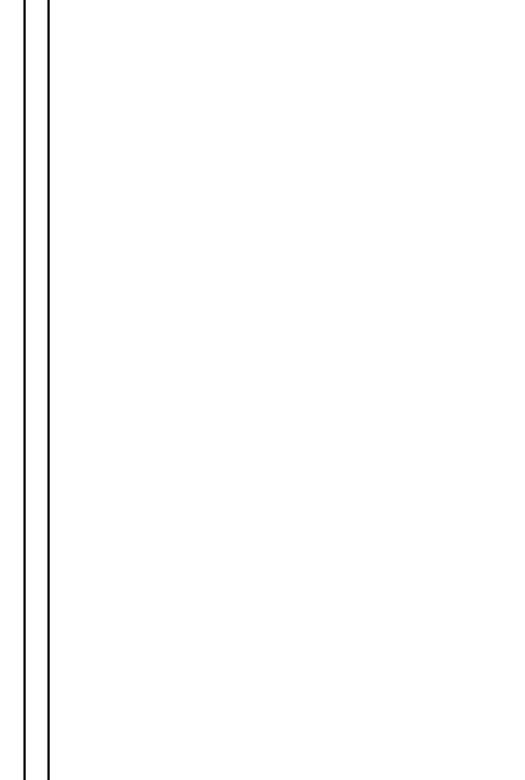1 SYSTEMS PLAN
E502 SCALE: 1/8" = 1'-0"

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AUGUSTA, GA 30901
PH: (706) 724-3551
FAX: (706) 724-8507
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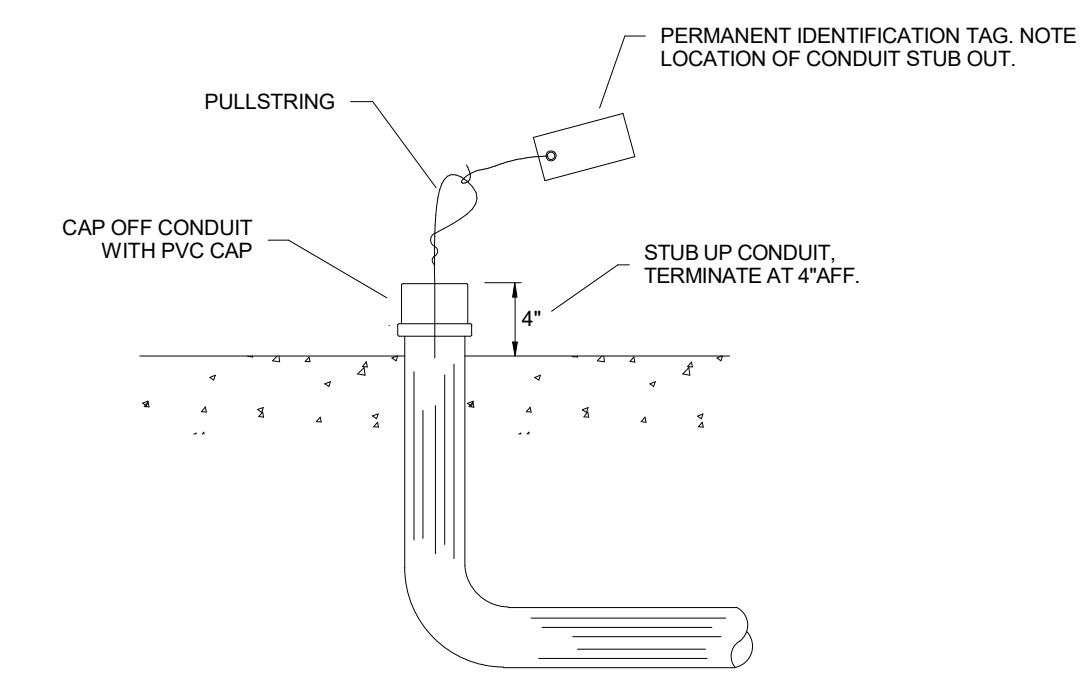


1 DETAIL - SERVICE GROUNDING
E700 SCALE: NONE

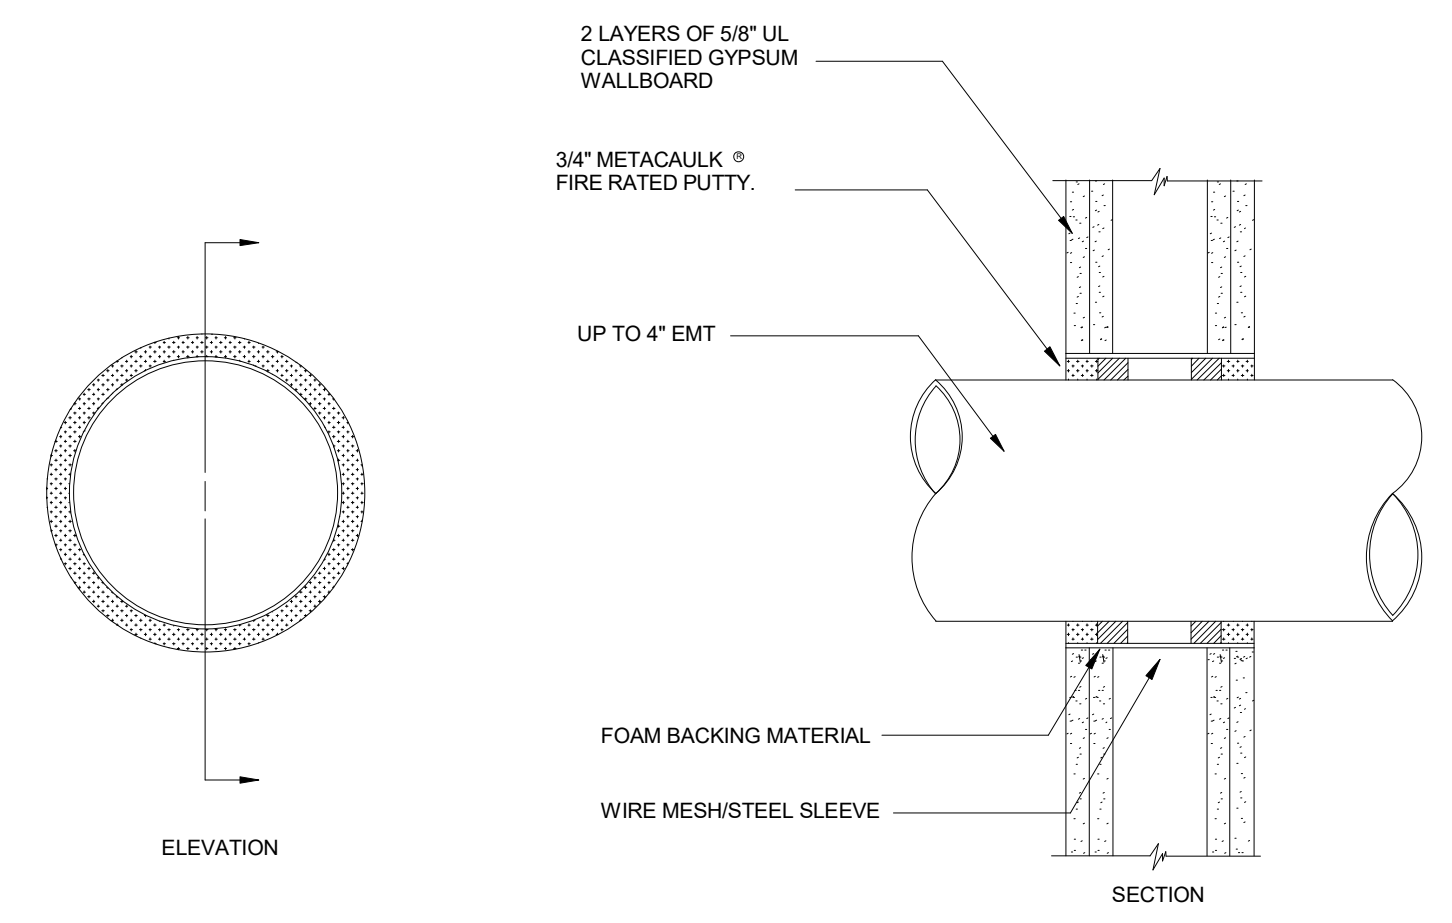


NOTE: WHERE CONDUIT IS USED AS A SLEEVE FOR ROUTING LOW VOLTAGE CABLES THROUGH A RATED WALL, LOCATE CONDUCTORS IN CENTER OF SLEEVE AND FILL OPENING WITH FIRE RATED PUTTY AT EACH END OF SLEEVE.


5 DETAIL - GYPSUM WALLBOARD PENETRATION
E700 SCALE: NONE




8 DETAIL - STUB UP CONDUIT DETAIL
E700 SCALE: NONE

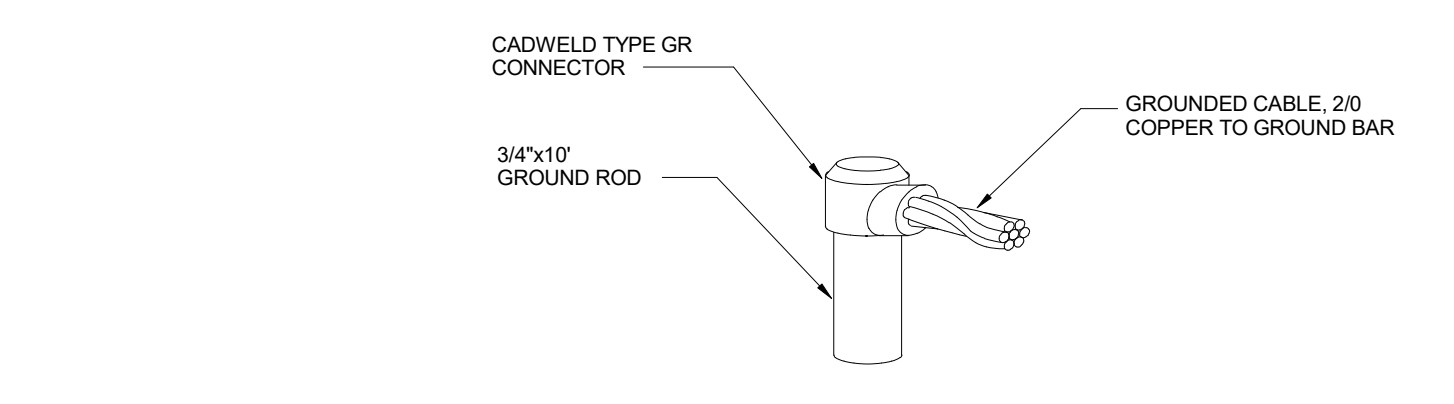


2 DETAIL - CABLE CONNECTION TO GROUND ROD
E700 SCALE: NONE

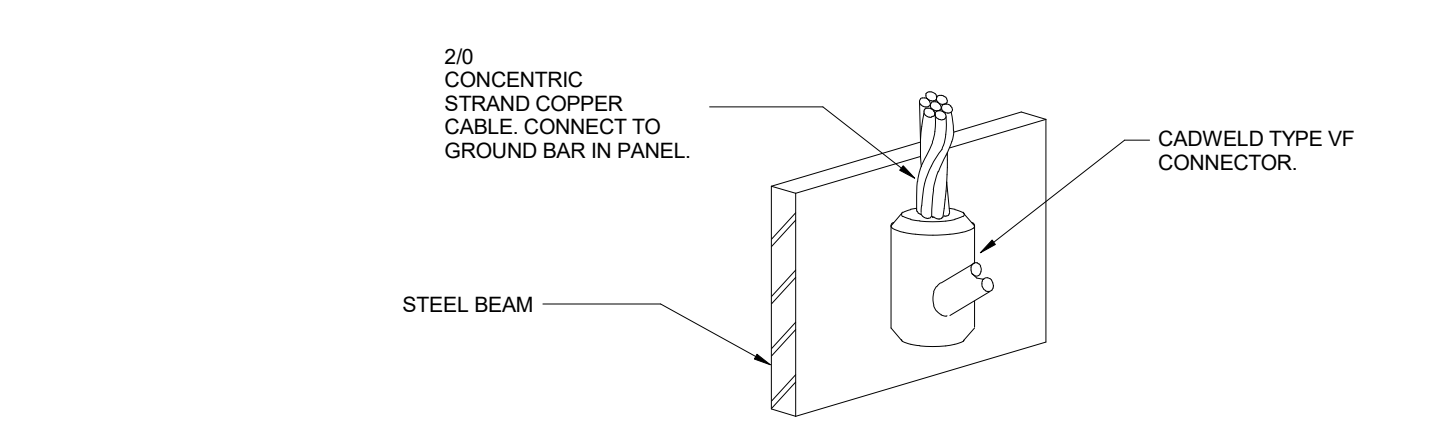


3 DETAIL - CABLE CONNECTION TO STEEL BEAM
E700 SCALE: NONE

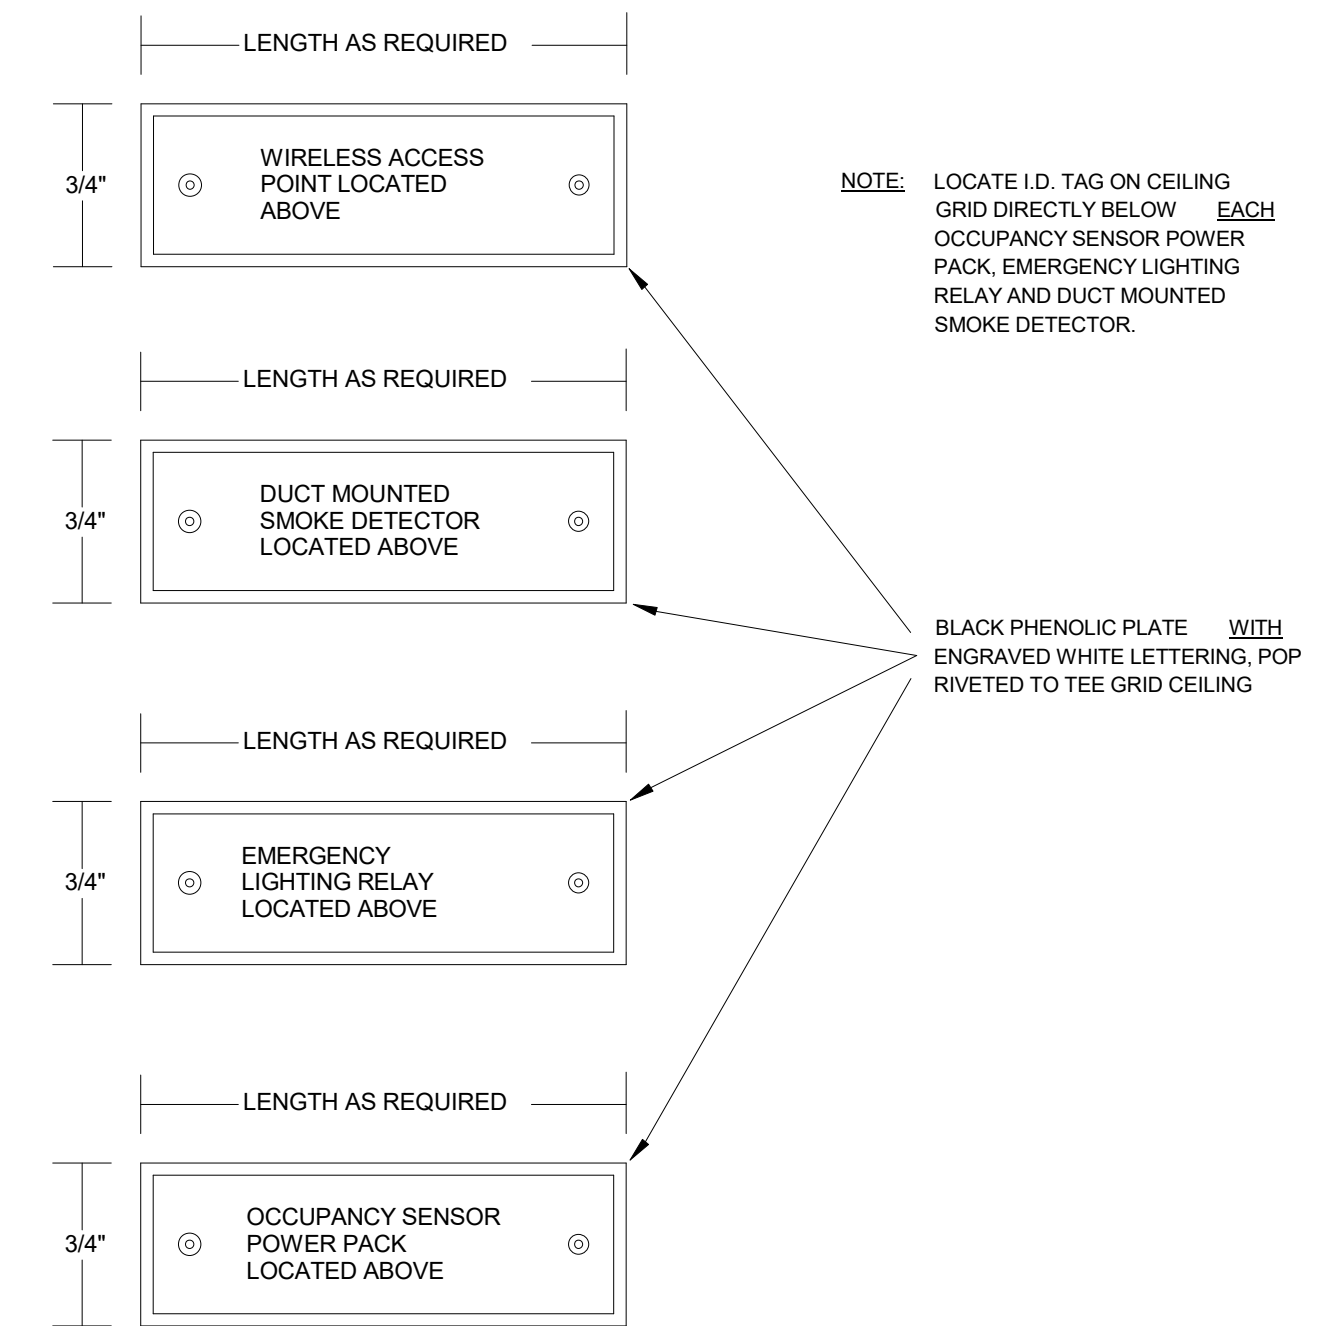


6 IDENTIFICATION TAG DETAIL
E700 SCALE: NOT TO SCALE

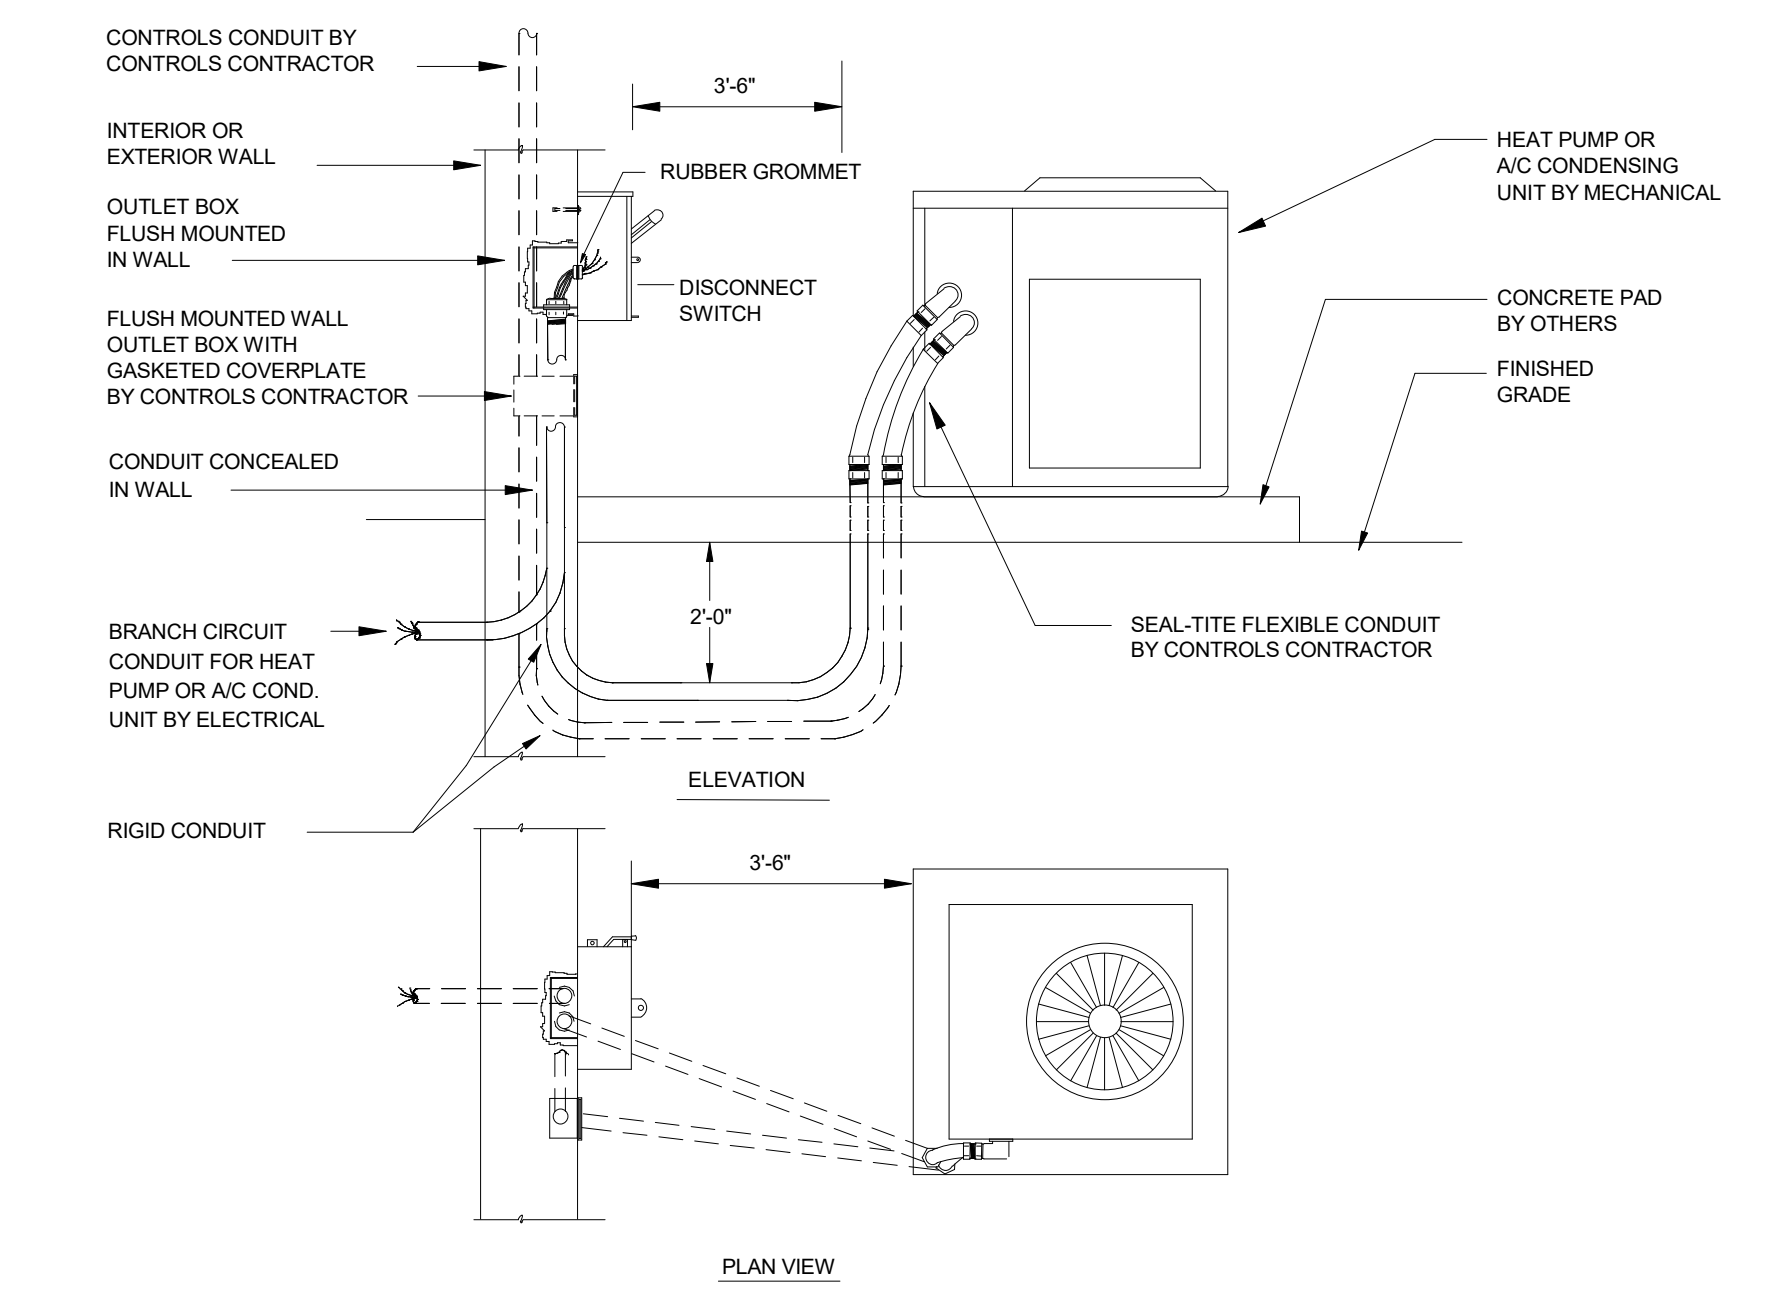


9 DETAIL - DISCONNECT SWITCH MOUNTING AT EXTERIOR H.V.A.C. UNIT
E700 SCALE: NONE

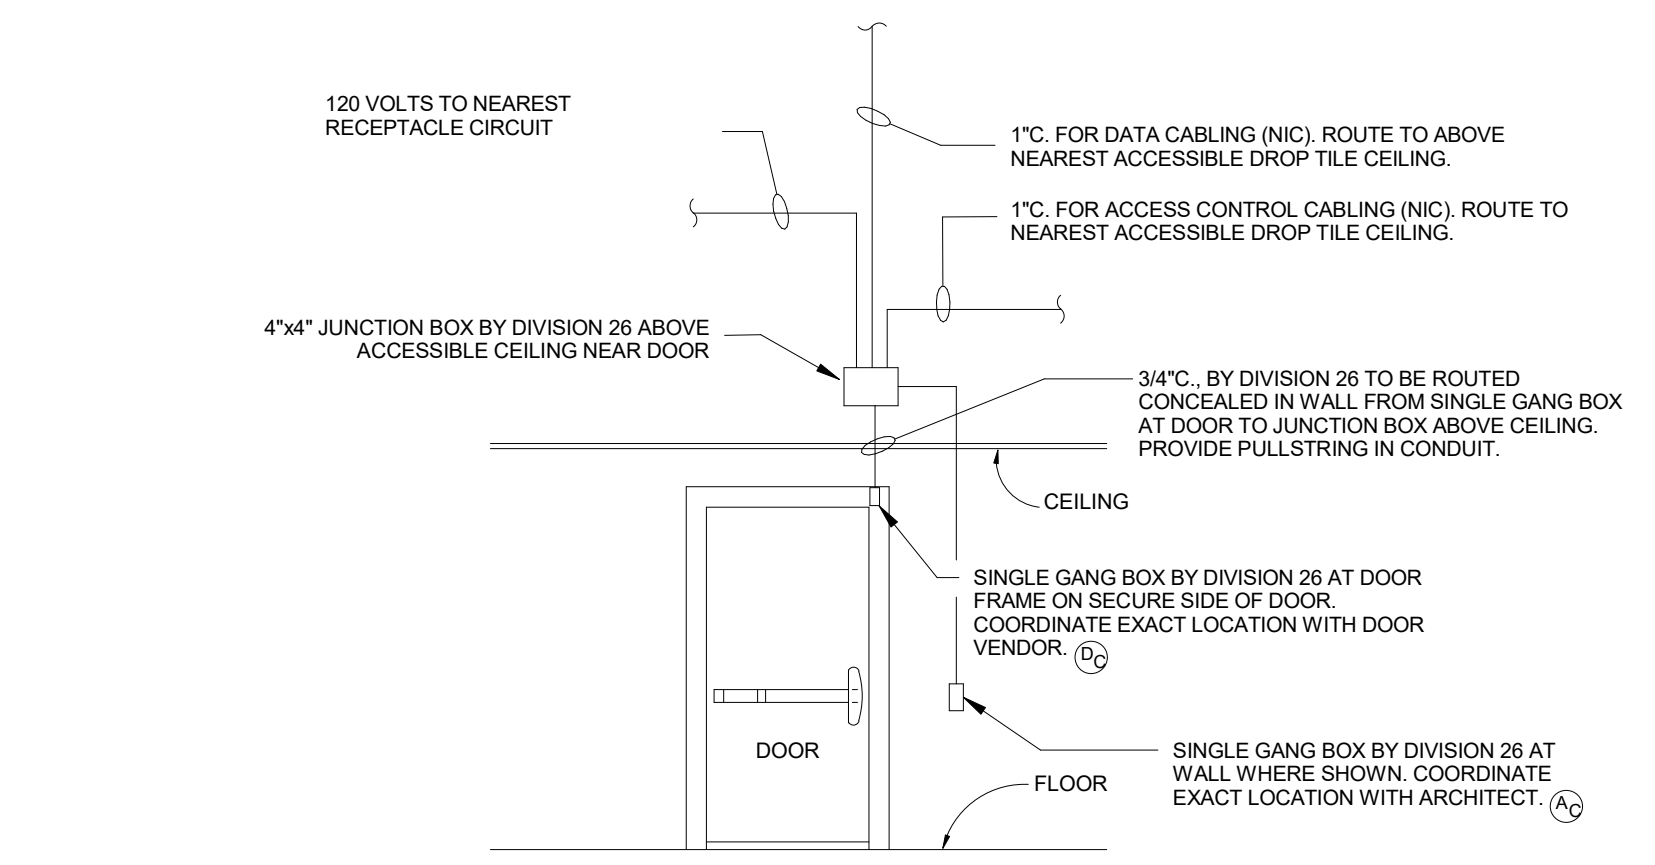

4 DETAIL - DOOR ACCESS CONTROL
E700 SCALE: NONE

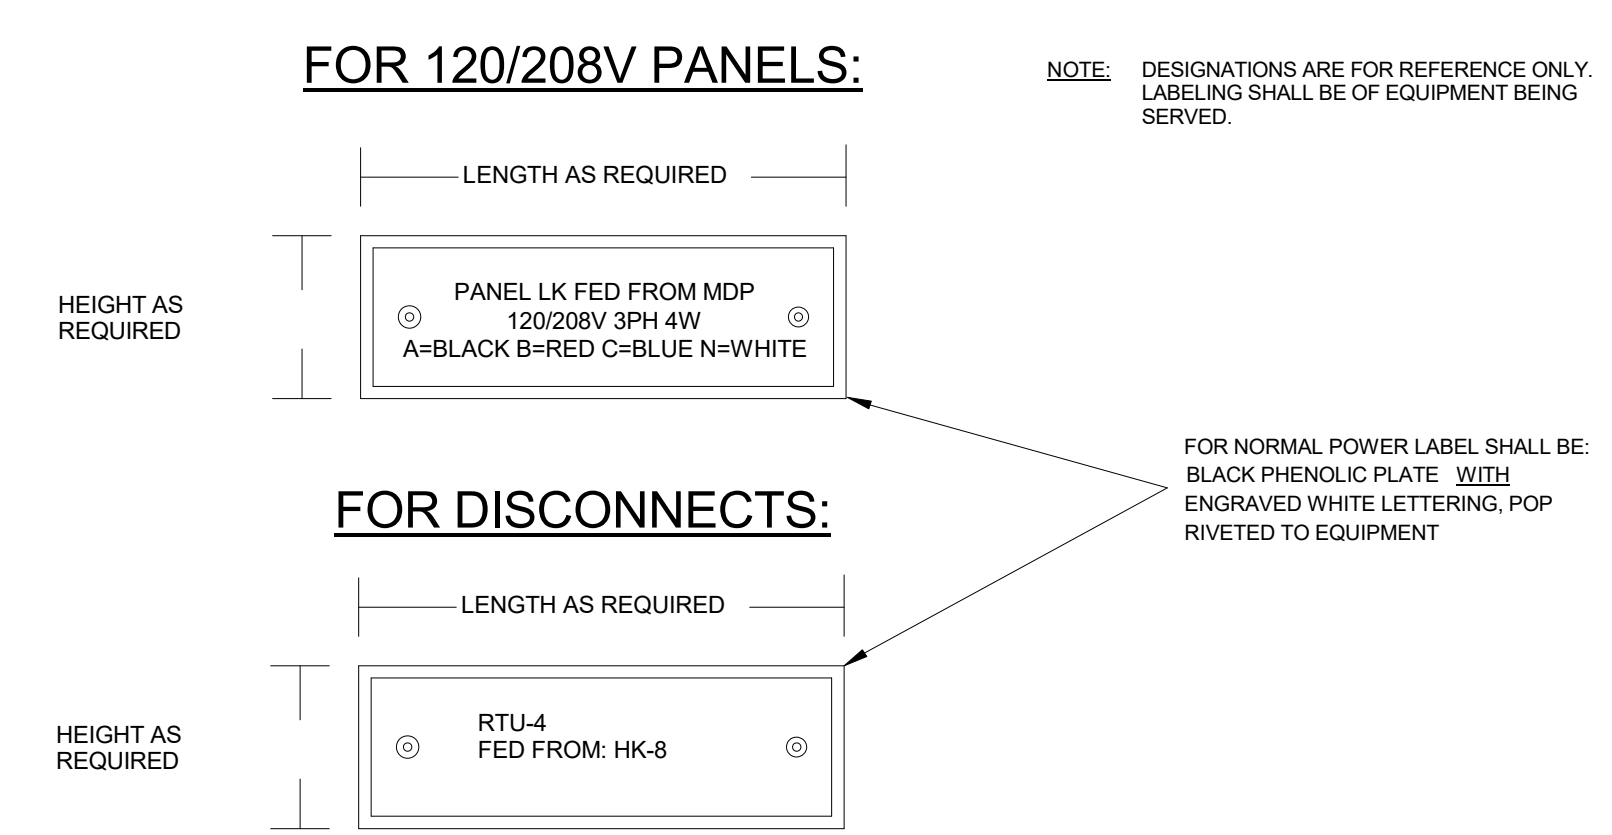

7 EQUIPMENT IDENTIFICATION TAG DETAIL
E700 SCALE: NOT TO SCALE

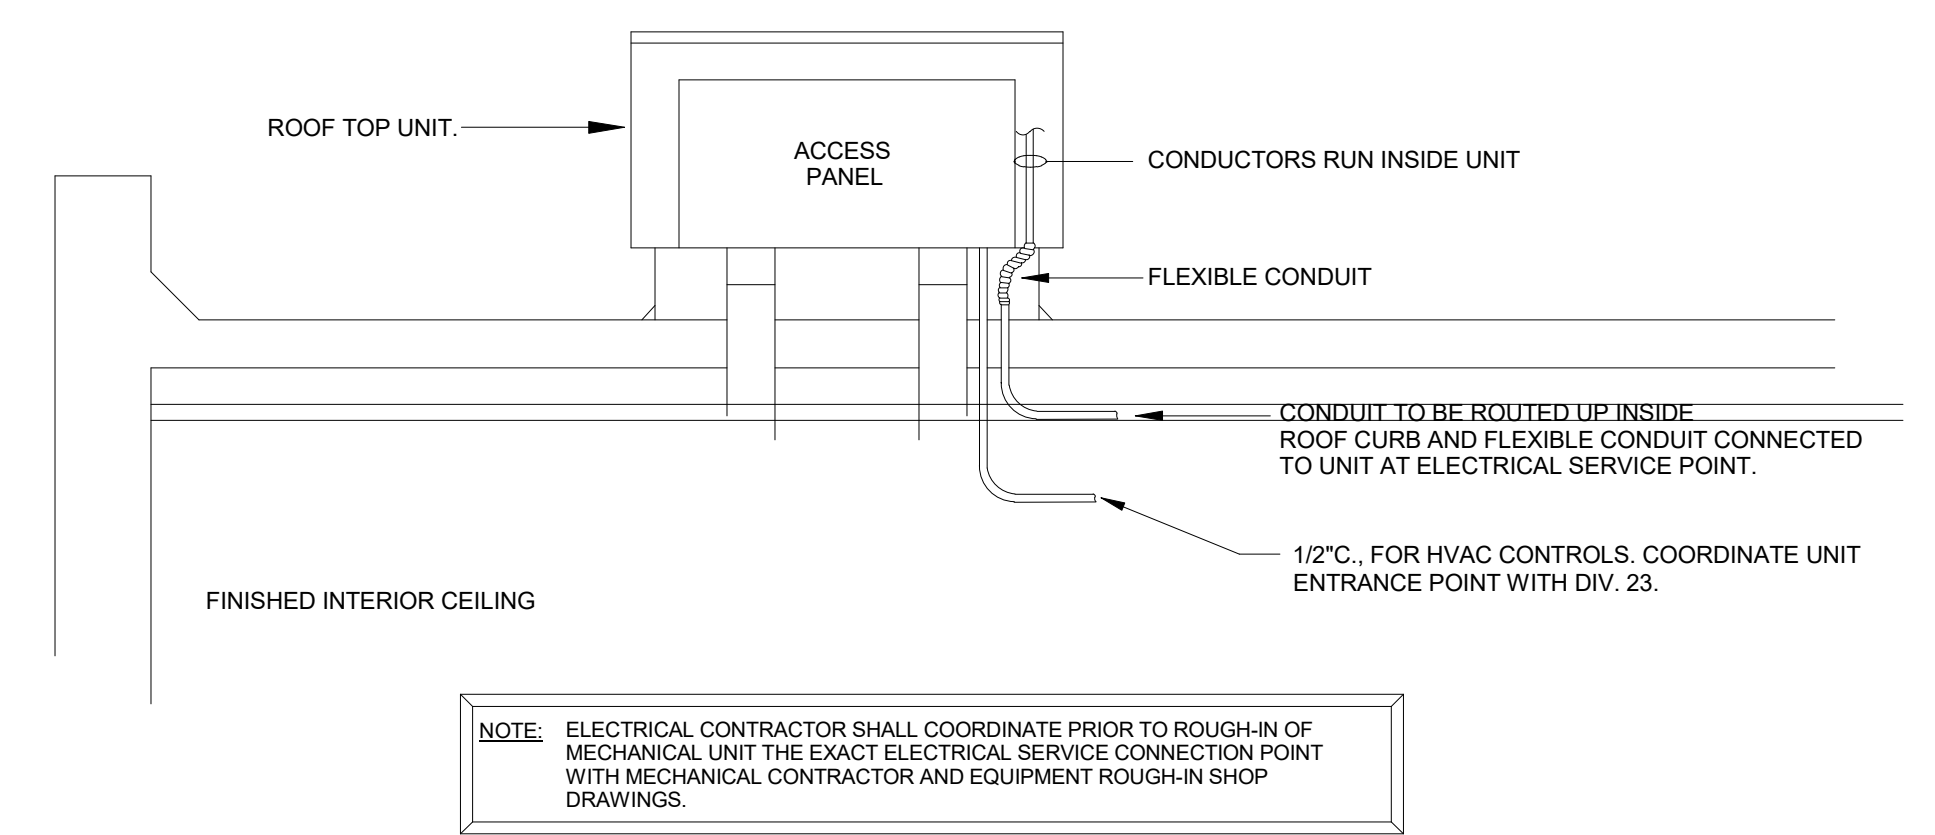

10 DETAIL - ROOF TOP UNIT WITH FACTORY SUPPLIED DISCONNECT
E700 SCALE: NONE

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